## USC - AIKEN CONVOCATION CENTER ROOF REPLACEMENT PROJECT 2049 CHAMPION WAY, GRANITEVILLE, SC

## DRAWING INDEX

TITLE SHEET, SITE VICINITY MAP,

KEY PLAN, & DRAWING INDEX

ROOF PLAN

ROOF PLAN

DETAILS


DETAILS

## LEGEND


AREAS IN CONTRACT

= AREAS NOT IN CONTRACT

(RA#) = ROOF AREA DESIGNATIONS

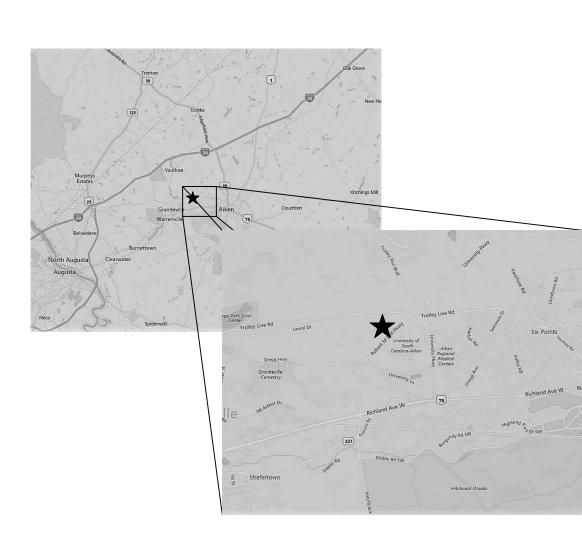




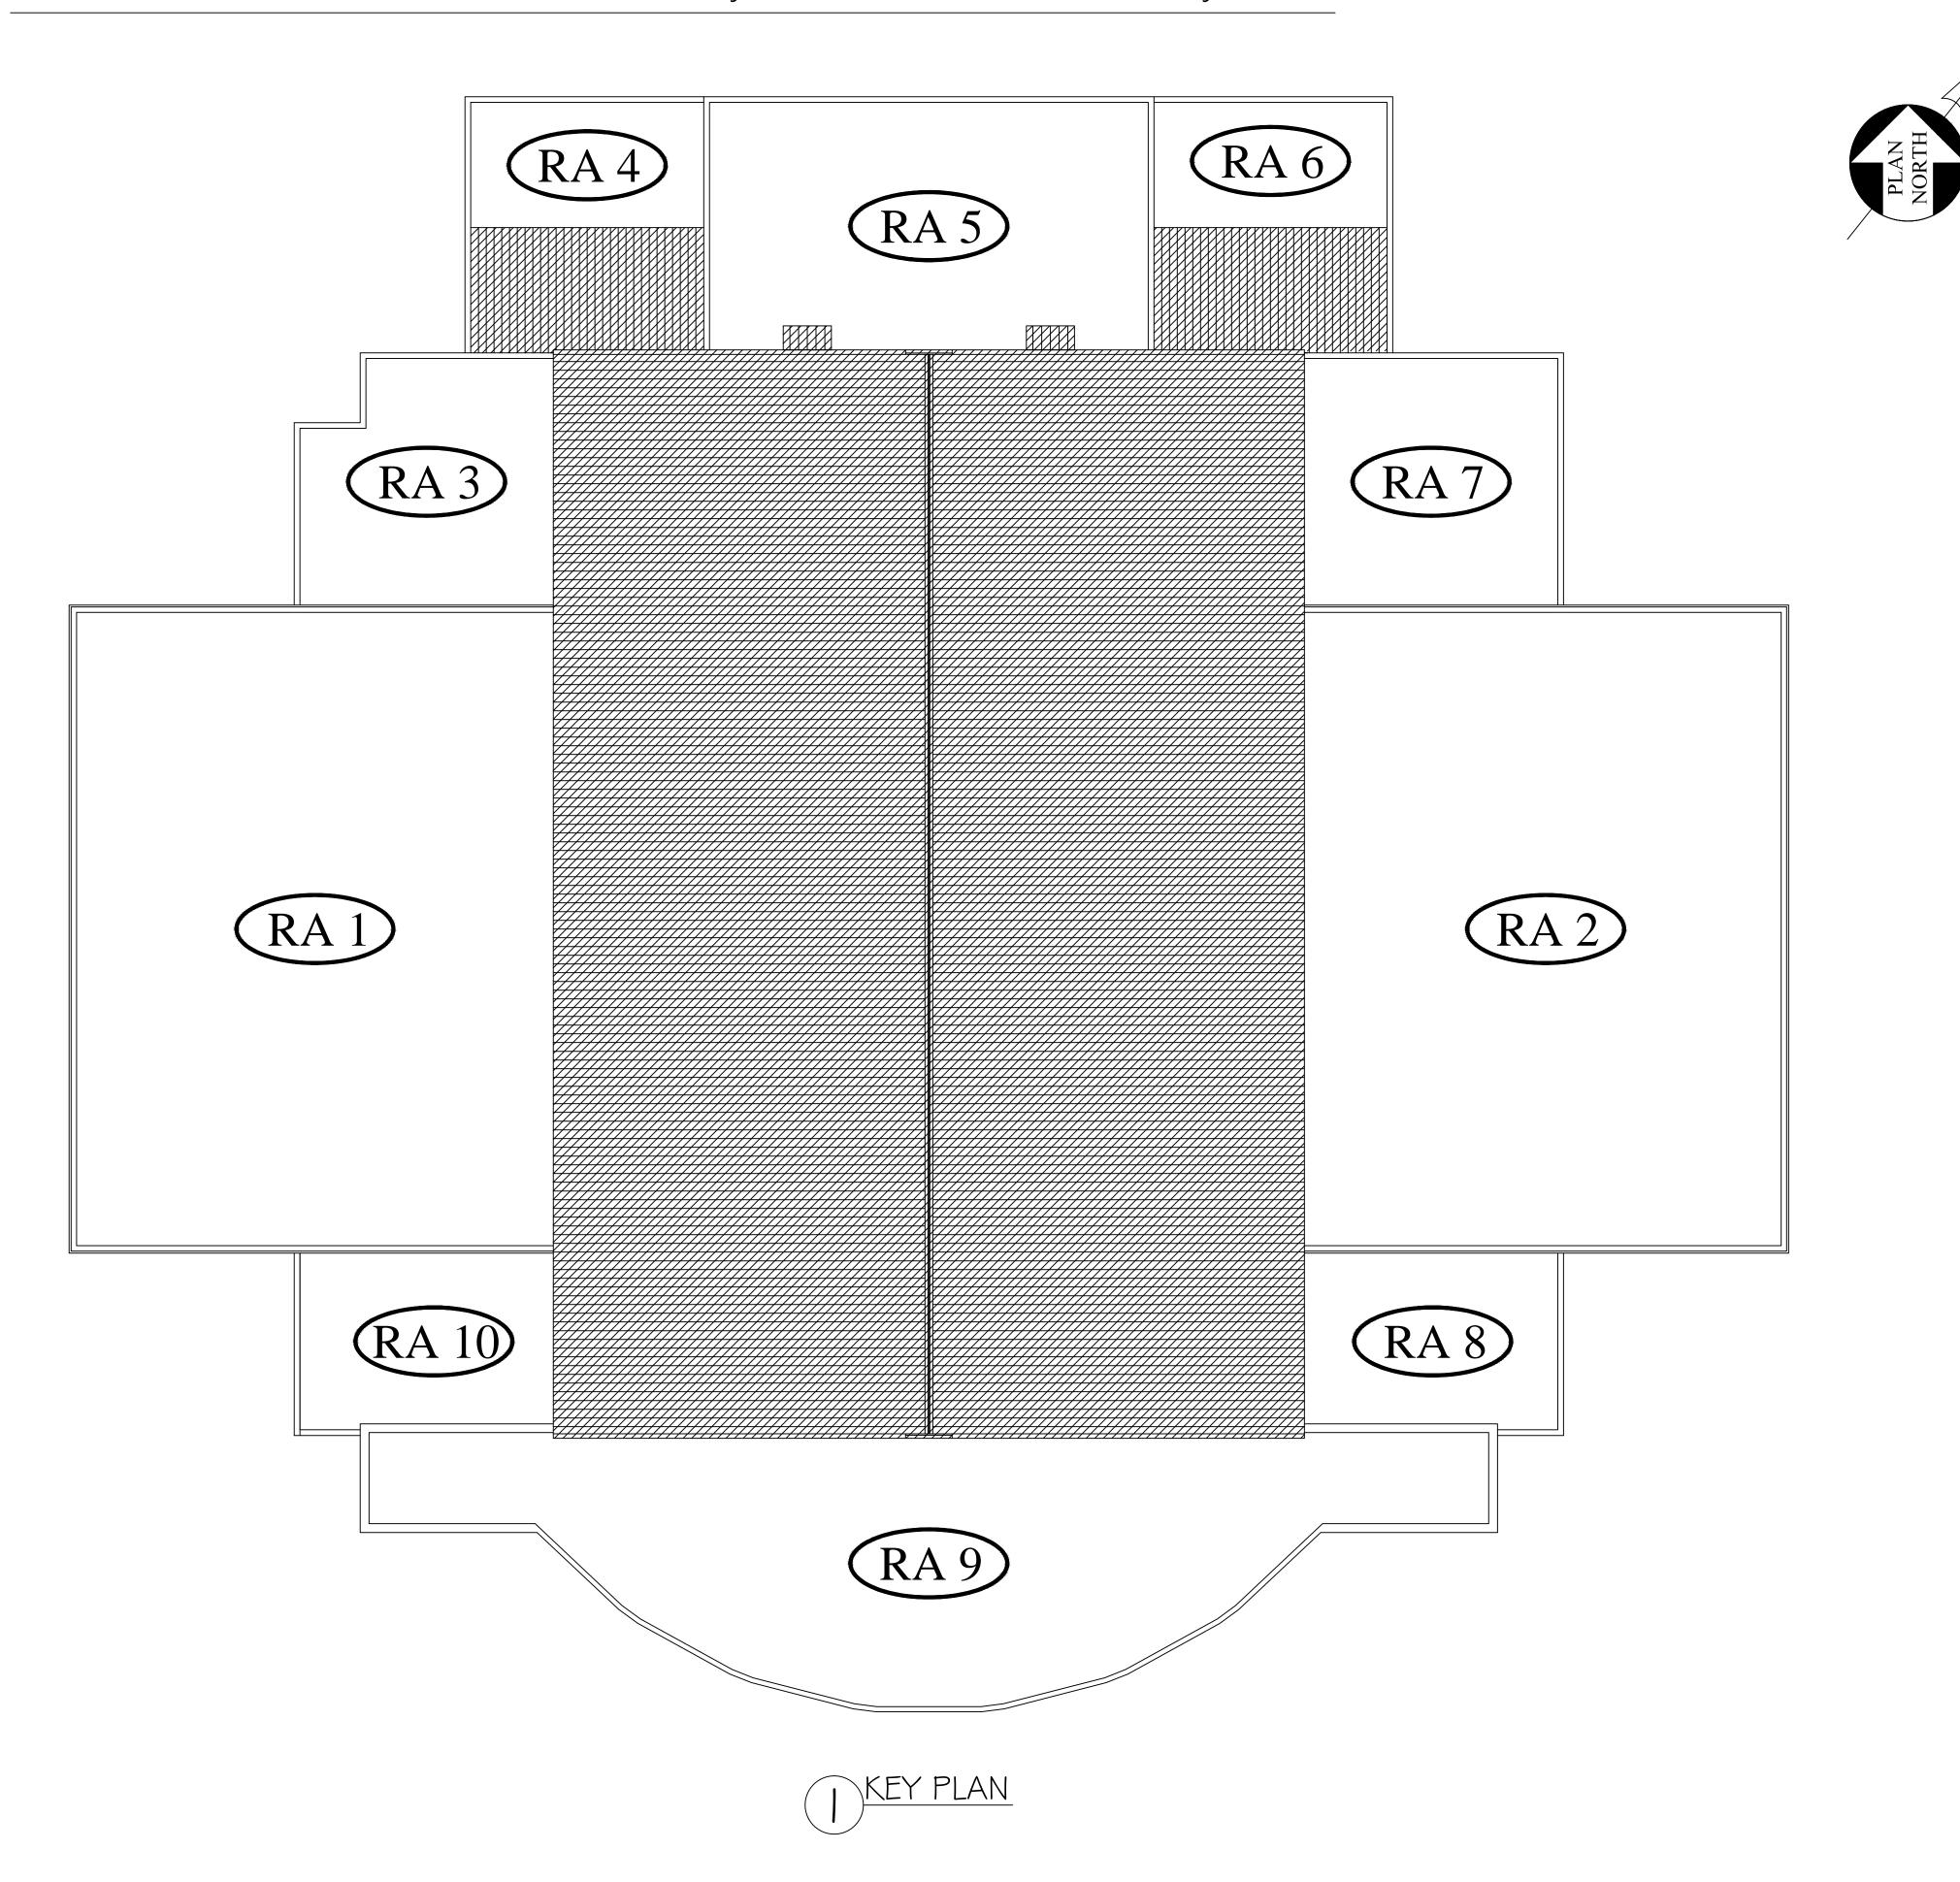


PF No. 11012.020.004 DATE: 6/8/2018 SCALE: NTS DRAWN BY: RCP

CHECKED BY: JAW

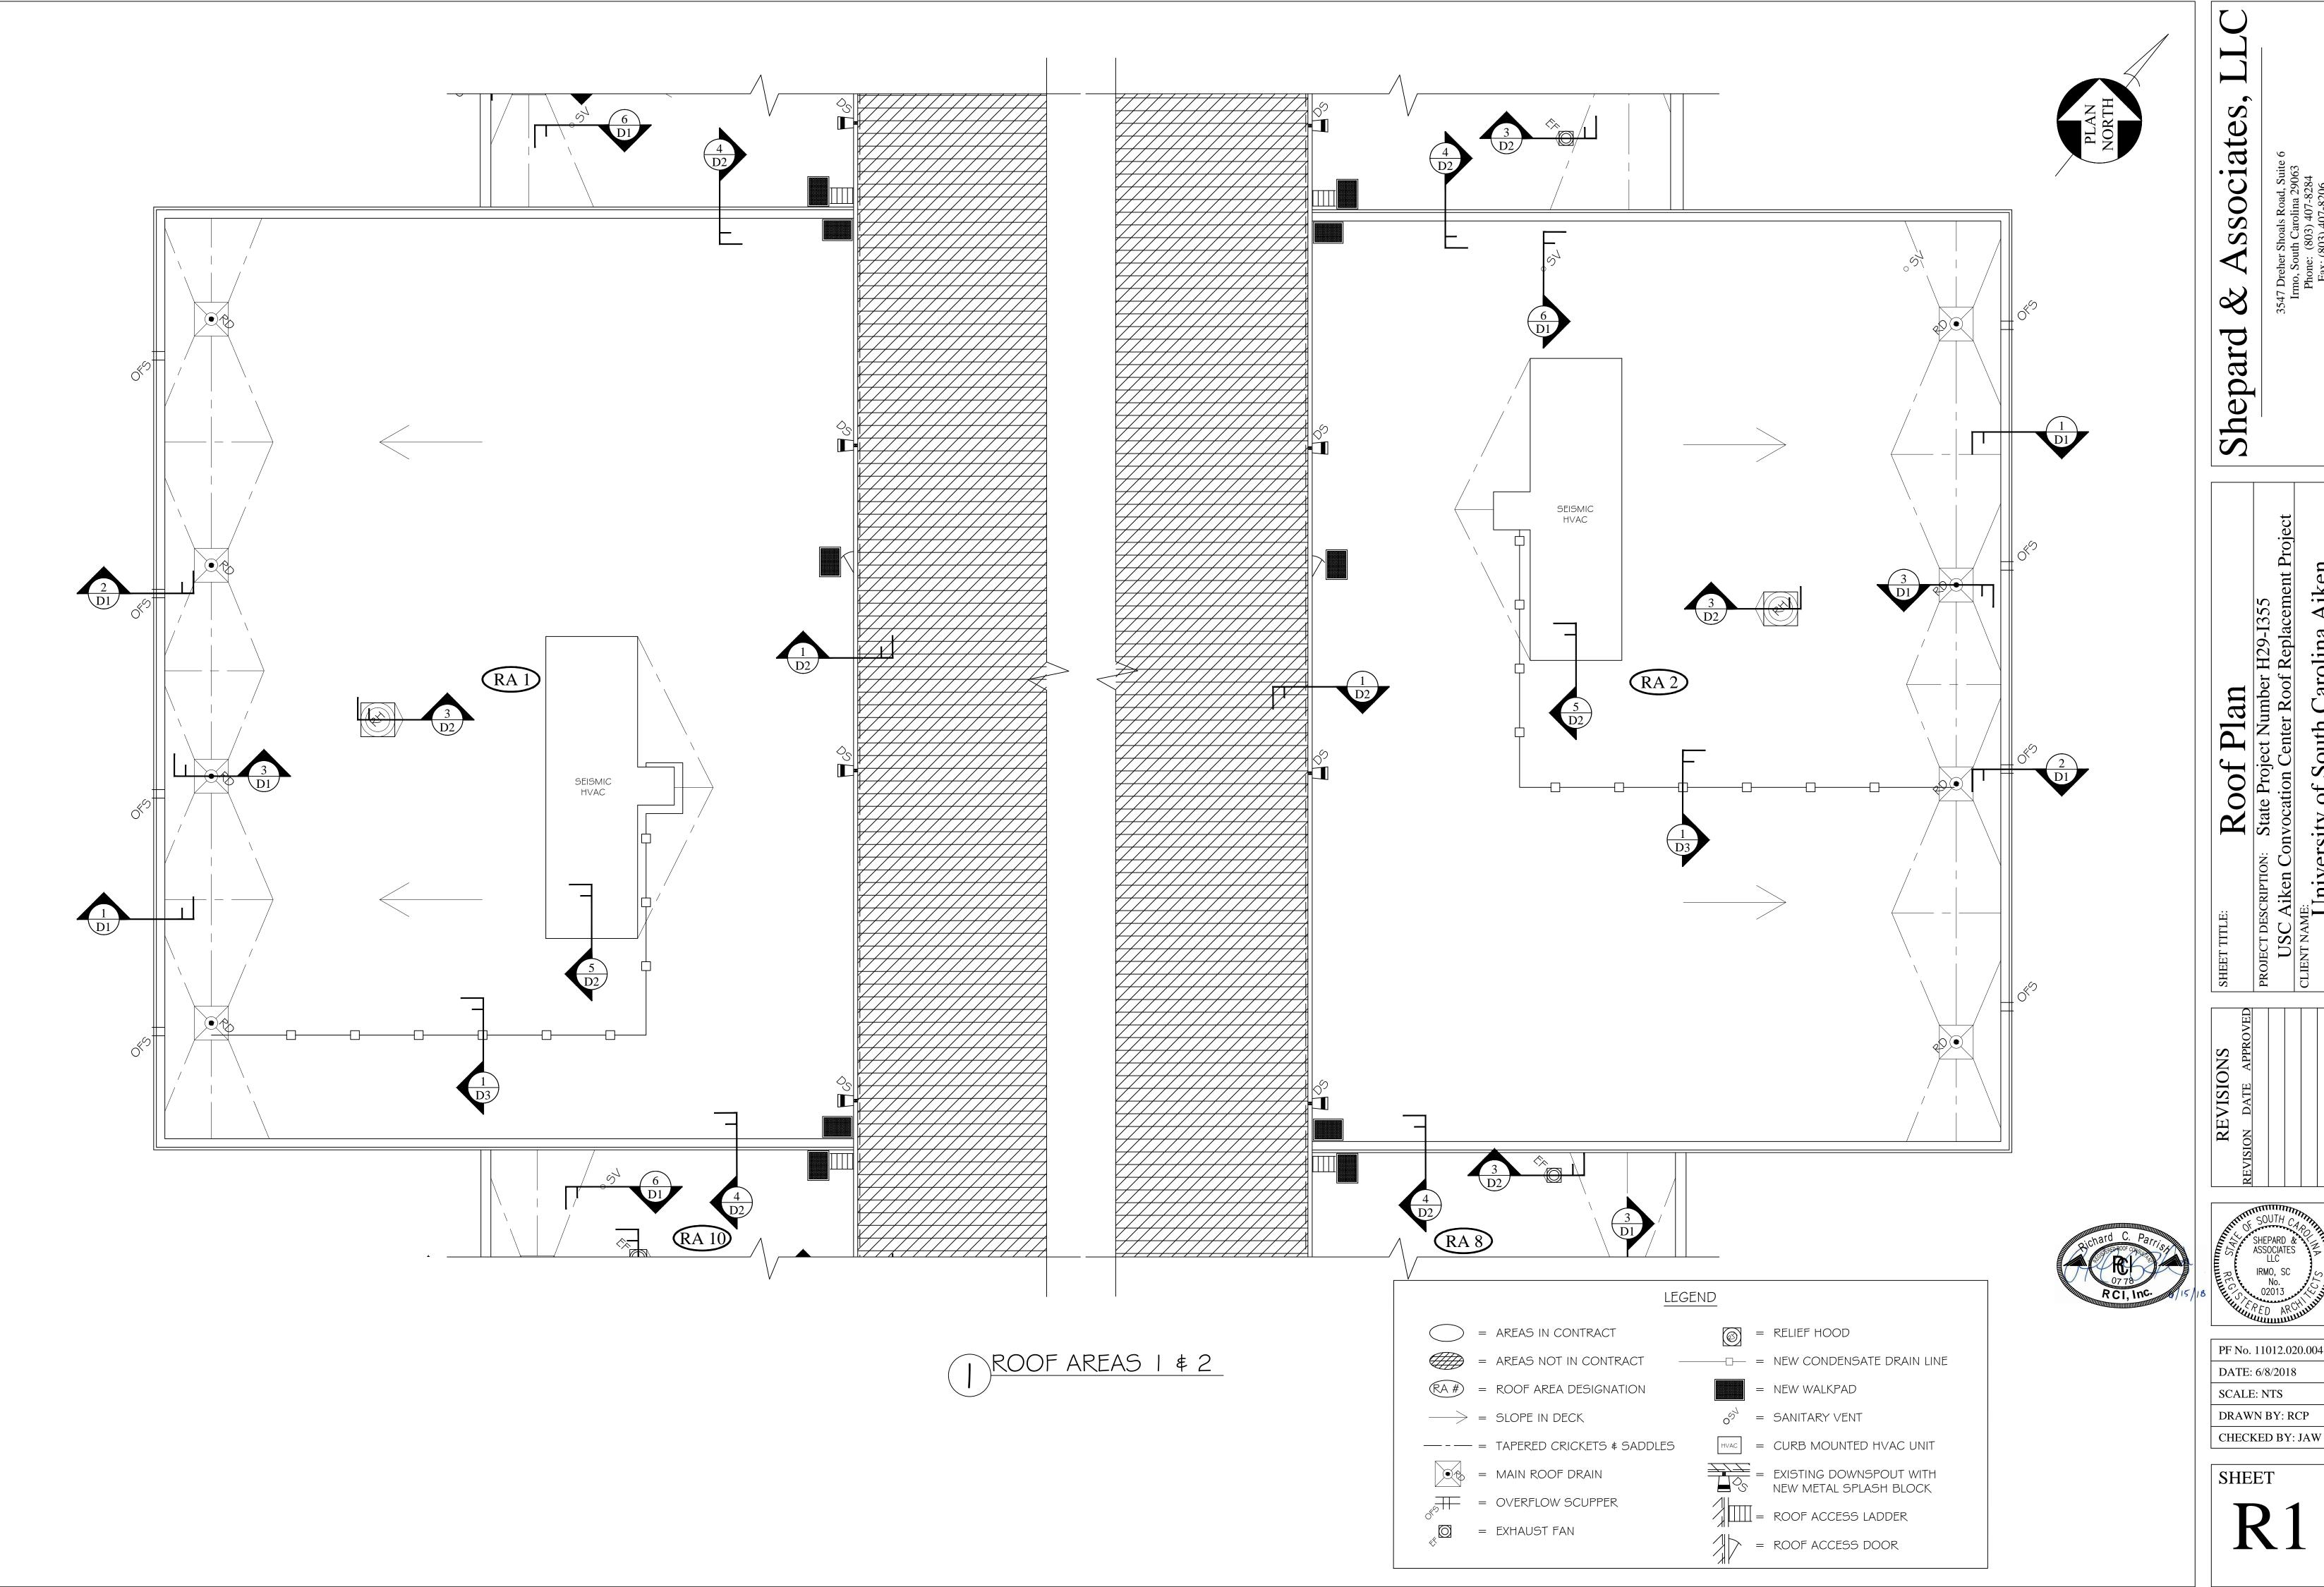



PF No. 11012.020.004 DATE: 6/8/2018

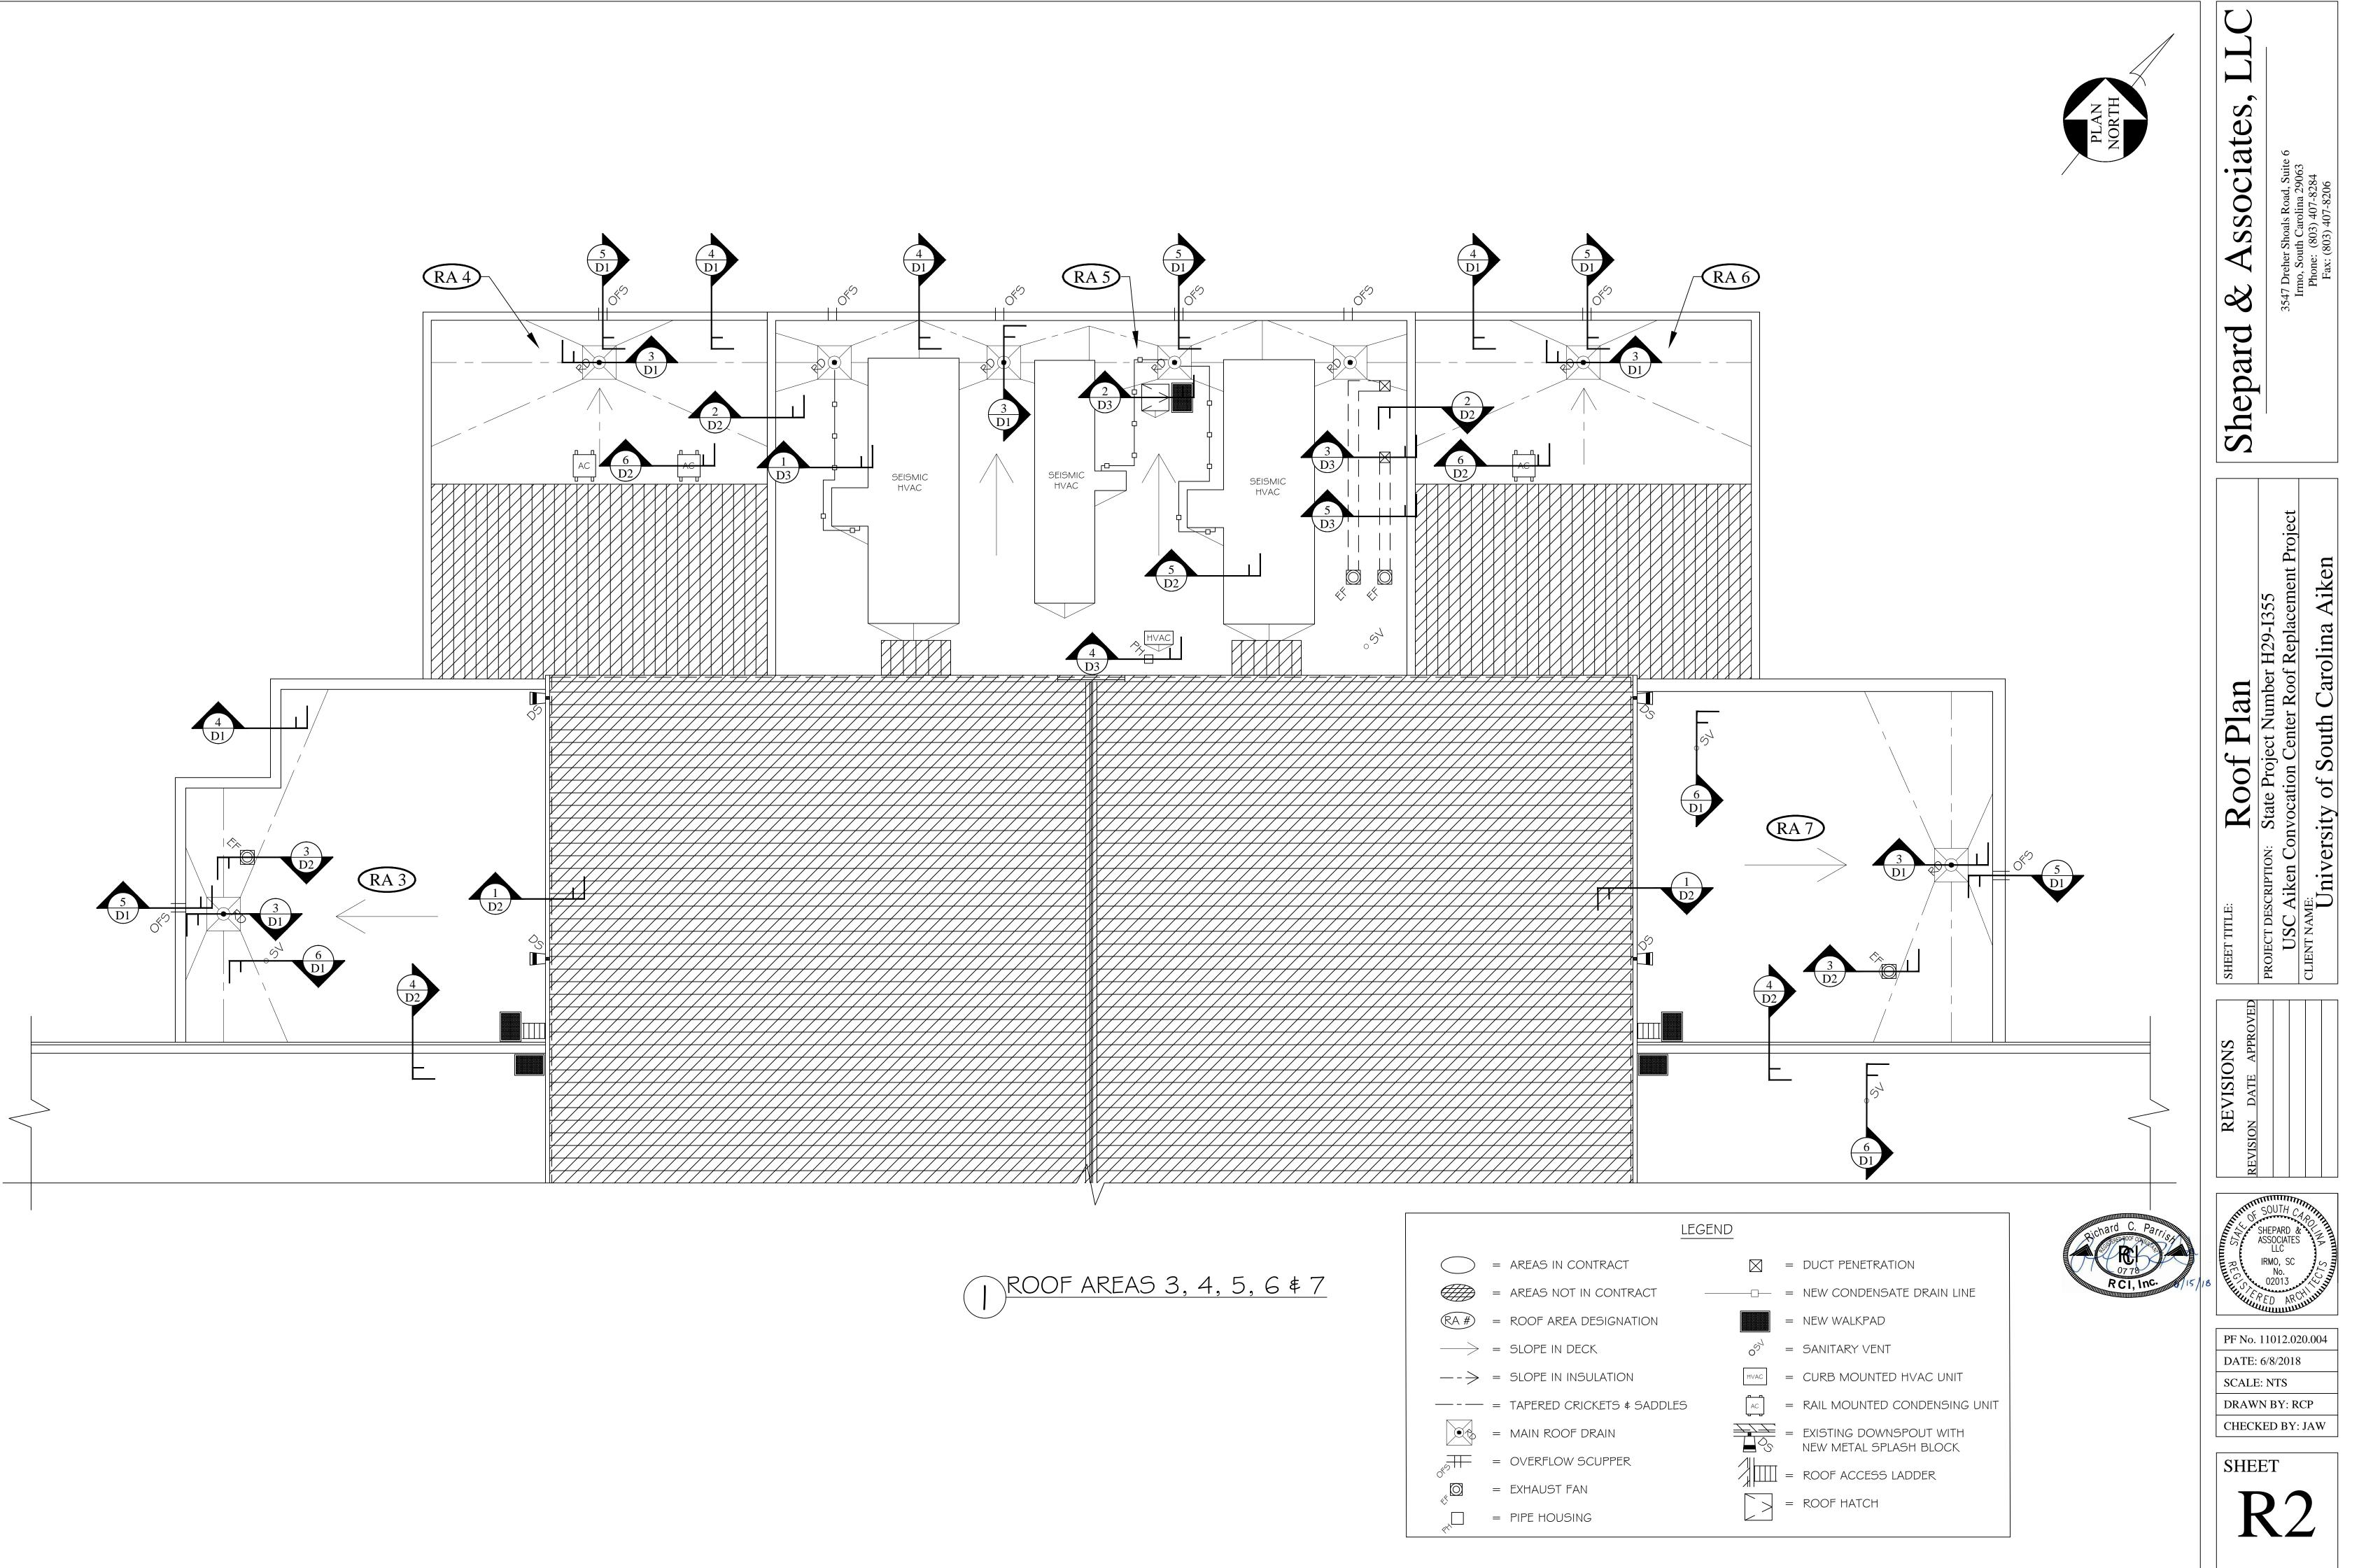


PF No. 11012.020.004 DATE: 6/8/2018

SCALE: NTS DRAWN BY: RCP

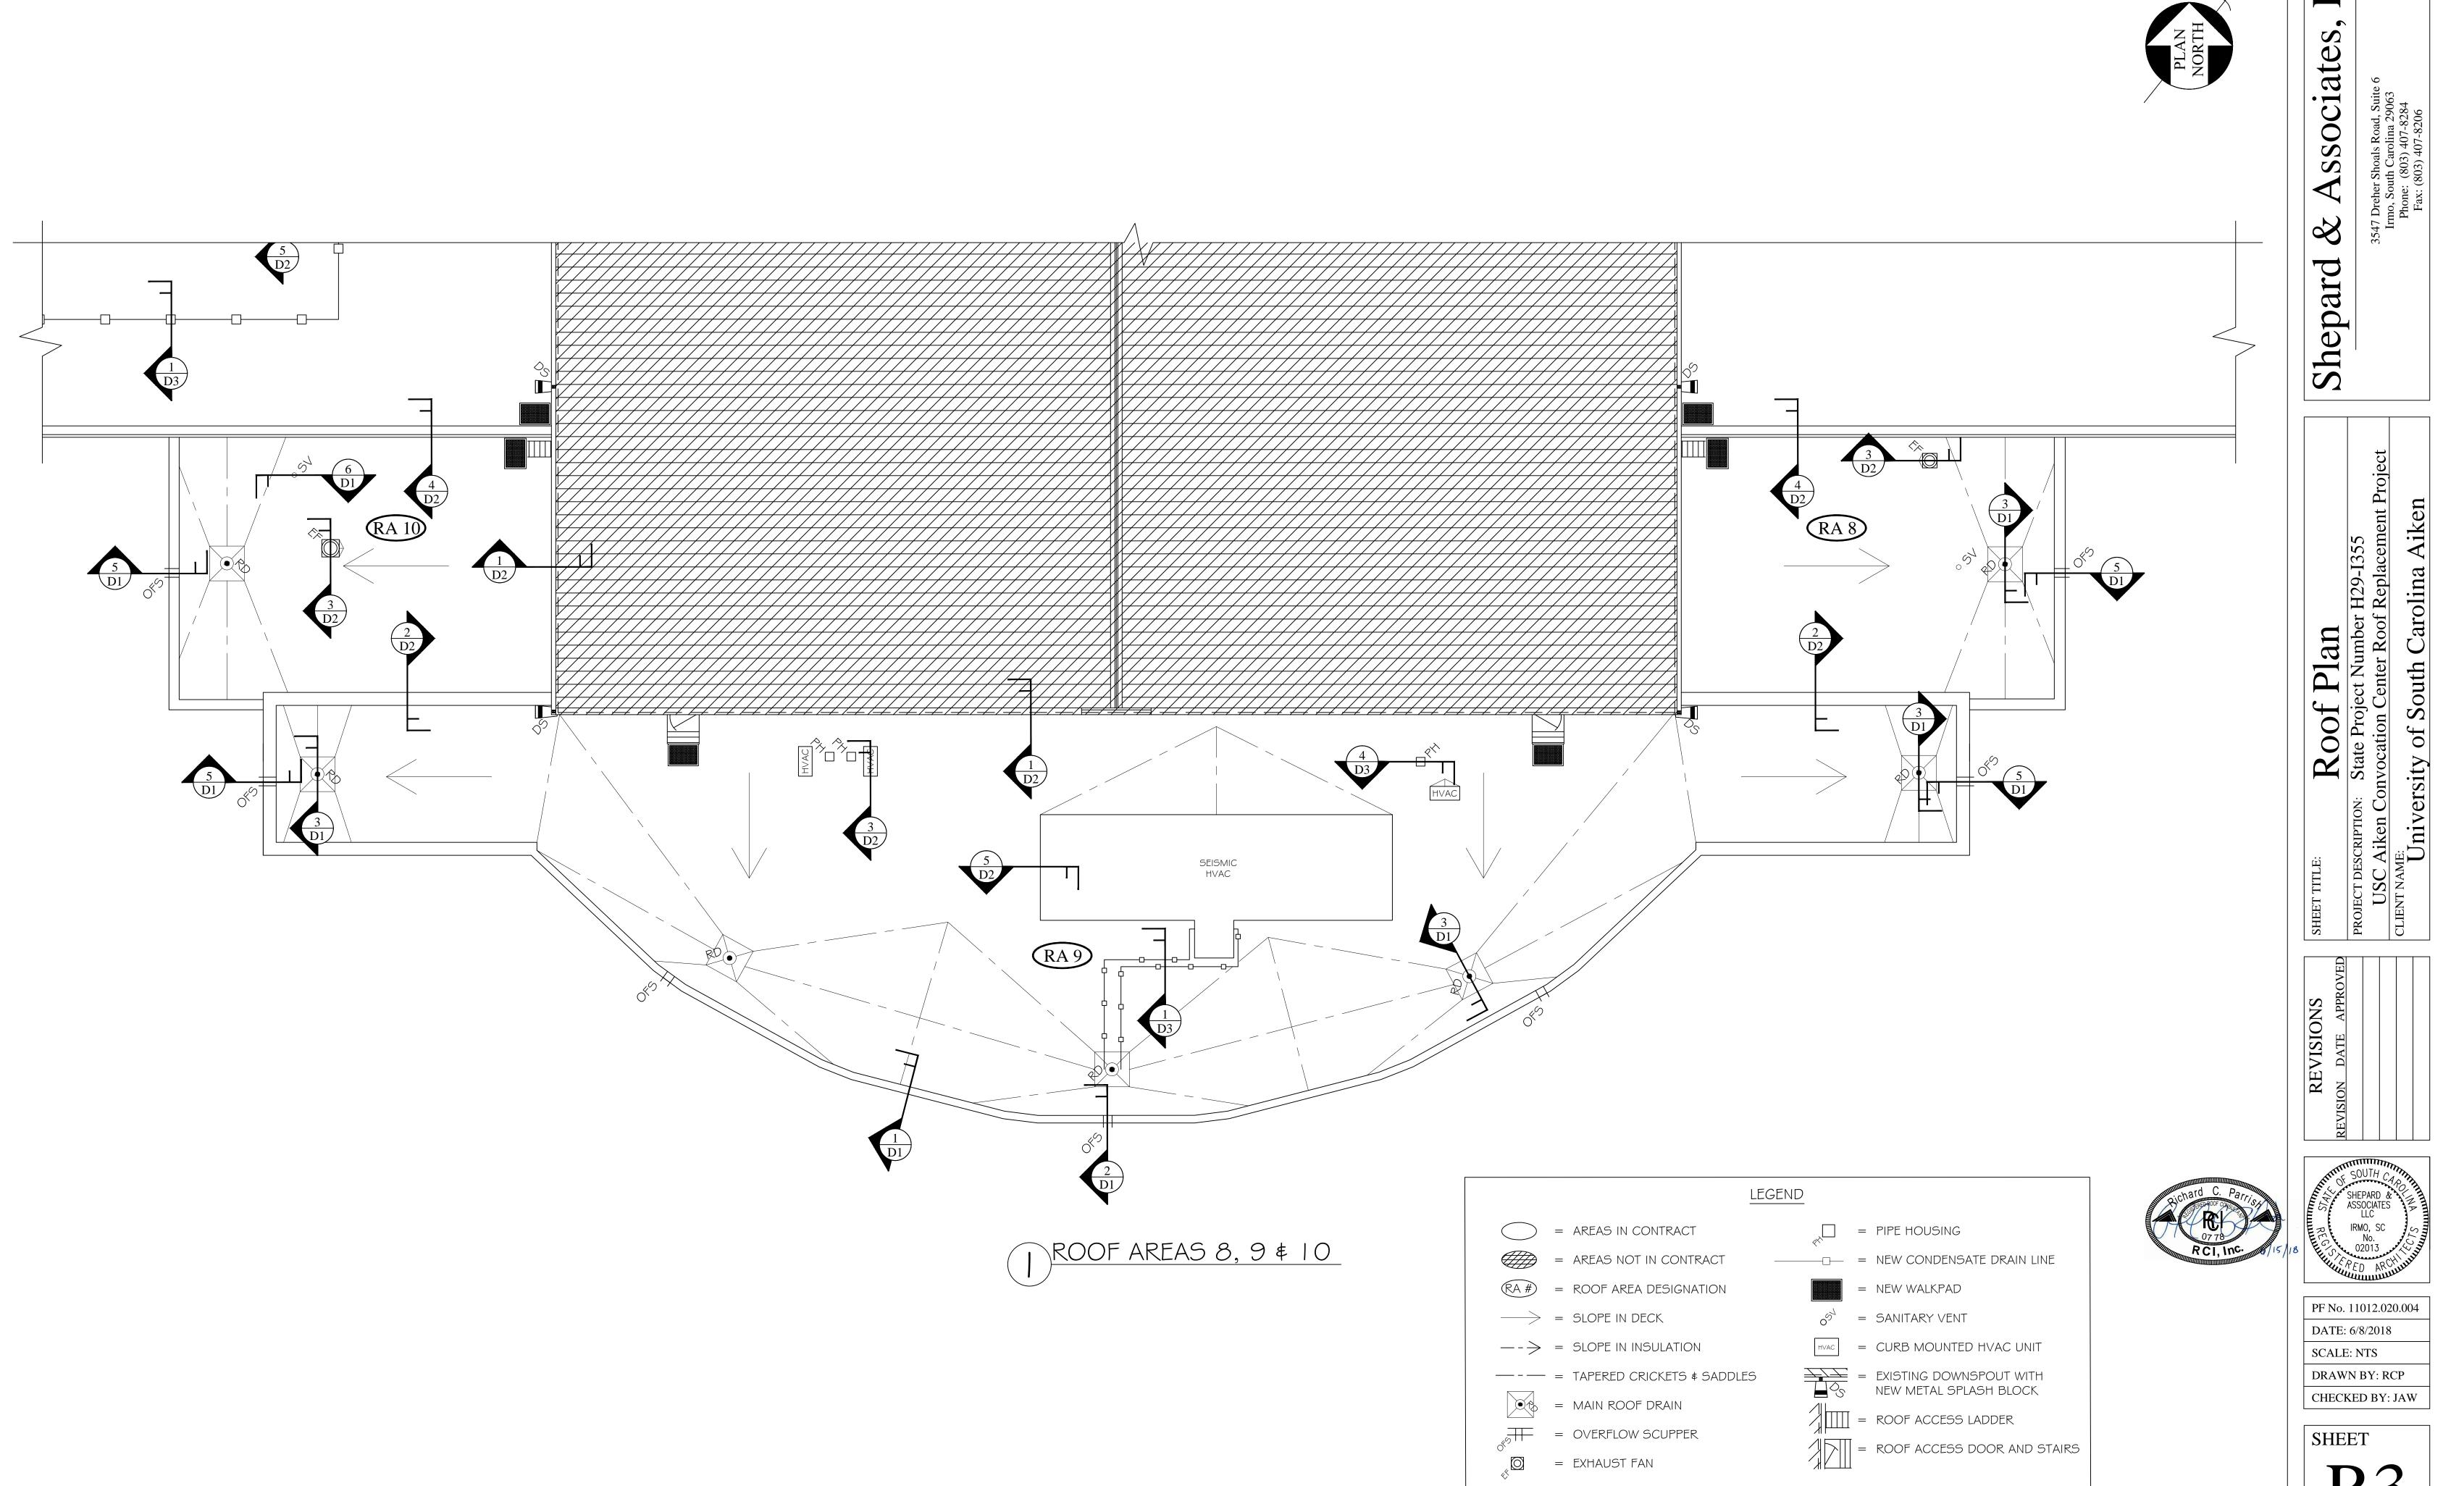

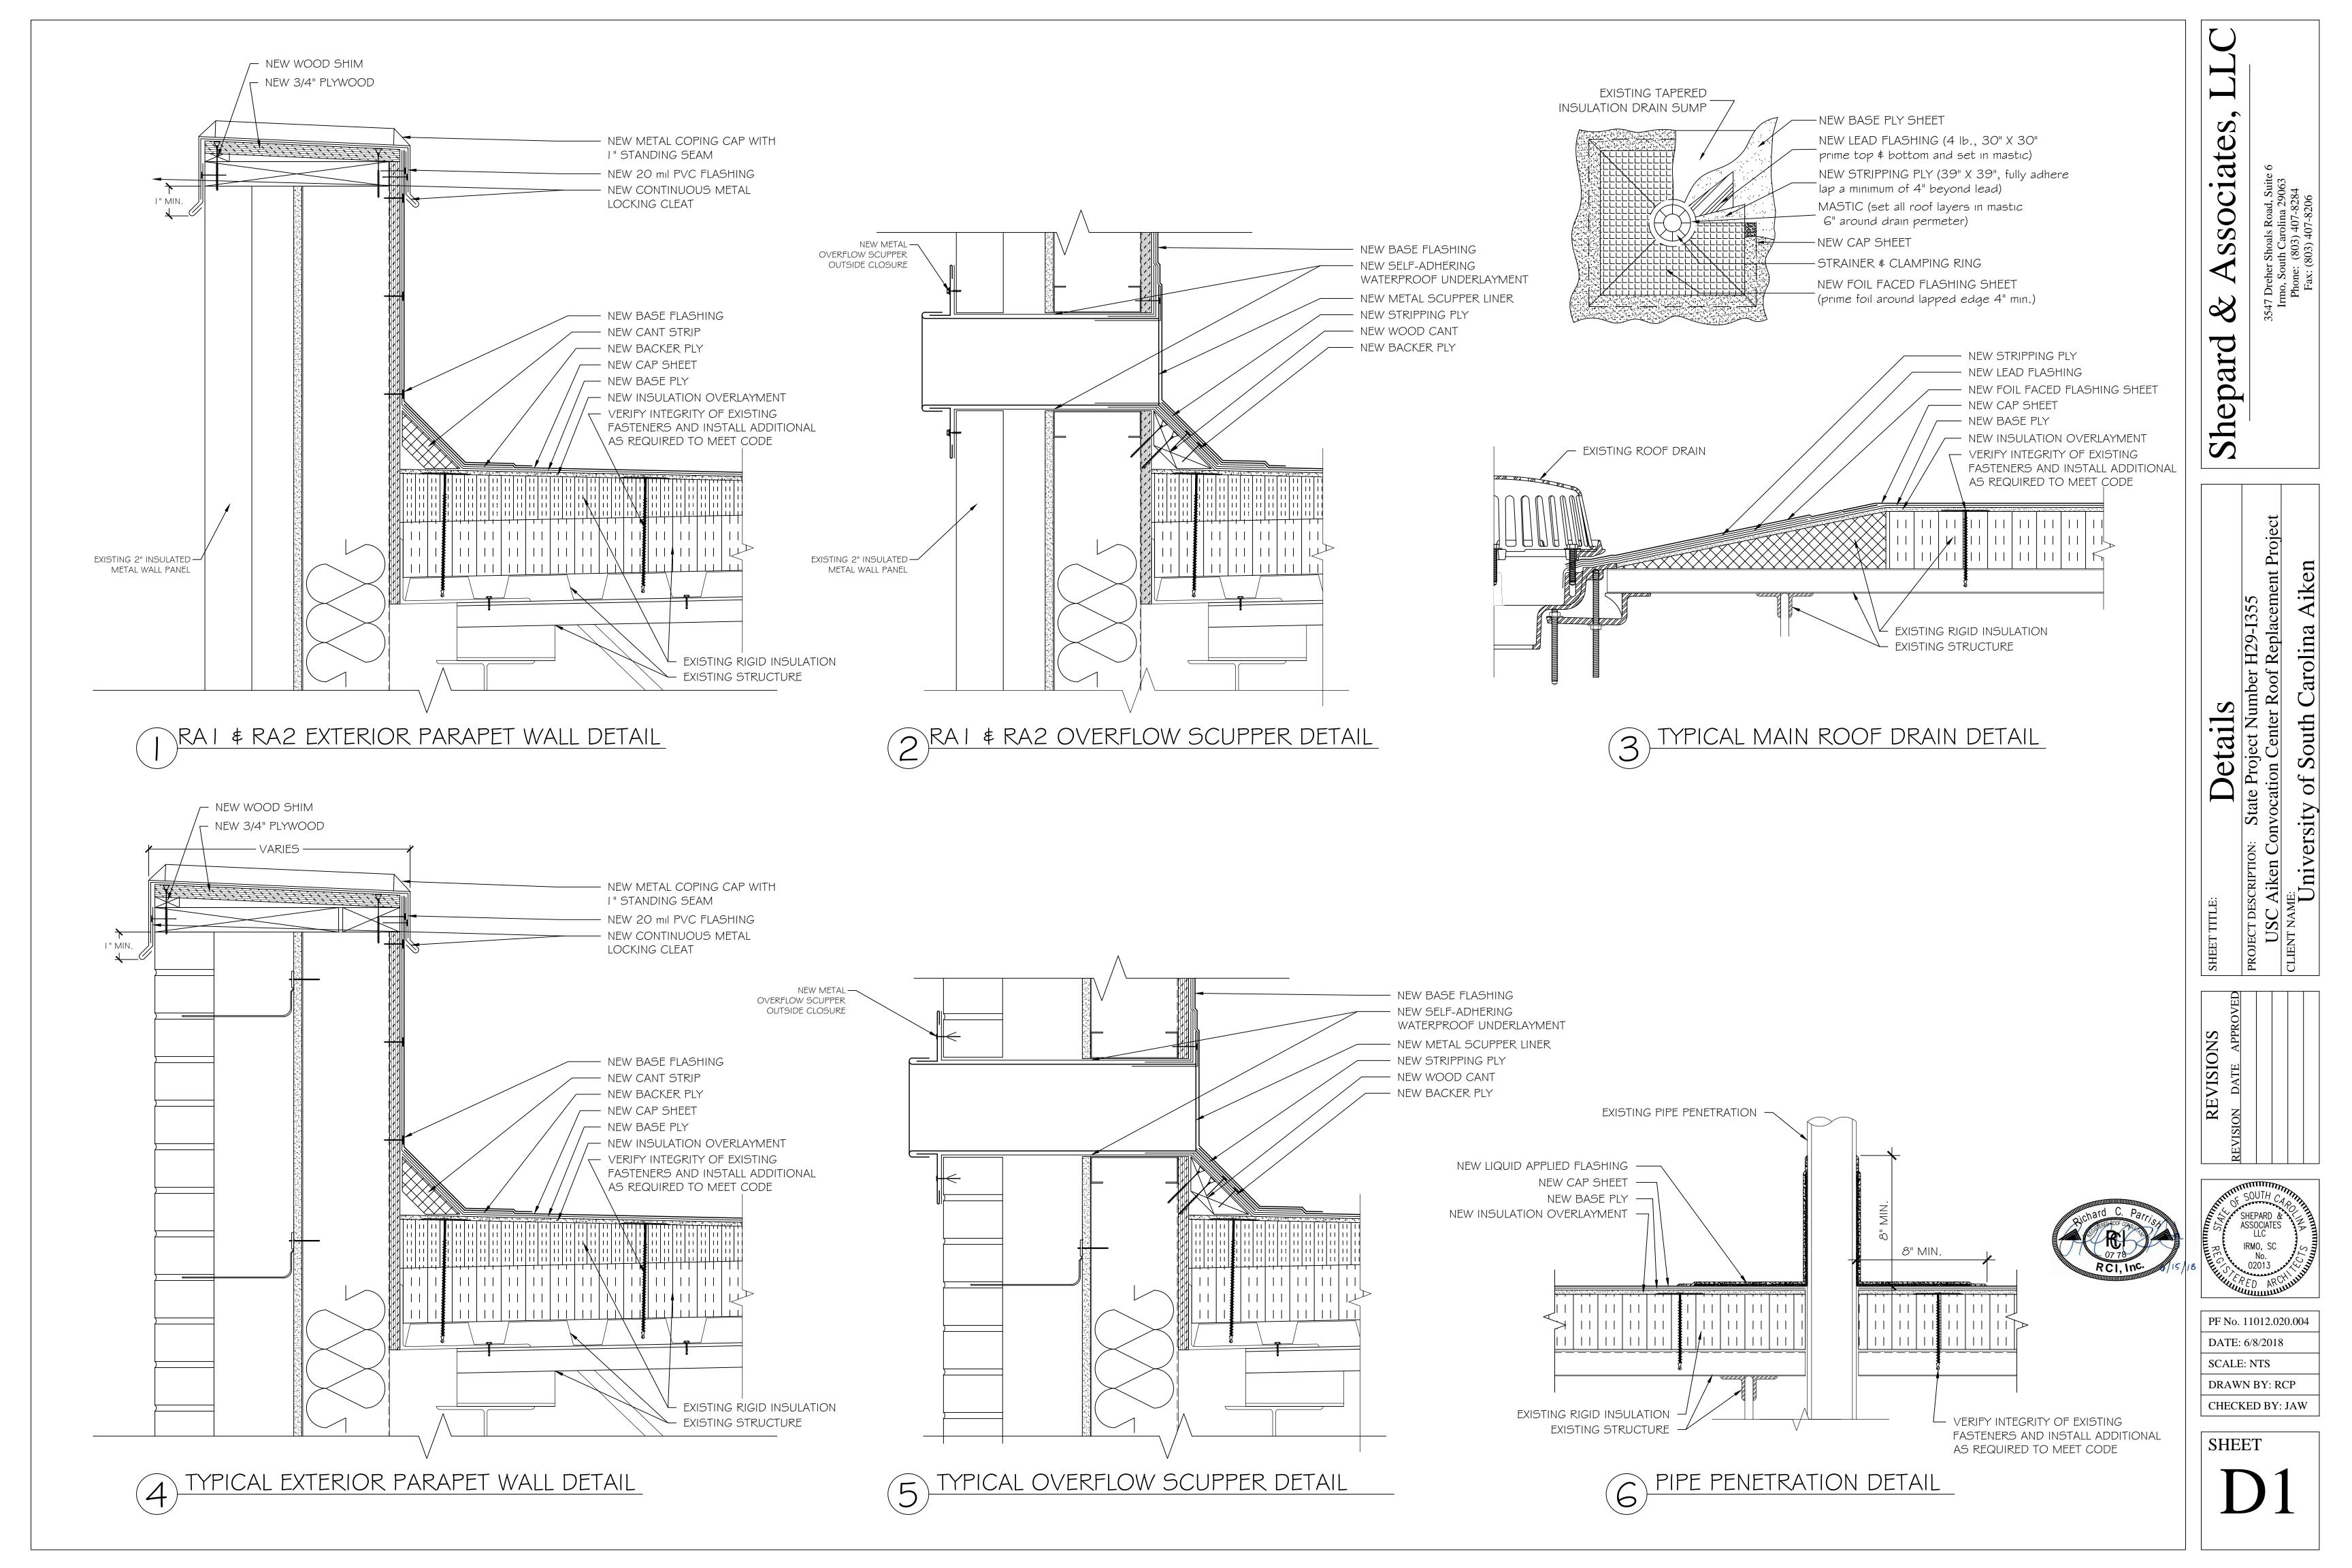

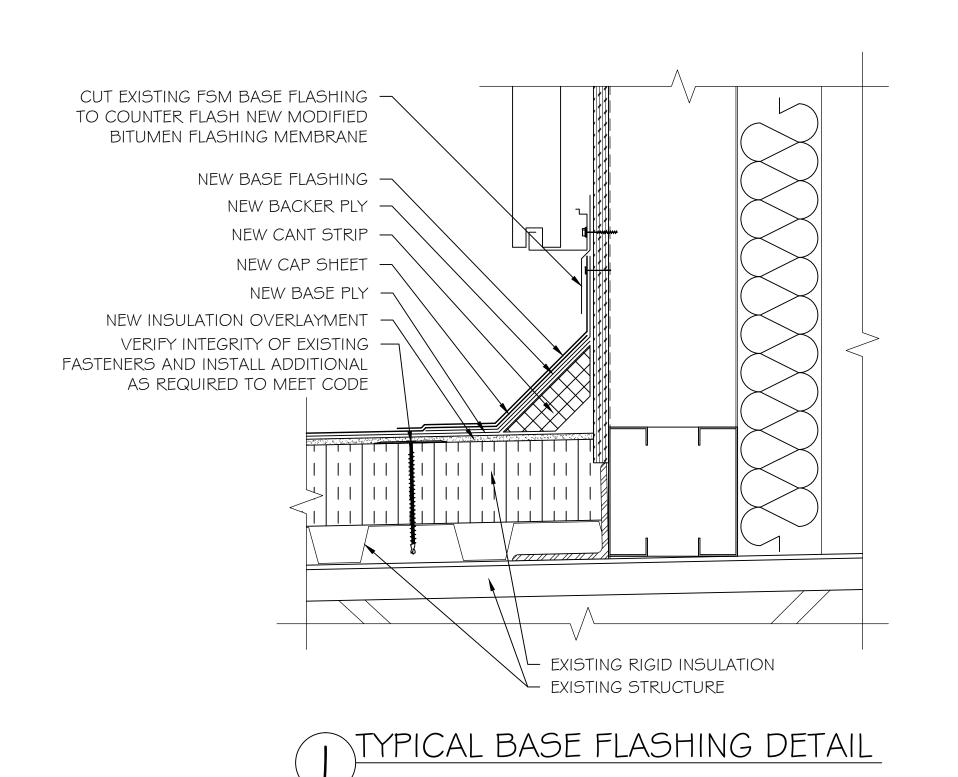

NEW LIQUID APPLIED FLASHING -

NEW METAL COUNTER FLASHING

CUT BACK EXISTING METAL

NEW METAL LOCKING CLEAT

APRON FLASHING

NEW BASE FLASHING .

NEW BACKER PLY

NEW CAP SHEET

NEW CANT STRIP

NEW BASE PLY

MEET CODE

EXISTING RIGID INSULATION

EXISTING STRUCTURE


4 BASE FLASHING DETAIL


NEW INSULATION OVERLAYMENT

VERIFY INTEGRITY OF EXISTING -


ADDITIONAL AS REQUIRED TO


FASTENERS AND INSTALL

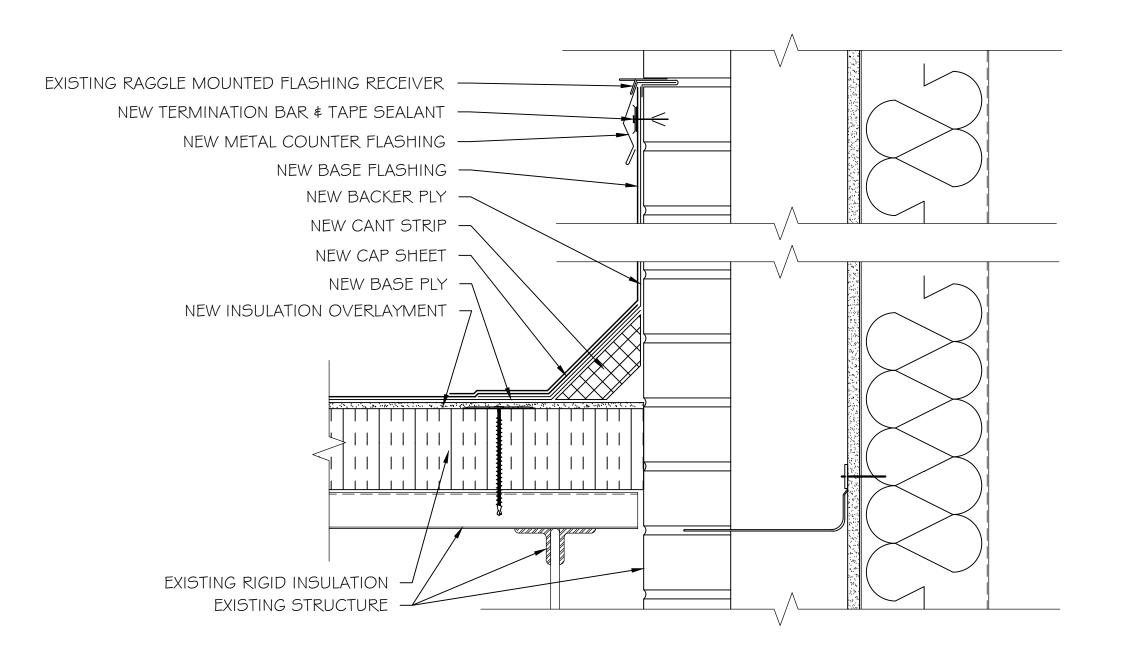


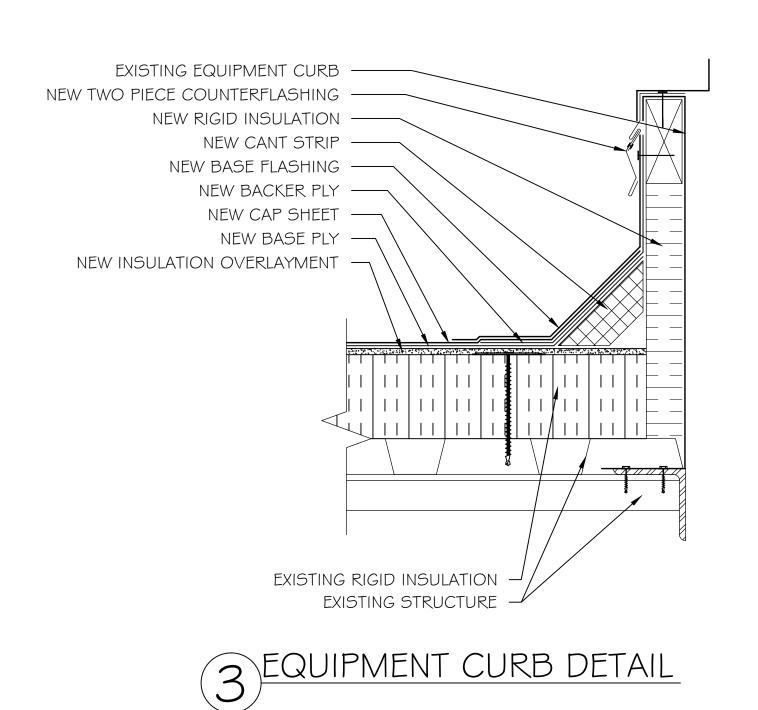

2 MASONRY WALL BASE FLASHING DETAIL

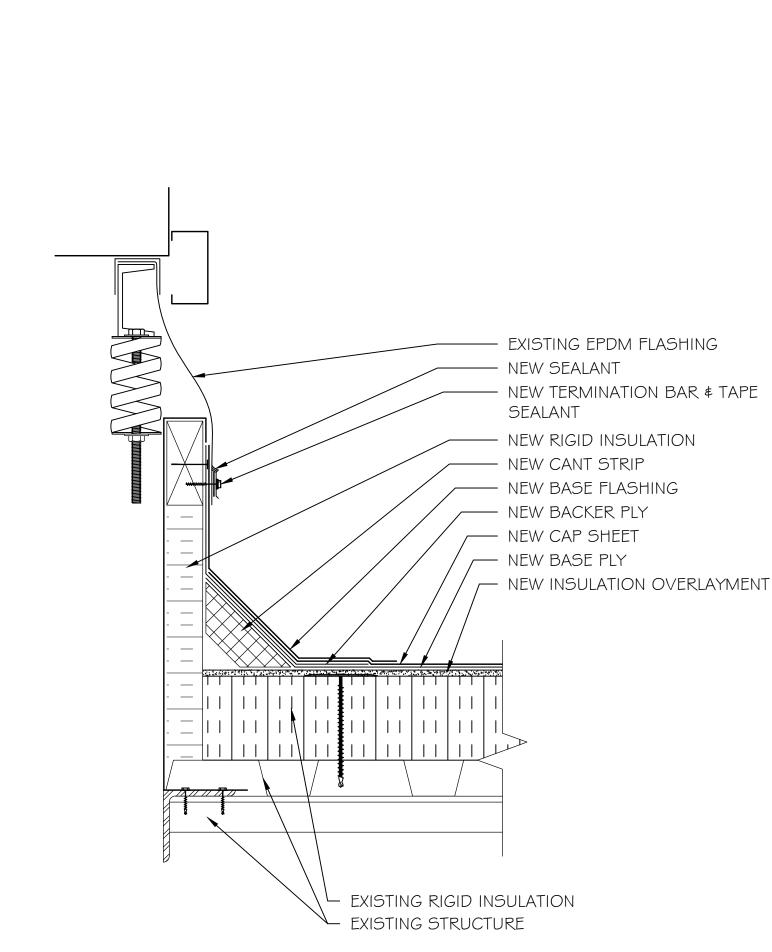

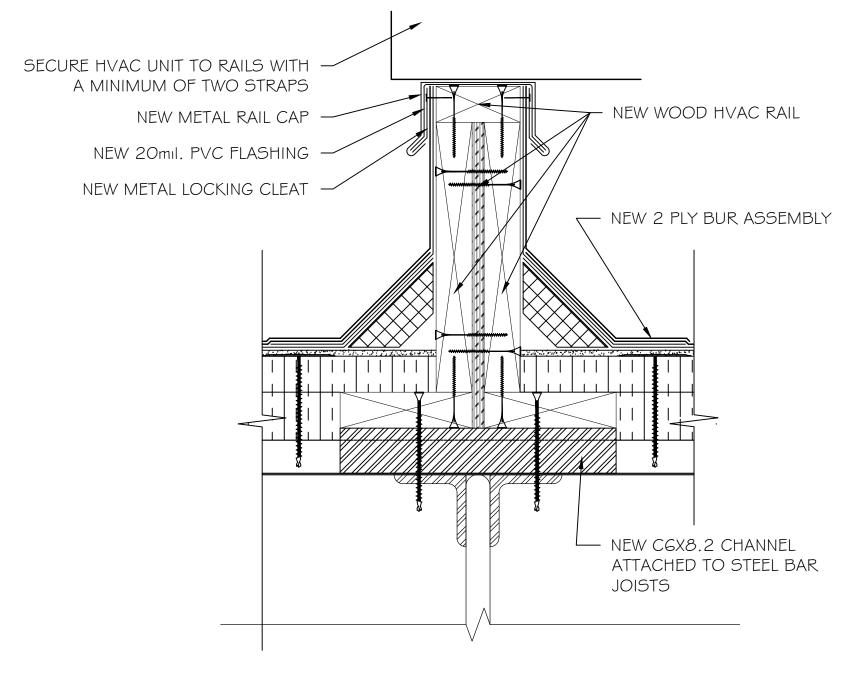

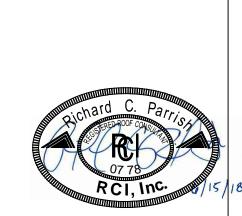

EXISTING INSULATED WALL PANEL

5 SEISMIC HVAC CURB DETAIL

6 NEW HVAC RAIL DETAIL

SHEPARD & ASSOCIATES LLC

ssociate

8

Shepard

tate Project Number H29-I355 ocation Center Roof Replacement Project

Carolina,

South

PROJECT DESCRIPTION: Sta

USC Aiken Convo

PF No. 11012.020.004 DATE: 6/8/2018

SCALE: NTS DRAWN BY: RCP

CHECKED BY: JAW

SHEET



EXISTING RIGID INSULATION

NEW SHEET-METAL

INSULATE VOID AS

AWAY FROM HOOD

COUNTER FLASHING — NEW BASE FLASHING

-EXISTING INSULATION

-EXISTING METAL DECK

--- NEW CANT STRIP

- NEW BACKER PLY

NEW CAP SHEET

MEW BASE PLY

REQUIRED

ENCLOSURE WITH REMOVABLE

EXISTING SHEET -METAL DUCTS

EXISTING METAL DUCT SUPPORTS

TOP -- CROSSBREAK OR

SLOPE FOR DRAINAGE

NEW SHEET-METAL OR FLEX-TUBE COLLAR

SLOPE PIPES DOWN AND

NEW REMOVABLE SHEET-METAL

- EXISTING STRUCTURE

CONDENSATE DRAIN SUPPORT DETAIL

NEW PIPE GUIDE -

NEW PIPE SUPPORT -

NEW WALKPAD -

NEW CAP SHEET -

MIN. 4" CLEARANCE FROM PIPE TO TOP OF CURB; MIN.

> NEW SHEET-METAL FLASHING RECEIVER

2" BETWEEN PIPES

EXISTING PIPE HOUSING CURB —

NEW INSULATION OVERLAYMENT

NEW BASE PLY -

NEW PVC CONDENSATE DRAIN

NEW INSULATION OVERLAYMENT -




NEW BASE FLASHING -

NEW BACKER PLY

NEW CANT STRIP

- EXISTING RIGID INSULATION

EXISTING STRUCTURE

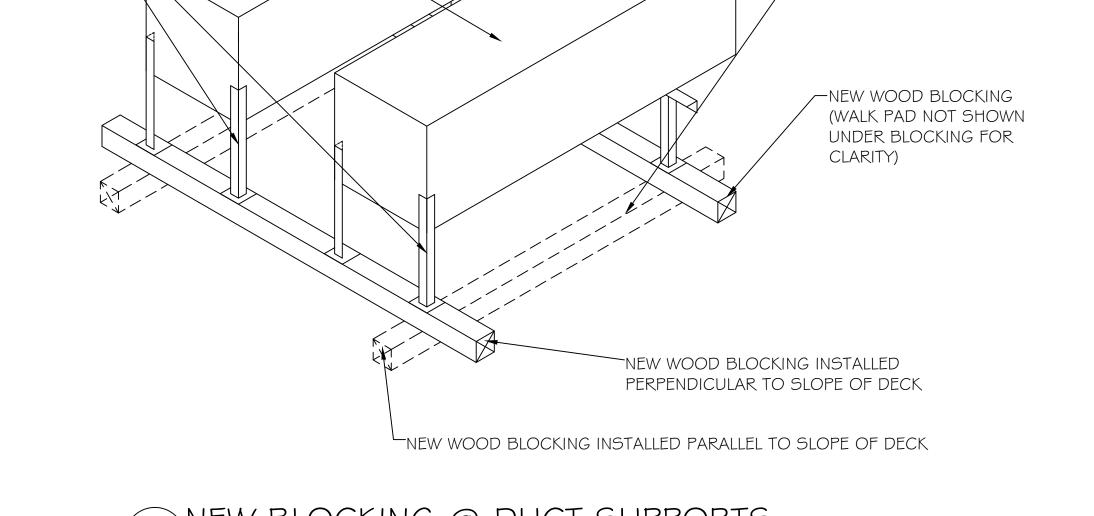

\* \* \* \* \*

2 ROOF HATCH DETAIL

EXISTING ROOF HATCH TO BE

WIRE BRUSHED, PRIMED AND PAINTED

EXISTING WOOD

NEW WOOD BLOCKING

UNDER ROOF MEMBRANE

BLOCKING

/ NEW CAP SHEET

/ NEW BASE PLY

- NEW INSULATION OVERLAYMENT

EXISTING EQUIPMENT CURB

NEW WOOD BLOCING

NEW RIGID INSULATION -

NEW CANT STRIP

NEW BASE FLASHING -

NEW BACKER PLY

NEW CAP SHEET

NEW BASE PLY

NEW RIGID INSULATION


EXISTING STRUCTURE  $\Rightarrow$ 

3 DUCT PENETRATION DETAIL

NEW TWO PIECE COUNTERFLASHING

NEW INSULATION OVERLAYMENT



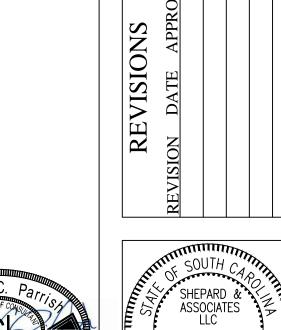

PF No. 11012.020.004

DATE: 6/8/2018

DRAWN BY: RCP

CHECKED BY: JAW

SCALE: NTS

SHEET

PROJECT DESCRIPTION: Sta

USC Aiken Convo

CLIENT NAME:

University

tate Project Number H29-I355 ocation Center Roof Replacement Project South Carolina Aiken

Shepard

Associates 8