




WILLIAMS BRICE STADIUM EAST GROUND LEVEL CONCESSION AREA DEMOLITION

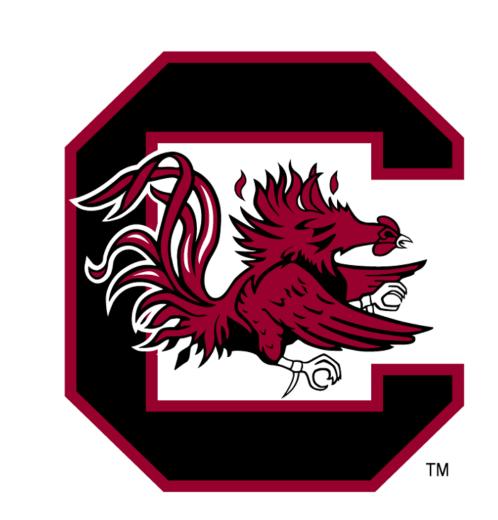

GEORGE ROGERS BOULEVARD COLUMBIA SC, 29201

VICINITY MAP YMPIA-GRANBY LOCATION

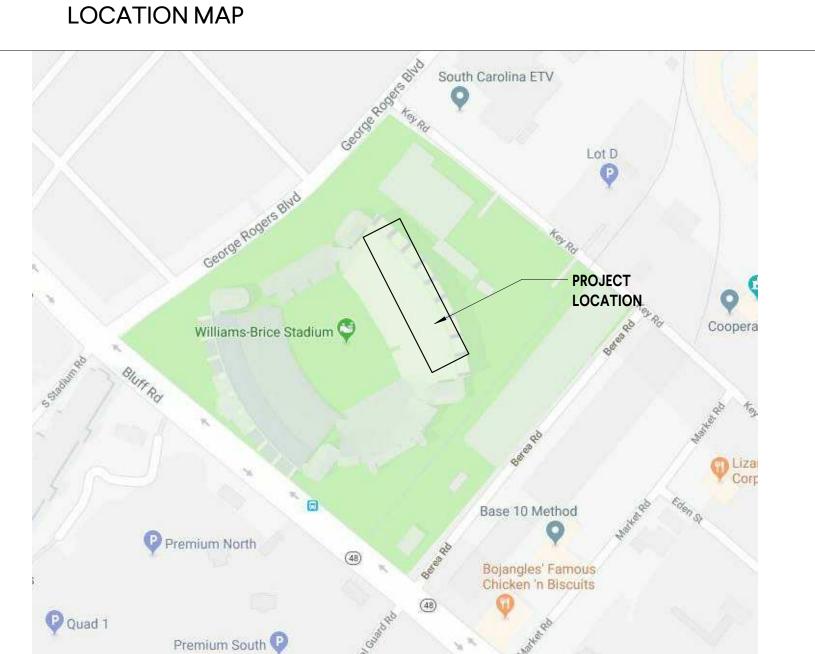

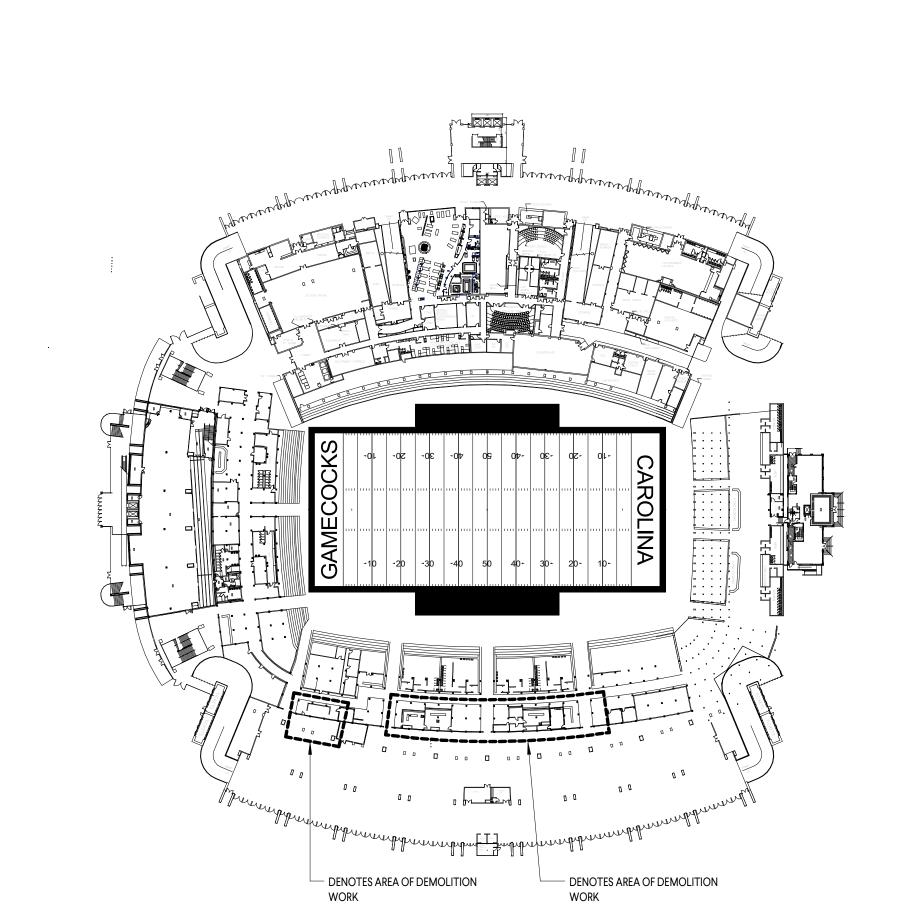

KEY PLAN, PROJECT SUMMARY, AND CODE ANALYSIS

PROJECT SUMMARY:

THE GROUND LEVEL CONCOURSE ON THE EAST SIDE OF WILLIAMS-BRICE STADIUM IS A LARGE OPEN AREA WITH SEVERAL FIXED AND MOBILE CONCESSION STANDS. THE SCOPE OF THIS PROJECT IS TO DEMOLISH THE EAST SIDE CONCESSION STANDS FOR FUTURE REPLACEMENT BY OTHERS.

PROJECT CODE ANALYSIS:

THIS PROJECT INVOLVES THE DEMOLITION OF EXISTING CONCESSION STANDS. ALL DEMOLITION WORK SHALL COMPLY WITH EPA REGULATIONS, ANSI/ ASSE A10.6 AND NFPA 241 AND OTHER APPLICABLE DEMOLITION REGULATIONS OF AUTHORITIES HAVING JURISDICTION AS NOTED IN PROJECT


PROJECT TEAM


ARCHITECTS STRUCTURAL ENGINEERS MECHANICAL ENGINEERS ELECTRICAL ENGINEERS


GOODWYN MILLS AND CAWOOD, INC. TIMMERMAN STRUCTURAL ENGINEERS SWYGERT \$ ASSOCIATES BELKA ENGINEERING

INDEX OF DRAWINGS			
No.	Sheet Name	Rev#	Rev Date
A0.01	TITLE SHEET		
AD1.0	OVERALL DEMOLITION PLAN		
AD1.01	ROOF DEMOLITION PLAN		
PD1.0	DEMOLITION PLAN		
ED1.0	OVERALL ELECTRICAL DEMOLITION PLAN		



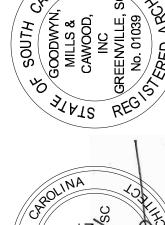

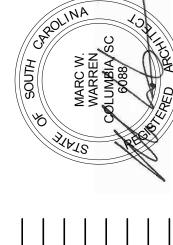

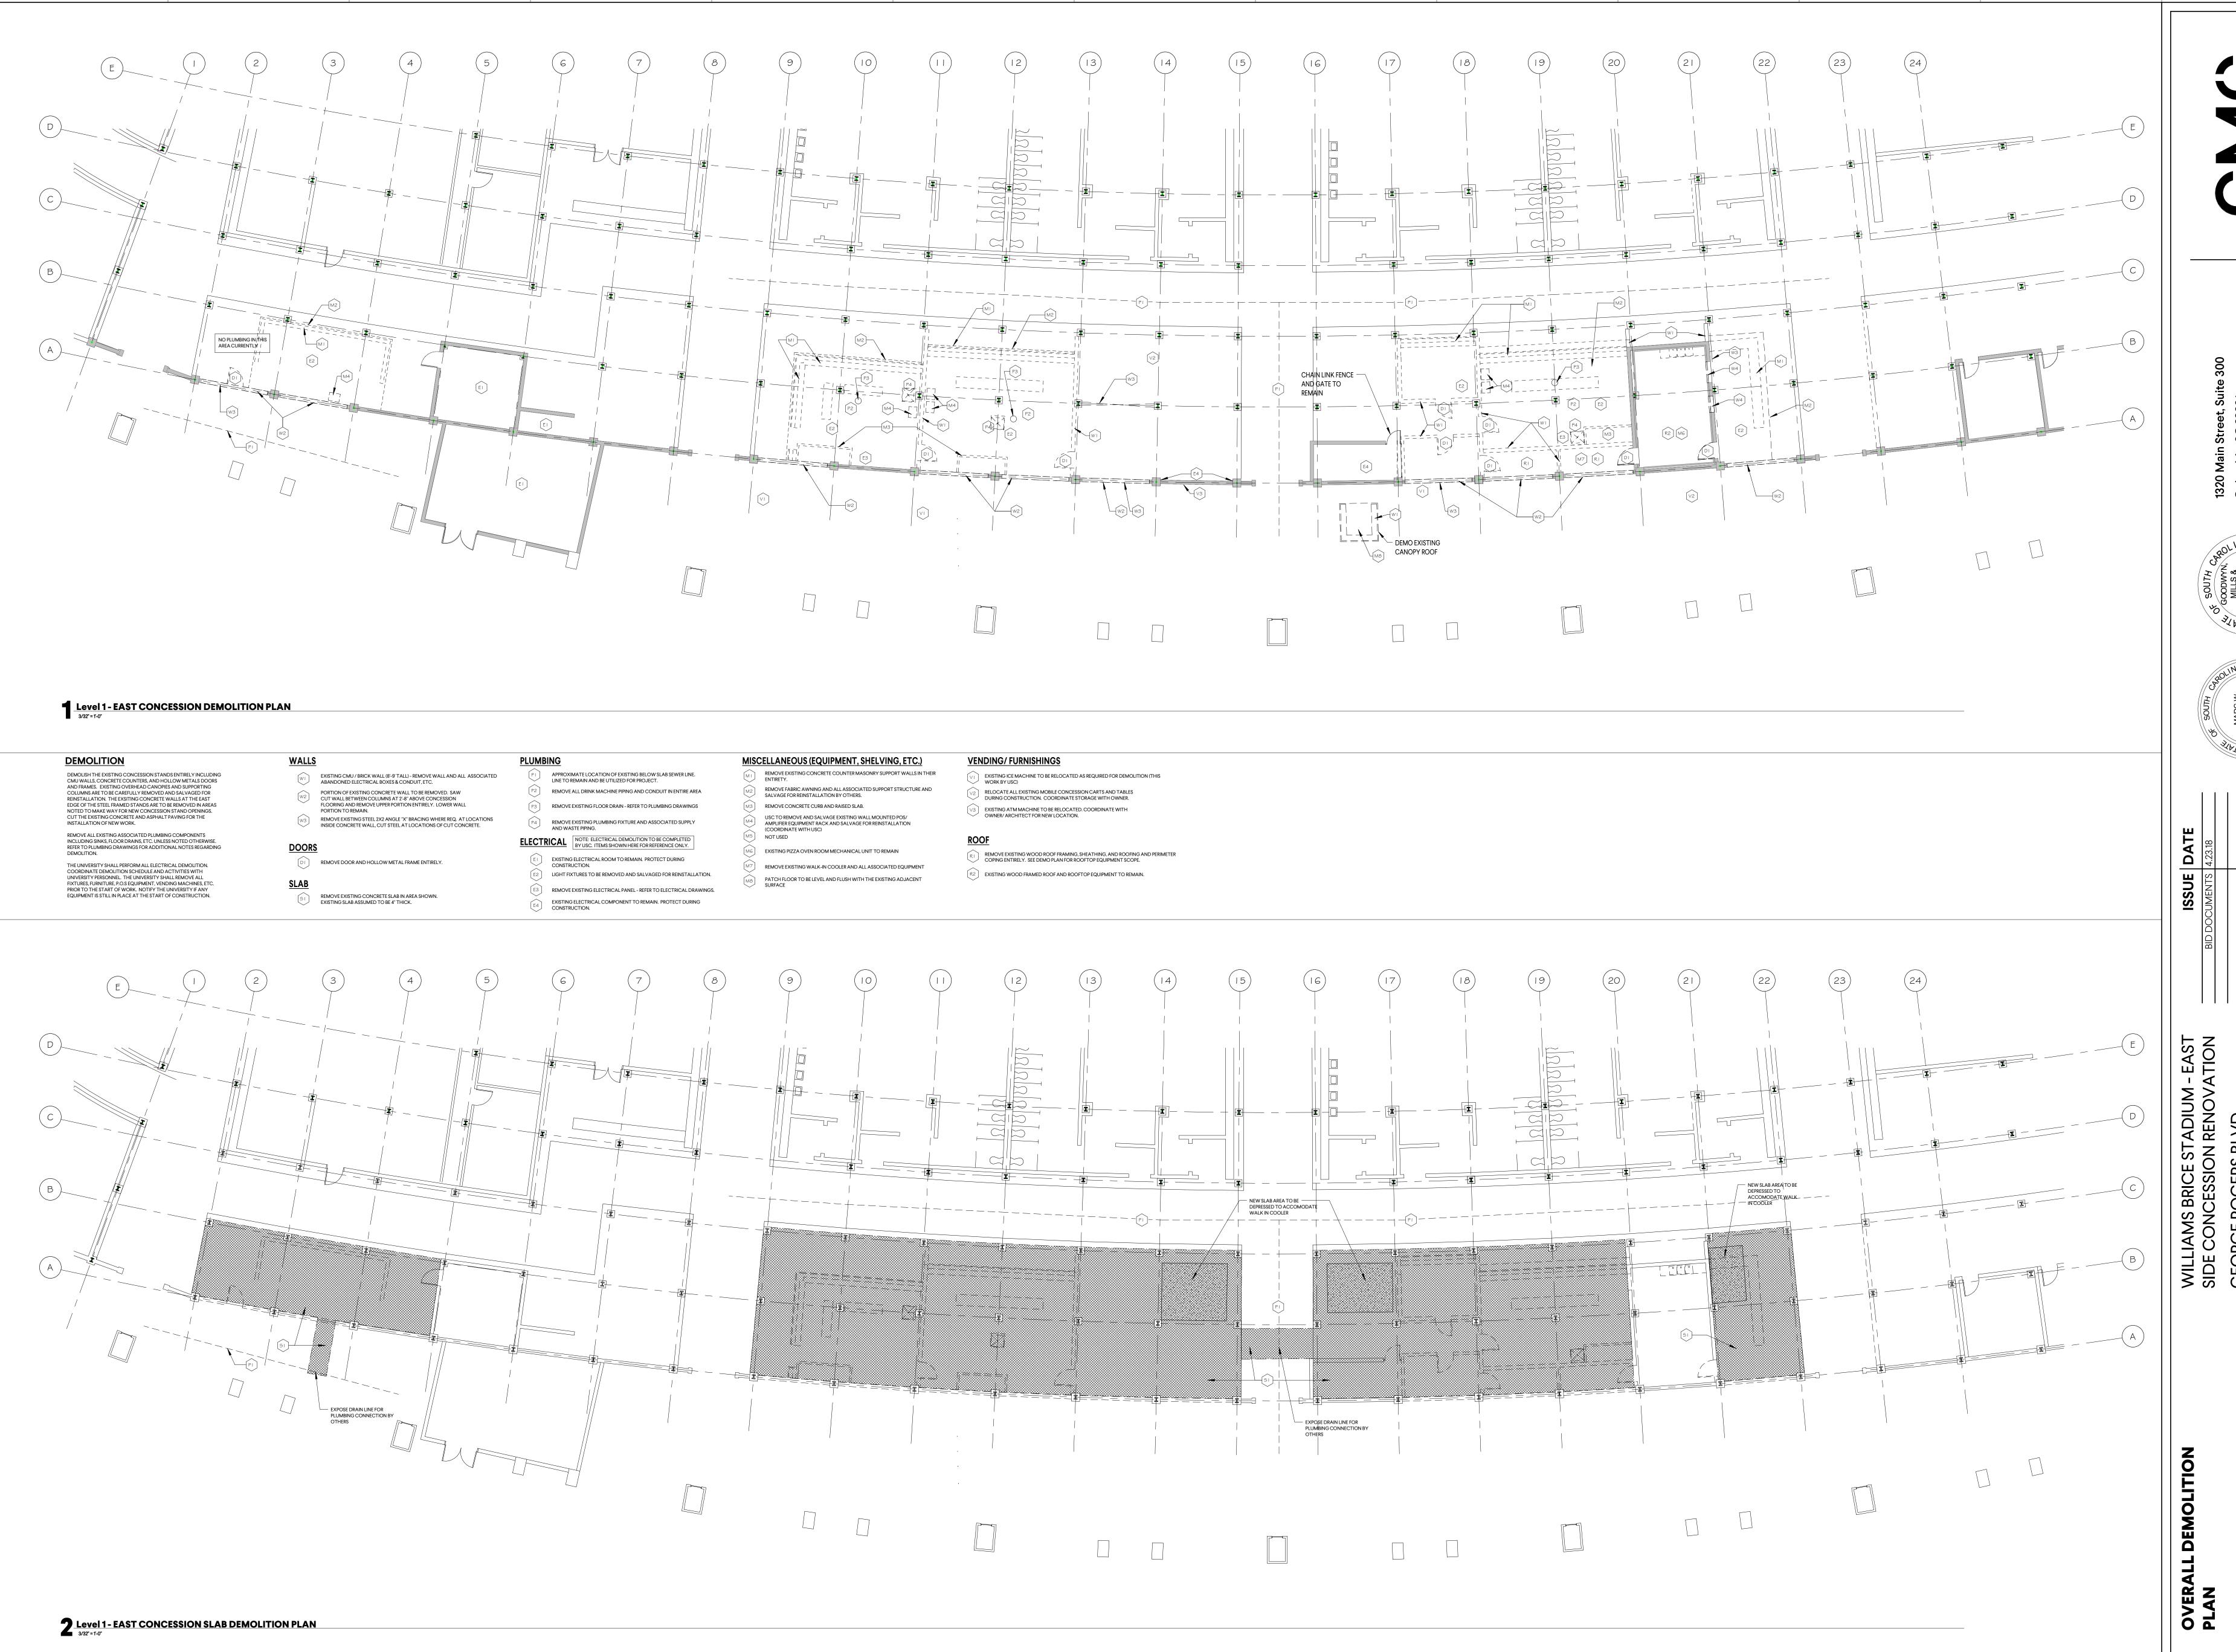



DEMOLITION ROOF PLAN3/3/2" = 1'-0"

DEMOLITION

DEMOLISH THE EXISTING CONCESSION STANDS ENTIRELY INCLUDING CMU WALLS, CONCRETE COUNTERS, AND HOLLOW METALS DOORS AND FRAMES. EXISTING OVERHEAD CANOPIES AND SUPPORTING COLUMNS ARE TO BE CAREFULLY REMOVED AND SALVAGED FOR REINSTALLATION. THE EXSITING CONCRETE WALLS AT THE EAST EDGE OF THE STEEL FRAMED STANDS ARE TO BE REMOVED IN AREAS NOTED TO MAKE WAY FOR NEW CONCESSION STAND OPENINGS. CUT THE EXISTING CONCRETE AND ASPHALT PAVING FOR THE INSTALLATION OF NEW WORK.

REMOVE ALL EXISTING ASSOCIATED PLUMBING COMPONENTS INCLUDING SINKS, FLOOR DRAINS, ETC. UNLESS NOTED OTHERWISE.
REFER TO PLUMBING DRAWINGS FOR ADDITIONAL NOTES REGARDING THE UNIVERSITY SHALL PERFORM ALL ELECTRICAL DEMOLITION. COORDINATE DEMOLITION SCHEDULE AND ACTIVITIES WITH UNIVERSITY PERSONNEL. THE UNIVERSITY SHALL REMOVE ALL FIXTURES, FURNITURE, P.O.S EQUIPMENT, VENDING MACHINES, ETC. PRIOR TO THE START OF WORK. NOTIFY THE UNIVERSITY IF ANY EQUIPMENT IS STILL IN PLACE AT THE START OF CONSTRUCTION.

REMOVE EXISTING CONCRETE SLAB IN AREA SHOWN. EXISTING SLAB ASSUMED TO BE 4" THICK.

- **WALLS** EXISTING CMU / BRICK WALL (8'-9' TALL) - REMOVE WALL AND ALL ASSOCIATED ABANDONED ELECTRICAL BOXES & CONDUIT, ETC.
- PORTION OF EXISTING CONCRETE WALL TO BE REMOVED. SAW CUT WALL BETWEEN COLUMNS AT 2-8" ABOVE CONCESSION FLOORING AND REMOVE UPPER PORTION ENTIRELY. LOWER WALL PORTION TO REMAIN. REMOVE EXISTING STEEL 2X2 ANGLE "X" BRACING WHERE REQ. AT LOCATIONS INSIDE CONCRETE WALL, CUT STEEL AT LOCATIONS OF CUT CONCRETE.

DI REMOVE DOOR AND HOLLOW METAL FRAME ENTIRELY.

PLUMBING

- APPROXIMATE LOCATION OF EXISTING BELOW SLAB SEWER LINE. LINE TO REMAIN AND BE UTILIZED FOR PROJECT. REMOVE ALL DRINK MACHINE PIPING AND CONDUIT IN ENTIRE AREA

ELECTRICAL NOTE: ELECTRICAL DEMOLITION TO BE COMPLETED BY USC. ITEMS SHOWN HERE FOR REFERENCE ONLY.

AND WASTE PIPING.

EXISTING ELECTRICAL ROOM TO REMAIN. PROTECT DURING CONSTRUCTION. LIGHT FIXTURES TO BE REMOVED AND SALVAGED FOR REINSTALLATION. REMOVE EXISTING ELECTRICAL PANEL - REFER TO ELECTRICAL DRAWINGS.

REMOVE EXISTING FLOOR DRAIN - REFER TO PLUMBING DRAWINGS

REMOVE EXISTING PLUMBING FIXTURE AND ASSOCIATED SUPPLY

EXISTING ELECTRICAL COMPONENT TO REMAIN. PROTECT DURING CONSTRUCTION.

MISCELLANEOUS (EQUIPMENT, SHELVING, ETC.)

- REMOVE EXISTING CONCRETE COUNTER MASONRY SUPPORT WALLS IN THEIR ENTIRETY.
 - REMOVE FABRIC AWNING AND ALL ASSOCIATED SUPPORT STRUCTURE AND SALVAGE FOR REINSTALLATION BY OTHERS. REMOVE CONCRETE CURB AND RAISED SLAB.
 - USC TO REMOVE AND SALVAGE EXISTING WALL MOUNTED POS/ AMPLIFIER EQUIPMENT RACK AND SALVAGE FOR REINSTALLATION (COORDINATE WITH USC)
 - NOT USED EXISTING PIZZA OVEN ROOM MECHANICAL UNIT TO REMAIN
 - REMOVE EXISTING WALK-IN COOLER AND ALL ASSOCIATED EQUIPMENT PATCH FLOOR TO BE LEVEL AND FLUSH WITH THE EXISTING ADJACENT SURFACE

VENDING/ FURNISHINGS

- EXISTING ICE MACHINE TO BE RELOCATED AS REQUIRED FOR DEMOLITION (THIS WORK BY USC)
- RELOCATE ALL EXISTING MOBILE CONCESSION CARTS AND TABLES DURING CONSTRUCTION. COORDINATE STORAGE WITH OWNER.


EXISTING ATM MACHINE TO BE RELOCATED. COORDINATE WITH OWNER/ ARCHITECT FOR NEW LOCATION.

- REMOVE EXISTING WOOD ROOF FRAMING, SHEATHING, AND ROOFING AND PERIMETER COPING ENTIRELY. SEE DEMO PLAN FOR ROOFTOP EQUIPMENT SCOPE.
- R2 EXISTING WOOD FRAMED ROOF AND ROOFTOP EQUIPMENT TO REMAIN.

WILLIAMS BRICE STADIUM - EAST SIDE CONCESSION RENOVATION GEORGE ROGERS BLVD.
COLUMBIA, SC 29201

GMC # ACOL180001

DEMOLITION NOTES EXISTING WATER HEATERS TO REMAIN PROPERTY OF THE OWNER. THE CONTRACTOR SHALL REMOVE WATER HEATERS FROM CONCESSION AREA AND TURN OVER TO THE OWNER. CAP ALL PLUMBING AS REQUIRED. SEE RENOVATION PLAN FOR CONNECTION TO EXISTING PLUMBING WITH NEW WATER HEATER. REMOVE ALL EXISTING PLUMBING FIXTURES, PIPING, FITTINGS, AND ACCESSORIES WITHIN THE EXISTING CONCESSION AREA. CONTRACTOR SHALL CAP ALL PLUMBING BELOW GRADE TO ALLOW FOR NEW FLOOR SLAB. ALL PLUMBING ABOVE GRADE SHALL BE CAPPED TO ALLOW FOR NEW CONCESSION BUILDINGS. NOTE: NEW FLOOR SLAB AND FUTURE PLUMBING ITEMS BY OTHERS. (23)BRICE STADIUM E CONCESSION WILLIAMS E EAST SIDE BENRYÆTK COLUMBIA Swygert & Associates SWYGERT AND ASSOCIATES, LTD.
NO. C00227 CONSULTING ENGINEERS

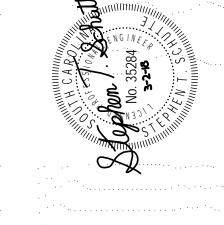




DBA Swygert & Assoc., Ltd. Telephone: (803) 791-9300
Post Office Box 11686 Facsimile: (803) 791-0830
Columbia, S.C. 29211 mail@swygert-associates.com

OVERALL POWER/SYSTEMS DEMOLITION PLAN

ED1.0 SCALE: 3/32" = 1'-0"

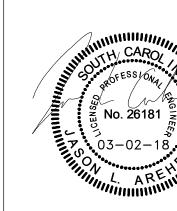

32 SCALE: 3/32" = 1'-0"



NOTE: ELECTRICAL DEMOLITION

SHALL BE PERFORMED BY USC.

SHOWN HERE FOR REFERENCE

ELECTRICAL DEMOLITION SCOPE

ONLY. DEMOLITION CONTRACTOR

SHALL COORDINATE DEMOLITION

SCOPE AND TIMING WITH DENNIS

GALLAGHER AT USC (803-777-4217).

