

SITE MAP

CAROLINA COLISEUM ROOF REPAIR

UNIVERSITY OF SOUTH CAROLINA 701 ASSEMBLY STREET COLUMBIA, SOUTH CAROLINA, 29201 STATE PROJECT NO. H27-Z334 REI PROJECT NO. 17CHS-023




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ROOF DETAILS			
ROOF DETAILS			

	ABBREVIATION LIST		
MAX.	MAXIMUM		
MIN.	MINIMUM		
N.I.C.	NOT IN CONTRACT		
N.T.S.	NOT TO SCALE		
O.C.	ON CENTER		
S.S.	STAINLESS STEEL		
SIM.	SIMILAR		
TERM.	TERMINATION		
TYP.	TYPICAL		

CODE COMPLIANCE REFERENCE LIST
2015 INTERNATIONAL BUILDING CODE WITH SC MODIFICATIONS
2015 INTERNATIONAL FIRE CODE WITH SC MODIFICATIONS
2015 INTERNATIONAL PLUMBING CODE
2015 INTERNATIONAL MECHANICAL CODE
2009 INTERNATIONAL ENERGY CONSERVATION CODE
2015 INTERNATIONAL FUEL GAS CODE WITH SC MODIFICATIONS
2014 NATIONAL ELECTRIC CODE



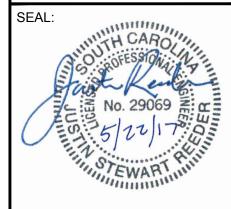

COVER SHEET

consistent with REI's rights while REI is providing service for the specific project identified or referred to herein or extensions thereto. It may not be used for any other purpose except with the express written agreement of, and compensation to, REI Engineers, Inc.

SECTOR AREA (SQUARE FEET) ±89,100 ±89,100 **CONTRACTOR TO VERIFY ALL
QUANTITIES PRIOR TO BIDDING**






UNIVERSIT' COLUMBIA, STATE PRC REI PROJE(

REVISION # REVISION DATE DRAWN BY: AD / RLW SCALE: N.T.S. 05/22/2017

ROOF PLAN

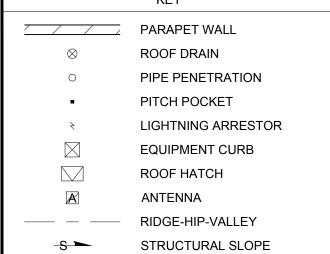

EXISTING TAPERED SLOPE

DETAIL NUMBER

NOTES:

1. CONTRACTOR TO VERIFY EXISTING CURB CONSTRUCTION.

2. INSTALL CRICKETS ON UP SLOPE SIDE OF CURBS.


3. CONTRACTOR TO FIELD VERIFY ALL QUANTITIES AND LOCATIONS.

4. NOTES ARE INTENDED TO PROVIDE TYPICAL LOCATIONS OF WORK. IT IS THE CONTRACTORS RESPONSIBILITY TO QUANTIFY ALL LOCATIONS.


5. ONLY ONE DETAIL SYMBOL IS SHOWN FOR EACH TYPE OF ROOF PENETRATION. ALL OTHER SIMILAR PENETRATIONS ARE TO BE FLASHED AS REQUIRED BY THE DETAIL LIMITESS OTHERWISE NOTED.

6. REPAIR OF SITE: CONTRACTOR SHALL REPAIR ALL DAMAGES TO GRASS, TREES, SHRUBS, SIDEWALKS, PAVEMENT, ETC. SURROUNDING THE BUILDING CAUSED DURING THE CONSTRUCTION PROCESS. REPAIRS TO THESE ITEMS SHALL BE PERFORMED TO THE OWNER'S SATISFACTION AT NO ADDITIONAL COST.

7. PROVIDE WALKWAY PAD UNDER ALL CONDENSING UNIT SUPPORT PADS OR EQUIPMENT SUPPORT FRAMES.

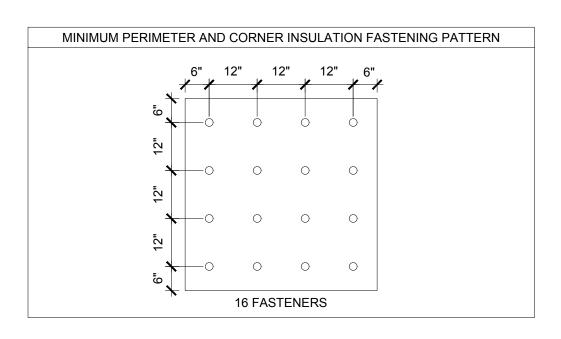

PERIMETER AND CORNER

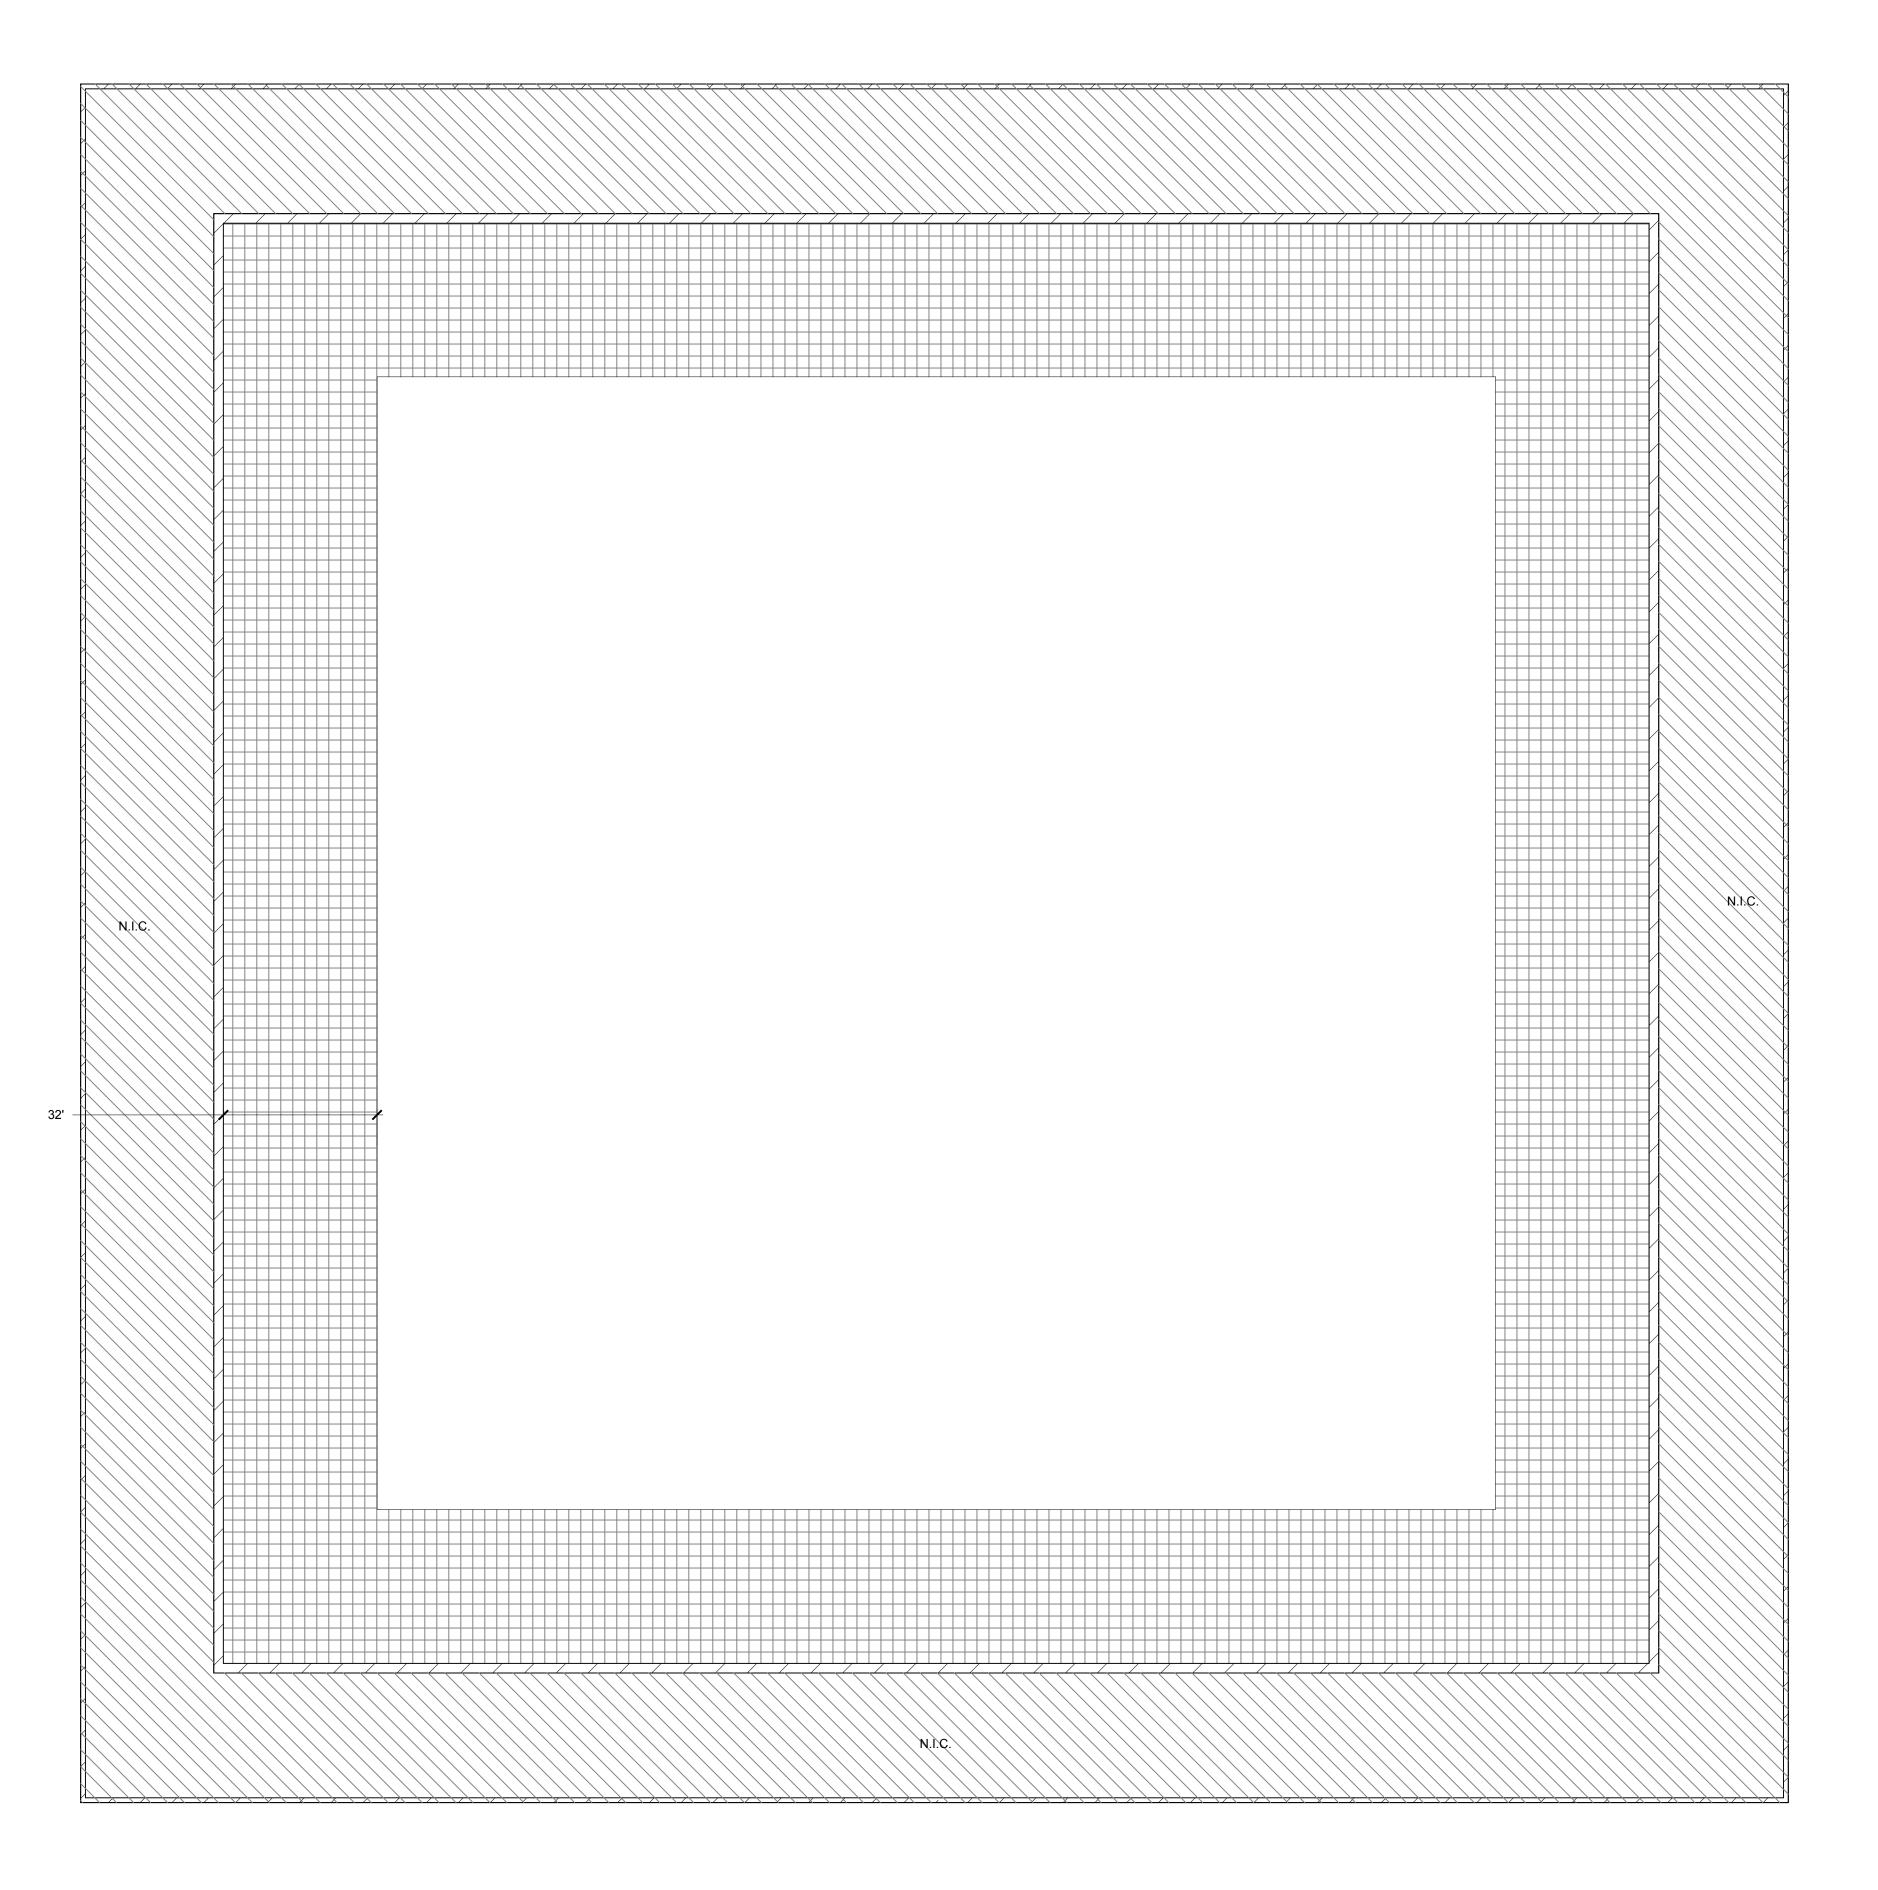

CAROLINA COLISEUM ROOF REPAIF

UNIVERSITY OF SOUTH CAROLINA COLUMBIA, SOUTH CAROLINA STATE PROJECT #: H27-Z334

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REVISION#	REVISION DATE
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2	
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4	
DRAWN BY:	AD / RLW
SCALE:	N.T.S.

DRAWING:

1" = 20' - 0"

DRAWING:

SHEET 3 OF 5

INSULATION ATTACHMENT PLAN

NOTES:

NOTES:

1. PLACEMENT OF INSULATION FASTENERS SHALL COMPLY WITH BOARD MANUFACTURER'S
PLIBLISHED LITERATURE AND THE MEMBRANE MANUFACTURER'S REQUIREMENTS

PUBLISHED LITERATURE AND THE MEMBRANE MANUFACTURER'S REQUIREMENTS.

2. CUT OR SCORE BOARDS TO CONFORM TO ANY IRREGULAR SUBSTRATE CONDITIONS.

3. INSTALL NUMBER OF FASTENERS REQUIRED BY MEMBRANE MANUFACTURER'S TESTED ASSEMBLY TO MEET WIND DESIGN UPLIFT PRESSURES SPECIFIED IN SECTION 07 54 00.

