


REVISIONS	DATE
NO.	NAME

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9/21/2016 8:22:04 AM

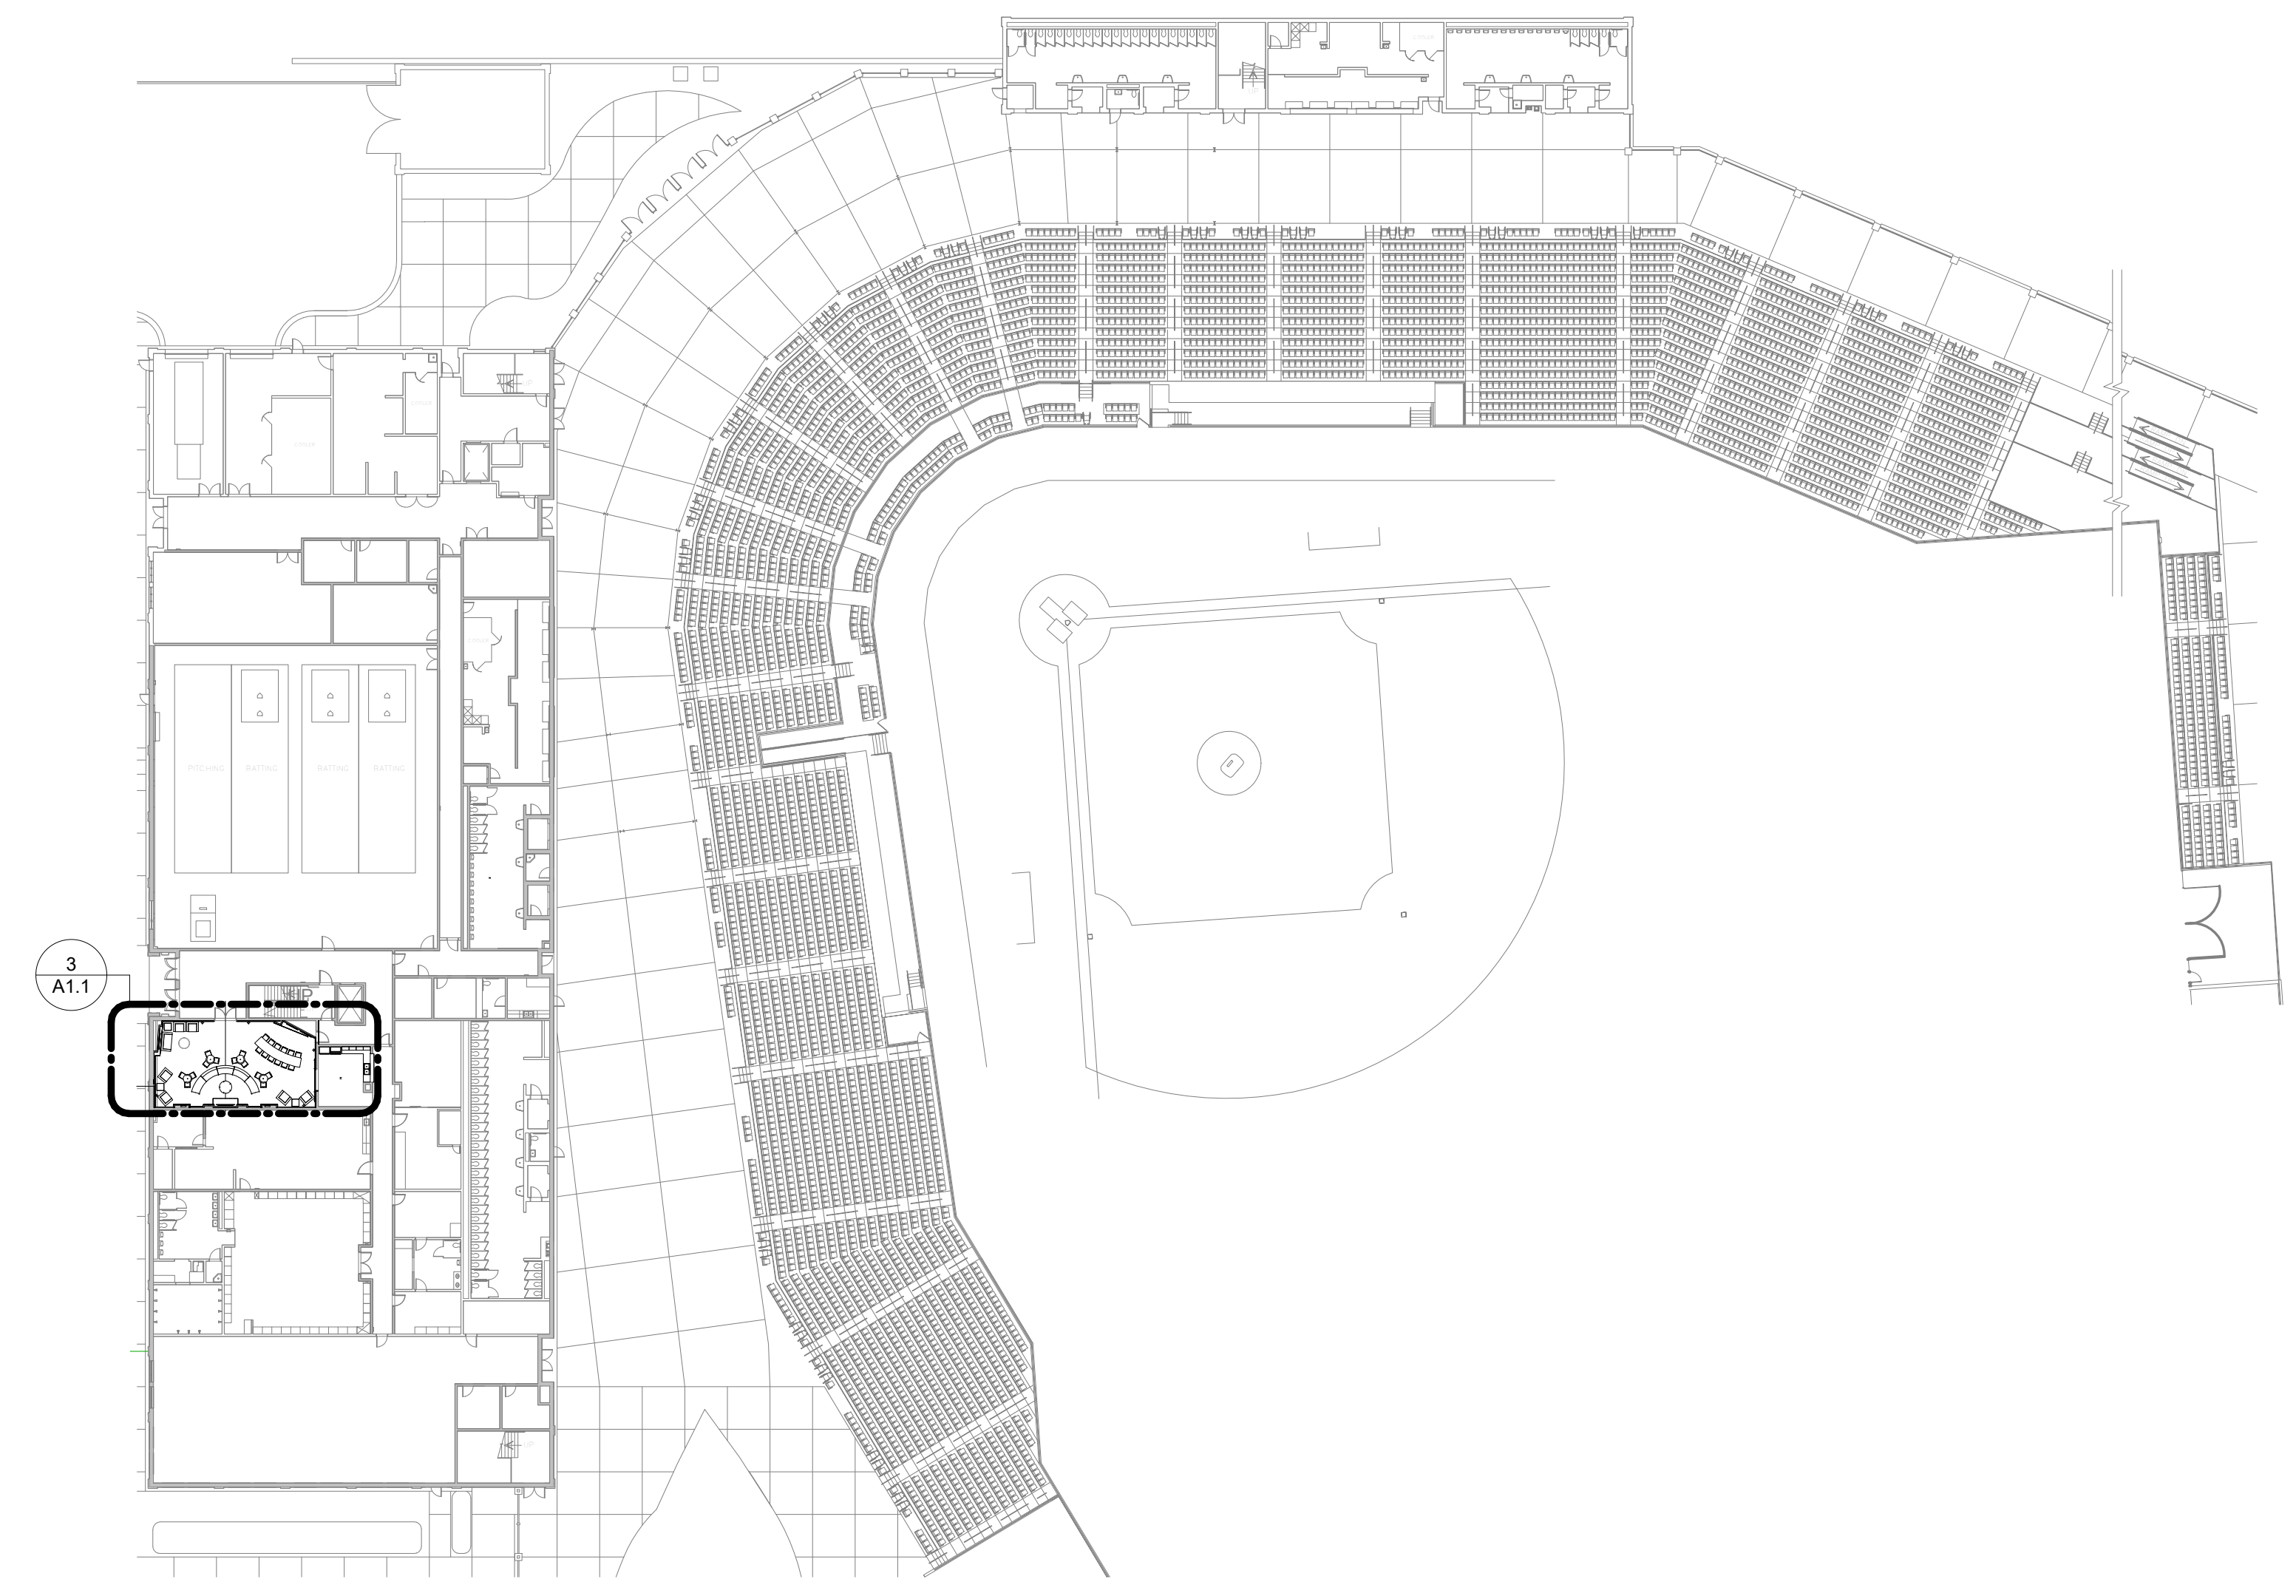


1 FLOOR PLAN - ENTRY LEVEL
 A1.1 1" = 40'-0"
 REFERENCED: A1.4
 OK

LEGEND - DEMOLITION PLAN


- EXISTING WALL TO BE DEMOLISHED
- EXISTING WALL TO REMAIN
- EXISTING DOOR TO BE DEMOLISHED
- EXISTING DOOR TO REMAIN
- EXISTING WINDOW TO BE DEMOLISHED
- EXISTING WINDOW TO REMAIN
- ALL ROOF PAVERS AND PEDESTALS IN THIS AREA TO BE REMOVED AND STORED. PAVERS AND PEDESTALS TO BE RE-INSTALLED TO MEET NEW BUILDING FOOTPRINT AND FINISH FLOOR ELEVATION. EXCESS PAVERS TO BE USED FOR ADD ALTERNATE NO. 2 IF NEEDED.

KEYNOTES - DEMOLITION

- 1 ALL CASEWORK, COUNTERTOPS, PLUMBING FIXTURES TO BE REMOVED
- 2 ALL INTERIOR FLOOR FINISHES TO BE REMOVED IN THIS AREA
- 3 ALL CEILINGS TO BE REMOVED IN THIS AREA
- 4 EXISTING DOOR TO BE REMOVED - FRAME TO REMAIN
- 5 MASONRY WALL TO BE REMOVED IN THIS AREA - SEE PLANS & ELEVATIONS FOR DIMENSIONS & STRUCT. DWGS. FOR LINTEL DETAILS
- 6 CUT EXISTING SLAB IN THIS AREA TO ALLOW FOR ELEC DATA CABLING TO NEW TABLE - SEE ELEC. DWGS.

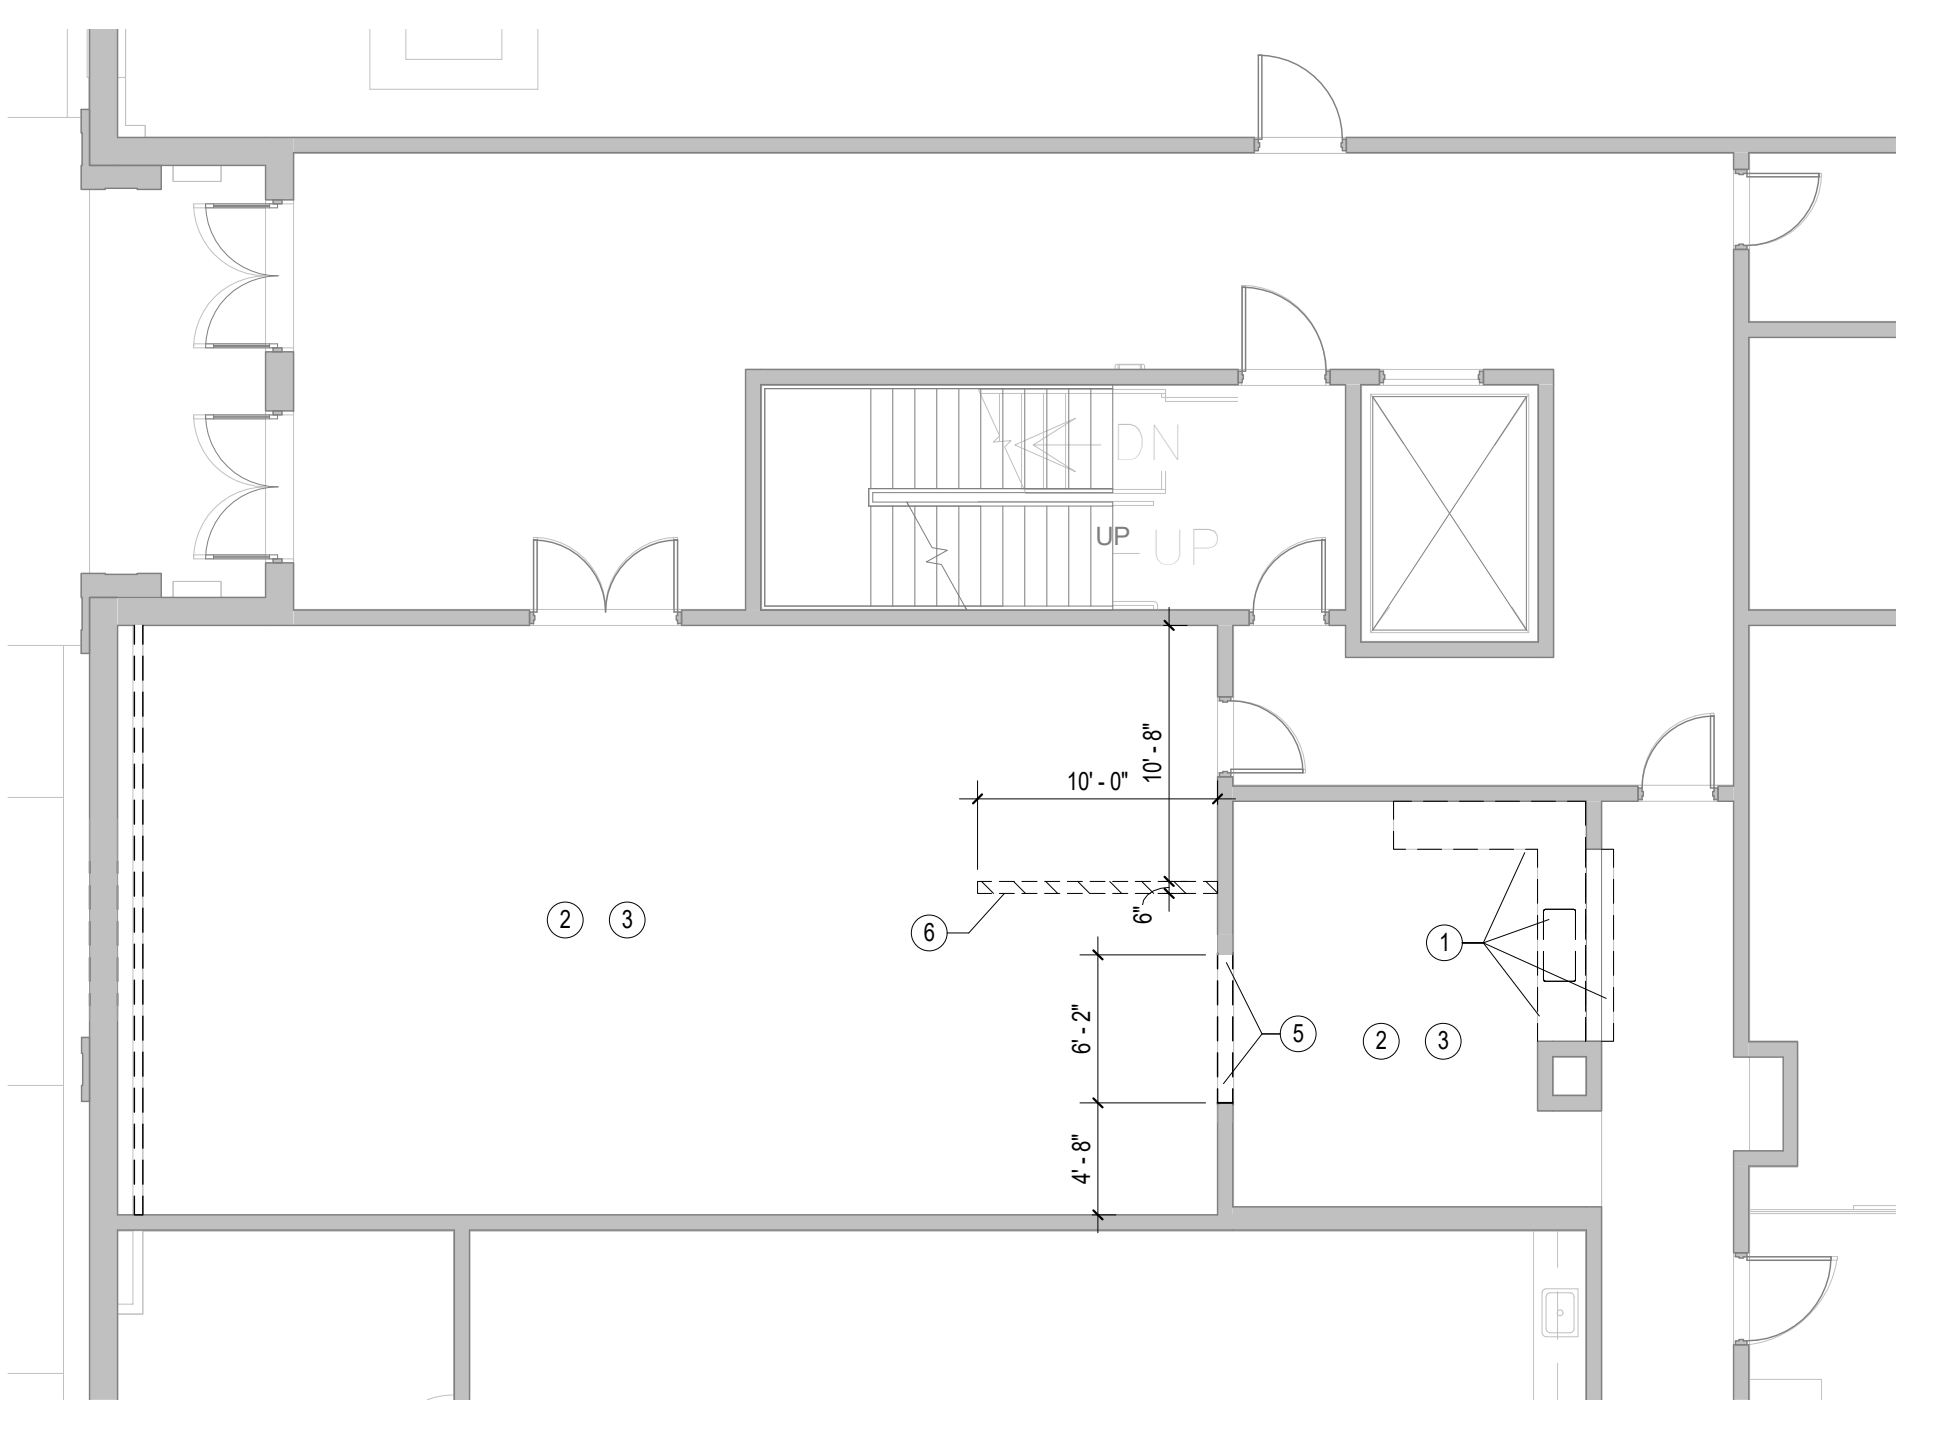

2 DEMOLITION PLAN - PLAYERS LOUNGE
 A1.1 1/8" = 1'-0"
 REFERENCED: OK

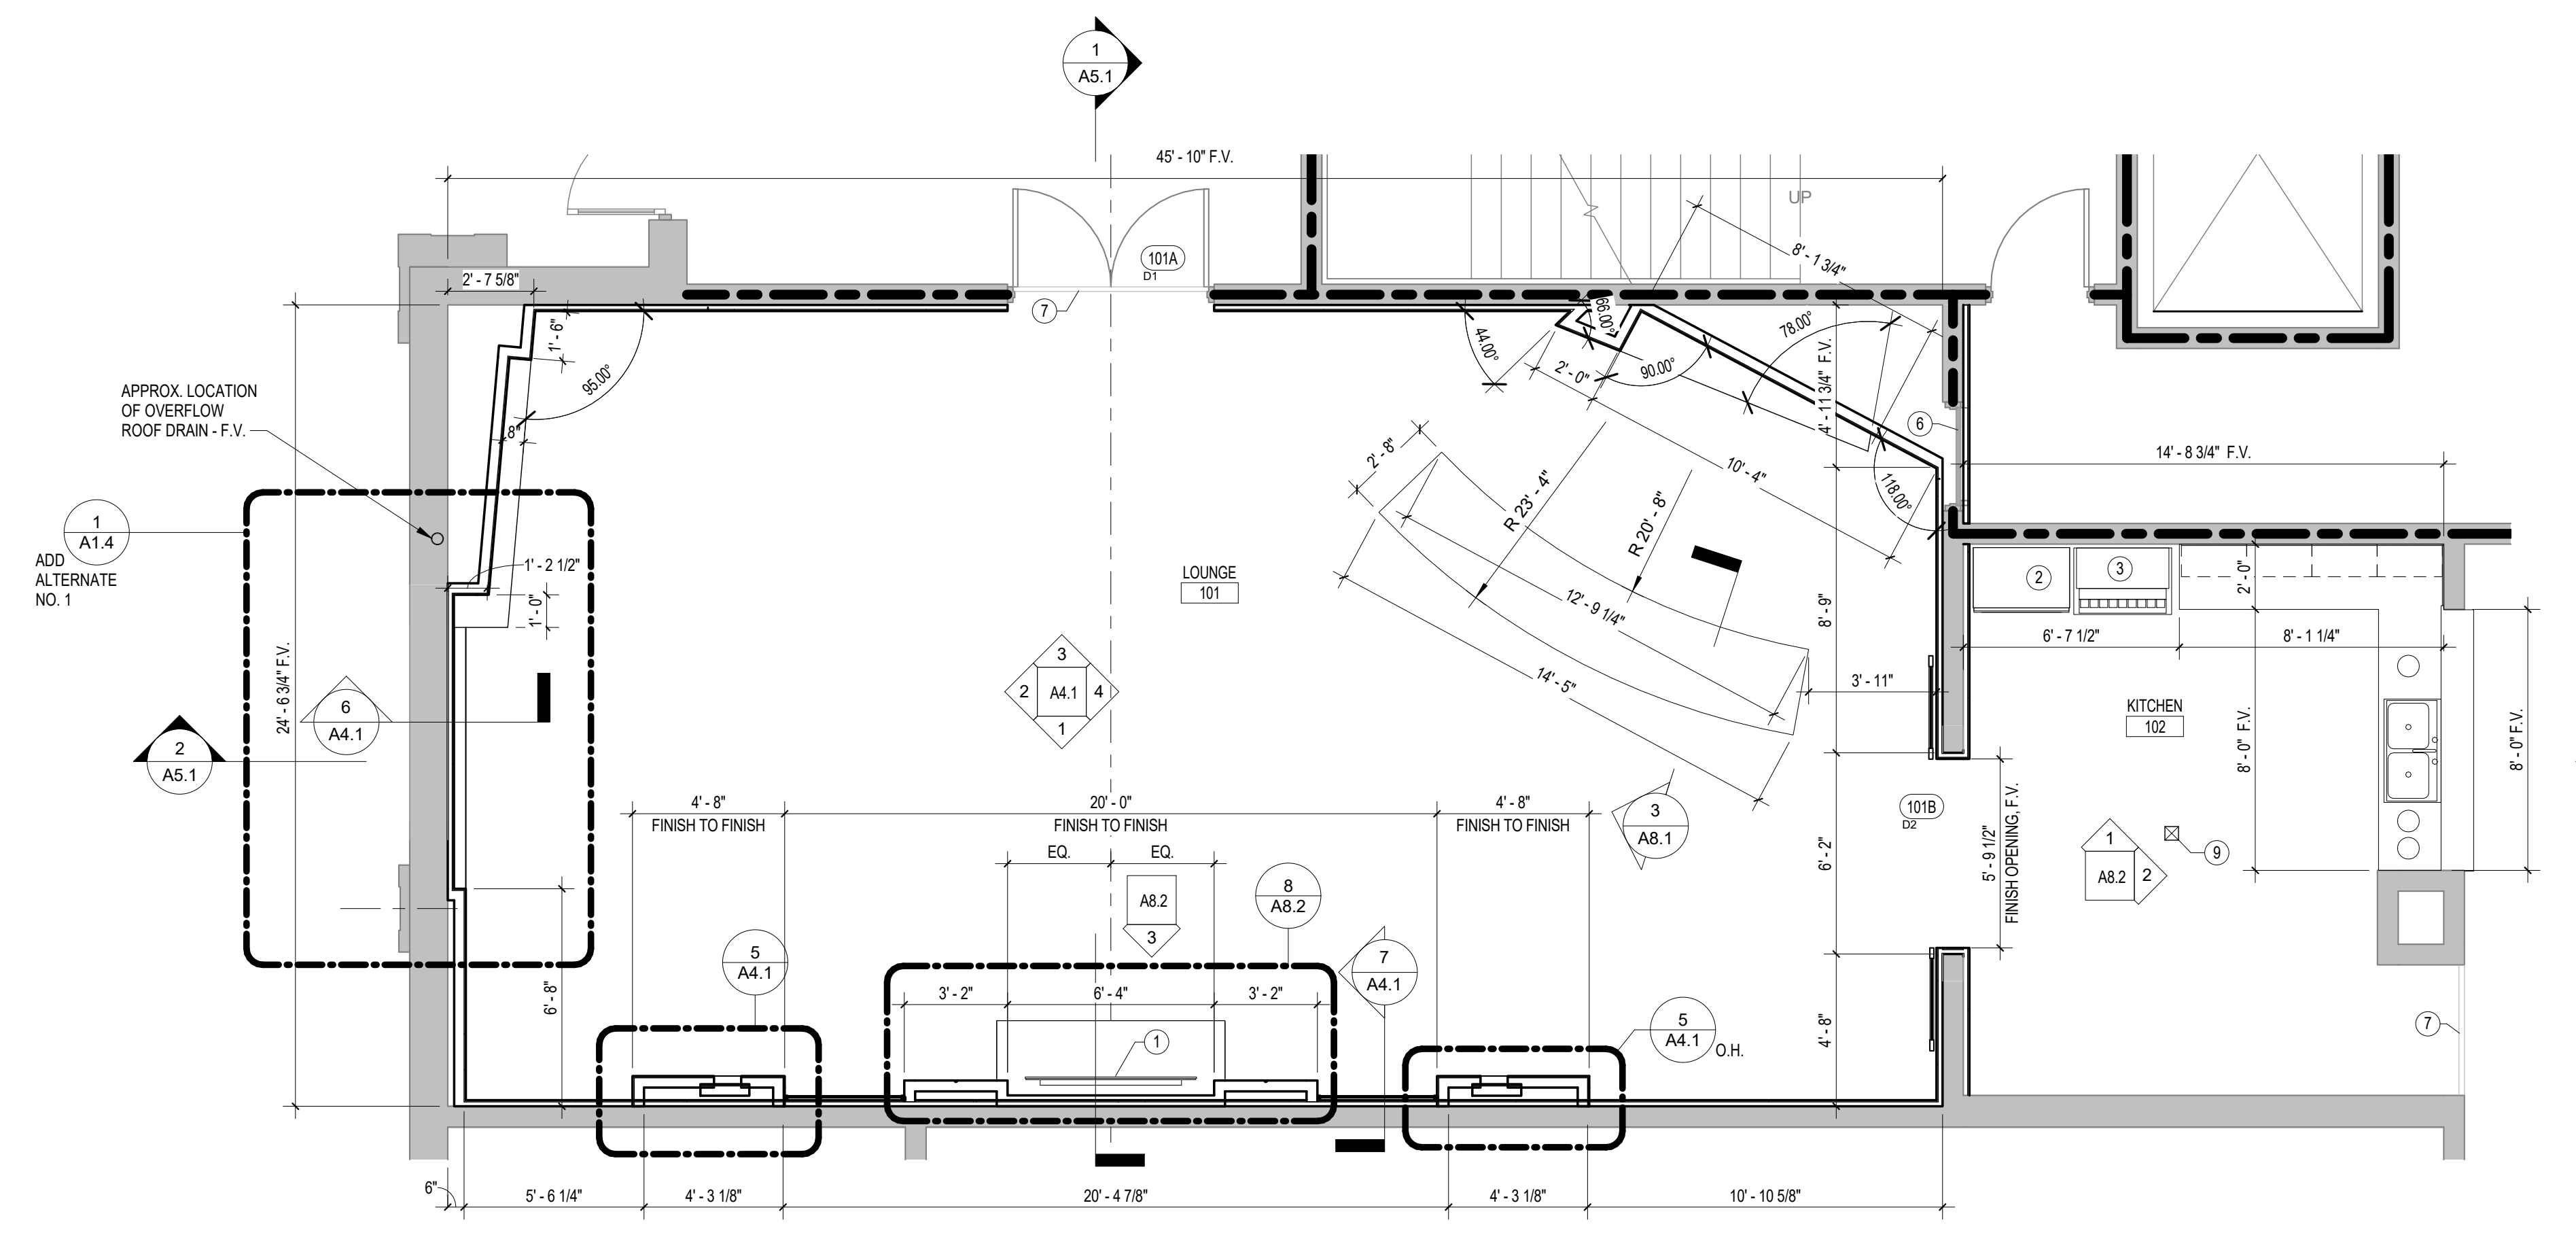

3 ENLARGED PLAN - PLAYERS LOUNGE
 A1.1 1/4" = 1'-0"
 REFERENCED: A1.1
 OK

GENERAL NOTES - FLOOR PLAN


1. SEE T1.1 FOR MINIMUM REQUIRED ADA MANEUVERING CLEARANCES. VERIFY EXACT FEB AND FEC LOCATIONS WITH ARCHITECT - CENTER FECS ON VERTICAL MORTAR JOINTS IN EXPOSED CMU WALLS.
2. SEE T1.1 FOR REQUIRED UL ASSEMBLIES OF ALL BUILDING SYSTEMS. ALL PENETRATIONS THROUGH RATED WALL AND FLOOR ASSEMBLIES MUST COMPLY WITH UL DESIGN FOR PENETRATIONS.
3. DIMENSIONS INDICATED ON THESE DRAWINGS ARE TO FACE OF CMU WALL, FACE OF EXTERIOR VENEER, FACE OF STUD WALL, OR CENTERLINE OF COLUMN UNLESS OTHERWISE INDICATED. COORDINATE ALL DIMENSIONS WITH STRUCTURAL DIMENSION PLANS, ENLARGED PLANS, SECTION AND DETAIL DRAWINGS, AND STRUCTURAL DRAWINGS AND VERIFY EXACT LOCATIONS. COORDINATE ALL FLOOR SLAB PENETRATIONS WITH SYSTEM DRAWINGS (S, S, M, S, P, S, AND E) AND ACTUAL PRODUCT TO BE INSTALLED AND VERIFY LOCATIONS WITH ARCHITECTURAL DRAWINGS PRIOR TO INSTALLATION.
4. SEE FINISH SCHEDULES AND PLANS (A8.6-A8.19) FOR FLOOR PATTERNS AND FLOOR FINISH REFERENCES
5. EXTERIOR MASONRY OPENINGS TO RECEIVE STOREFRONT, DOORS, WINDOWS, LOUVERS, OR OTHER ELEMENTS SHALL BE FIELD VERIFIED PRIOR TO MANUFACTURE OF SYSTEM.
6. INTERIOR METAL STUD OPENINGS TO RECEIVE STOREFRONT, DOORS, GRILLS, LOUVERS, OR OTHER ELEMENTS SHALL BE FIELD VERIFIED PRIOR TO MANUFACTURE OF SYSTEM. LOCATION OF ALL RECESSED CABINETS AND EQUIPMENT WALL PENETRATIONS MUST BE VERIFIED PRIOR TO INSTALLATION OF CMU WALLS TO ENSURE INDICATED LOCATION AND EVEN COURSING. ANY CONFLICTS WITH INDICATED DIMENSIONS OR LOCATIONS SHALL BE COORDINATED WITH ARCHITECT PRIOR TO INSTALLATION.
7. SEE ROOF PLAN FOR ROOF AND PARAPET DETAIL REFERENCES, GENERAL ROOF NOTES AND ROOF LEGEND.
8. PATCH/REPAIR ALL STRUCTURE TO REMAIN. SEE SPECIFICATIONS FOR ADDITIONAL INFORMATION.
9. SEE ELECTRICAL DRAWINGS FOR ALL FLOOR BOX QUANTITY AND LOCATION. VERIFY FINAL LOCATIONS WITH ARCHITECT AND OWNER PRIOR TO POURING CONCRETE.

LEGEND - FLOOR PLAN


- ONE-HOUR FIRE-RATED WALL ASSEMBLY
- SEE PARTITION TYPES FOR UL DESIGN NOS.
- EXPANSION JOINT - SEE SHEET A3.16 FOR TYPES AND DETAILS
- BRICK CONTROL JOINT
- FIRE EXTINGUISHER RECESSED IN WALL CABINET
- FIRE EXTINGUISHER MOUNTED ON WALL BRACKETS
- FD - FLOOR DRAIN

KEYNOTES - FLOOR PLAN

- 1 FLAT SCREEN TV LOCATION. SEE ELEC. DWGS. - VERIFY MOUNTING LOCATION AND HEIGHT WITH ARCHITECT/OWNER PRIOR TO INSTALL. ALL FLAT SCREENS TO BE SUPPLIED AND INSTALLED BY OWNER
- 2 REFRIGERATOR, N.I.C. - TO BE SUPPLIED AND INSTALLED BY OWNER
- 3 DRINK MACHINE, N.I.C. - TO BE SUPPLIED AND INSTALLED BY OWNER
- 4 1-1/2" DIA. WALL MOUNTED WOOD HANDRAIL, STAINED - SEE DETAILS
- 5 1-1/2" DIA. FLOOR MOUNTED WOOD HANDRAIL, STAINED - SEE DETAILS
- 6 EXISTING DOOR TO REMAIN - TO BE ENCAPSULATED BY NEW FRAMING AND GWS
- 7 EXISTING MARBLE THRESHOLD TO REMAIN
- 8 SOLID SURFACE WALL CAP - SEE DETAILS
- 9 EXISTING FLOOR DRAIN TO RECEIVE NEW COVER - SEE PLUMB. DWGS.

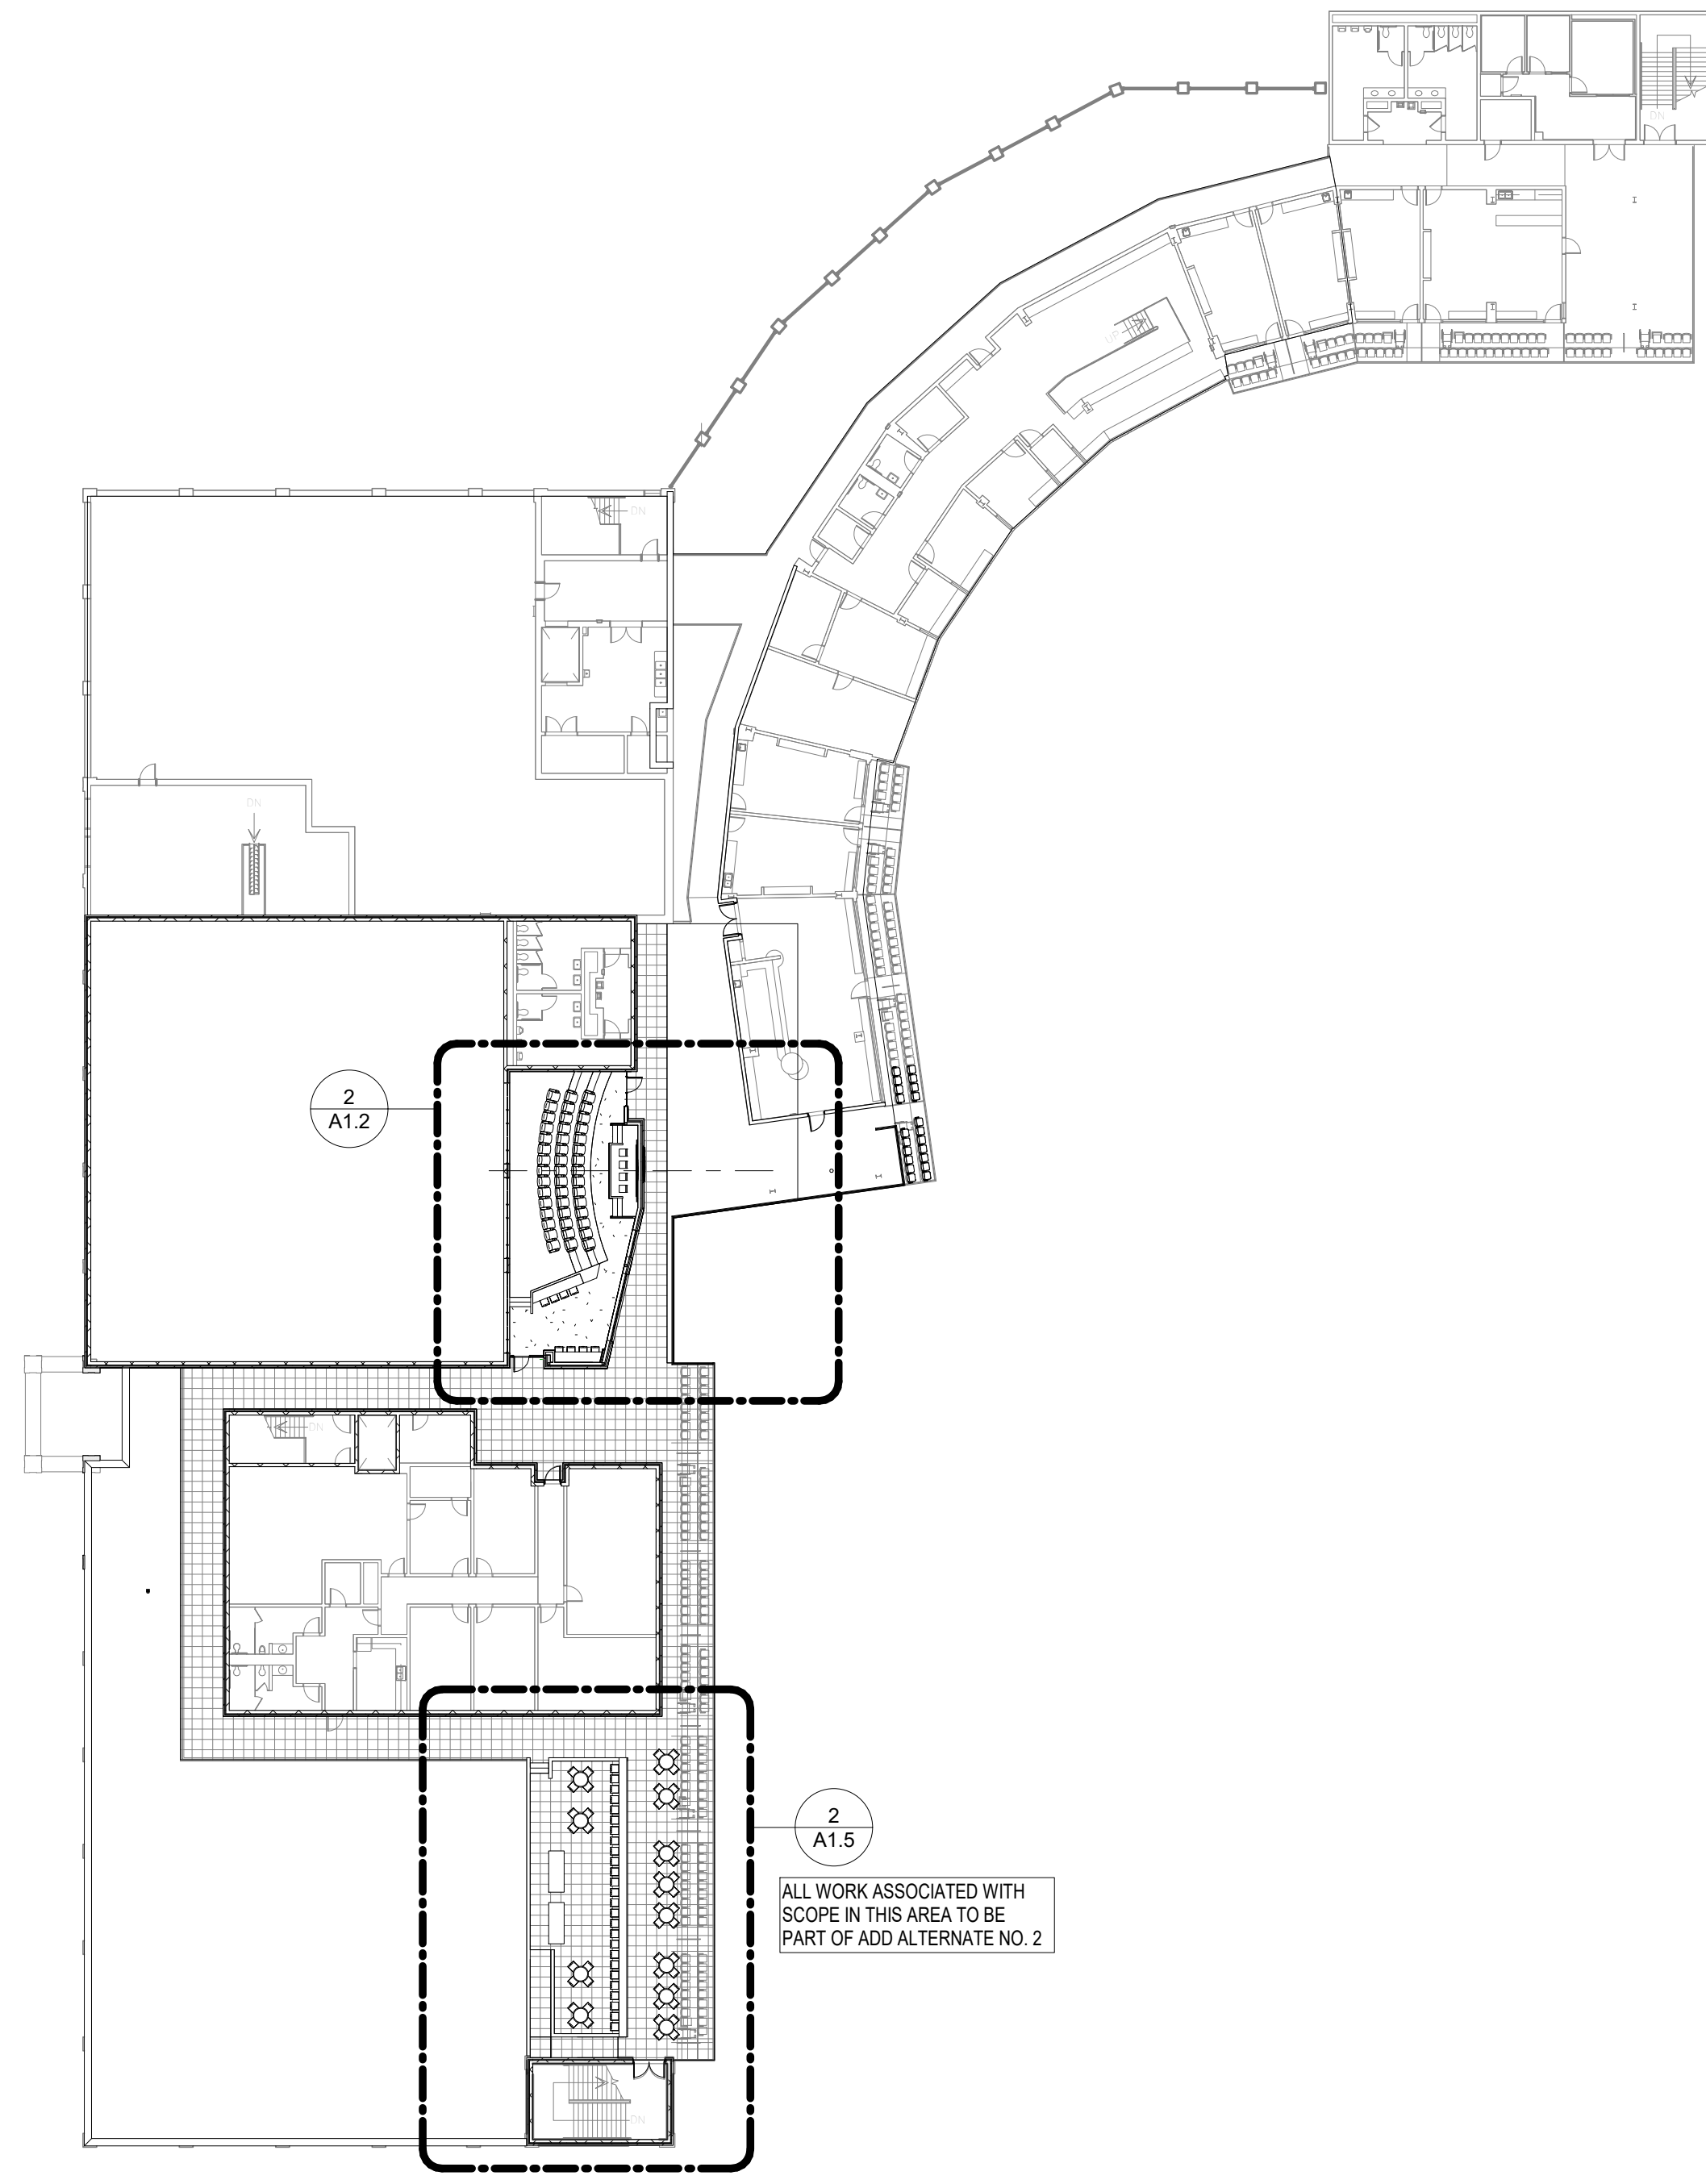

1 FLOOR PLAN - CLUB LEVEL
A1.2 1" = 3/8" REFERENCE: A1.5 OK

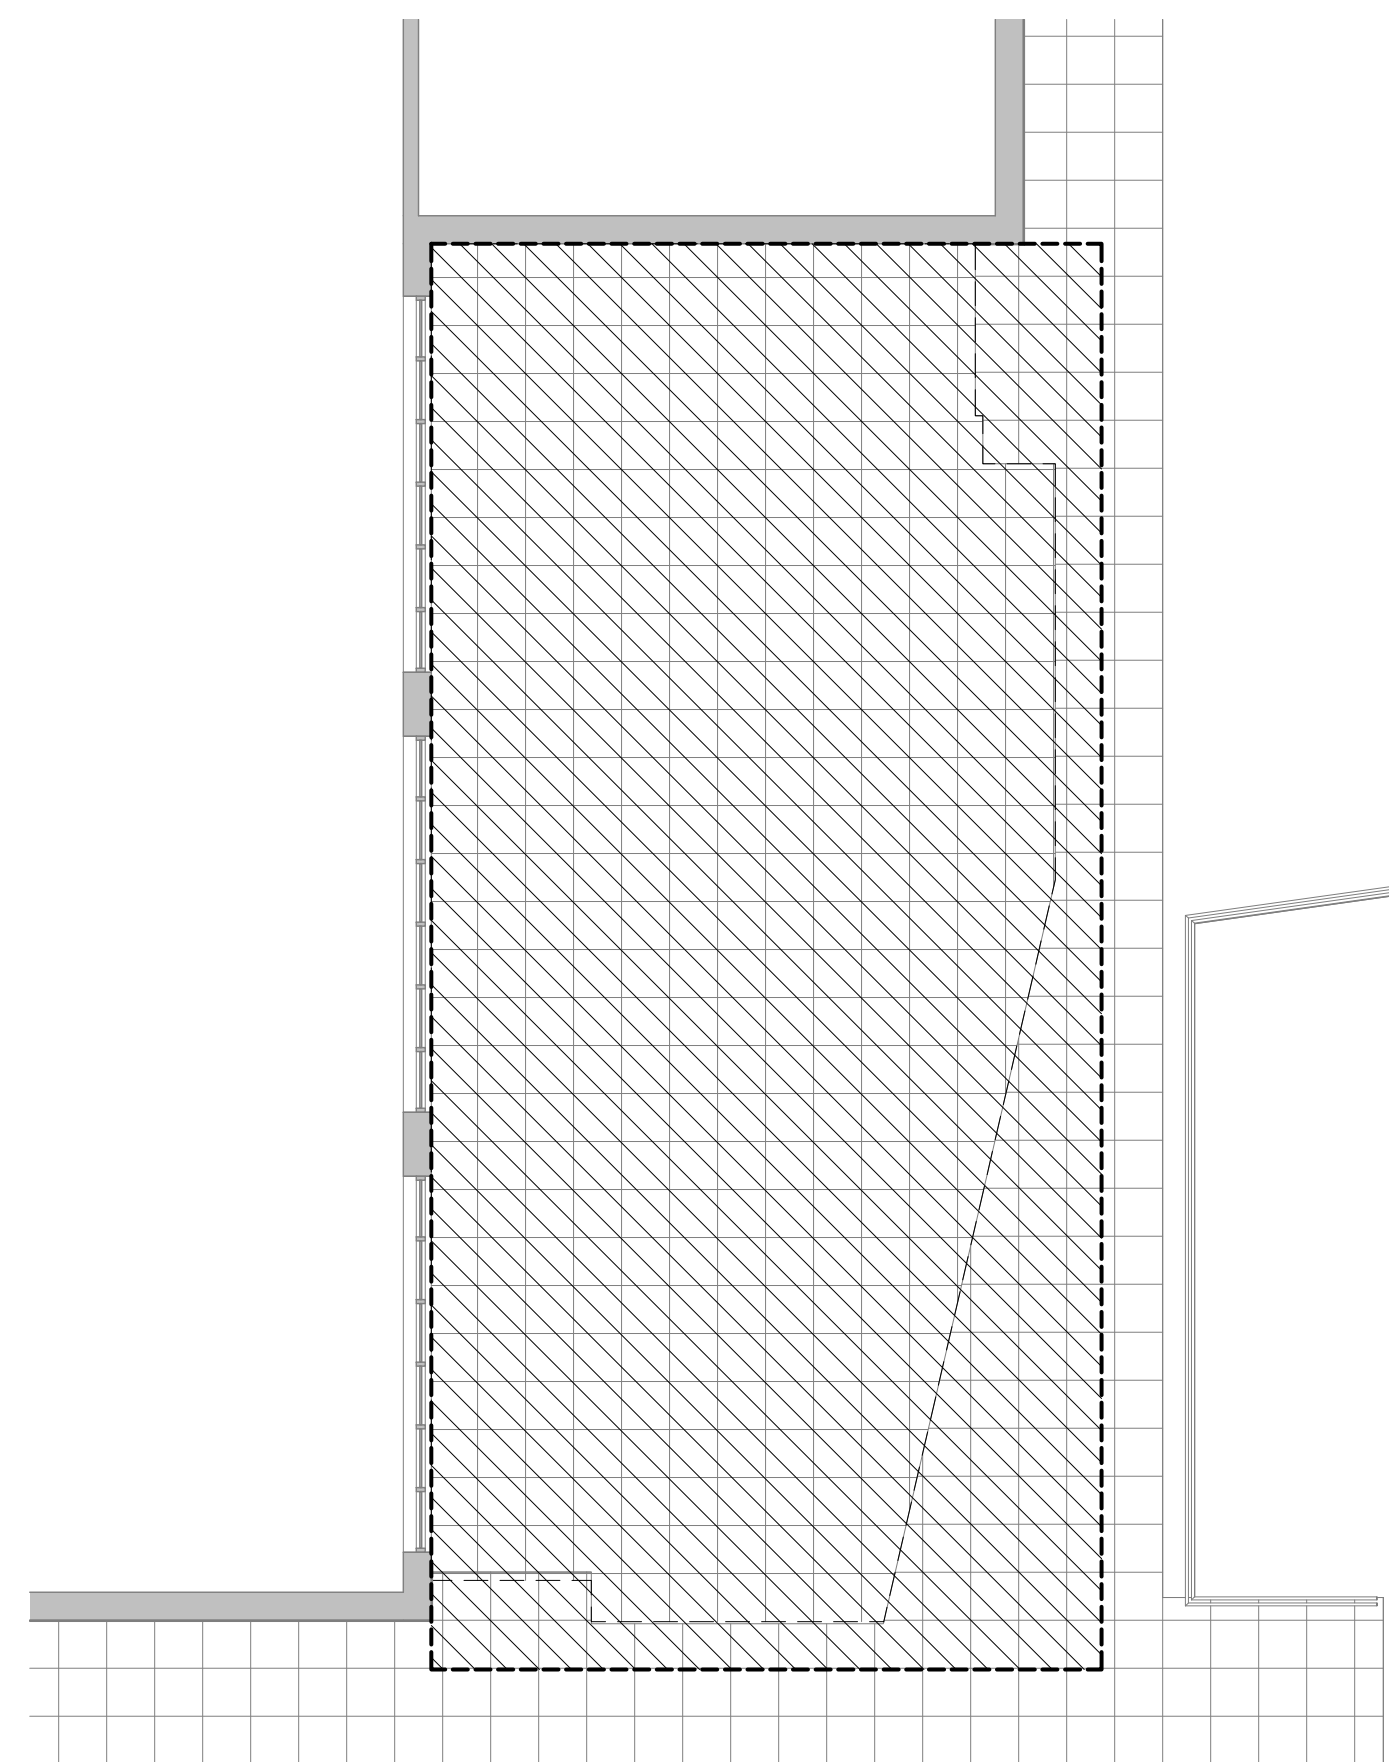


3 DEMOLITION PLAN - MEDIA ROOM
A1.2 1/8" = 1'-0" REFERENCE: OK

LEGEND - DEMOLITION PLAN

- EXISTING WALL TO BE DEMOLISHED
- EXISTING WALL TO REMAIN
- EXISTING DOOR TO BE DEMOLISHED
- EXISTING DOOR TO REMAIN
- EXISTING WINDOW TO BE DEMOLISHED
- EXISTING WINDOW TO REMAIN
- ALL ROOF PAVERS AND PEDESTALS IN THIS AREA TO BE REMOVED AND STORED. PAVERS AND PEDESTALS TO BE RE-INSTALLED TO MEET NEW BUILDING FOOTPRINT AND FINISH FLOOR ELEVATION. EXCESS PAVERS TO BE USED FOR ADD ALTERNATE NO. 2 IF NEEDED

KEYNOTES - DEMOLITION

- 1 ALL CASEWORK, COUNTERTOPS, PLUMBING FIXTURES TO BE REMOVED
- 2 ALL INTERIOR FLOOR FINISHES TO BE REMOVED IN THIS AREA
- 3 ALL CEILINGS TO BE REMOVED IN THIS AREA
- 4 EXISTING DOOR TO BE REMOVED - FRAME TO REMAIN
- 5 MASONRY WALL TO BE REMOVED IN THIS AREA - SEE PLANS & ELEVATIONS FOR DIMENSIONS & STRUCT. DWGS. FOR LINTEL DETAILS
- 6 CUT EXISTING SLAB IN THIS AREA TO ALLOW FOR FLECDATA CABLING TO NEW TABLE - SEE ELEC. DWGS.

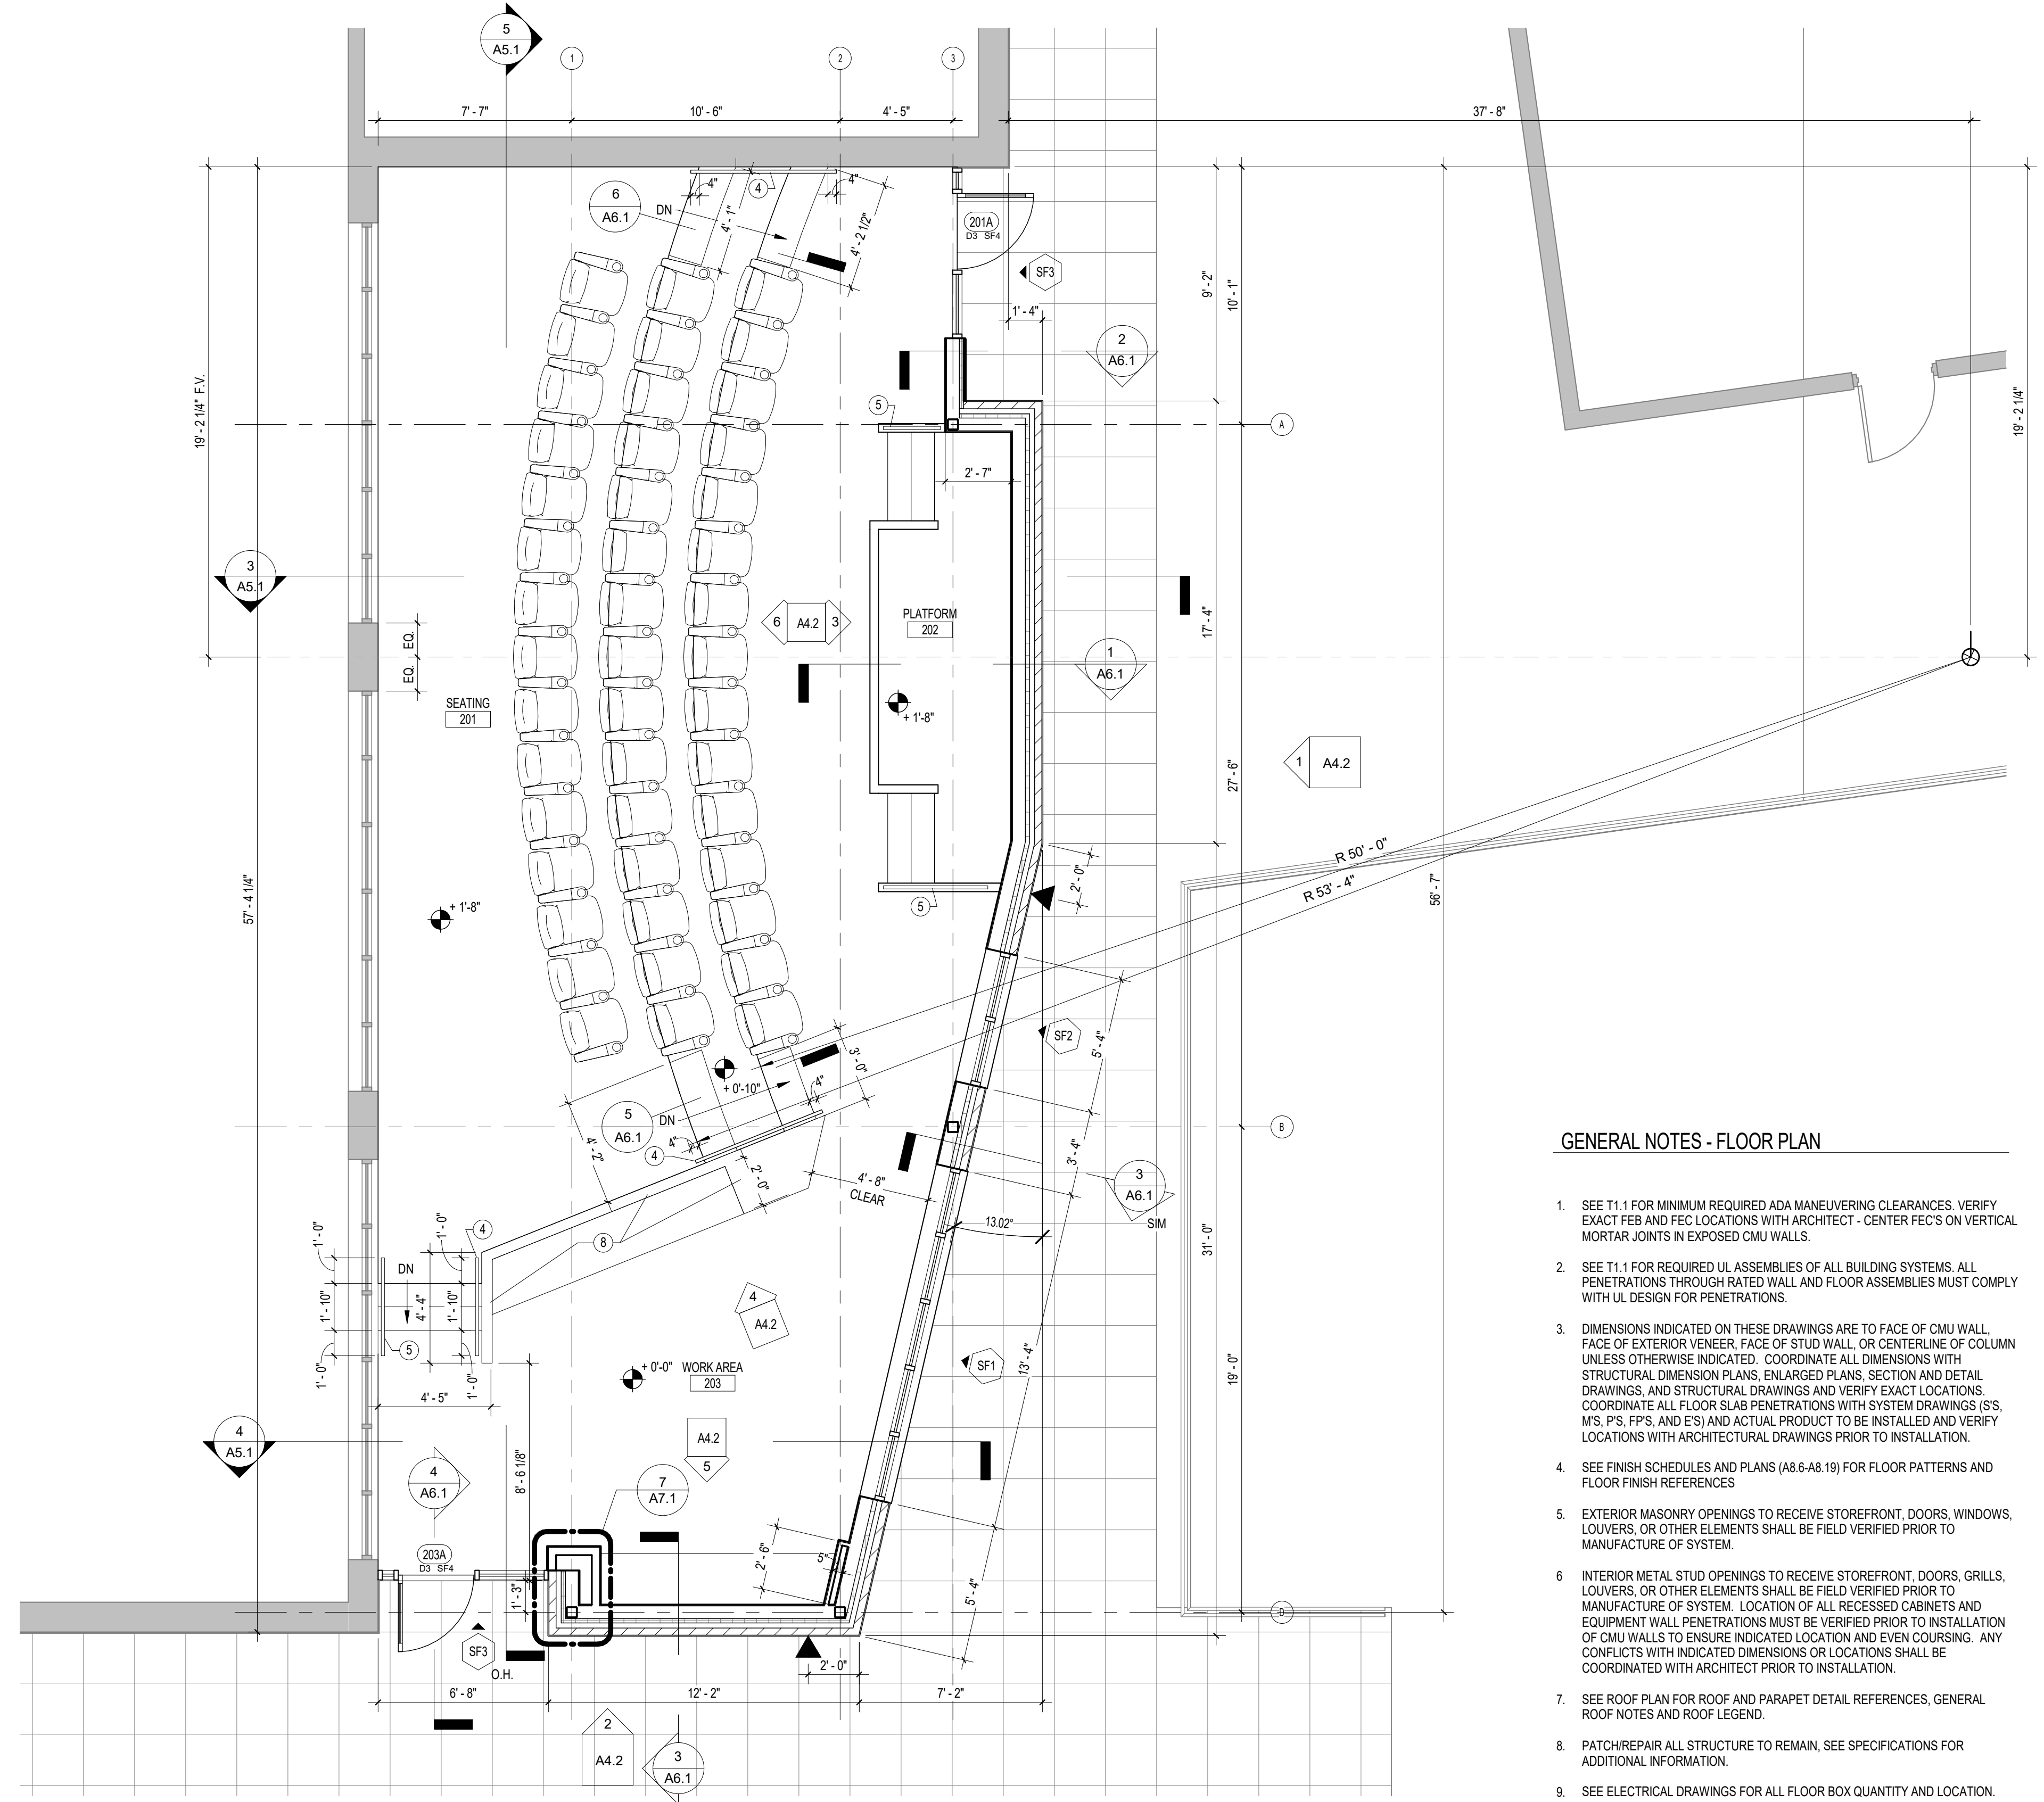

2 ENLARGED PLAN - MEDIA ROOM
A1.2 1/4" = 1'-0" REFERENCE: A1.2 OK

LEGEND - FLOOR PLAN

- ONE-HOUR FIRE-RATED WALL ASSEMBLY
- SEE PARTITION TYPES FOR UL DESIGN NOS.
- EXPANSION JOINT - SEE SHEET A3.16 FOR TYPES AND DETAILS
- BRICK CONTROL JOINT
- FIRE EXTINGUISHER RECESSED IN WALL CABINET
- FIRE EXTINGUISHER MOUNTED ON WALL BRACKETS
- FD - FLOOR DRAIN

KEYNOTES - FLOOR PLAN

- 1 FLAT SCREEN TV LOCATION. SEE ELEC. DWGS. - VERIFY MOUNTING LOCATION AND HEIGHT WITH ARCHITECT/OWNER PRIOR TO INSTALL. - ALL FLAT SCREENS TO BE SUPPLIED AND INSTALLED BY OWNER
- 2 REFRIGERATOR, N.I.C. - TO BE SUPPLIED AND INSTALLED BY OWNER
- 3 DRINK MACHINE, N.I.C. - TO BE SUPPLIED AND INSTALLED BY OWNER
- 4 1-1/2" DIA. WALL MOUNTED WOOD HANDRAIL, STAINED - SEE DETAILS
- 5 1-1/2" DIA. FLOOR MOUNTED WOOD HANDRAIL, STAINED - SEE DETAILS
- 6 EXISTING DOOR TO REMAIN - TO BE ENCAPSULATED BY NEW FRAMING AND GWS
- 7 EXISTING MARBLE THRESHOLD TO REMAIN
- 8 SOLID SURFACE WALL CAP - SEE DETAILS
- 9 EXISTING FLOOR DRAIN TO RECEIVE NEW COVER - SEE PLUMB. DWGS.

GENERAL NOTES - FLOOR PLAN

1. SEE T1.1 FOR MINIMUM REQUIRED ADA MANEUVERING CLEARANCES. VERIFY EXACT FES AND FEC LOCATIONS WITH ARCHITECT - CENTER FES'S ON VERTICAL MORTAR JOINTS IN EXPOSED CMU WALLS.
2. SEE T1.1 FOR REQUIRED UL ASSEMBLIES OF ALL BUILDING SYSTEMS. ALL PENETRATIONS THROUGH RATED WALL AND FLOOR ASSEMBLIES MUST COMPLY WITH UL DESIGN FOR PENETRATIONS.
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4. SEE FINISH SCHEDULES AND PLANS (A8.6-A8.19) FOR FLOOR PATTERNS AND FLOOR FINISH REFERENCES
5. EXTERIOR MASONRY OPENINGS TO RECEIVE STOREFRONT, DOORS, WINDOWS, LOUVERS, OR OTHER ELEMENTS SHALL BE FIELD VERIFIED PRIOR TO MANUFACTURE OF SYSTEM.
6. INTERIOR METAL STUD OPENINGS TO RECEIVE STOREFRONT, DOORS, GRILLS, LOUVERS, OR OTHER ELEMENTS SHALL BE FIELD VERIFIED PRIOR TO MANUFACTURE OF SYSTEM. LOCATION OF ALL RECESSED CABINETS AND EQUIPMENT WALL PENETRATIONS MUST BE VERIFIED PRIOR TO INSTALLATION OF CMU WALLS TO ENSURE INDICATED LOCATION AND EVEN COURSING. ANY CONFLICTS WITH INDICATED DIMENSIONS OR LOCATIONS SHALL BE COORDINATED WITH ARCHITECT PRIOR TO INSTALLATION.
7. SEE ROOF PLAN FOR ROOF AND PARAPET DETAIL REFERENCES. GENERAL ROOF NOTES AND ROOF LEGEND.
8. PATCH/REPAIR ALL STRUCTURE TO REMAIN. SEE SPECIFICATIONS FOR ADDITIONAL INFORMATION.
9. SEE ELECTRICAL DRAWINGS FOR ALL FLOOR BOX QUANTITY AND LOCATION. VERIFY FINAL LOCATIONS WITH ARCHITECT AND OWNER PRIOR TO POURING CONCRETE.

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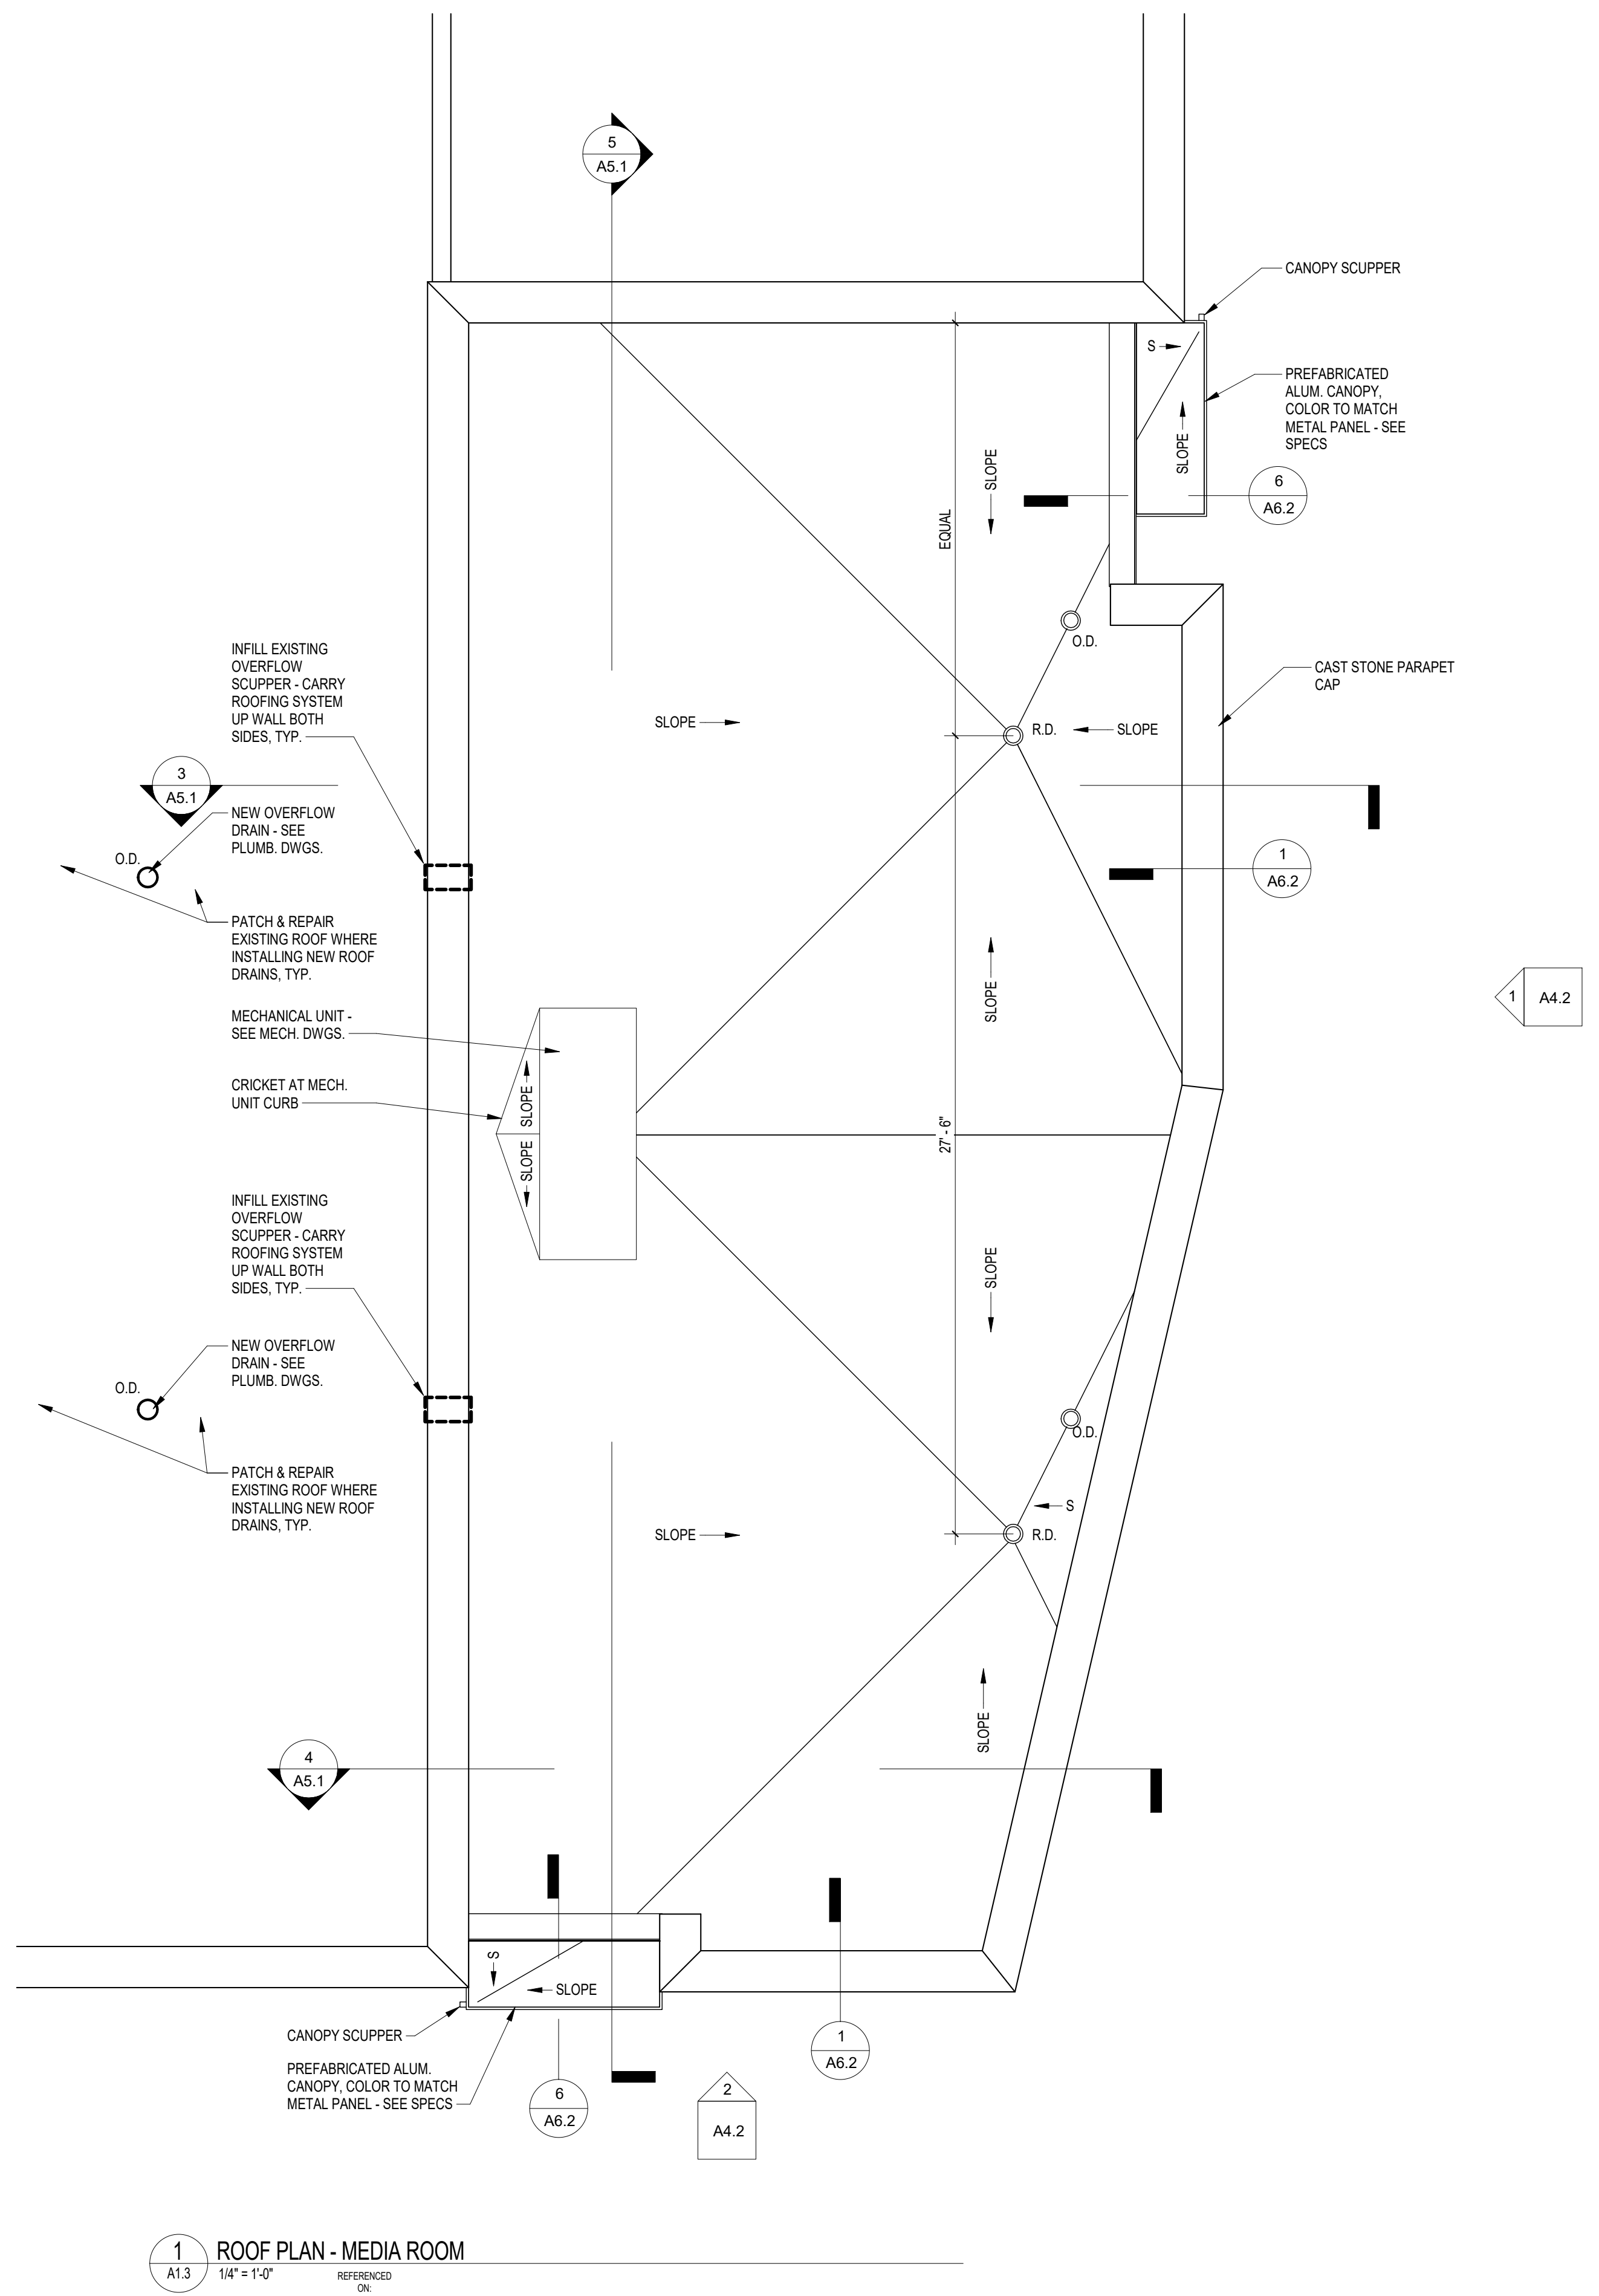
UNIVERSITY OF SOUTH CAROLINA
FOUNDERS PARK PLAYER'S LOUNGE
AND MEDIA ROOM ADDITION
431 WILLIAMS STREET
COLUMBIA, SC 29201

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CLUB LEVEL FLOOR PLAN,
DEMOLITION PLAN, ENLARGED
MEDIA ROOM PLAN

9/21/2016 8:22:11 AM



1 ROOF PLAN - MEDIA ROOM
A13 1/4" = 1'-0"

LEGEND - ROOF PLAN

RD ROOF DRAIN

TYPICAL ROOF SYSTEM, R-1

MODIFIED BITUMEN ROOFING W/ CONT. CANT STRIPS OVER TAPERED INSULATION ON 4-INCHES RIGID INSULATION ON METAL DECK. SEE SPECS.

GARVINDESIGNGROUP
803.212.1032 p / 803.212.1074 f
1209 Lincoln Street
Columbia, SC 29902

STATE OF SOUTH CAROLINA
REGISTERED ARCHITECT
DAVID M. GARVIN

STATE OF SOUTH CAROLINA
REGISTERED ARCHITECT
GARVIN DESIGN GROUP, INC.
111 CROSS STREET
COLUMBIA, SC

PROJECT TITLE
UNIVERSITY OF SOUTH CAROLINA
FOUNDERS PARK PLAYER'S LOUNGE
AND MEDIA ROOM ADDITION
431 WILLIAMS STREET
COLUMBIA, SC 29201

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DRAWING TITLE
MEDIA ROOM ROOF PLAN



PROJECT NO.
1425.1B
DATE
09.21.16
DRAWING NO.
A13


ADD ALTERNATE NO. 1

GENERAL NOTES - ADD ALTERNATE NO. 1


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LEGEND - ADD ALTERNATE NO. 1


-  EXISTING BRICK AND CMU WALL CONSTRUCTION TO BE REMOVED IN THIS AREA - SEE STRUCT. DWGS. FOR NEW LINTEL DETAILS
-  DEMO BRICK VENEER/ CAST STONE VENEER ONLY IN THIS AREA TO ALLOW FOR STEEL LINTEL, TOOTHING OF BRICK AT JAMBS, & NEW CAST STONE SILL. SEE STRUCT. DWGS. FOR DETAILS

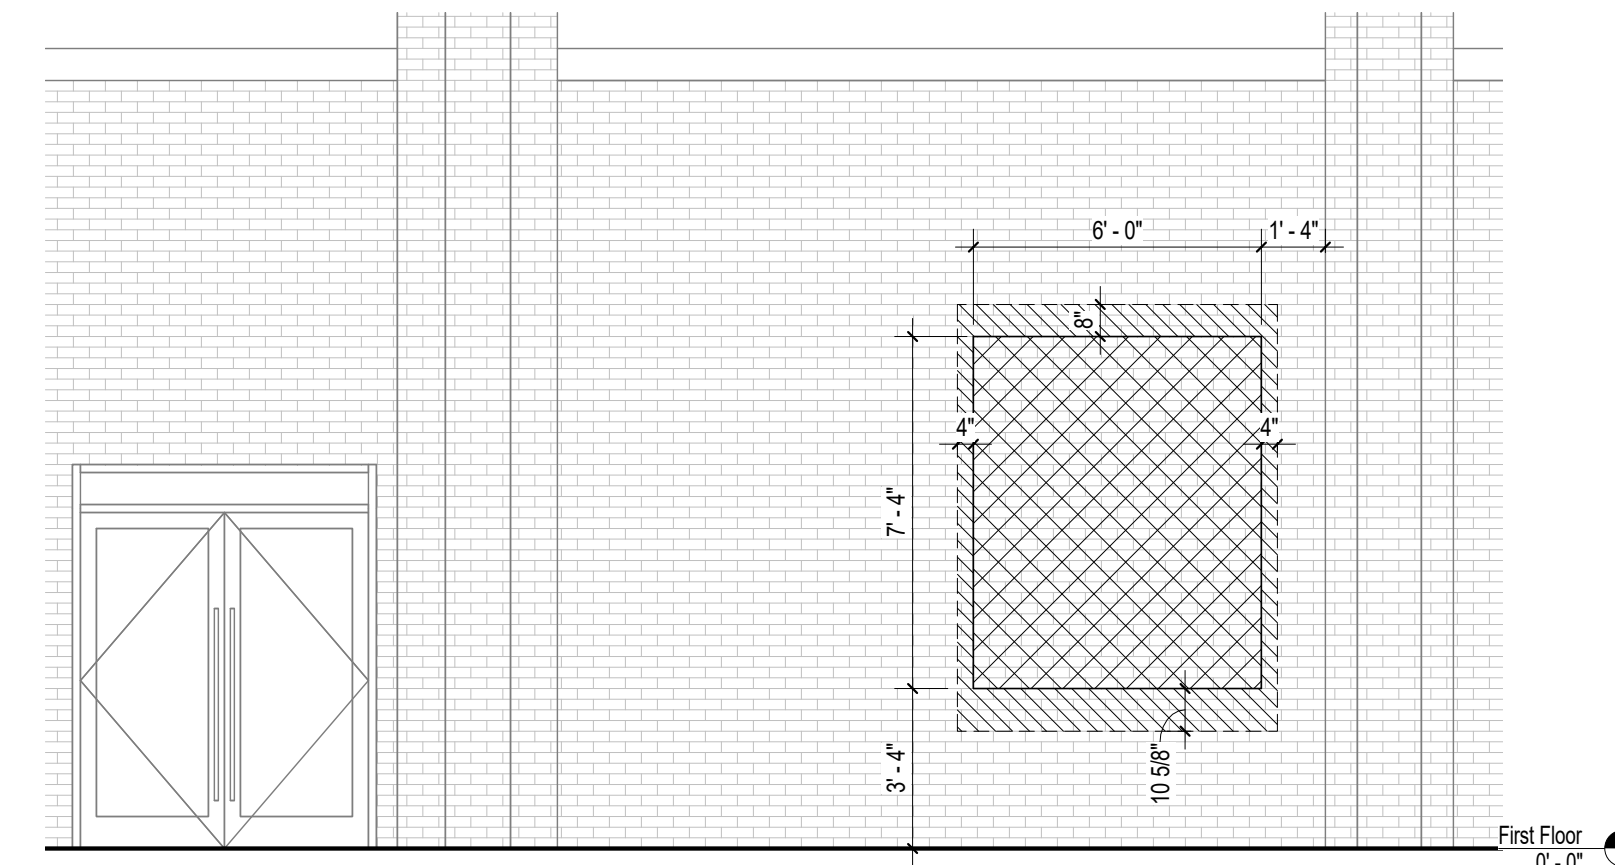


2 DEMOLITION ELEVATION
A1.4 1/4" = 1'-0" REFERENCED ON: A1.4

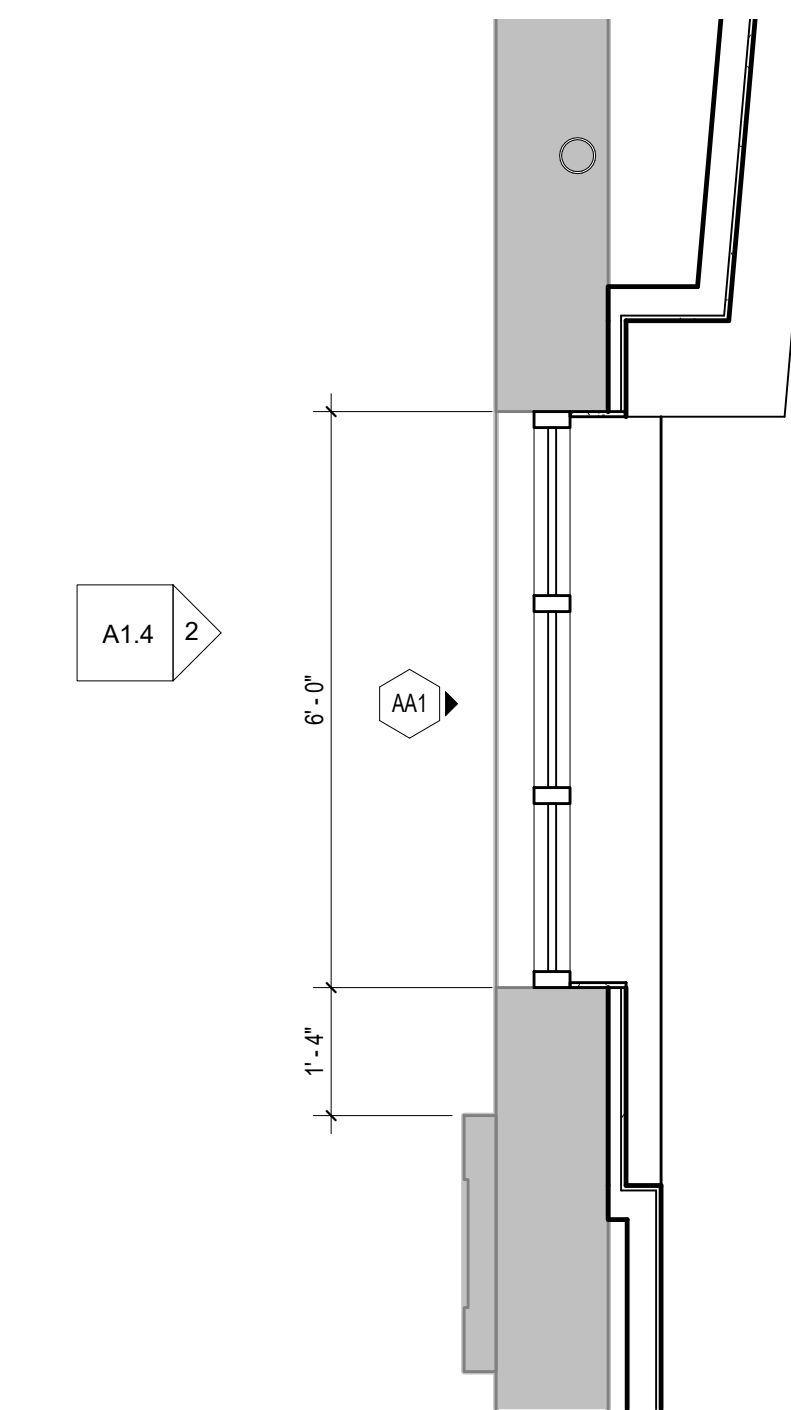


1 PARTIAL FLOOR PLAN - ADD ALT. NO. 1
A1.4 1/2" = 1'-0" REFERENCED ON: A1.1

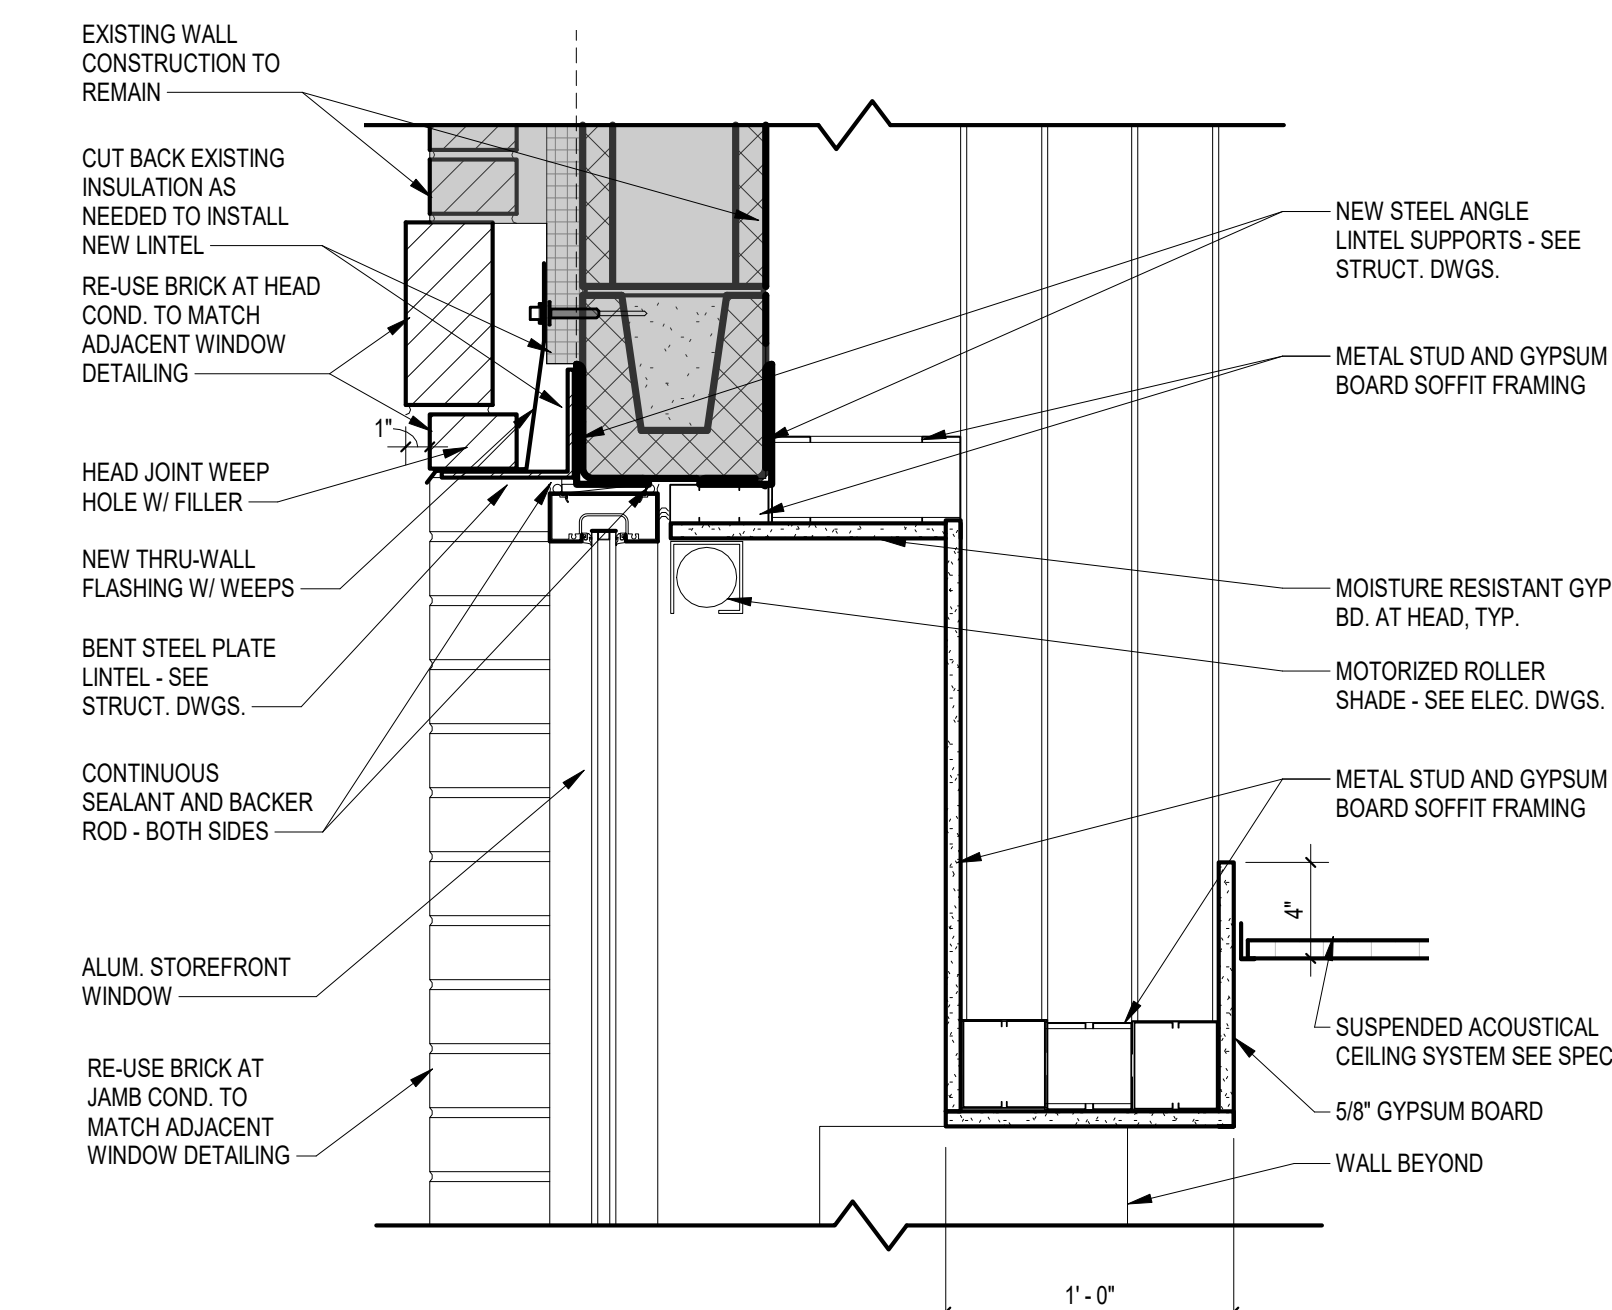


4 HEAD SECTION DETAIL
A1.4 1 1/2" = 1'-0" REFERENCED ON: A1.4

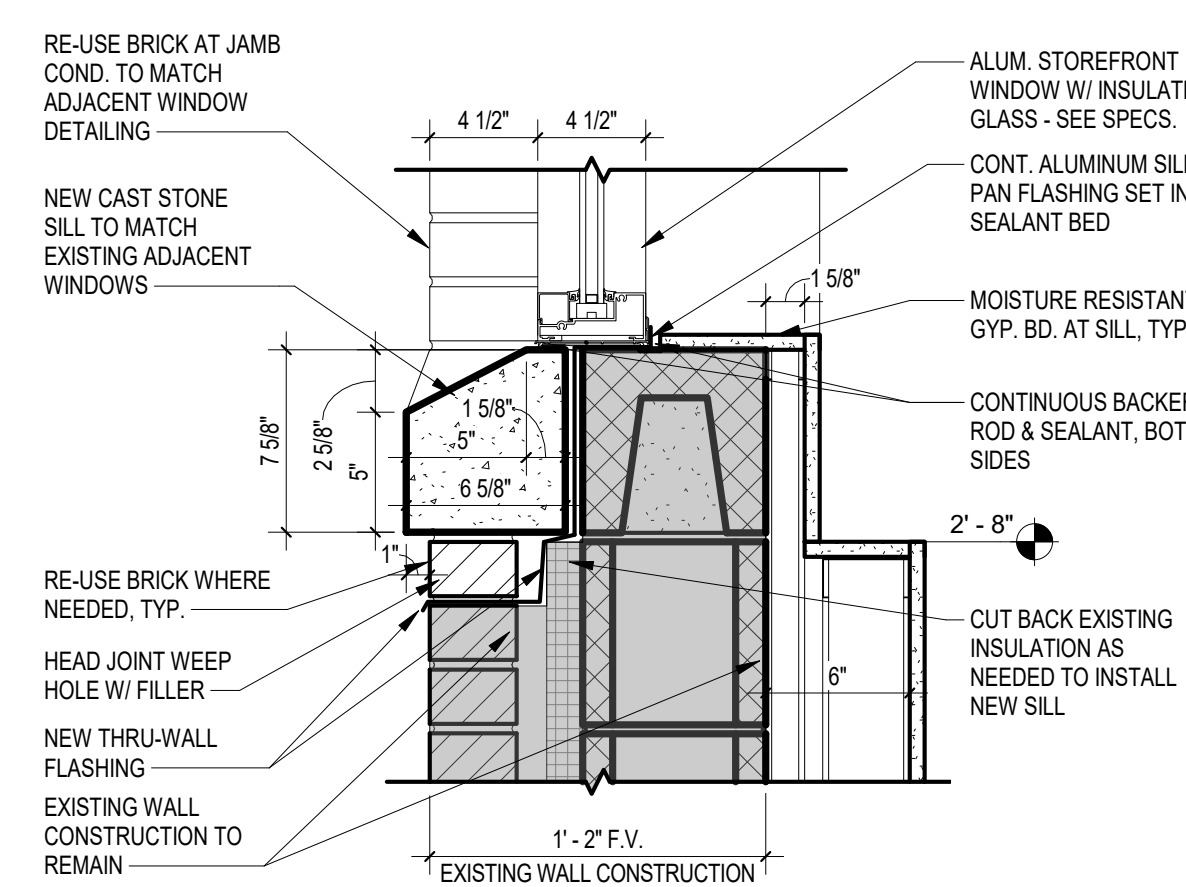

6 SILL SECTION DETAIL
A1.4 1 1/2" = 1'-0" REFERENCED ON: A1.4

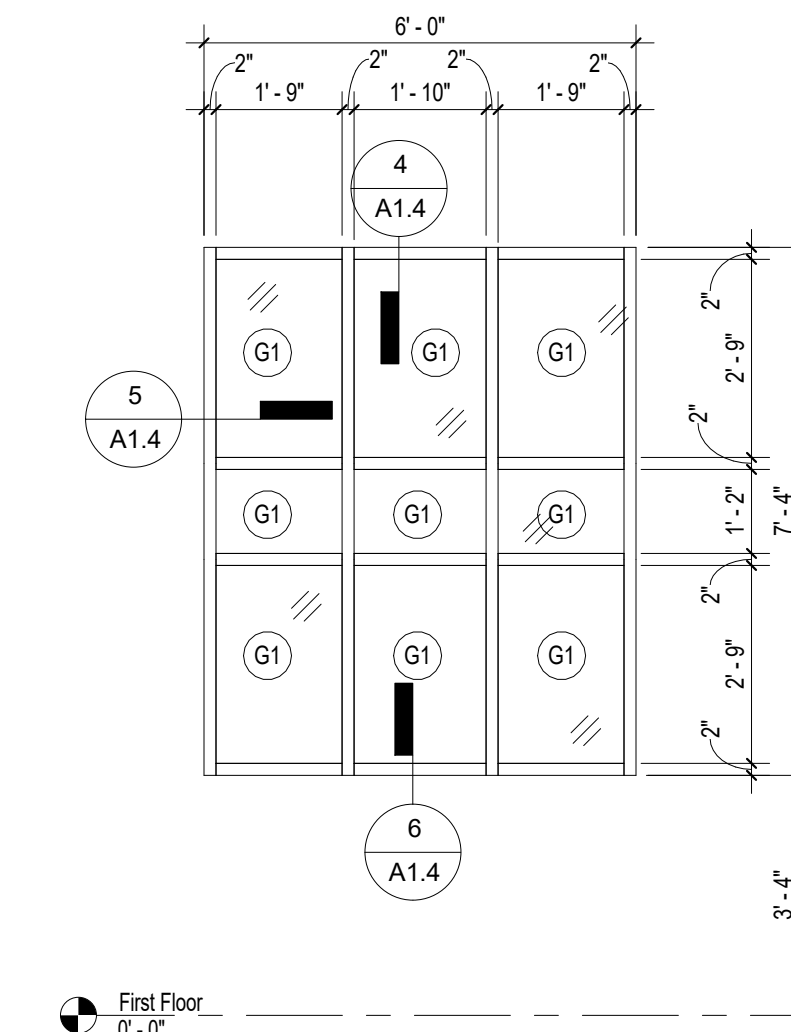

5 JAMB PLAN DETAIL
A1.4 1 1/2" = 1'-0" REFERENCED ON: A1.4

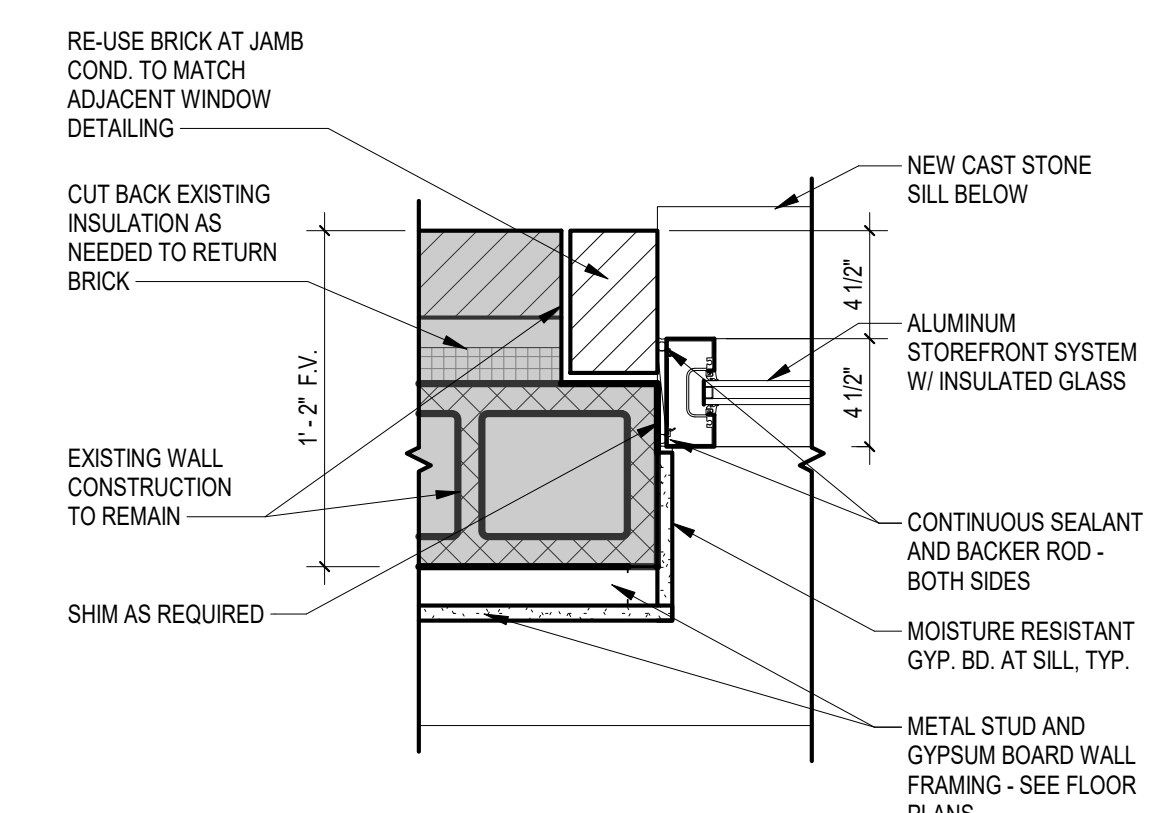

5 JAMB PLAN DETAIL
A1.4 1 1/2" = 1'-0" REFERENCED ON: A1.4

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ADD ALTERNATE NO. 2

LEGEND - ADD ALTERNATE NO. 2


ALL ROOF PAVERS IN THIS AREA TO BE REMOVED AND STORED. EXISTING PEDESTALS TO BE REMOVED AND REPLACED WITH NEW PEDESTALS AT APPROPRIATE HEIGHT TO ACHIEVE PAVER HEIGHT AS SHOWN ON PLANS

GENERAL NOTES - ADD ALTERNATE NO. 2


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KEYNOTES - ADD ALTERNATE NO. 2


- 1 EXISTING ROOF PAVERS TO BE REPLACED IN CONFIGURATION SHOWN - ADDITIONAL PAVERS TO BE TAKEN FROM STOCK REMOVED FROM MEDIA ROOM AREA
- 2 SOLID SURFACE COUNTERTOP/DRAIN RAIL

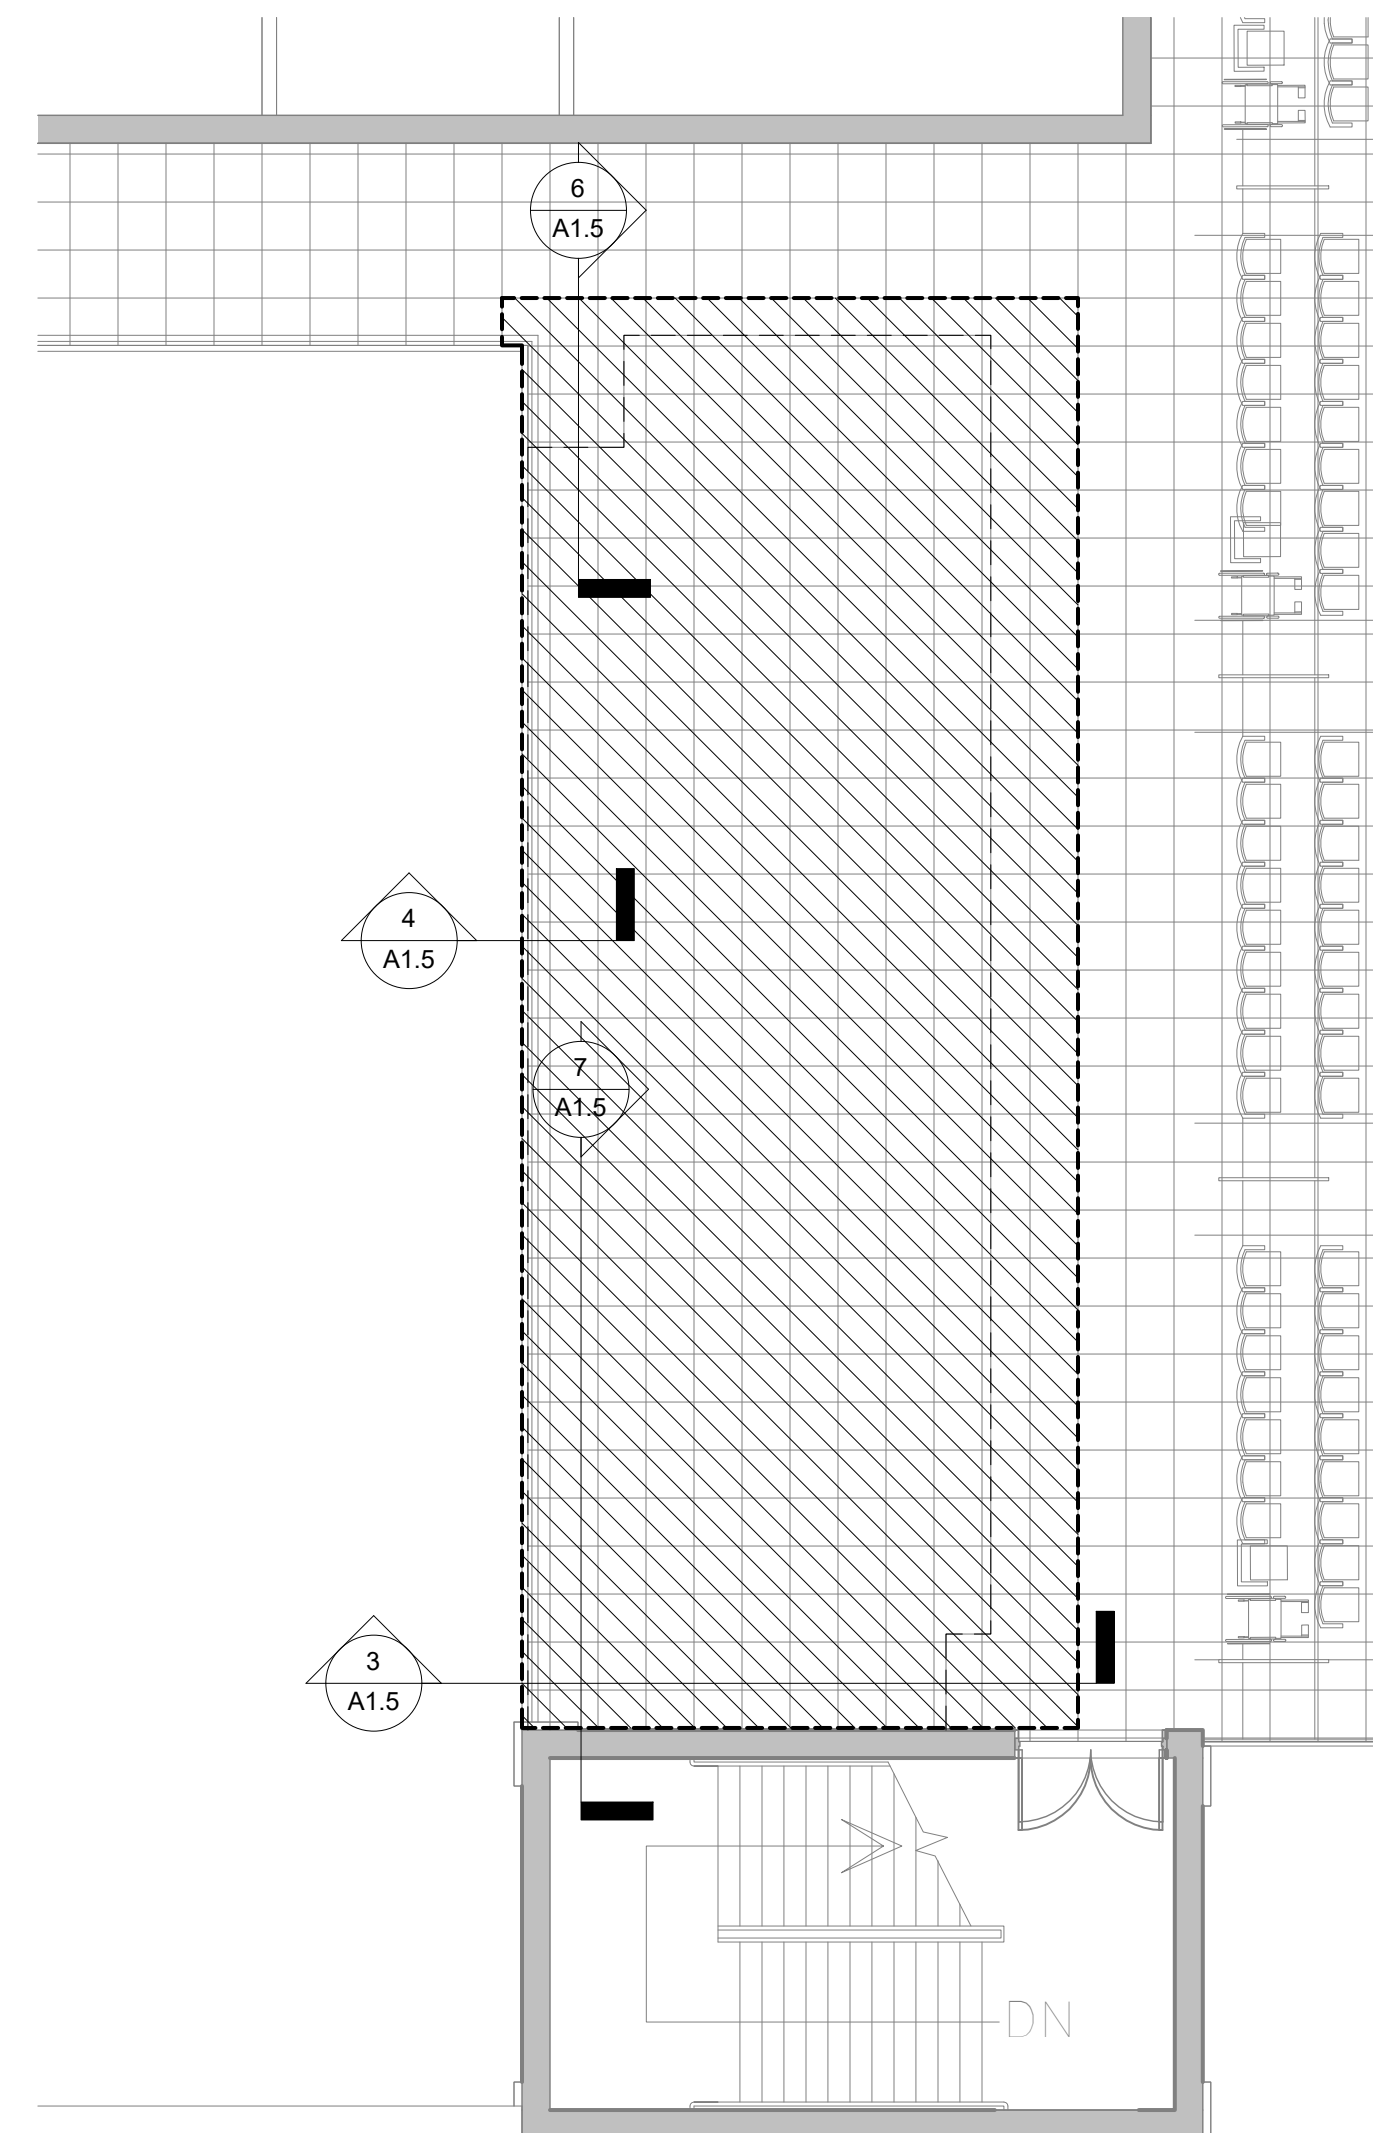


1 DEMOLITION PLAN - TERRACE
A1.5 1/8" = 1'-0" REFERENCED ON

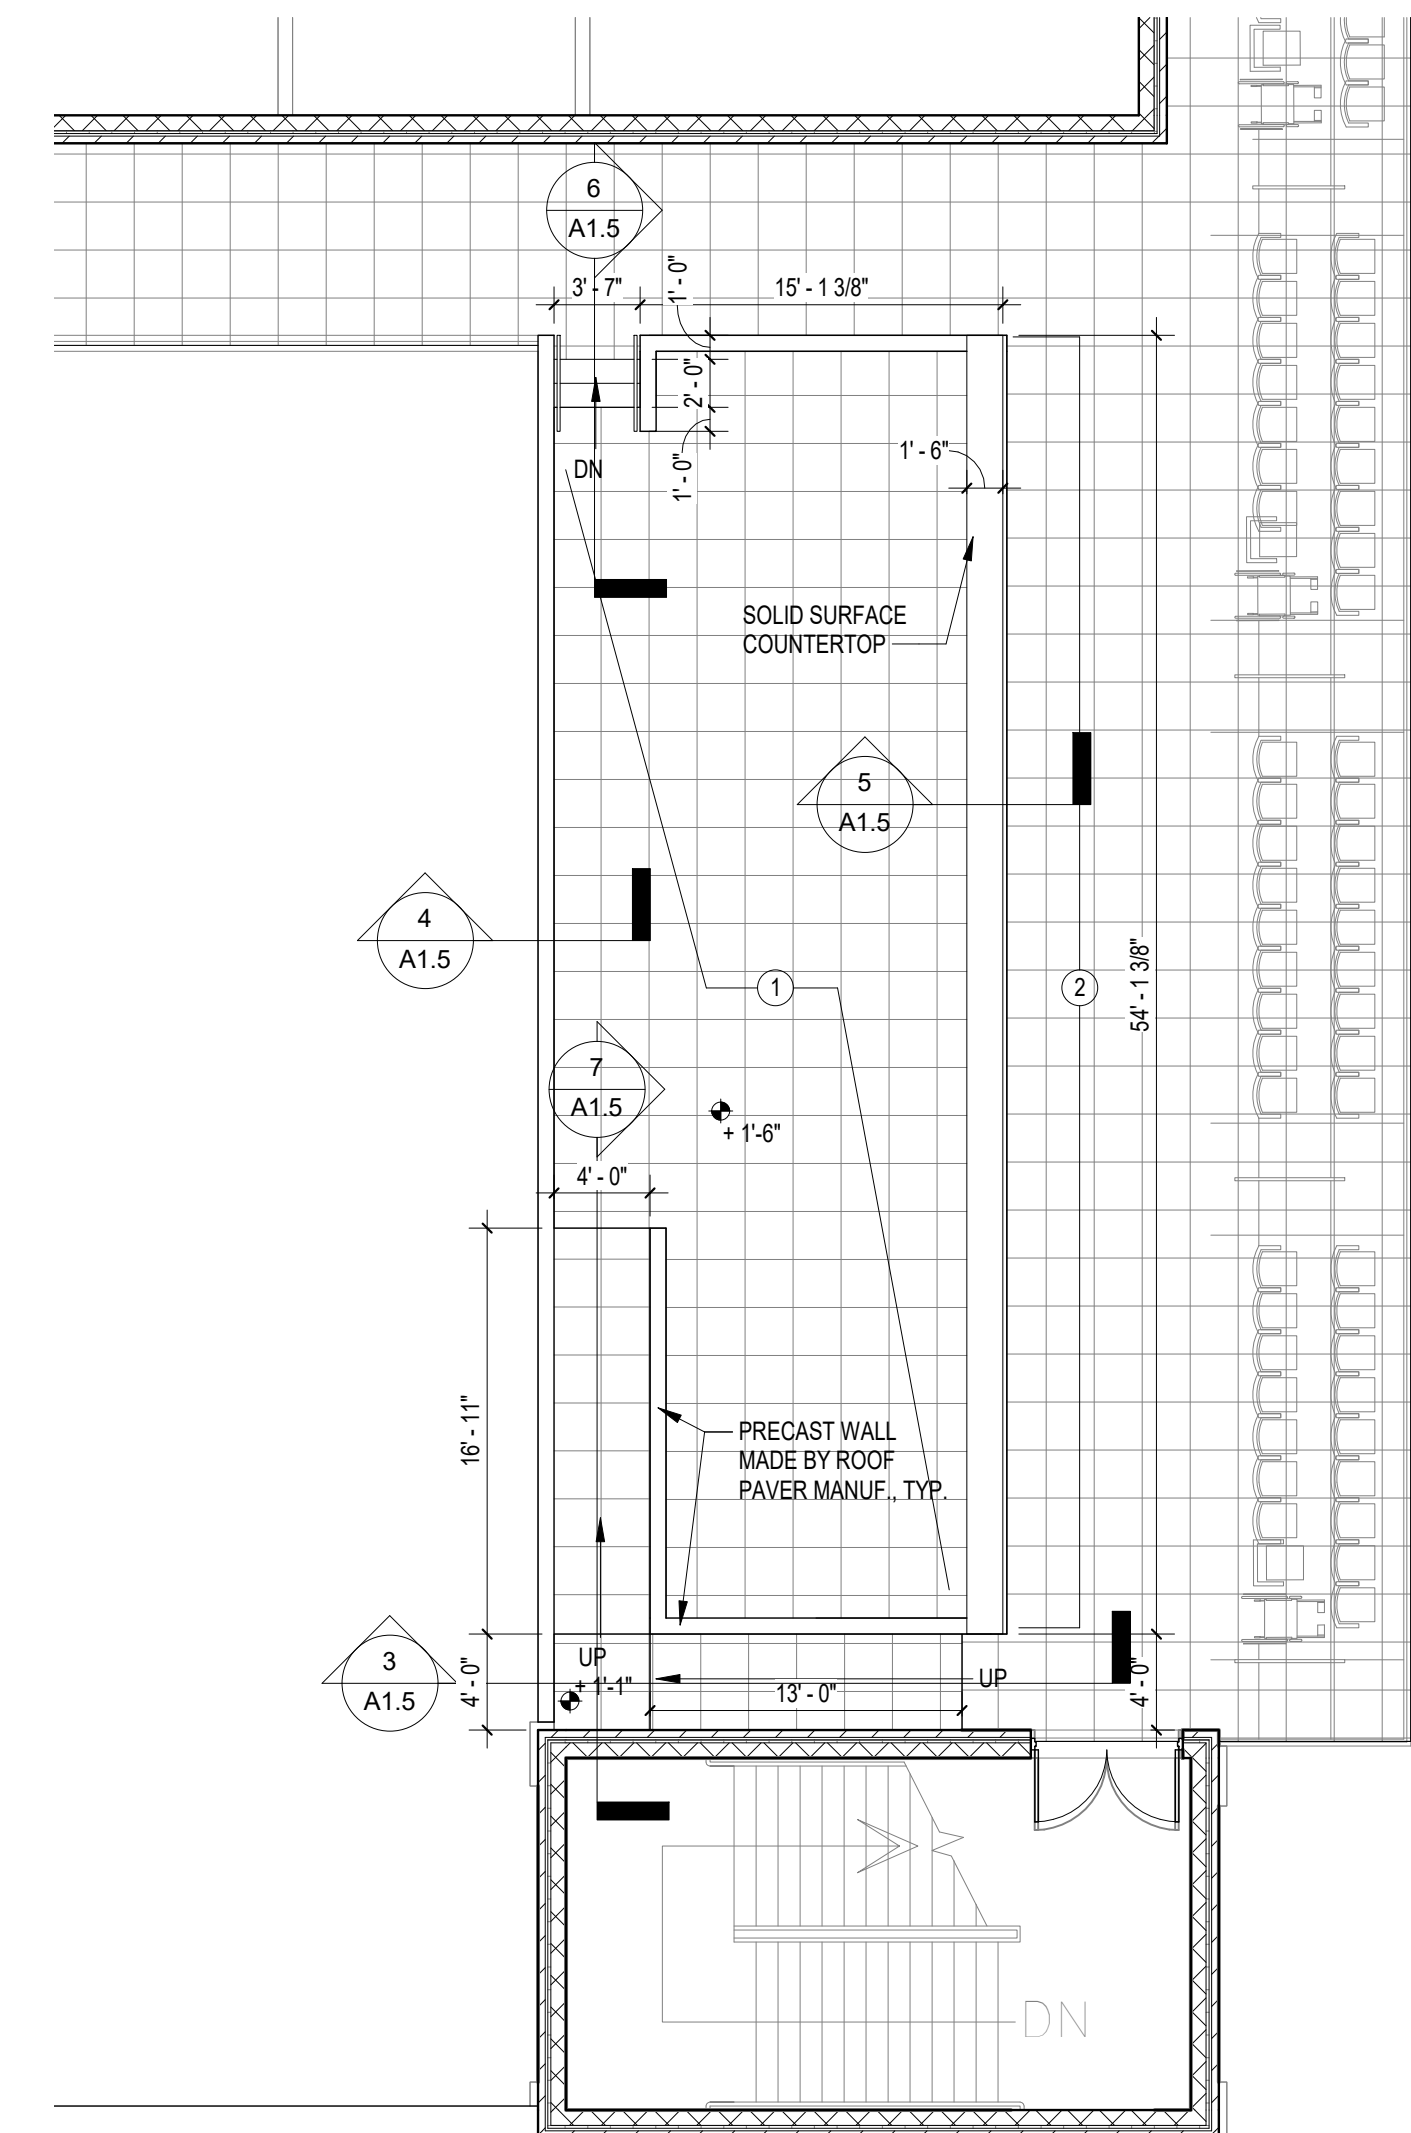


2 FLOOR PLAN - TERRACE
A1.5 1/8" = 1'-0" REFERENCED A1.2 ON

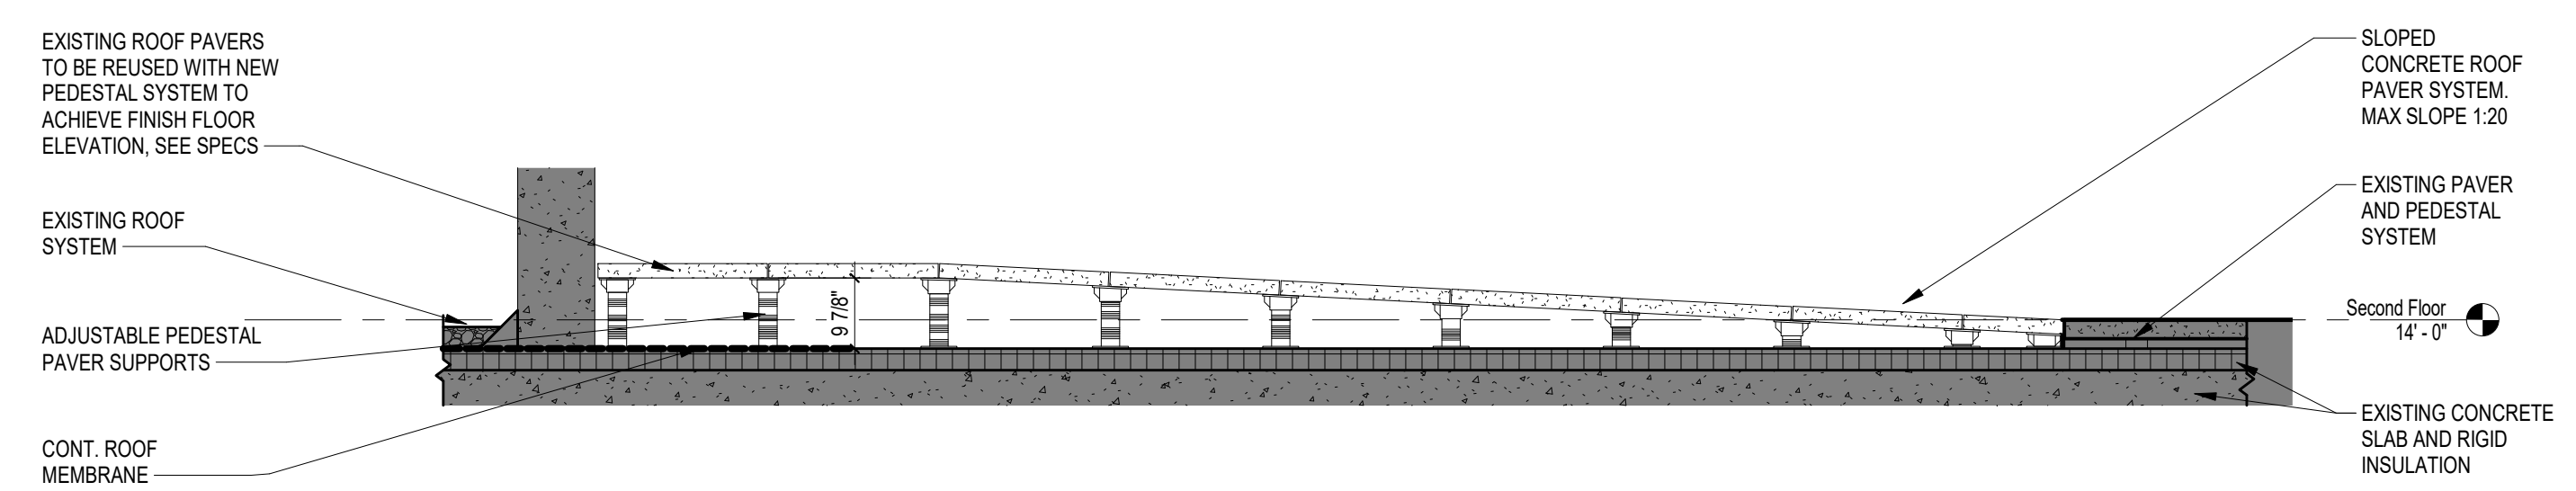


3 WALL SECTION - ADD ALT NO. 1 RAMP
A1.5 1/2" = 1'-0" REFERENCED A1.5 ON

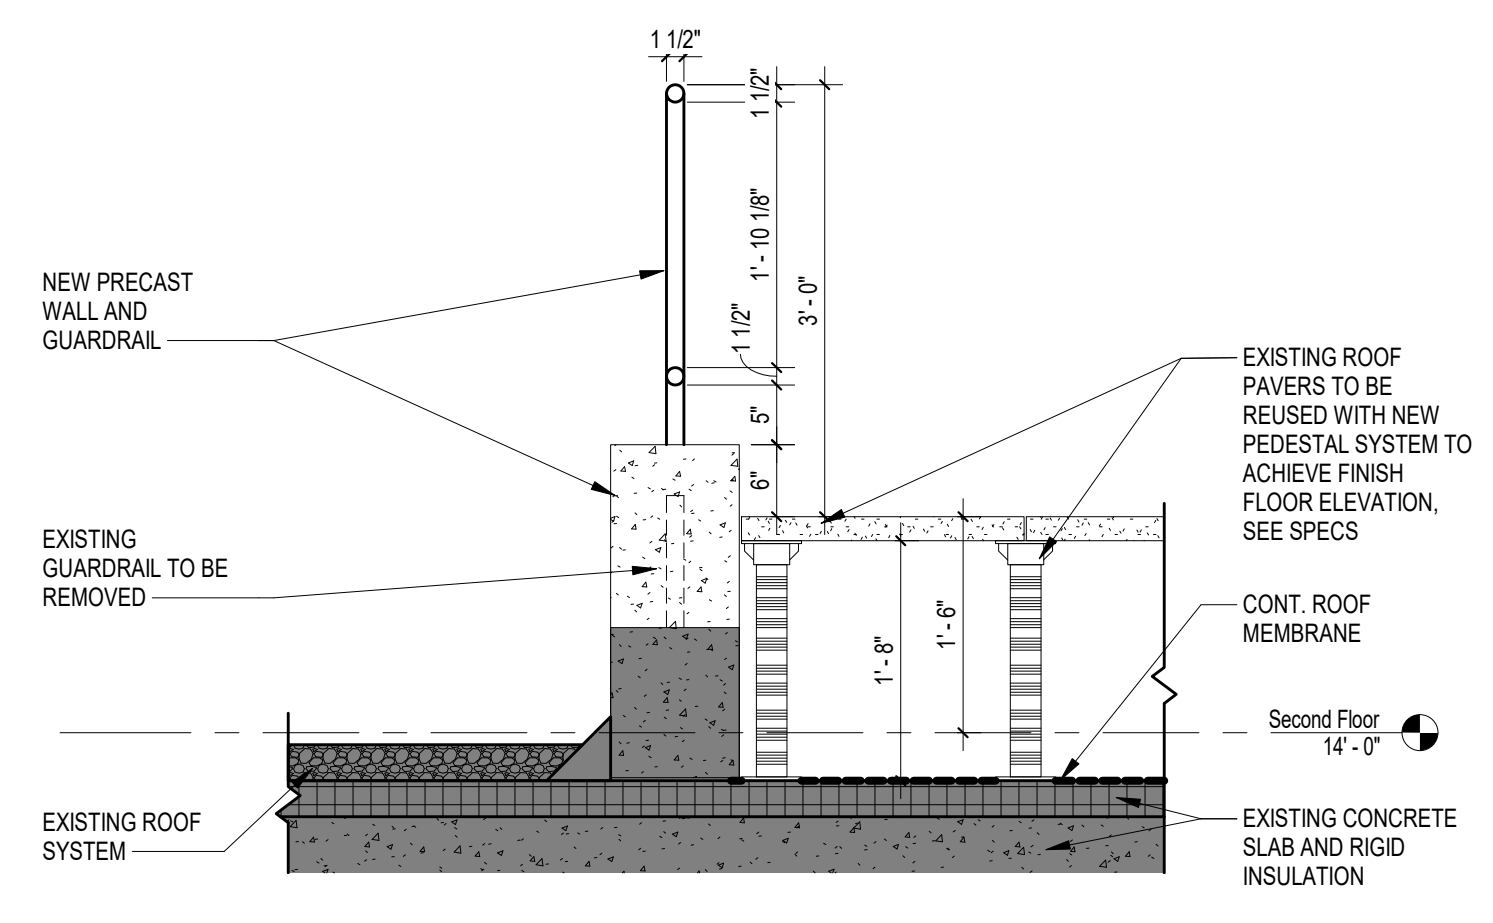


4 WALL SECTION - ADD ALT NO. 2 ROOF
A1.5 3/4" = 1'-0" REFERENCED A1.5 ON

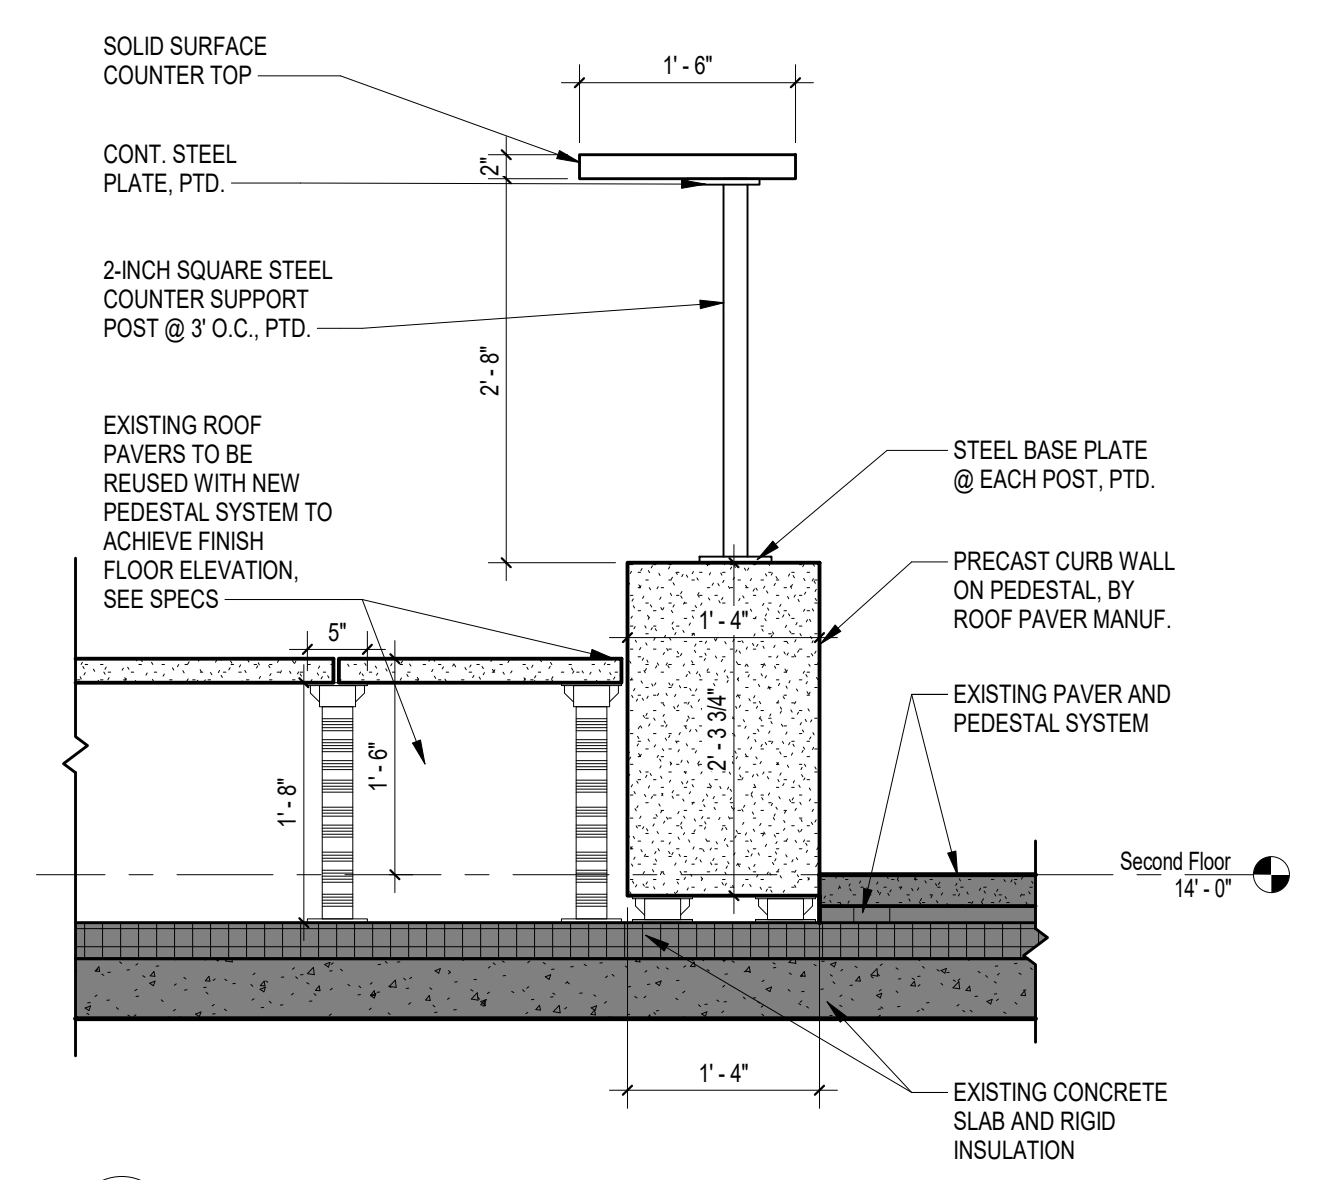


5 WALL SECTION - ADD ALT NO. 2
A1.5 3/4" = 1'-0" REFERENCED A1.5 ON

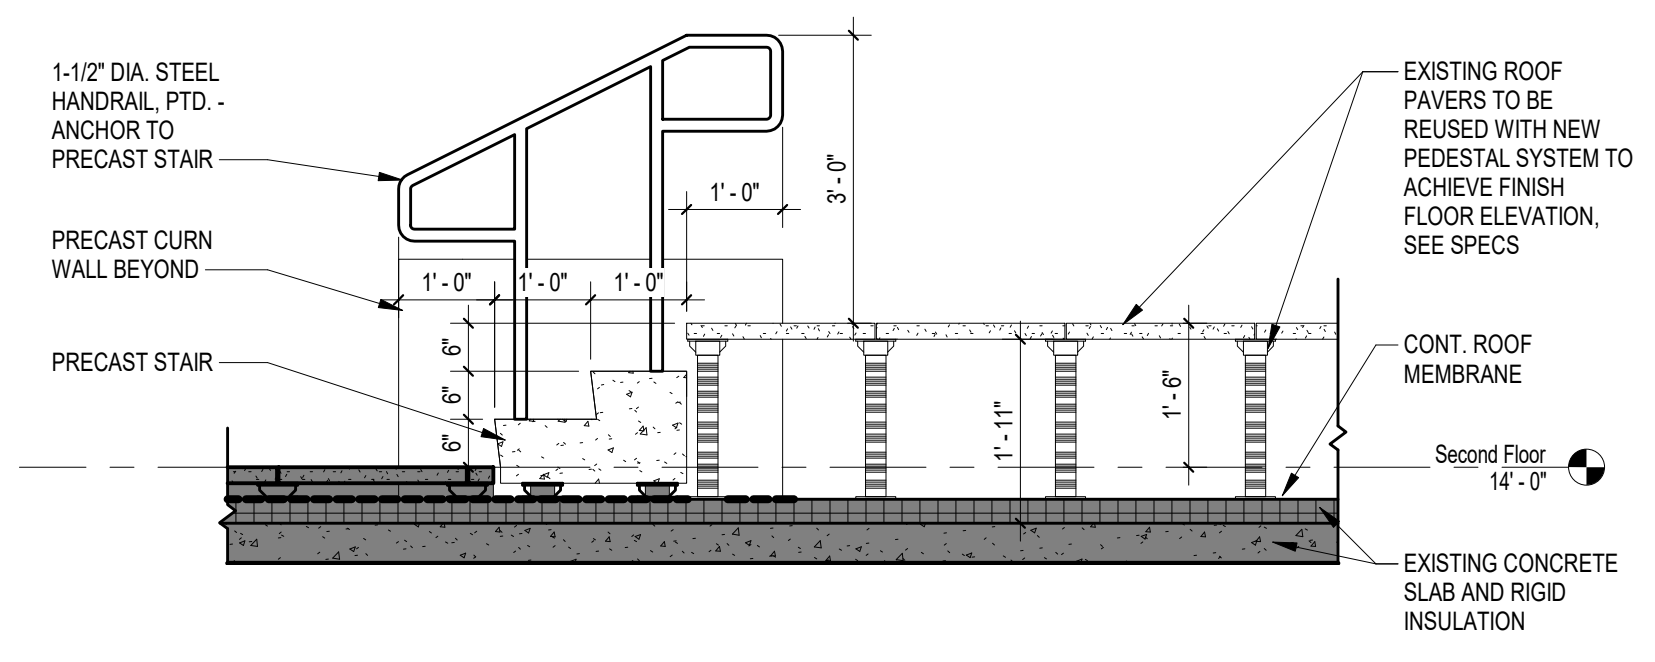

6 WALL SECTION - ADD ALT NO. 2 STAIR
A1.5 1/2" = 1'-0" REFERENCED A1.5 ON

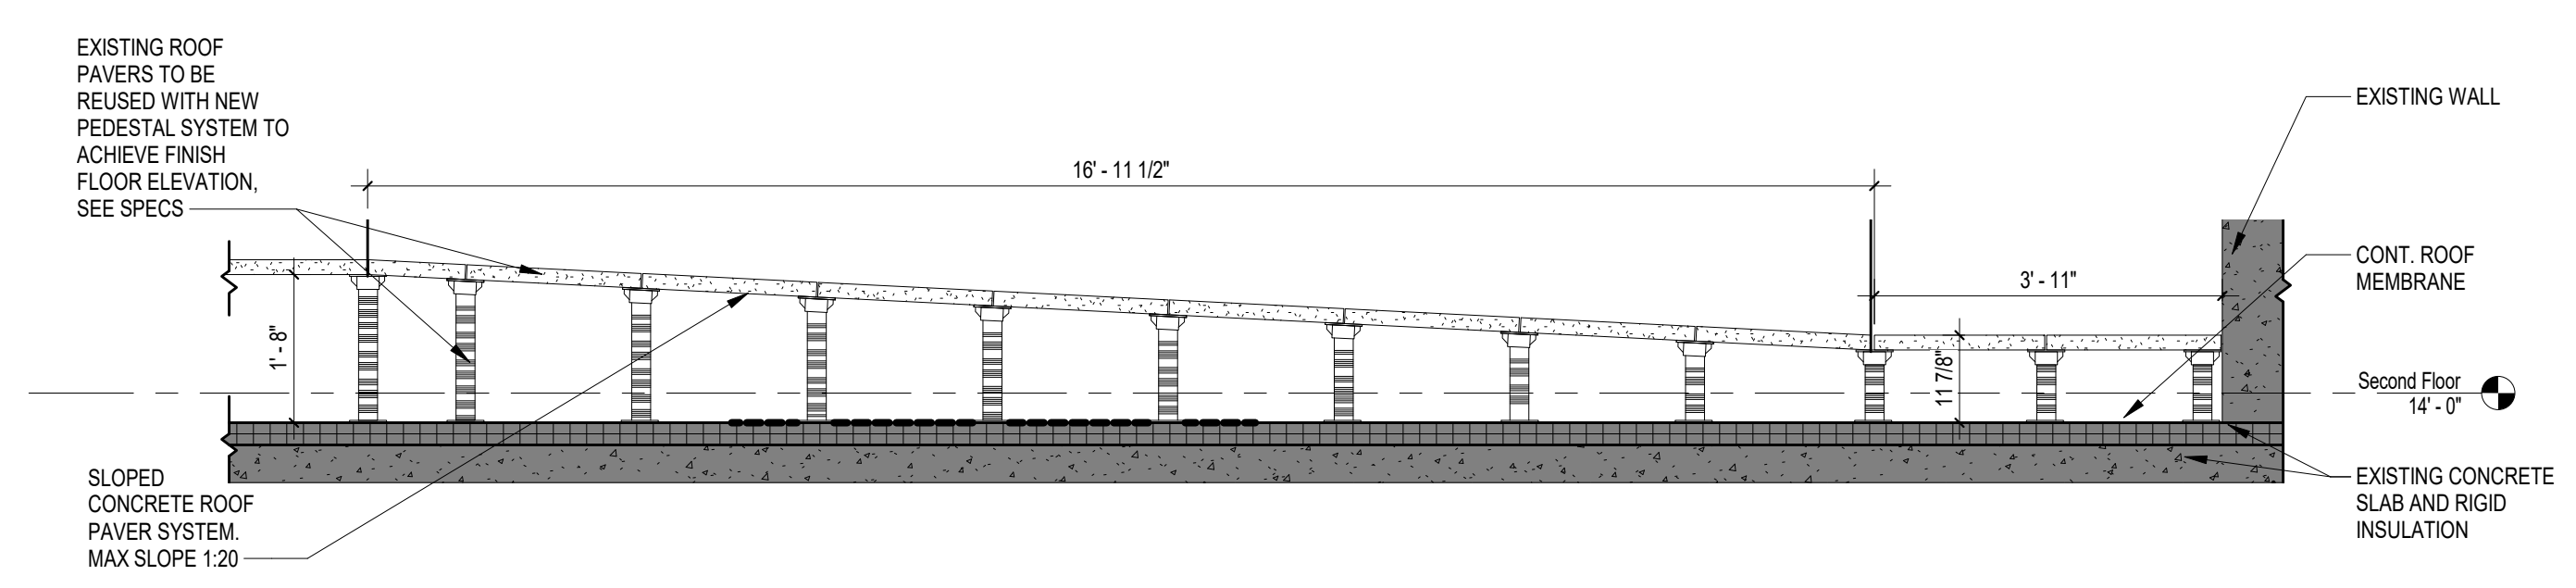

7 WALL SECTION - ADD ALT NO. 2 RAMP 2
A1.5 1/2" = 1'-0" REFERENCED A1.5 ON

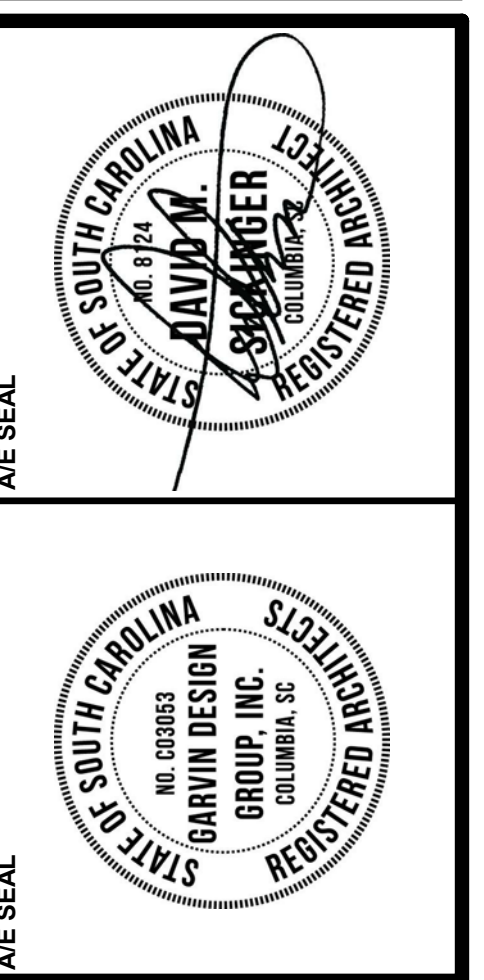

**UNIVERSITY OF SOUTH CAROLINA
FOUNDERS PARK PLAYER'S LOUNGE
AND MEDIA ROOM ADDITION**
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COLUMBIA, SC 29201


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ADD ALTERNATE NO. 2

PROJECT NO.	DATE	DRAWING NO.

A1.5




UNIVERSITY OF SOUTH CAROLINA
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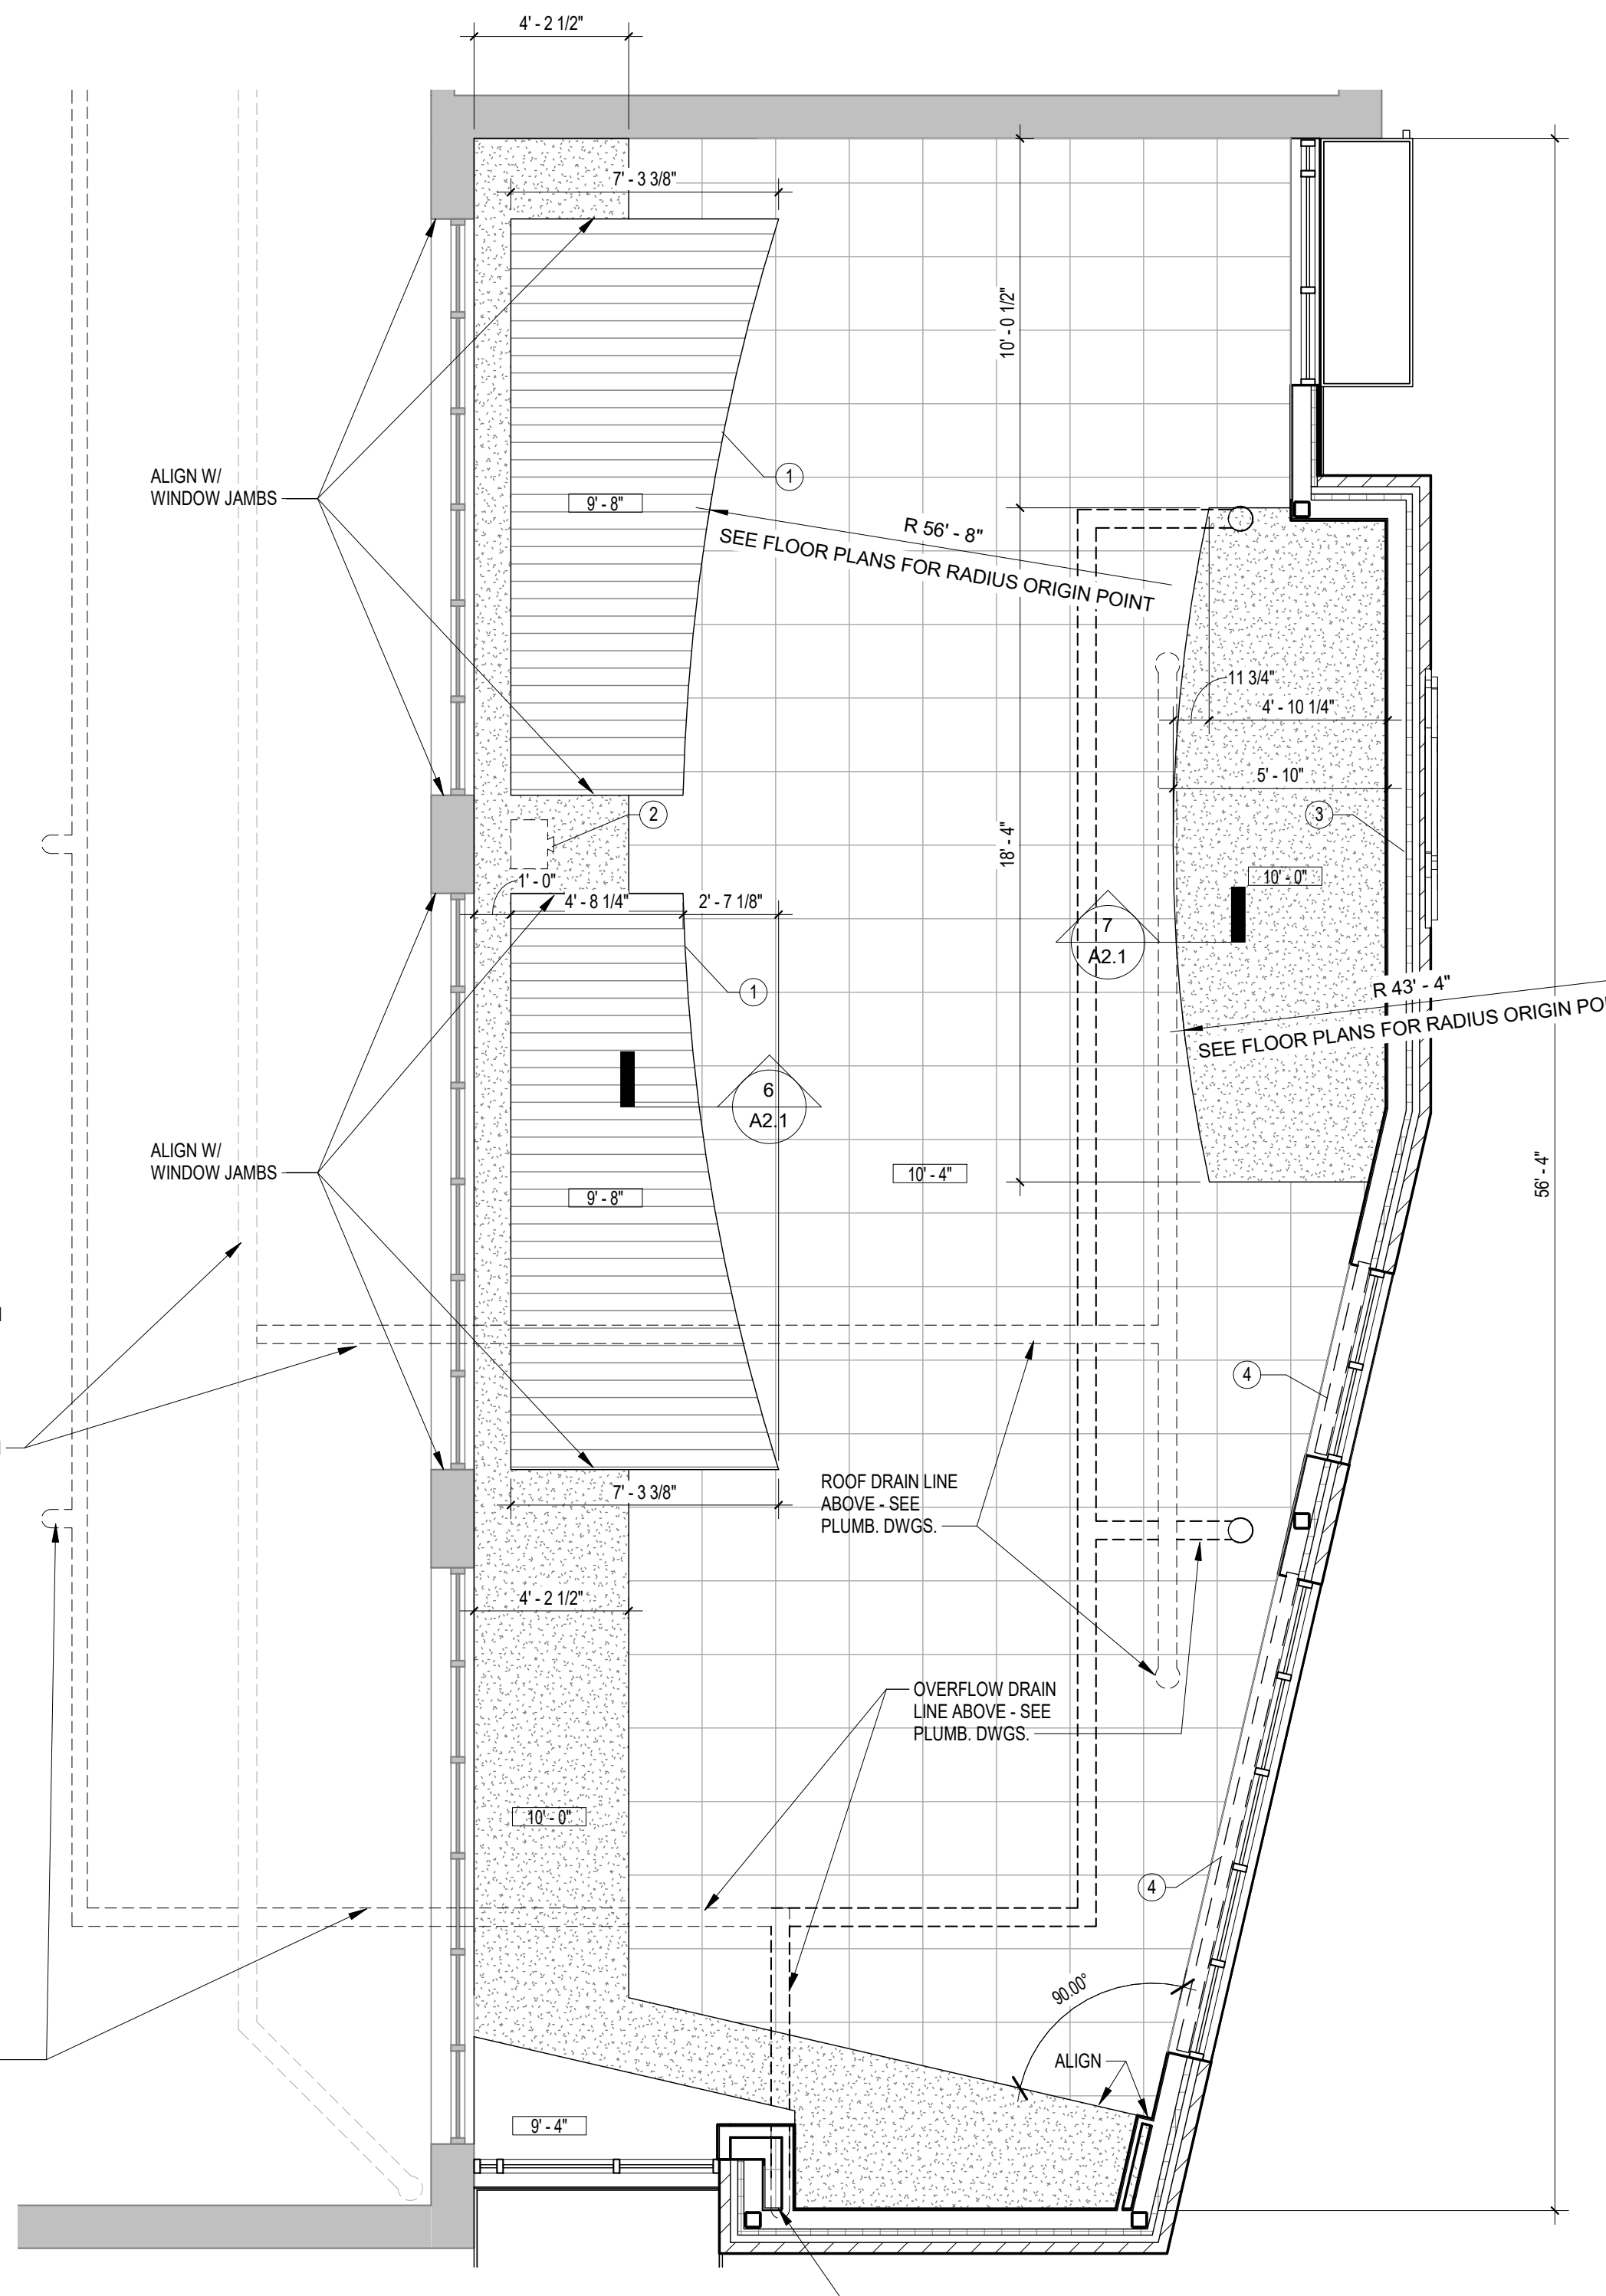
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REFLECTED CEILING PLANS, CEILING DETAILS

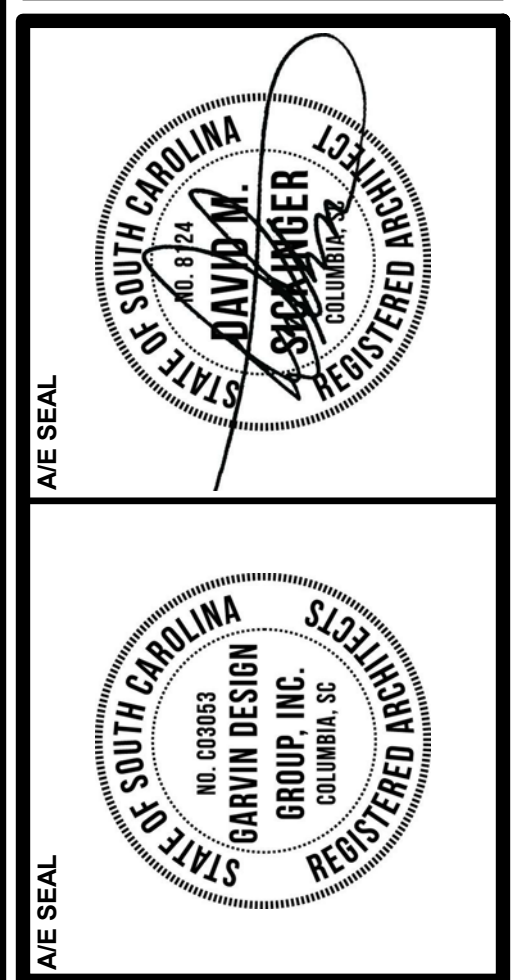PROJECT NO. 1421.18
 DATE 09.21.16
 DRAWING NO. **A2.1**



1 REFLECTED CEILING PLAN - PLAYERS LOUNGE
 A2.1 1/4" = 1'-0" REFERENCED A1.4

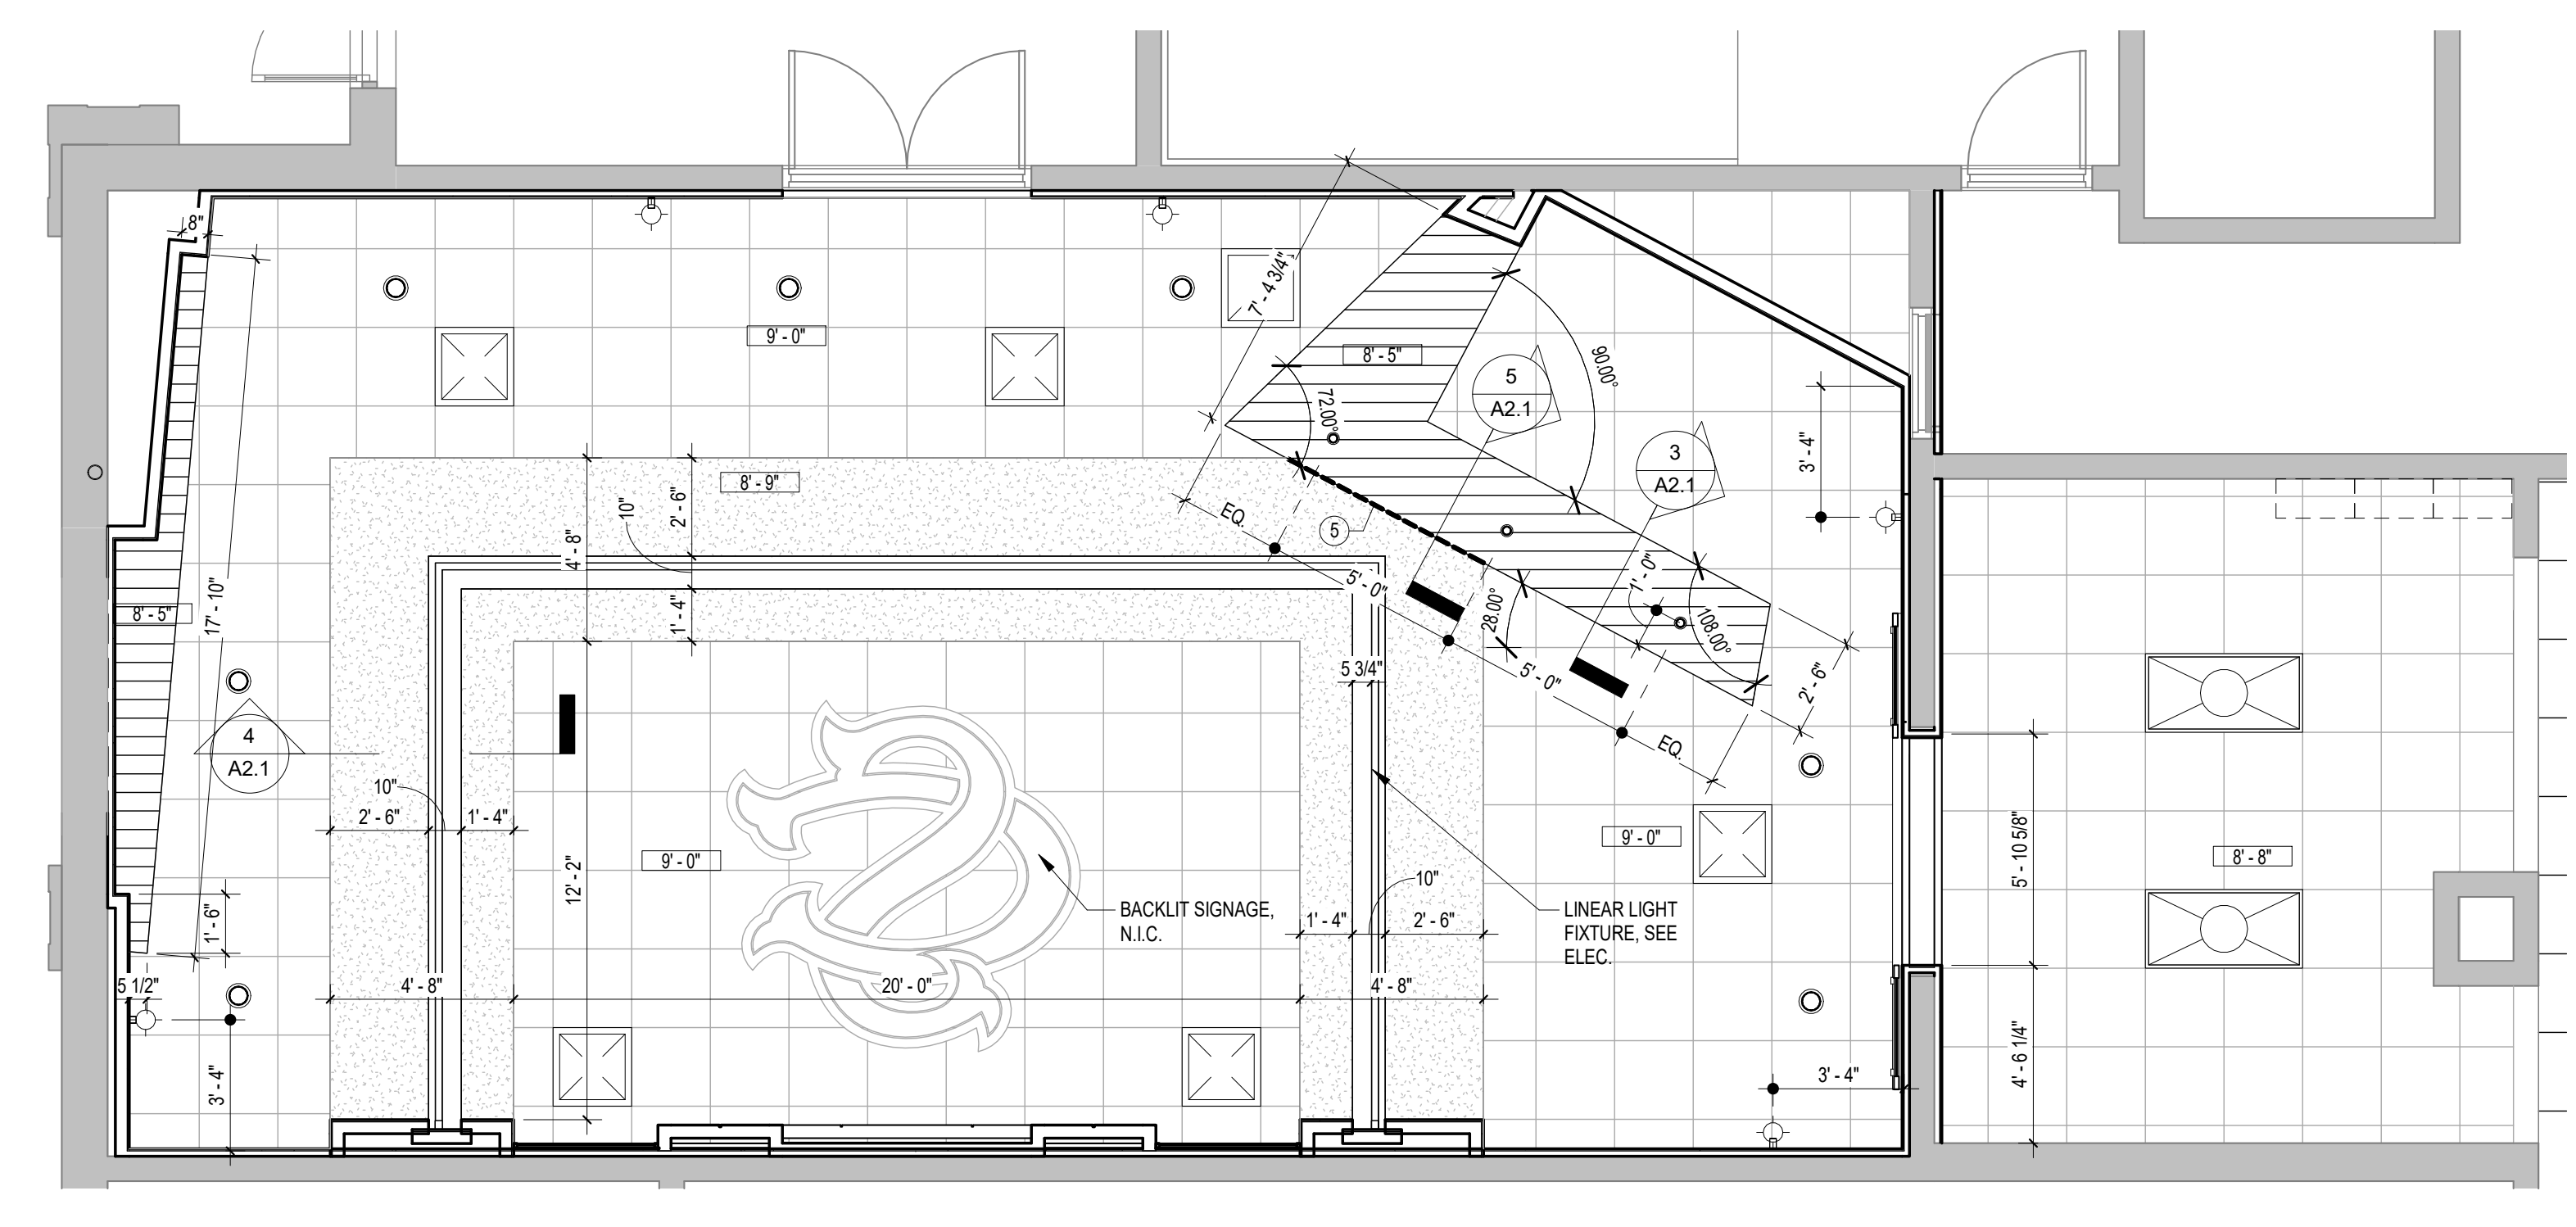

2 REFLECTED CEILING PLAN - MEDIA ROOM
 A2.1 1/4" = 1'-0" REFERENCED A1.5

LEGEND - REFLECTED CEILING PLAN


- ACCESS PANEL - COORDINATE LOCATIONS WITH ARCHITECT
- SUPPLY & RETURN MECHANICAL DIFFUSERS
- LINEAR SLOT DIFFUSER
- FLUORESCENT FIXTURES
- RECESSED INCANDESCENT DOWNLIGHT
- WALL MOUNTED FIXTURES
- STRIP FLUORESCENT FIXTURE
- PENDANT LIGHT
- EXIT LIGHTS - SEE ELECTRICAL DRAWINGS FOR LOCATIONS
- EXPANSION JOINT TYPE
- GYPSUM BOARD CEILING P-1
- GYPSUM BOARD CEILING P-2
- GYPSUM BOARD CEILING P-3
- ACOUSTICAL PANEL CEILING
- SHOWS CEILING HEIGHTS RELATIVE TO MAIN 0'-0" FINISHED FLOOR ELEVATION (EX. EAST ENTRY A104 FINISHED FLOOR)

KEYNOTES - REFLECTED CEILING PLAN


- 1 WALL/CEILING MOUNTED GYPSUM BOARD DECORATIVE PANEL
- 2 CEILING MOUNTED PROJECTOR, N.I.C. - TO BE PROVIDED AND INSTALLED BY OWNER. SEE ELECTRICAL DRAWINGS FOR POWER/DATA REQUIREMENTS
- 3 MOTORIZED PROJECTION SCREEN, N.I.C. - TO BE PROVIDED AND INSTALLED BY OWNER. SEE SPECS AND ELECTRICAL DRAWINGS FOR POWER REQUIREMENTS
- 4 MOTORIZED WINDOW SHADES - SEE SPECS AND ELECTRICAL DRAWINGS
- 5 GYPSUM BOARD CONTROL JOINT

GENERAL NOTES - REFLECTED CEILING PLAN


1. REFER TO ELECTRICAL DRAWINGS FOR QUANTITY AND SPECIFIC FIXTURE DESIGNATIONS.
2. ALL SUSPENDED ACOUSTICAL GRIDS ARE TO BE CENTERED IN CEILING ROOM AS SHOWN, UNLESS NOTED OTHERWISE.
3. CEILING MOUNTED EQUIPMENT, DEVICES, FIXTURES & GRILLS MUST BE COORDINATED ON REFLECTED CLG. PLANS. CEILING MOUNTED SPRINKLERS TO BE LOCATED IN CENTER OF CEILING TILE IN APC CEILINGS AND ALIGN WITH DOWNLIGHTS IN GYPSUM CEILINGS.
4. SEE FF DRAWINGS FOR FIRE PROTECTION SYSTEM LAYOUT. COORDINATE ROUTING OF PIPING W/ ARCHITECTURAL DWGS AND DETAILS AS WELL AS ALL OTHER SYSTEM DRAWINGS (Ss, Ms, Ps, & Es). SUBMIT LAYOUT COORDINATION DRAWING FOR REVIEW & APPROVAL PRIOR TO INSTALLATION.
5. PAINT ALL EXPOSED STRUCTURE/CEILING AREA, INCLUDING ROOF DECK, STEEL STRUCTURE, DUCTWORK, PLUMBING LINES, FIRE SUPPRESSION LINES, ELEC. CONDUITS & BOXES AND OTHER NON-FINISHED ITEMS, EXCEPT IN MECHANICAL ROOMS, ELECTRICAL ROOM, ELEVATOR MACHINE ROOMS, AND TEL/DATA ROOMS, UNLESS NOTED OTHERWISE ON FINISH SCHEDULES AND INTERIOR ELEVATIONS.
6. ACCESS PANELS BY GENERAL CONTRACTOR. QUANTITY OF ACCESS PANELS SHOWN ON ARCHITECTURAL DRAWINGS NOT INTENDED TO BE ALL INCLUSIVE; SEE MECHANICAL DRAWINGS, PLUMBING DRAWINGS, ELECTRICAL DRAWINGS, AND FIRE PROTECTION SHOP DRAWINGS FOR ADDITIONAL ACCESS PANELS. NOT SHOWN, COORDINATE EXACT LOCATION OF ACCESS PANELS NOT SHOWN WITH ARCHITECT. BRING ALL MECHANICAL AND PLUMBING ITEMS WHICH NEED ACCESS TO THE ACCESS PANEL LOCATIONS SHOWN. BRING THE NEED FOR ADDITIONAL ACCESS PANELS TO THE ARCHITECT'S ATTENTION BEFORE PROCEEDING.
7. PAINT ALL EXPOSED STEEL LINTELS, ANGLES AND PLATES, AND CONCRETE BEAMS.
8. REFERENCE ELECTRICAL DRAWINGS FOR FULL EXTENT OF ELECTRICAL CEILING AND WALL MOUNTED DEVICES.

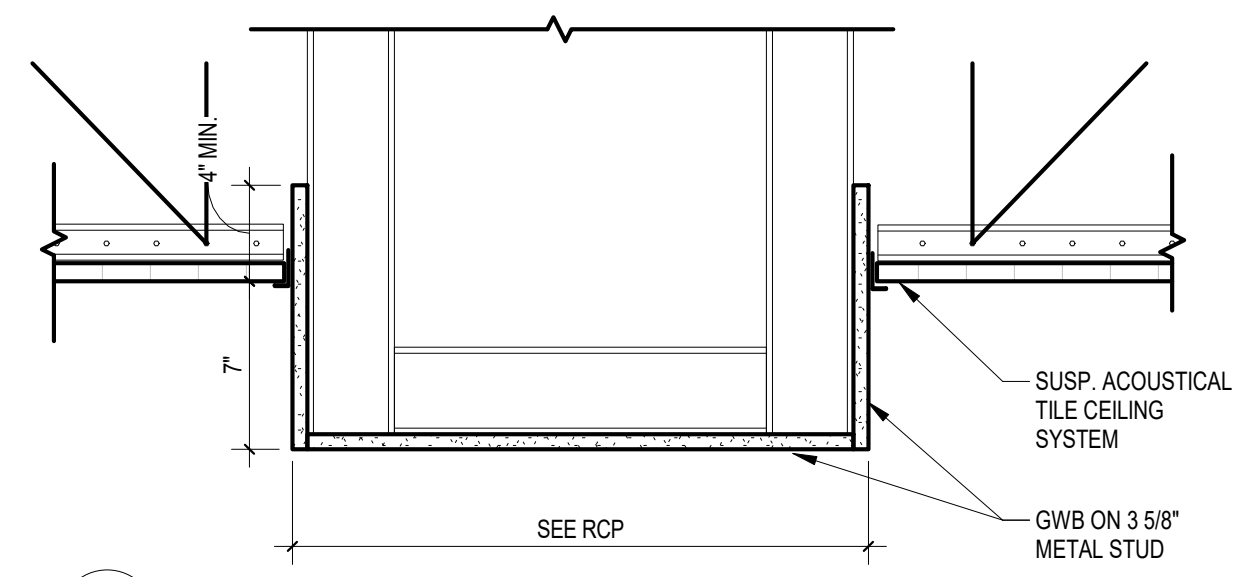


3 CEILING SECTION DETAIL
 A2.1 1 1/2" = 1'-0" REFERENCED A2.1

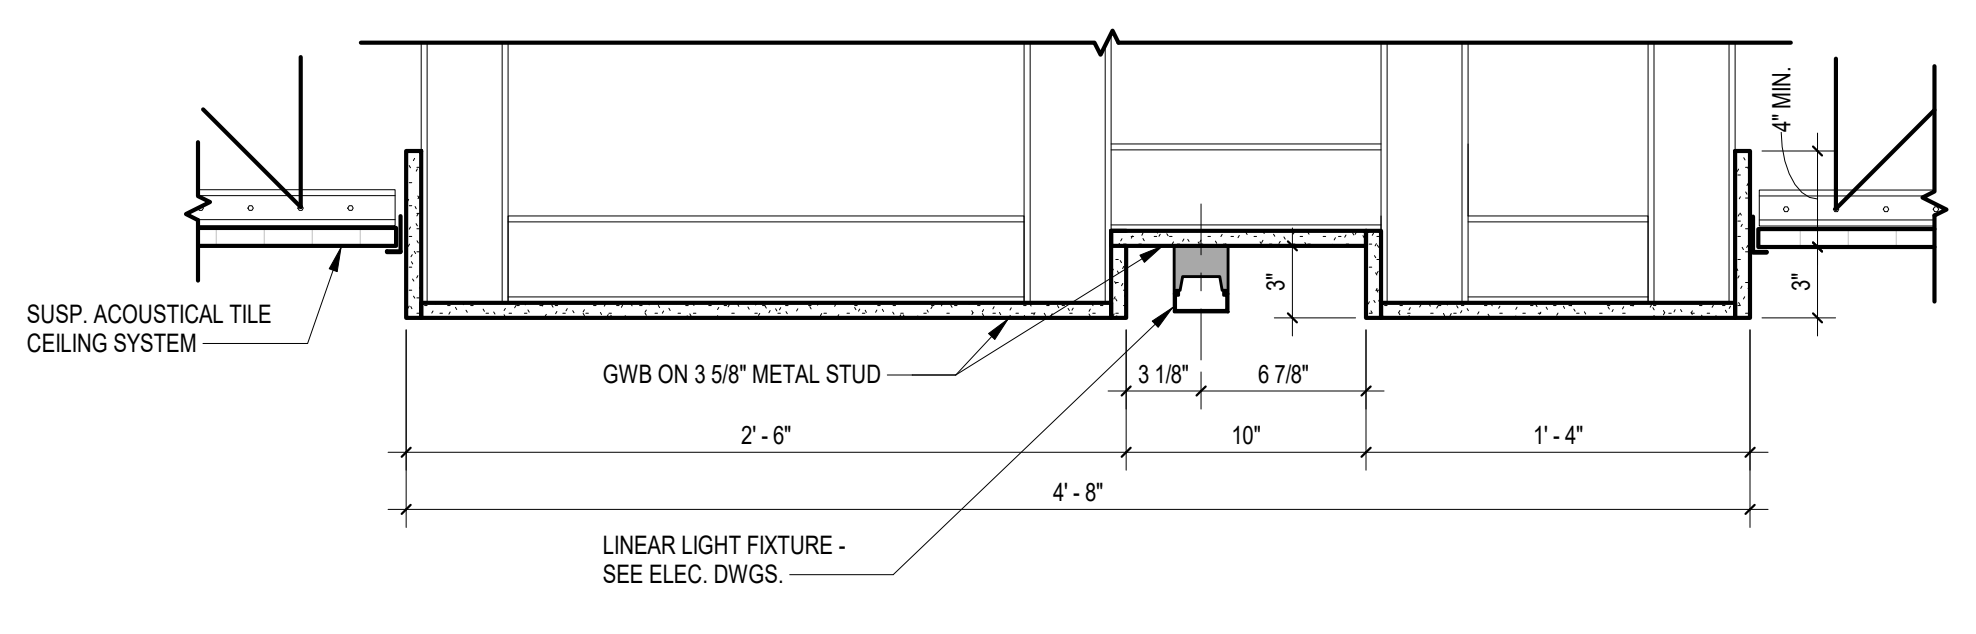


4 CEILING SECTION DETAIL
 A2.1 1 1/2" = 1'-0" REFERENCED A2.1

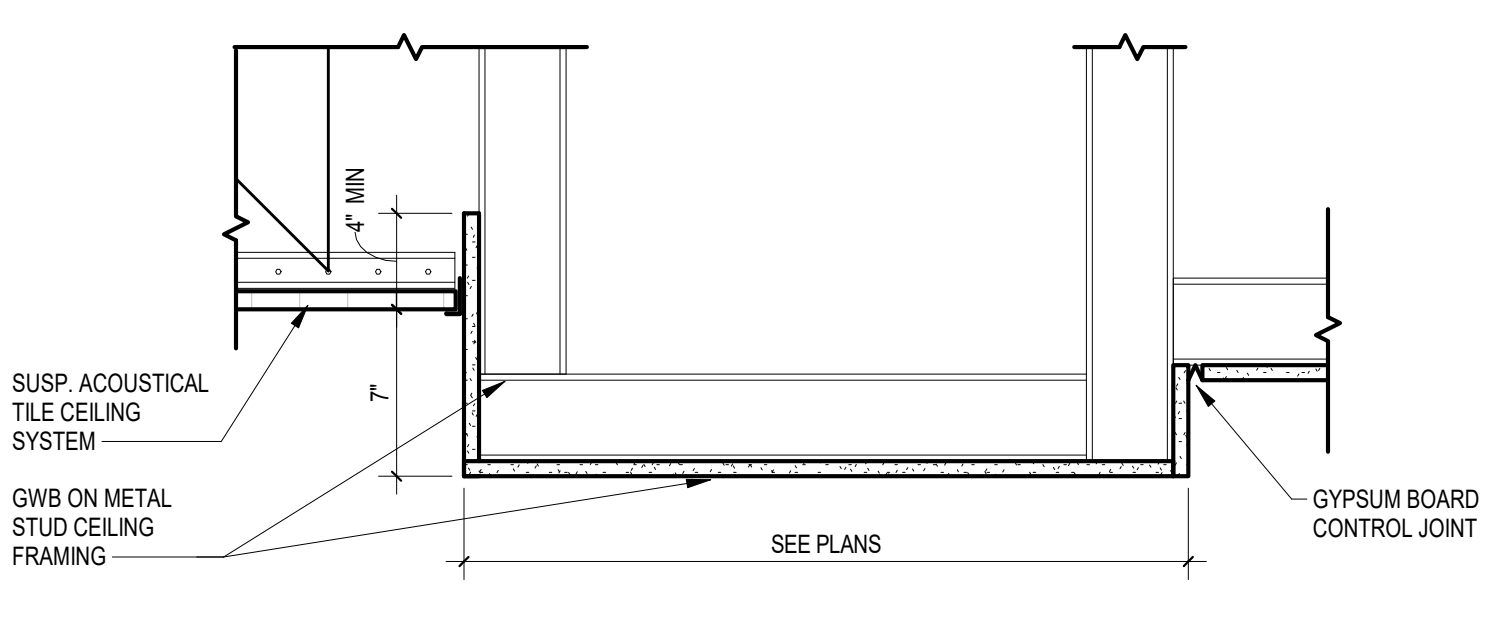




5 CEILING SECTION DETAIL
 A2.1 1 1/2" = 1'-0" REFERENCED A2.1

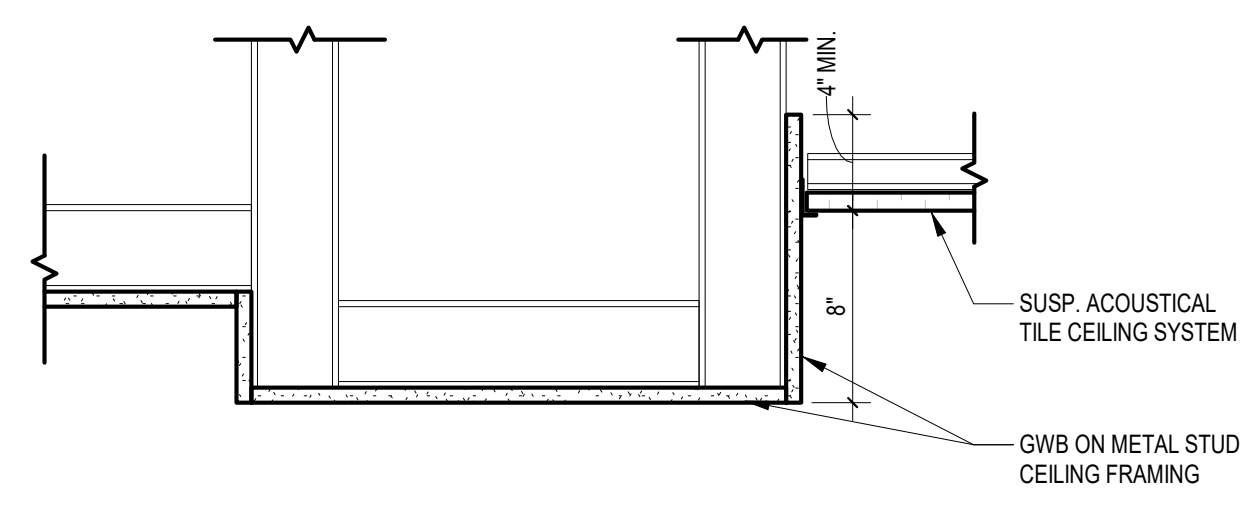

6 CEILING SECTION DETAIL
 A2.1 1 1/2" = 1'-0" REFERENCED A2.1


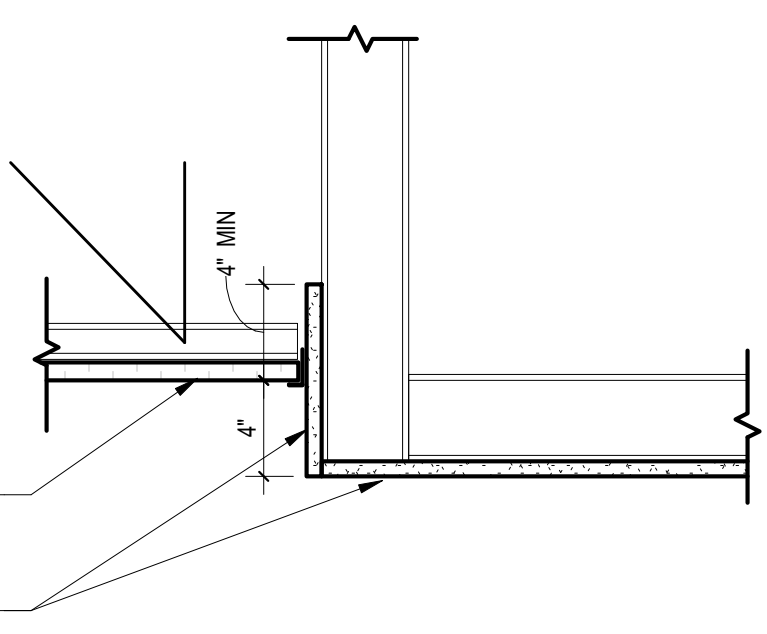


7 CEILING SECTION DETAIL
 A2.1 1 1/2" = 1'-0" REFERENCED A2.1

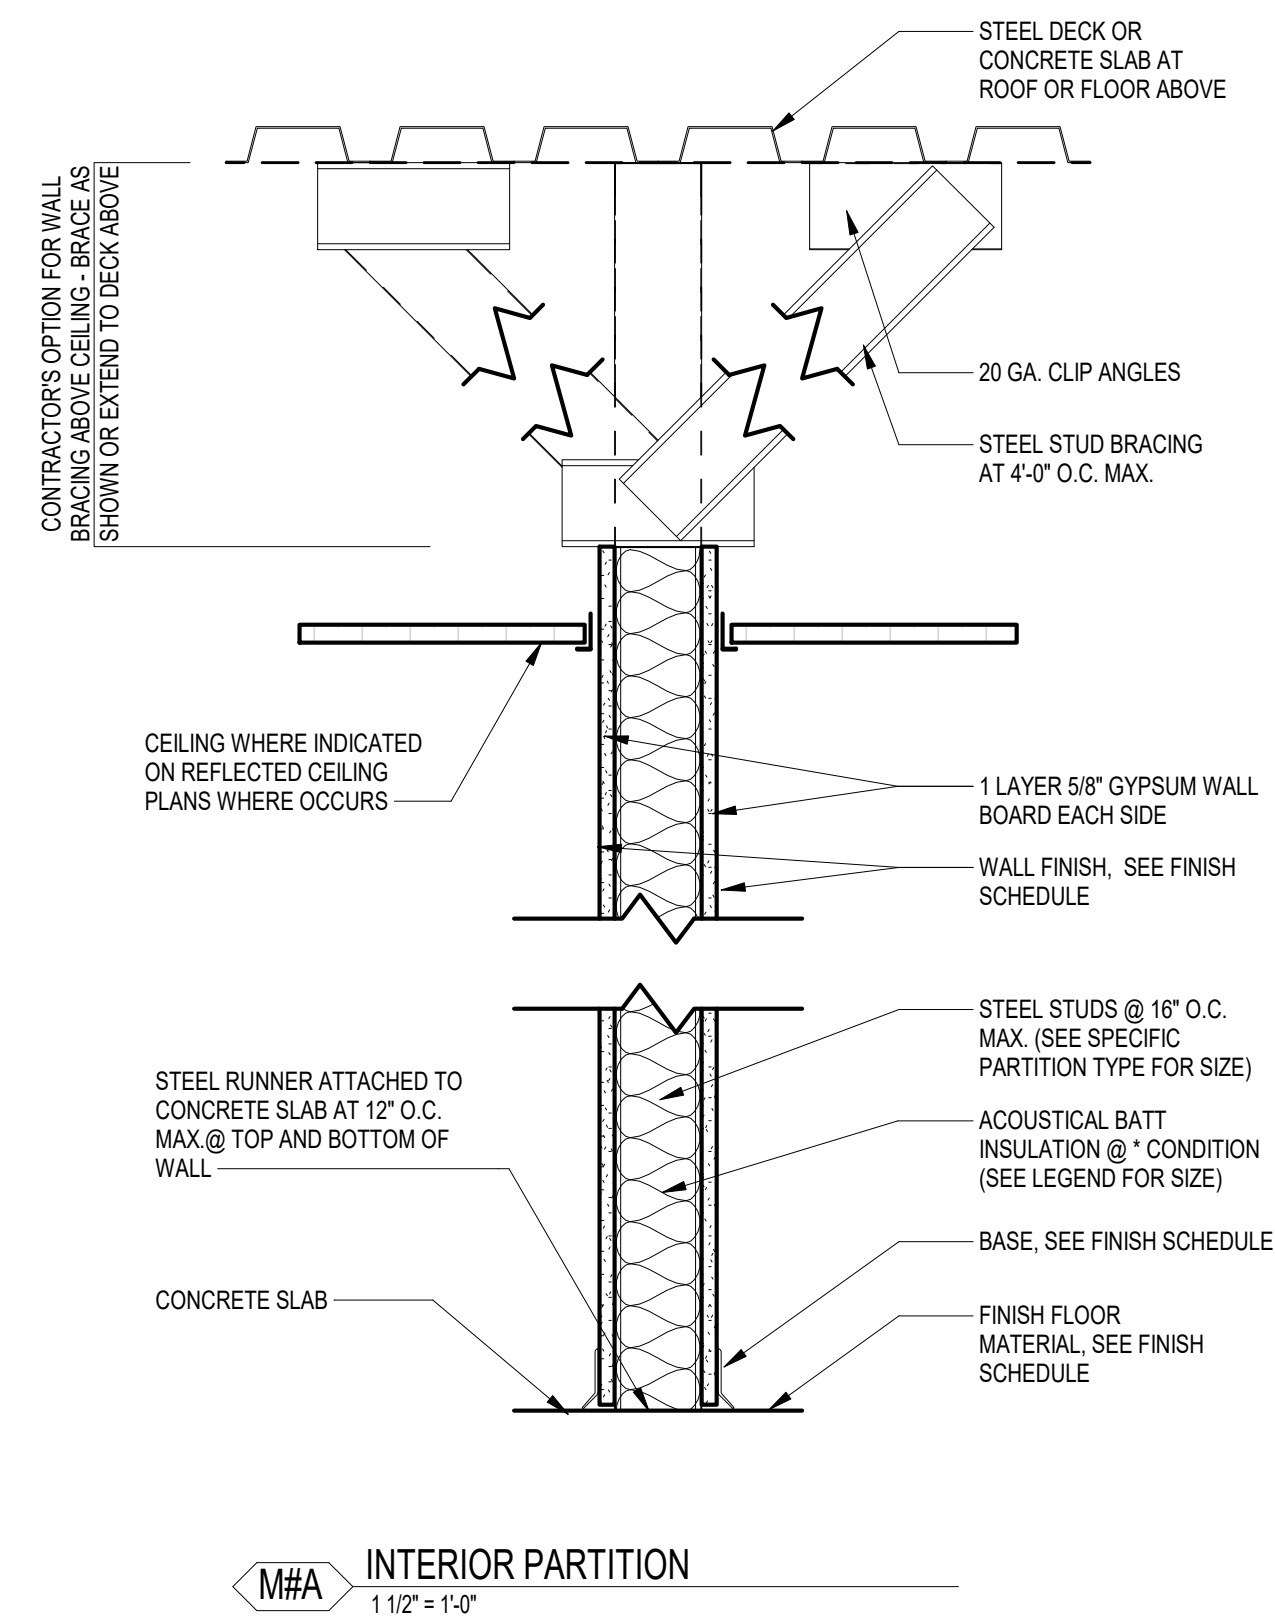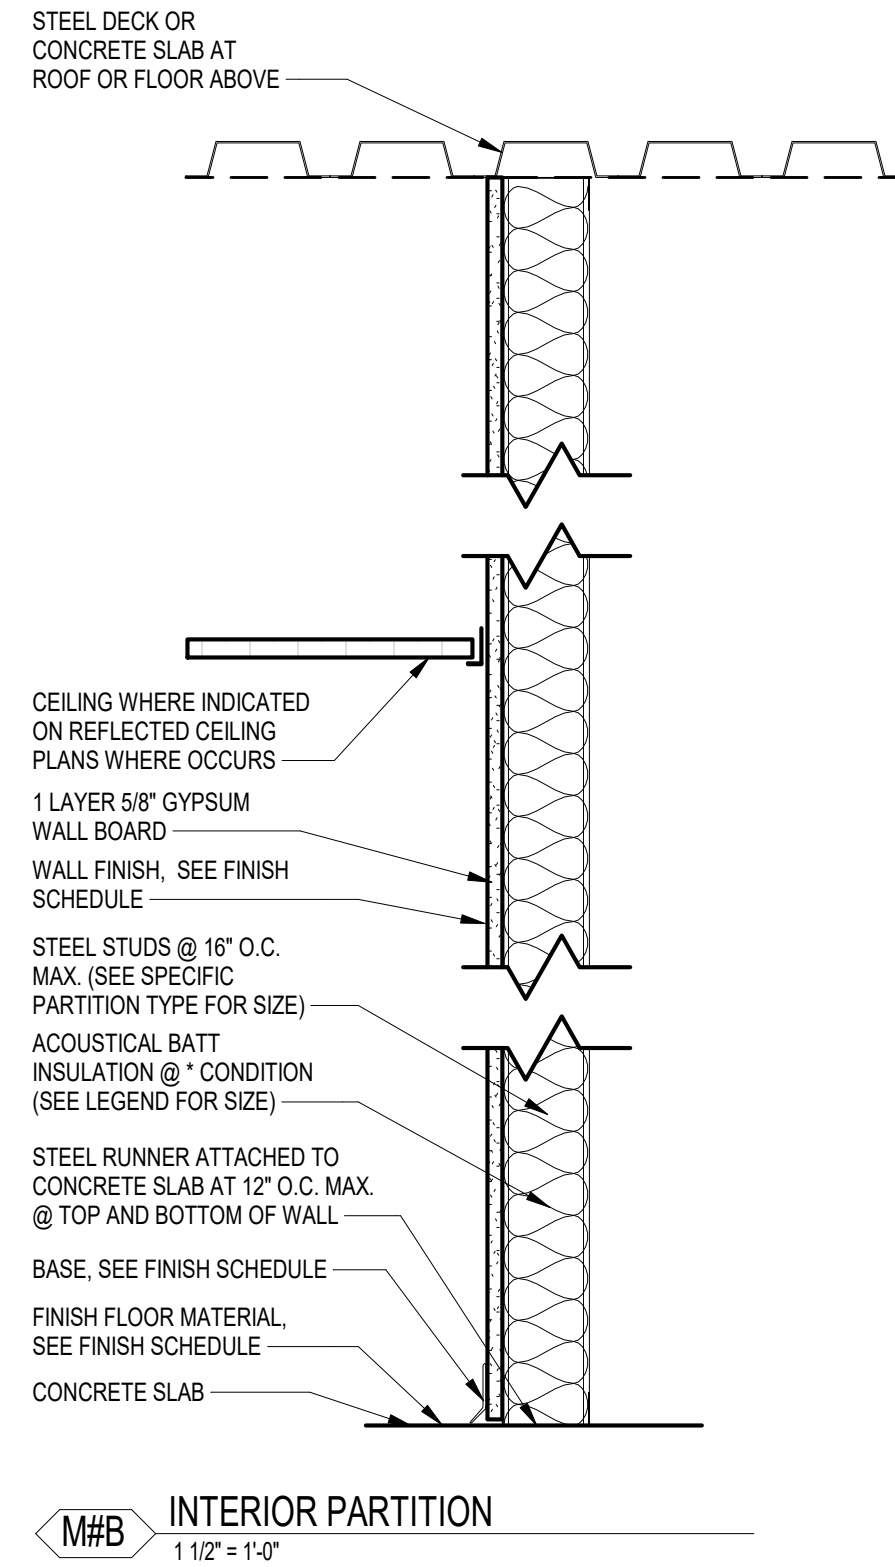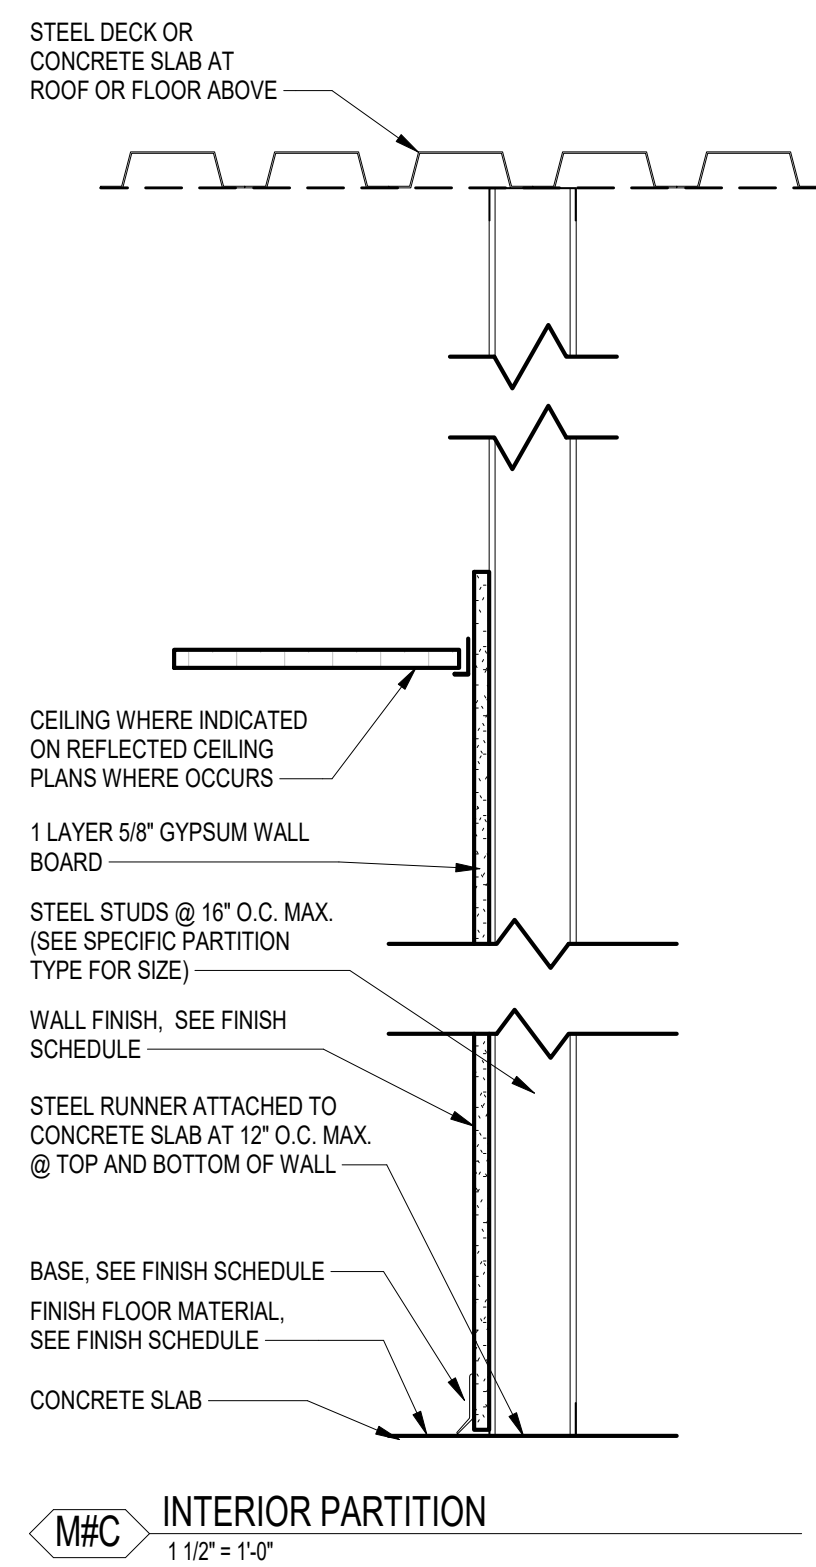

LEGEND - PARTITION TYPES

MATERIAL	FINISH	CONSTRUCTION SECTION
M1	1-5/8" METAL STUD	
M2	2-1/2" METAL STUD	
M3	3-5/8" METAL STUD	
M4	4" METAL STUD	
M6	6" METAL STUD	
M8	8" METAL STUD	
W2	2X2" WOOD STUD	
W4	2X4" WOOD STUD	
W6	2X6" WOOD STUD	
W8	2X8" WOOD STUD	
C4	4" CMU (5-5/8" NOM.)	
C8	8" CMU (7-5/8" NOM.)	
C12	12" CMU (11-5/8" NOM.)	
S2	2" C-H STUD (SHAFT WALL)	

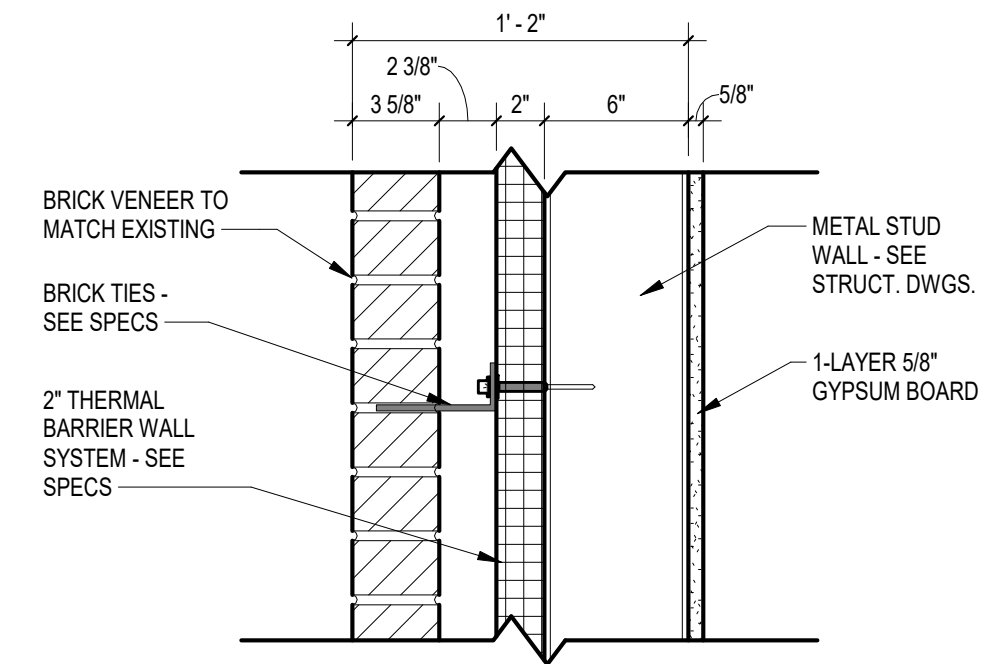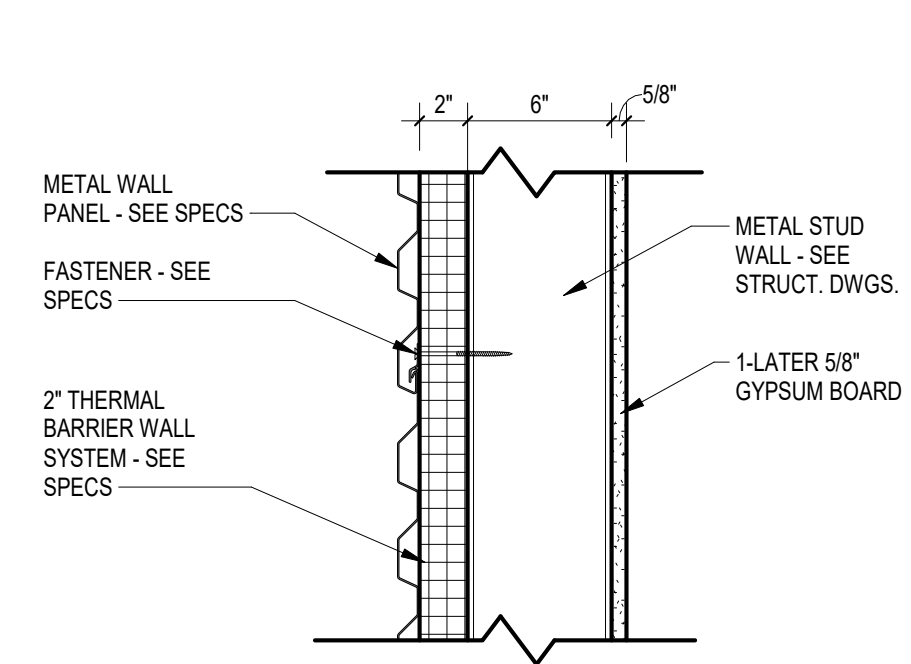

PROJECT TITLE
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431 WILLIAMS STREET
COLUMBIA, SC 29201


NO.	REVISIONS	DATE

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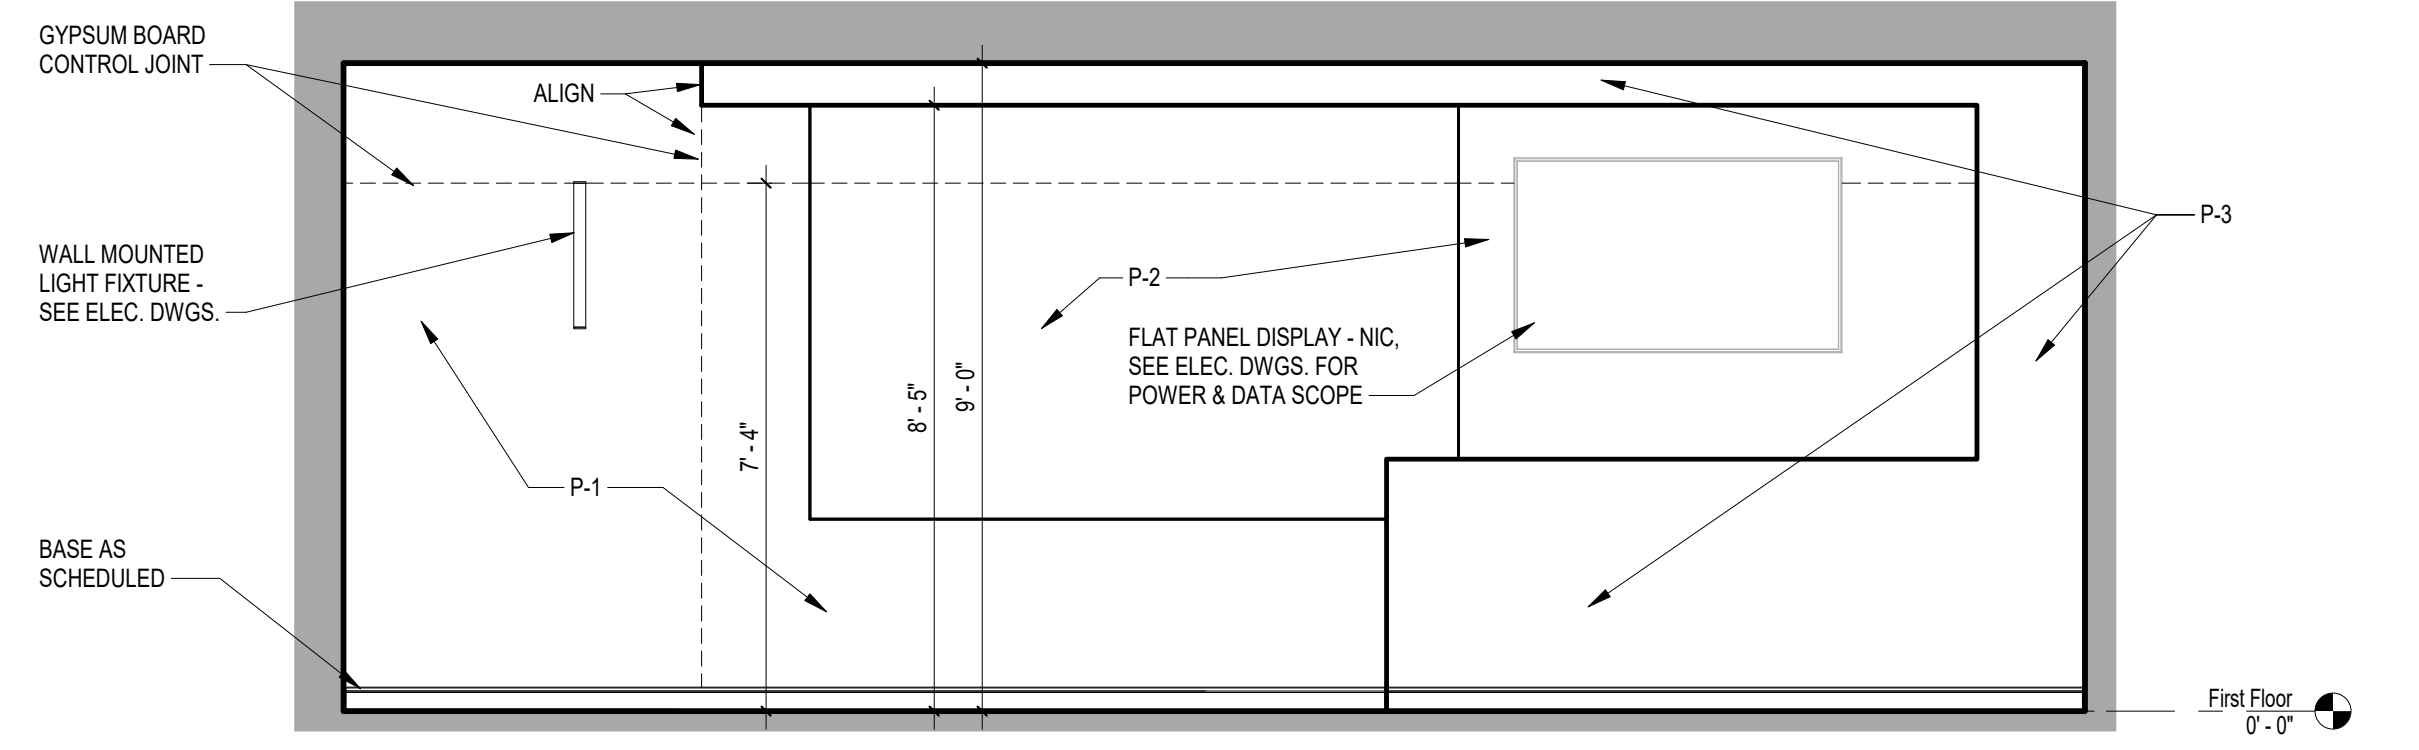
PROJECT NO. 1426.16
DATE 09-21-16
DRAWING NO. **A3.1**

DRAWING TITLE
PARTITION TYPES, EXTERIOR WALL TYPES


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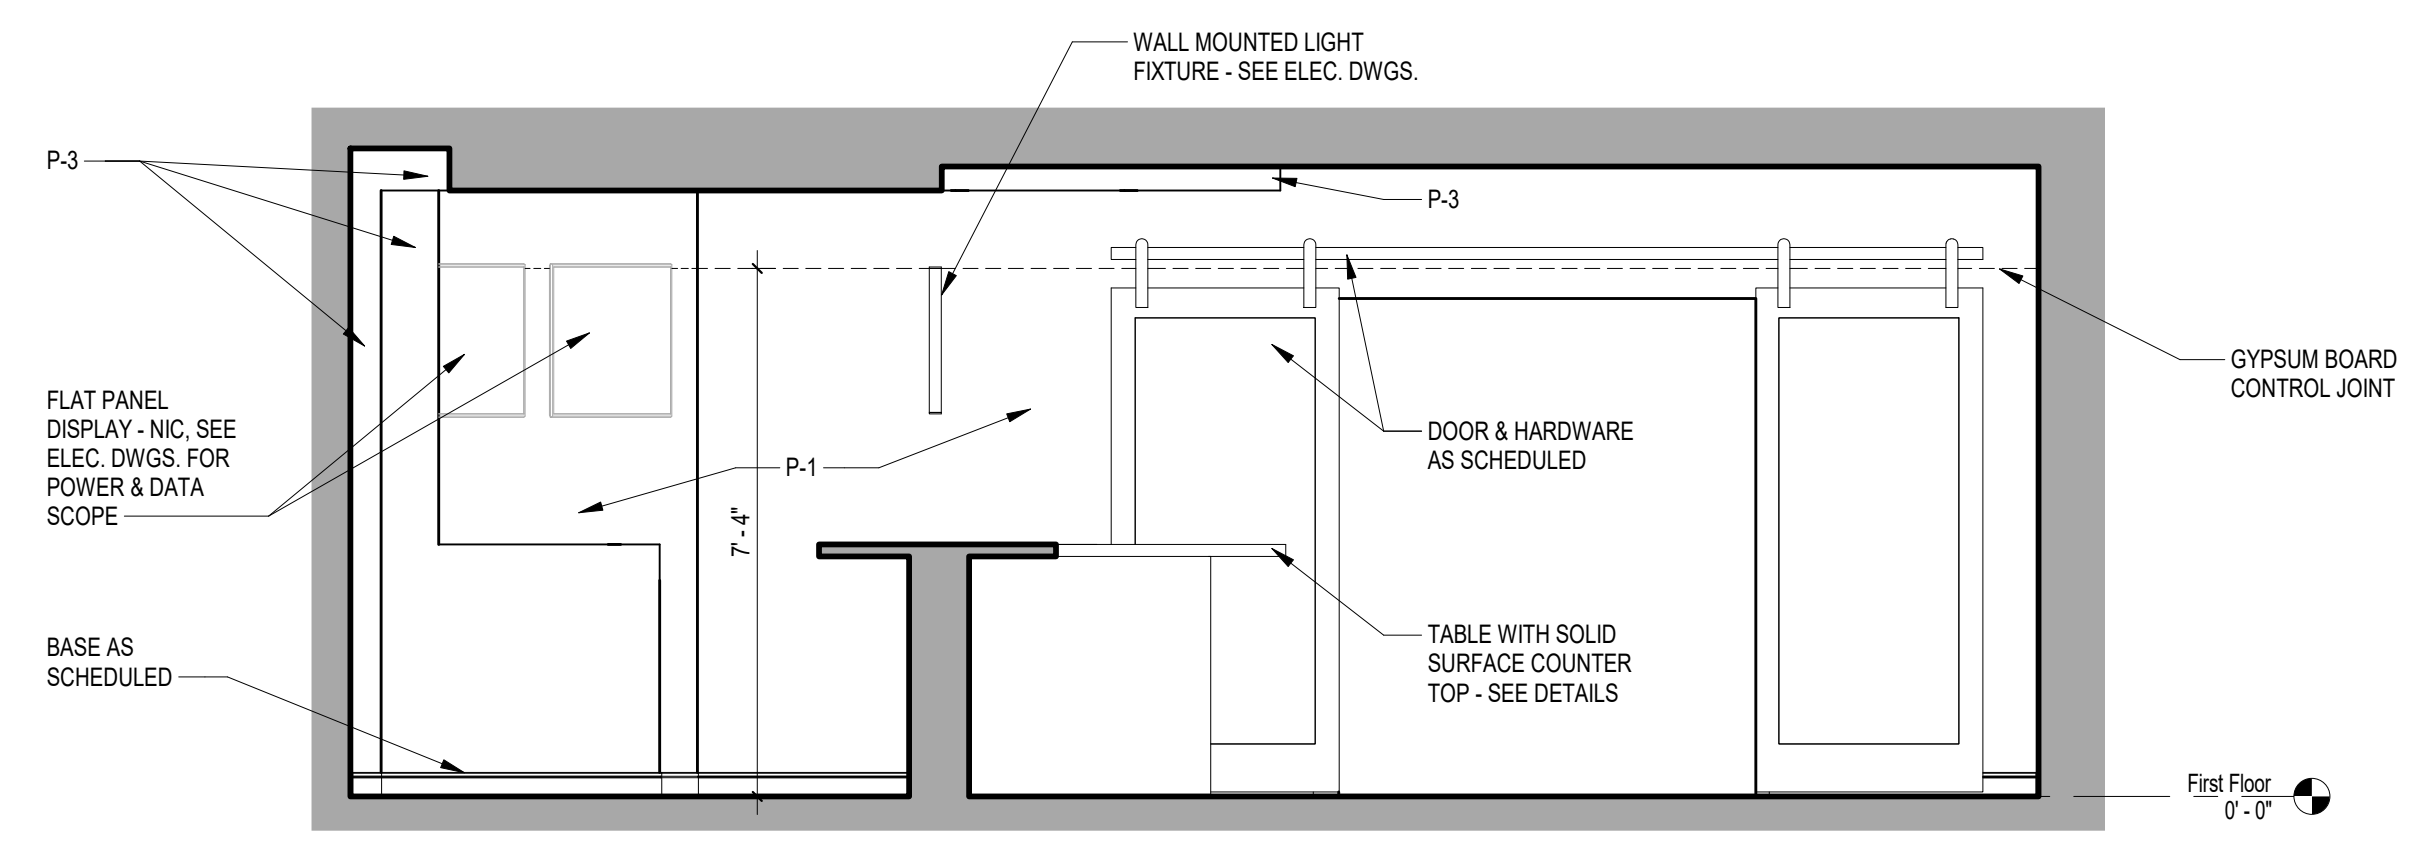
1 INTERIOR ELEVATION - PLAYERS LOUNGE
 A4.1 3/8" = 1'-0" REFERENCED ON A1.1
 SIGNAGE, N.I.C.
 GYPSUM BOARD CONTROL JOINT
 WALL MOUNTED LIGHT FIXTURE - SEE ELEC. DWGS.
 P-1
 BASE AS SCHEDULED
 5'-1"
 4'-0"
 7'-4"
 9'-1"
 8'-5"
 4'-0"
 5'-1 3/8"
 4-3/8"
 P-2
 P-3
 P-1
 FLAT PANEL DISPLAY - N.I.C. - SEE ELEC. DWGS. FOR POWER & DATA SCOPE
 AUDIOVISUAL CABINET AND FLAT PANEL CASWORK SURROUND - SEE SPECS & DETAILS
 METAL WALL PANEL - SEE SPECS & DETAILS
 First Floor 0'-0"

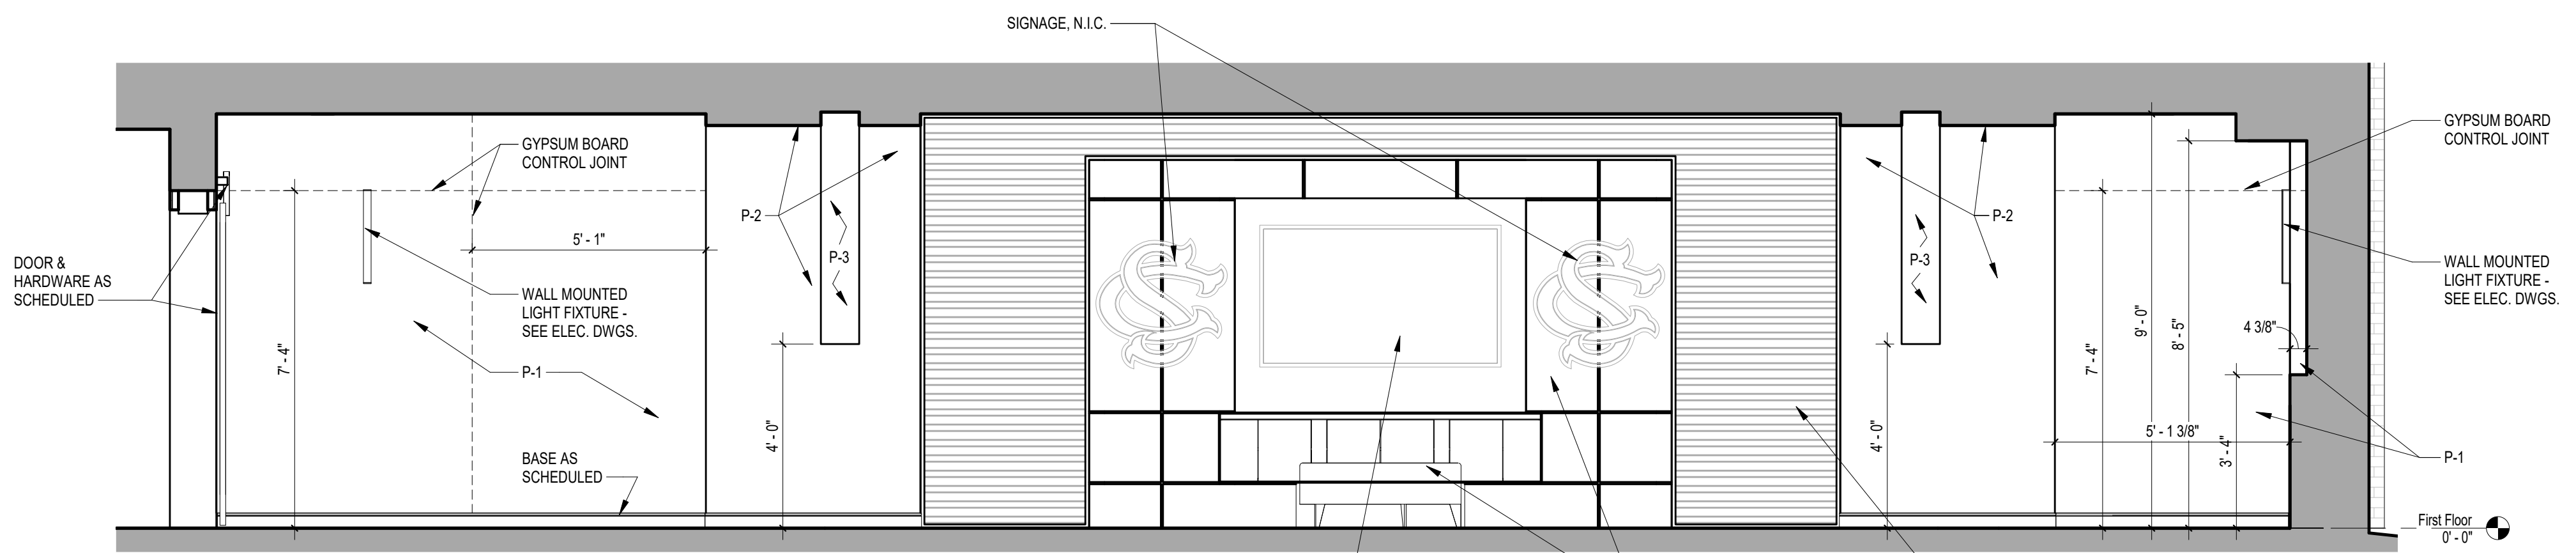

2 INTERIOR ELEVATION - PLAYERS LOUNGE
 A4.1 3/8" = 1'-0" REFERENCED ON A1.1
 GYPSUM BOARD CONTROL JOINT
 ALIGN
 WALL MOUNTED LIGHT FIXTURE - SEE ELEC. DWGS.
 P-1
 P-2
 FLAT PANEL DISPLAY - N.I.C. - SEE ELEC. DWGS. FOR POWER & DATA SCOPE
 P-3
 BASE AS SCHEDULED
 7'-4"
 8'-0"
 9'-1"
 First Floor 0'-0"




3 INTERIOR ELEVATION - PLAYERS LOUNGE
 A4.1 3/8" = 1'-0" REFERENCED ON A1.1
 FLAT PANEL DISPLAY - N.I.C. - SEE ELEC. DWGS. FOR POWER & DATA SCOPE
 P-2
 P-3
 P-1
 GYPSUM BOARD CONTROL JOINT
 WALL MOUNTED LIGHT FIXTURE - SEE ELEC. DWGS.
 P-2
 P-3
 P-4
 P-1
 P-3
 P-1
 P-3
 BASE AS SCHEDULED
 7'-4"
 5'-10"
 5'-10"
 5'-10"
 2'-8"
 2'-8"
 9'-10"
 7'-4"
 TABLE WITH SOLID SURFACE COUNTER TOP - SEE DETAILS
 NEW DOOR IN EXISTING FRAME - SEE PLANS & DETAILS
 FLAT PANEL DISPLAY - N.I.C. - SEE ELEC. DWGS. FOR POWER & DATA SCOPE
 WALL MOUNTED LIGHT FIXTURE - SEE ELEC. DWGS.
 P-1
 P-3
 First Floor 0'-0"

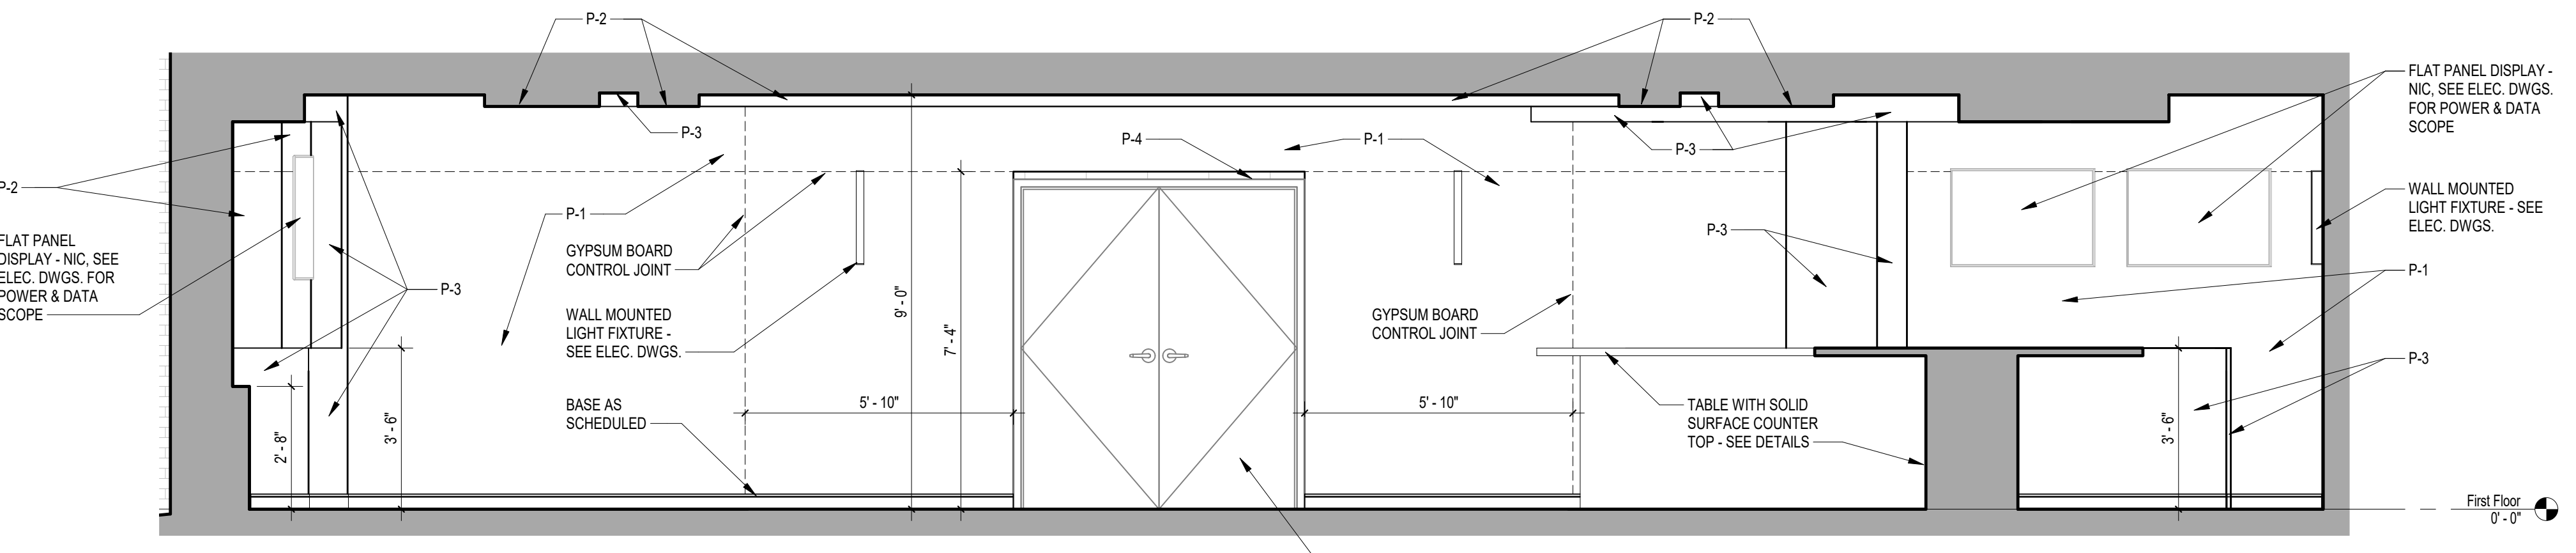


4 INTERIOR ELEVATION - PLAYERS LOUNGE
 A4.1 3/8" = 1'-0" REFERENCED ON A1.1
 WALL MOUNTED LIGHT FIXTURE - SEE ELEC. DWGS.
 P-3
 P-3
 P-1
 P-3
 GYPSUM BOARD CONTROL JOINT
 DOOR & HARDWARE AS SCHEDULED
 TABLE WITH SOLID SURFACE COUNTER TOP - SEE DETAILS
 P-1
 P-3
 BASE AS SCHEDULED
 7'-4"
 First Floor 0'-0"

GENERAL NOTES - INTERIOR ELEVATIONS


- P-1, P-2, P-3 ARE WALL & CEILING PAINT DESIGNATIONS. SEE SCHEDULES INTERIOR FINISHES ON A4.1 FOR COLOR DESIGNATIONS
- G.C. TO INITIATE A PAINTING COORDINATION MEETING WITH PAINTING SUBCONTRACTOR AND ARCHITECT AFTER WALLS HAVE BEEN PRIMED AND PRIOR TO FIRST PAINT COAT TO CONFIRM COLOR LOCATIONS

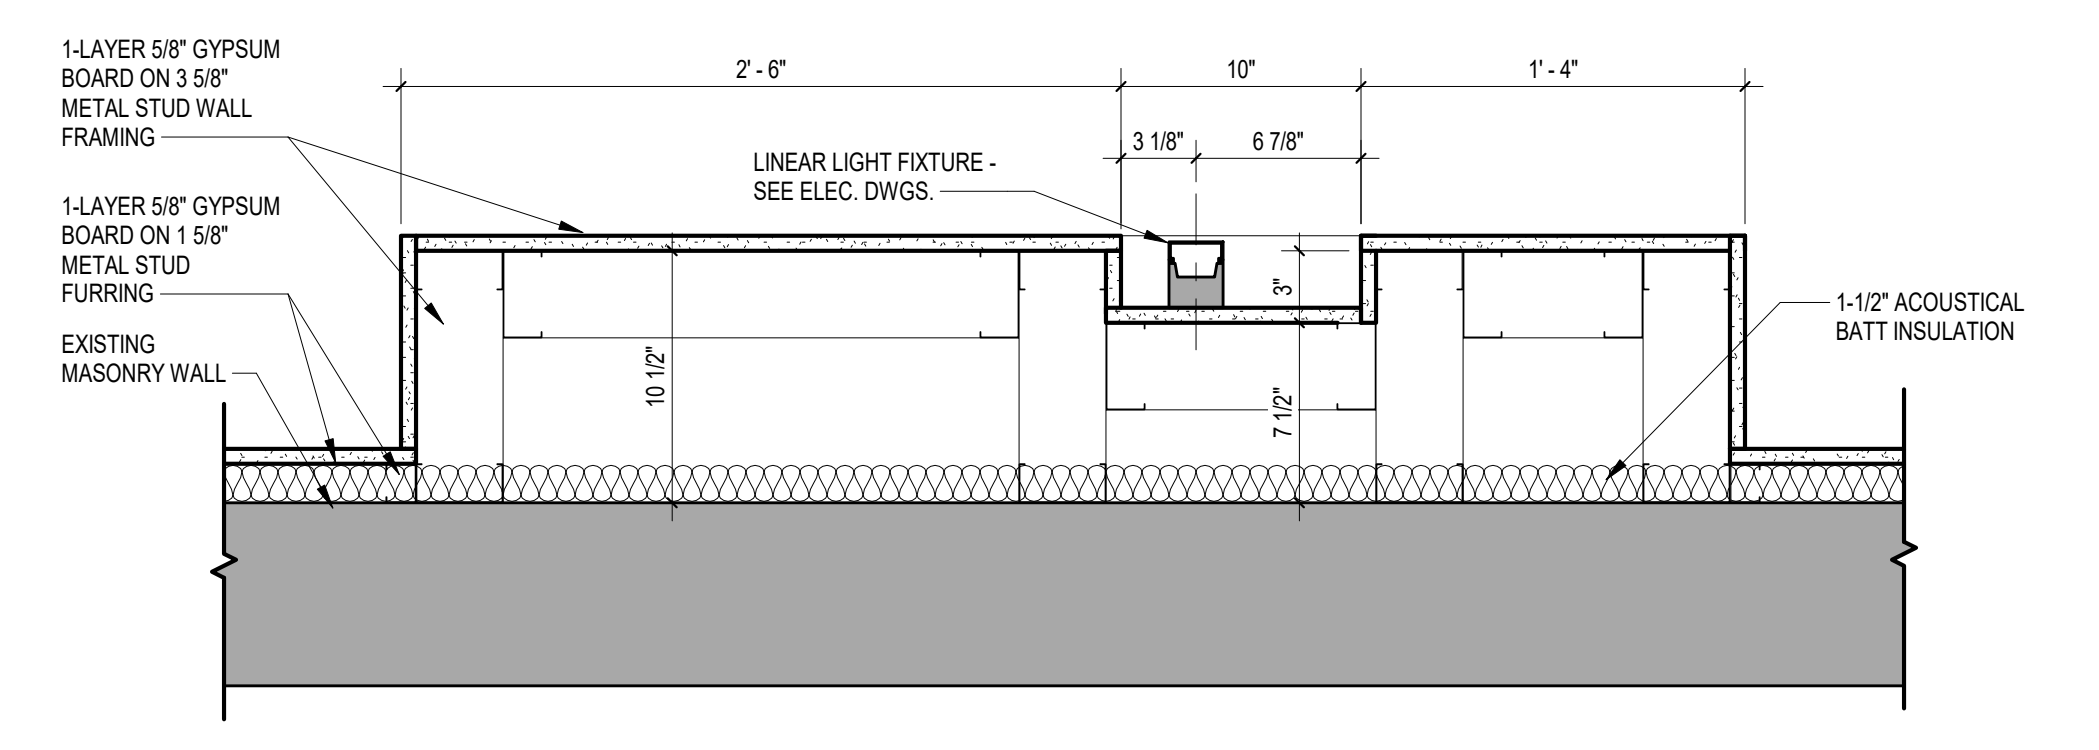


5 PLAN DETAIL
 A4.1 1 1/2" = 1'-0" REFERENCED ON A1.1
 1-LAYER 5/8" GYPSUM BOARD ON 3 5/8" METAL STUD WALL FRAMING
 1-LAYER 5/8" GYPSUM BOARD ON 1 5/8" METAL STUD FURRING
 EXISTING MASONRY WALL
 2'-6"
 10"
 1'-4"
 LINEAR LIGHT FIXTURE - SEE ELEC. DWGS.
 3 1/8"
 6 7/8"
 1-1/2" ACOUSTICAL BATT INSULATION
 10 1/2"
 7 1/2"
 8'-0"
 5'-4"

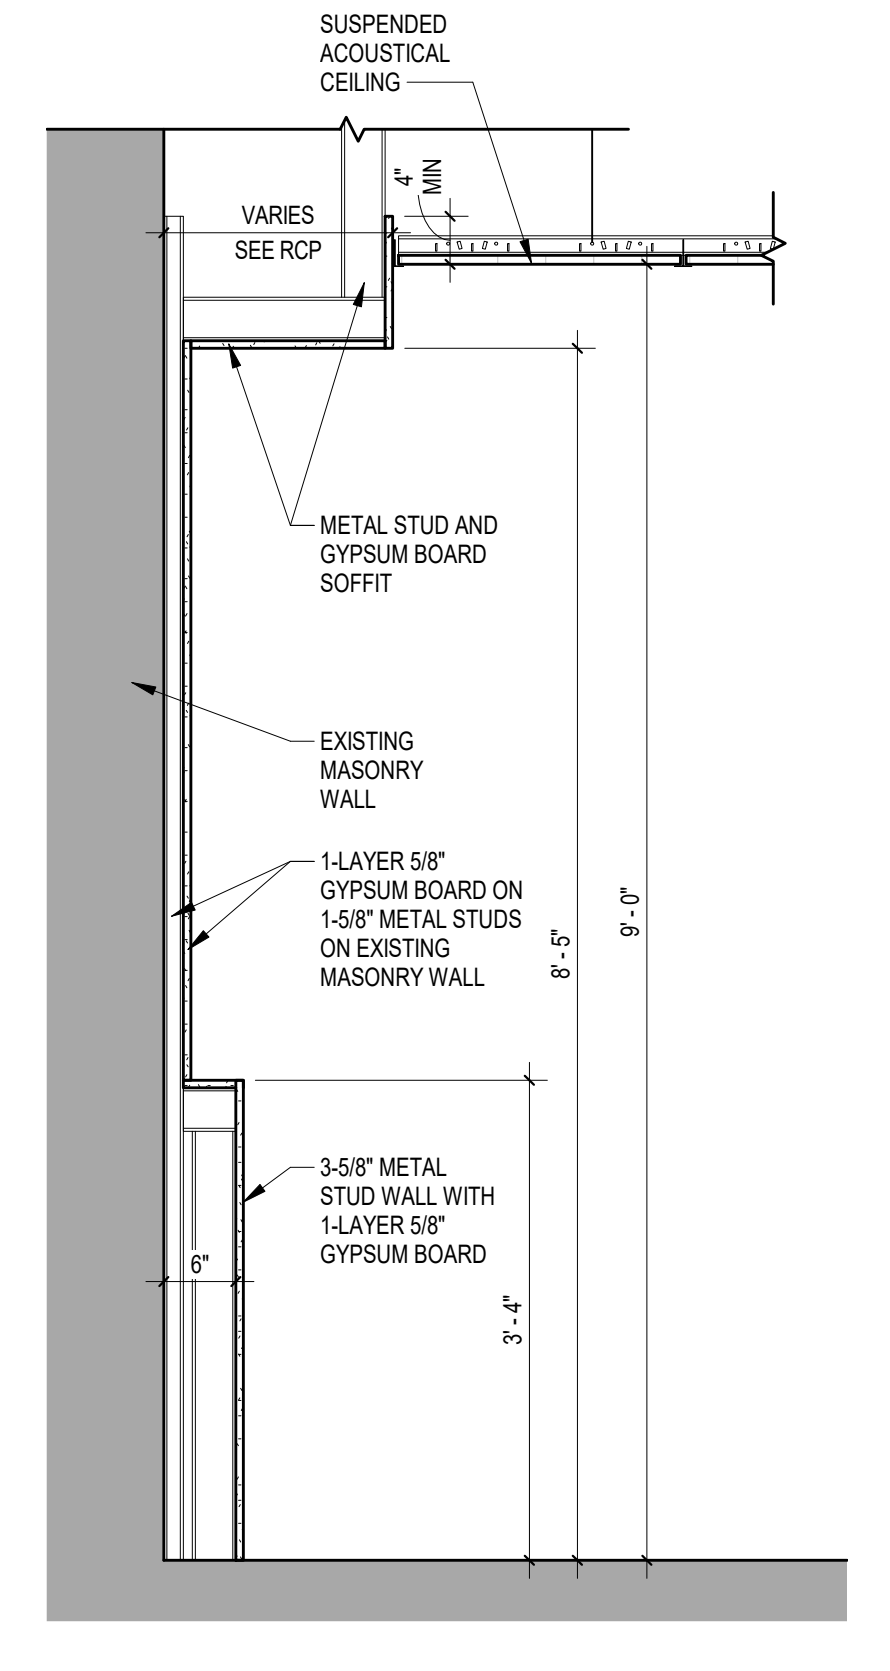

6 INTERIOR WALL SECTION
 A4.1 3/4" = 1'-0" REFERENCED ON A1.1
 SUSPENDED ACOUSTICAL CEILING
 VARIES SEE RCP
 4" MIN
 METAL STUD AND GYPSUM BOARD SOFFIT
 EXISTING MASONRY WALL
 1-LAYER 5/8" GYPSUM BOARD ON 1 5/8" METAL STUDS ON EXISTING MASONRY WALL
 8'-5"
 9'-0"
 3-5/8" METAL STUD WALL WITH 1-LAYER 5/8" GYPSUM BOARD
 5'-4"

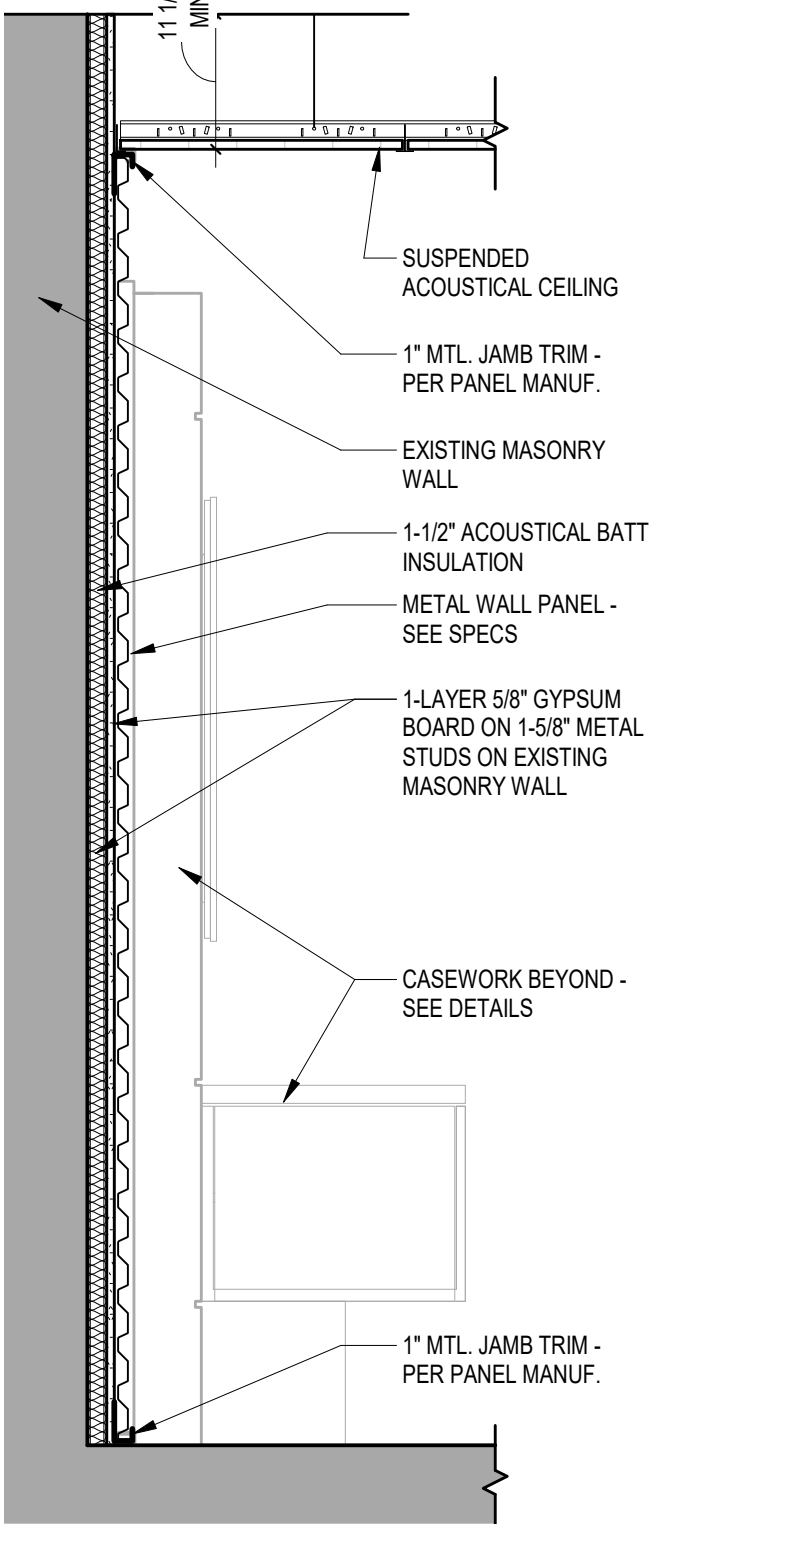

7 INTERIOR WALL SECTION
 A4.1 3/4" = 1'-0" REFERENCED ON A1.1
 SUSPENDED ACOUSTICAL CEILING
 11 1/4" MIN
 1" MITL. JAMB TRIM - PER PANEL MANUF.
 EXISTING MASONRY WALL
 1-1/2" ACOUSTICAL BATT INSULATION
 METAL WALL PANEL - SEE SPECS
 1-LAYER 5/8" GYPSUM BOARD ON 1 5/8" METAL STUDS ON EXISTING MASONRY WALL
 CASEWORK BEYOND - SEE DETAILS
 1" MITL. JAMB TRIM - PER PANEL MANUF.

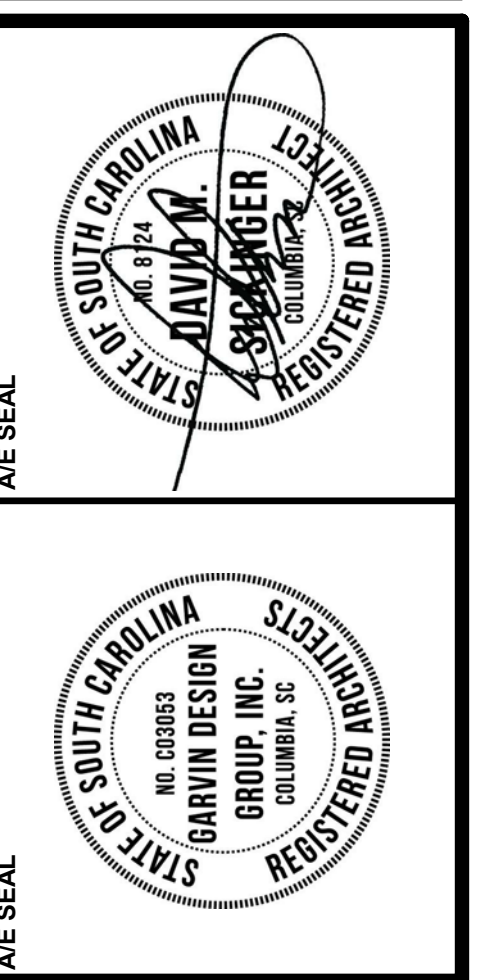



PROJECT TITLE
**UNIVERSITY OF SOUTH CAROLINA
 FOUNDERS PARK PLAYERS LOUNGE
 AND MEDIA ROOM ADDITION**
 431 WILLIAMS STREET
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DRAWING TITLE
**INTERIOR ELEVATIONS, PARTITION
 SECTIONS, DETAILS - LOUNGE**

PROJECT NO.	DATE	DRAWING NO.
1426.16	09.21.16	A4.1



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 FOUNDERS PARK PLAYER'S LOUNGE
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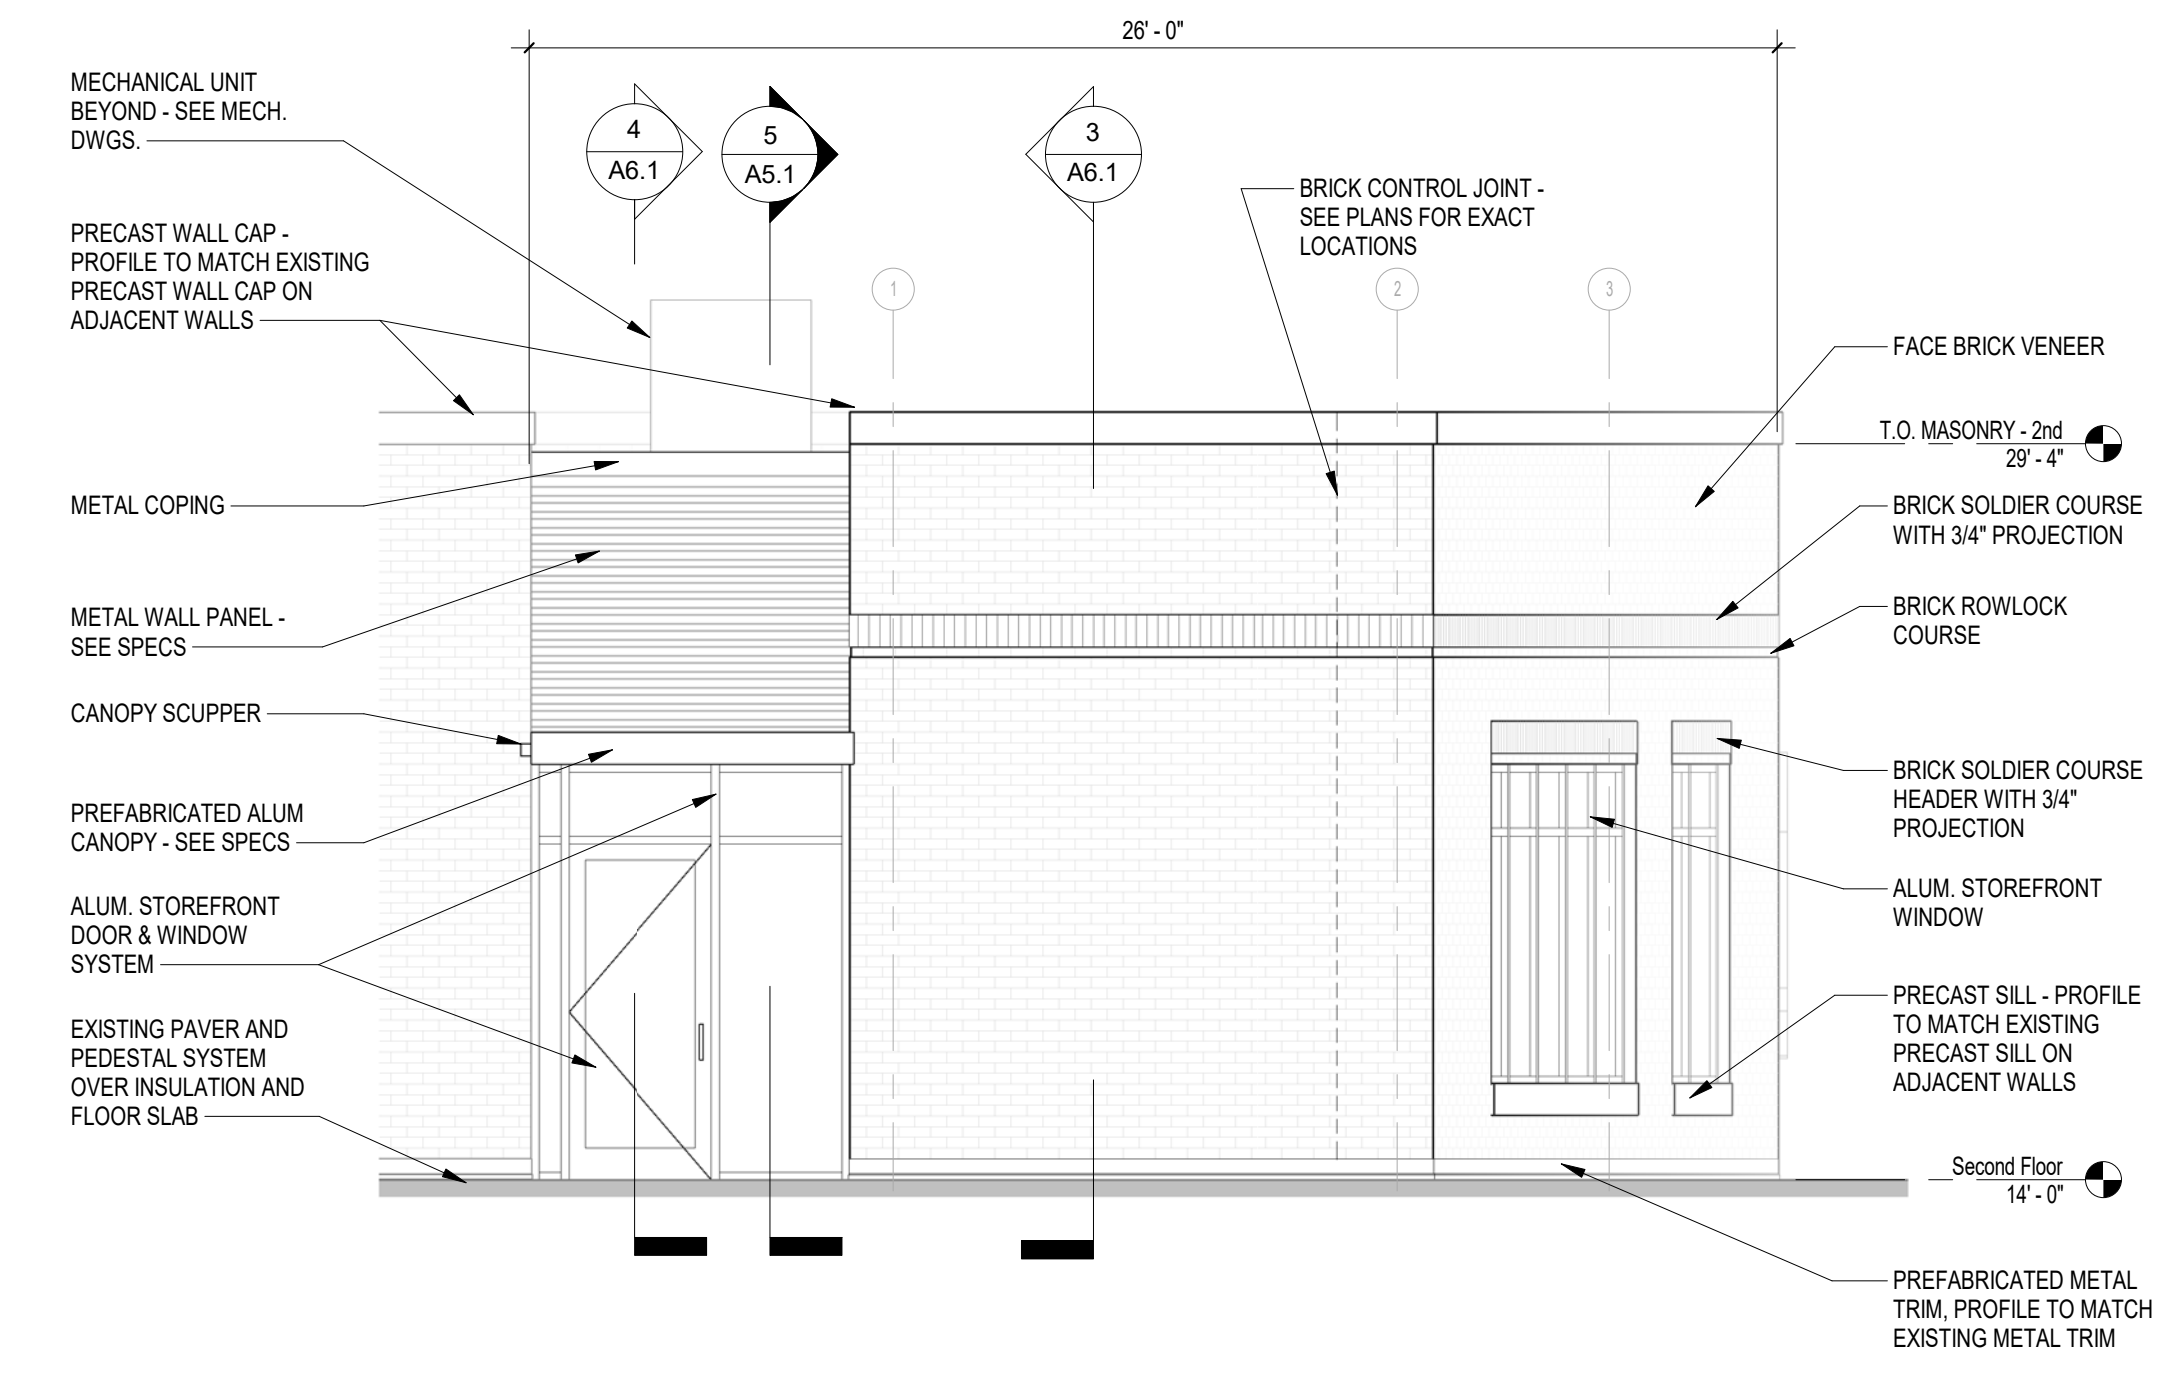
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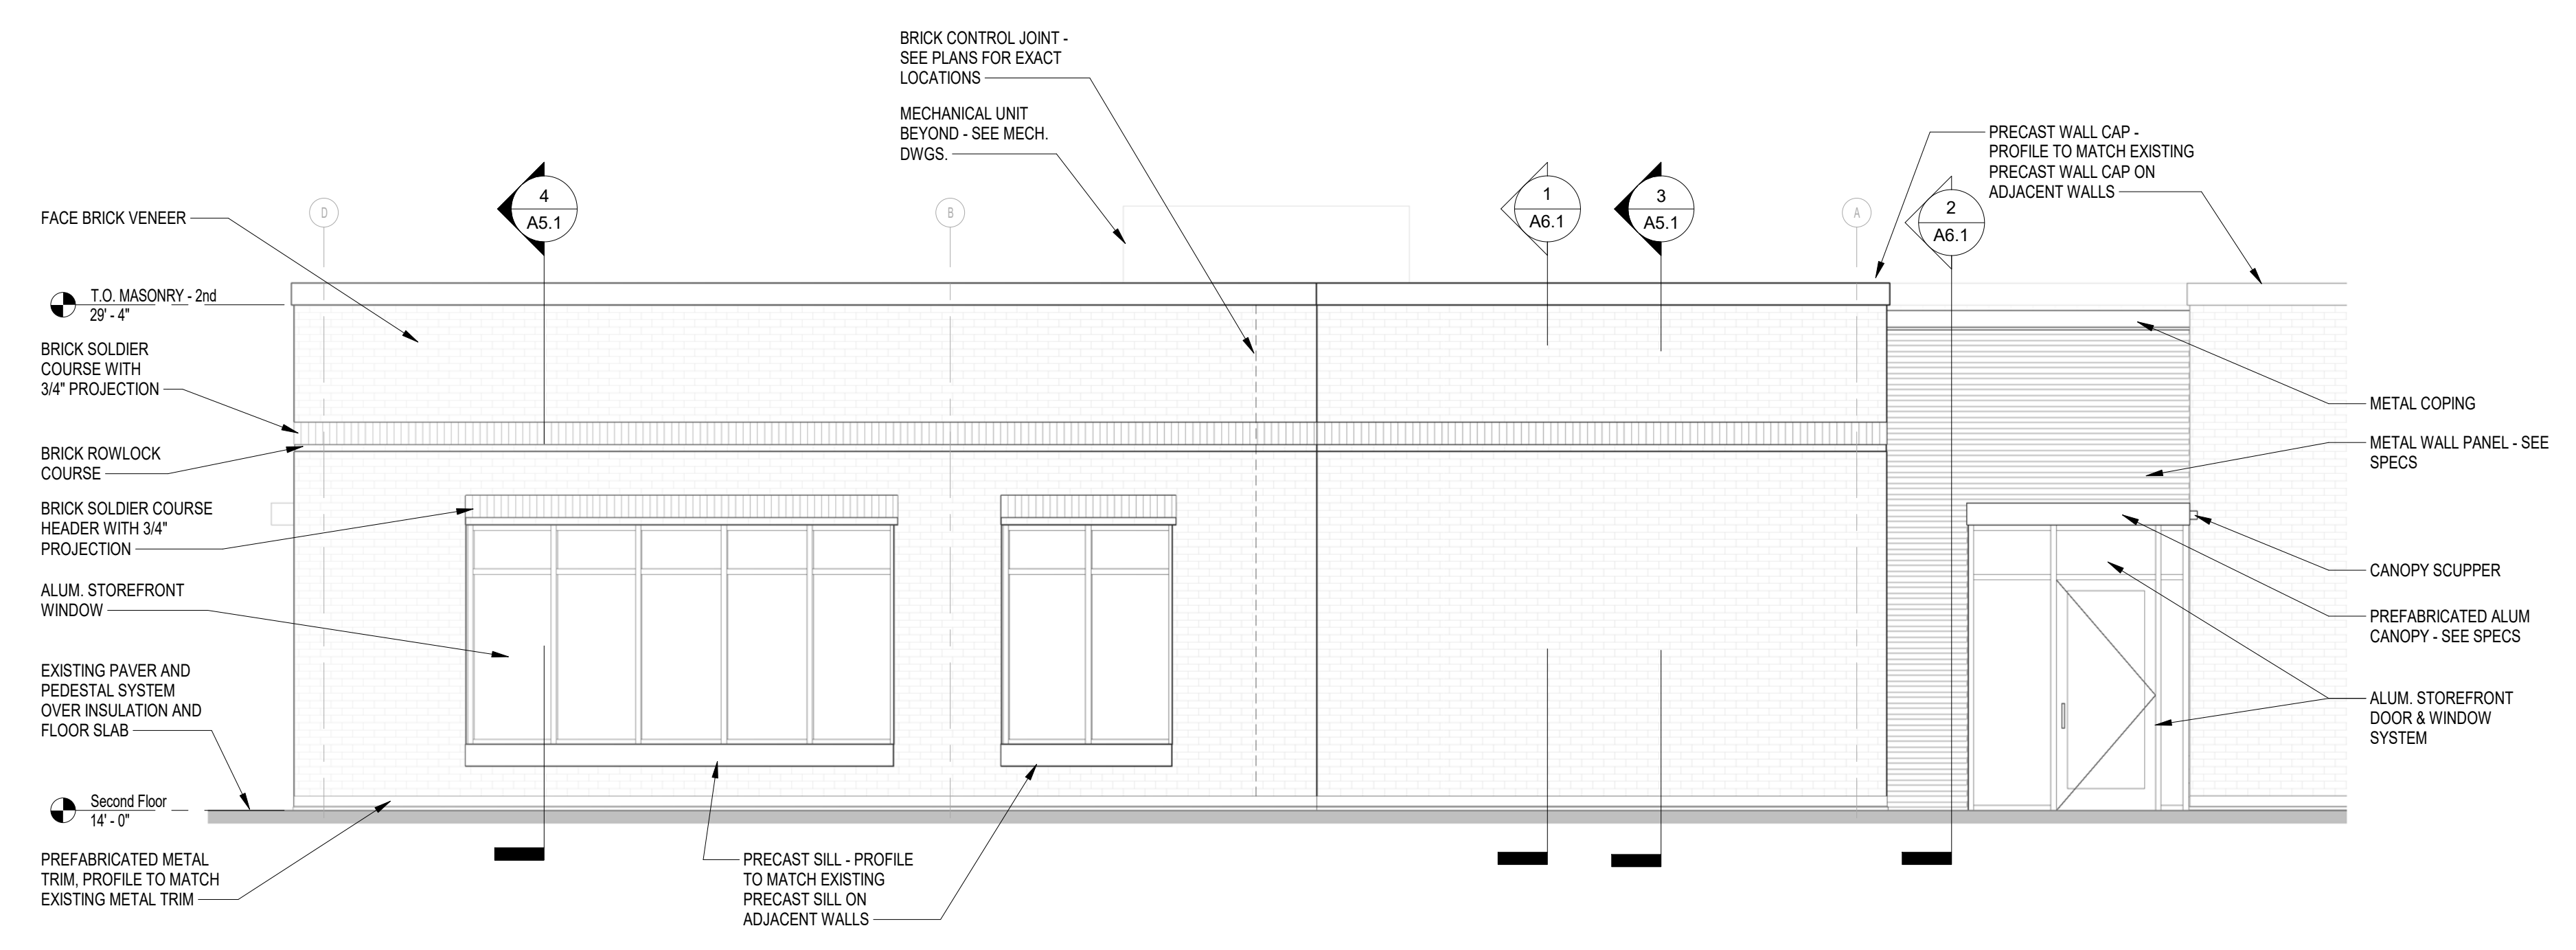
**BUILDING ELEVATIONS, INTERIOR
 ELEVATIONS - MEDIA ROOM**

PROJECT NO. 1426.16
 DATE 09.21.16
 DRAWING NO. **A4.2**

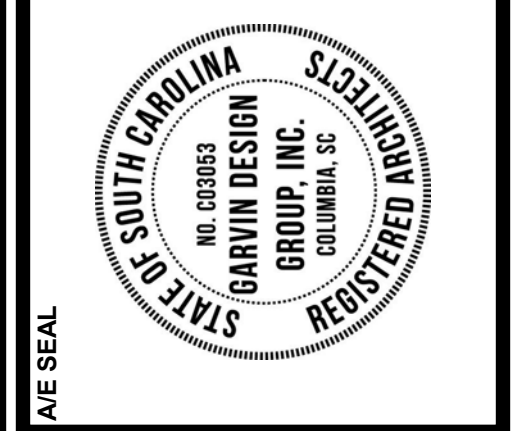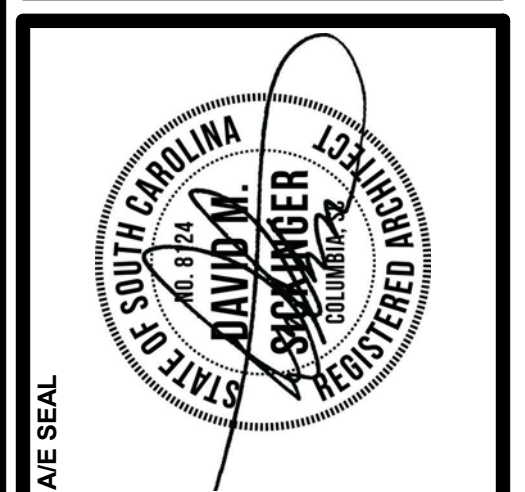
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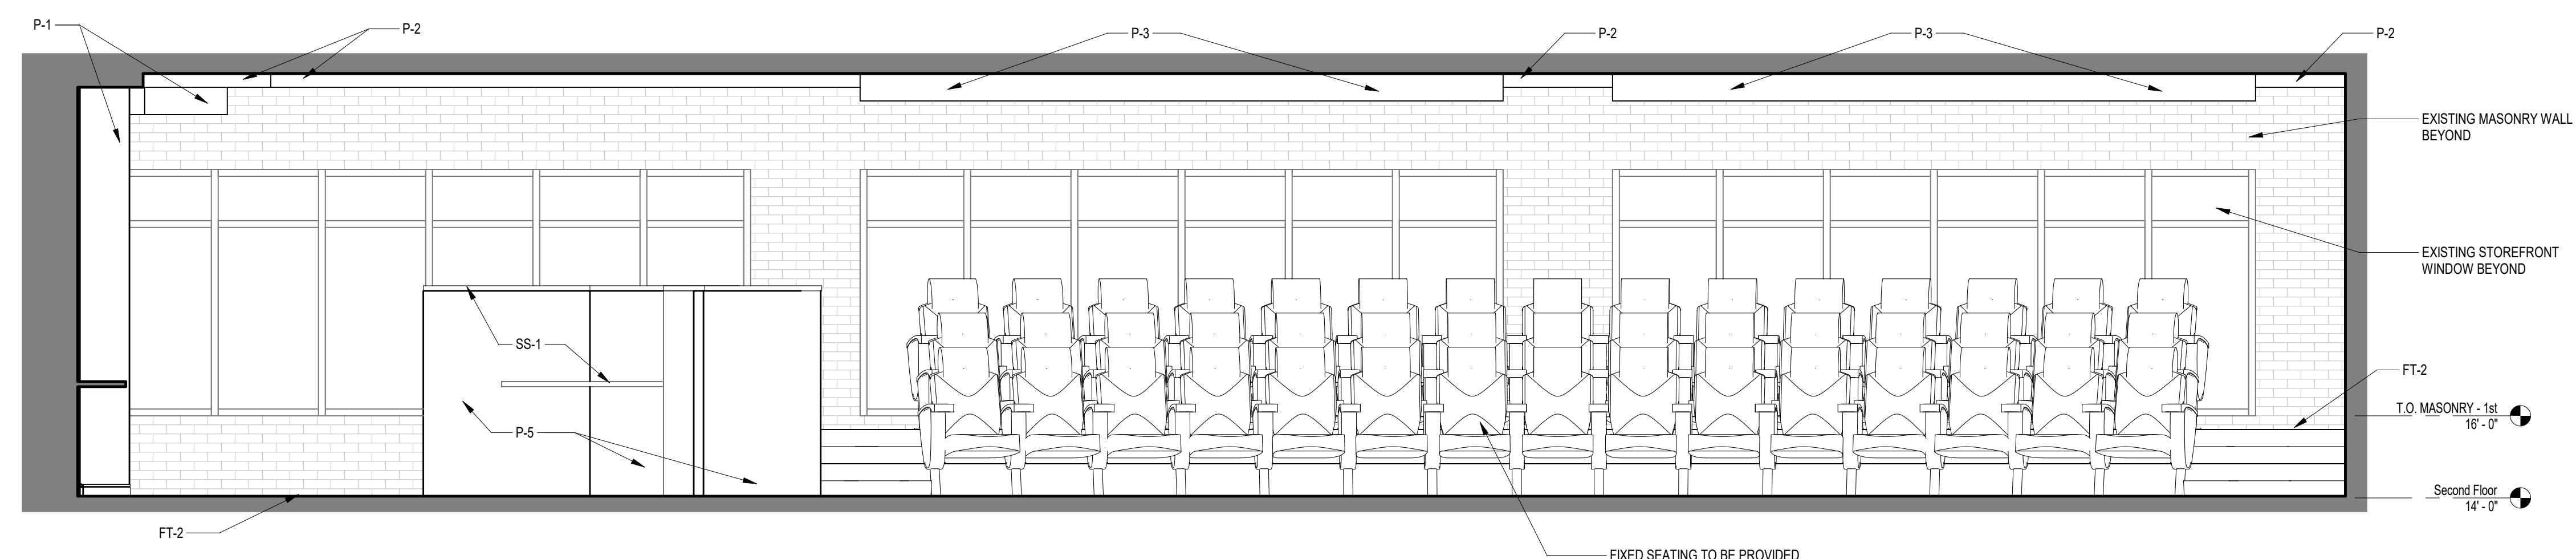
2 BUILDING ELEVATION
 A4.2 1/4" = 1'-0"
 REFERENCED ON A1.2




1 BUILDING ELEVATION
 A4.2 1/4" = 1'-0"
 REFERENCED ON A1.2




5 INTERIOR ELEVATION - MEDIA ROOM
 A4.2 3/8" = 1'-0"
 REFERENCED ON A1.2

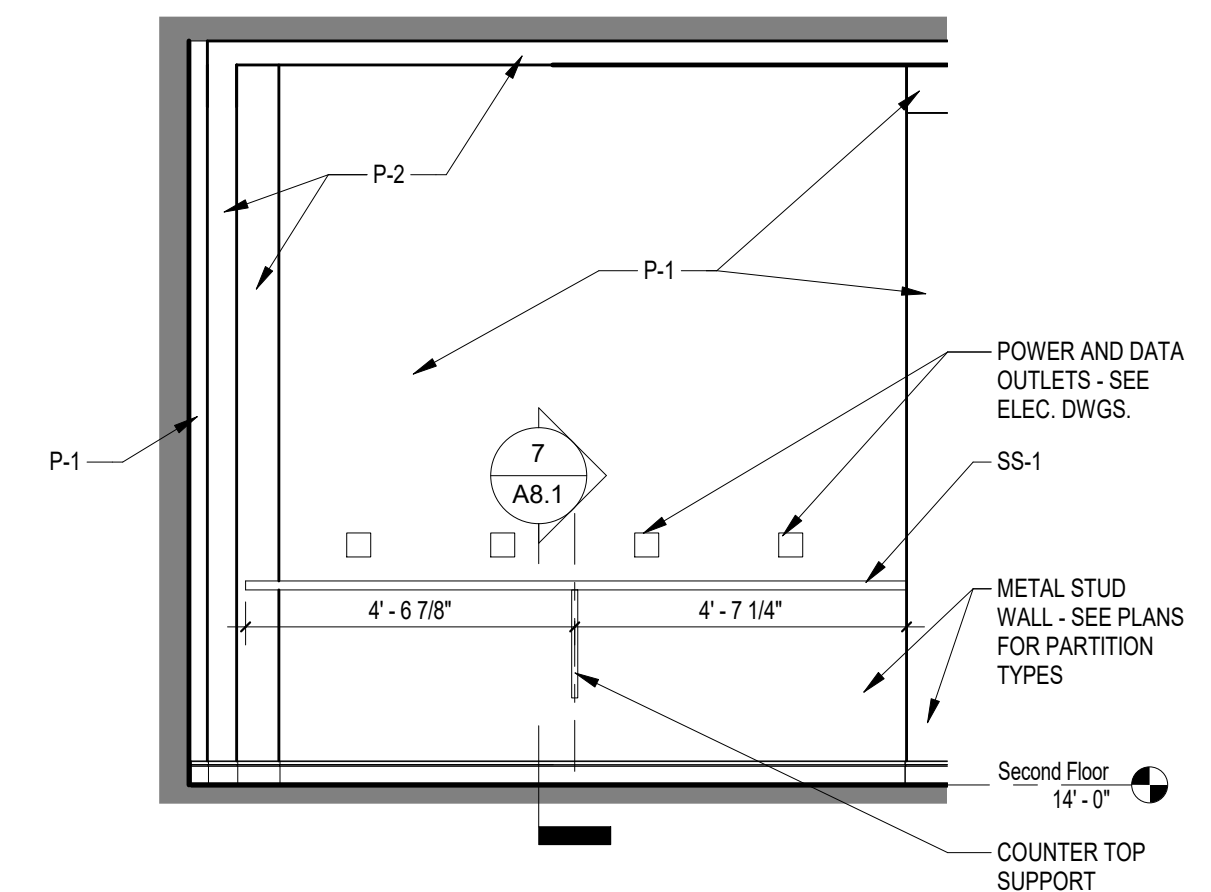


6 INTERIOR ELEVATION - MEDIA ROOM
 A4.2 3/8" = 1'-0"
 REFERENCED ON A1.2

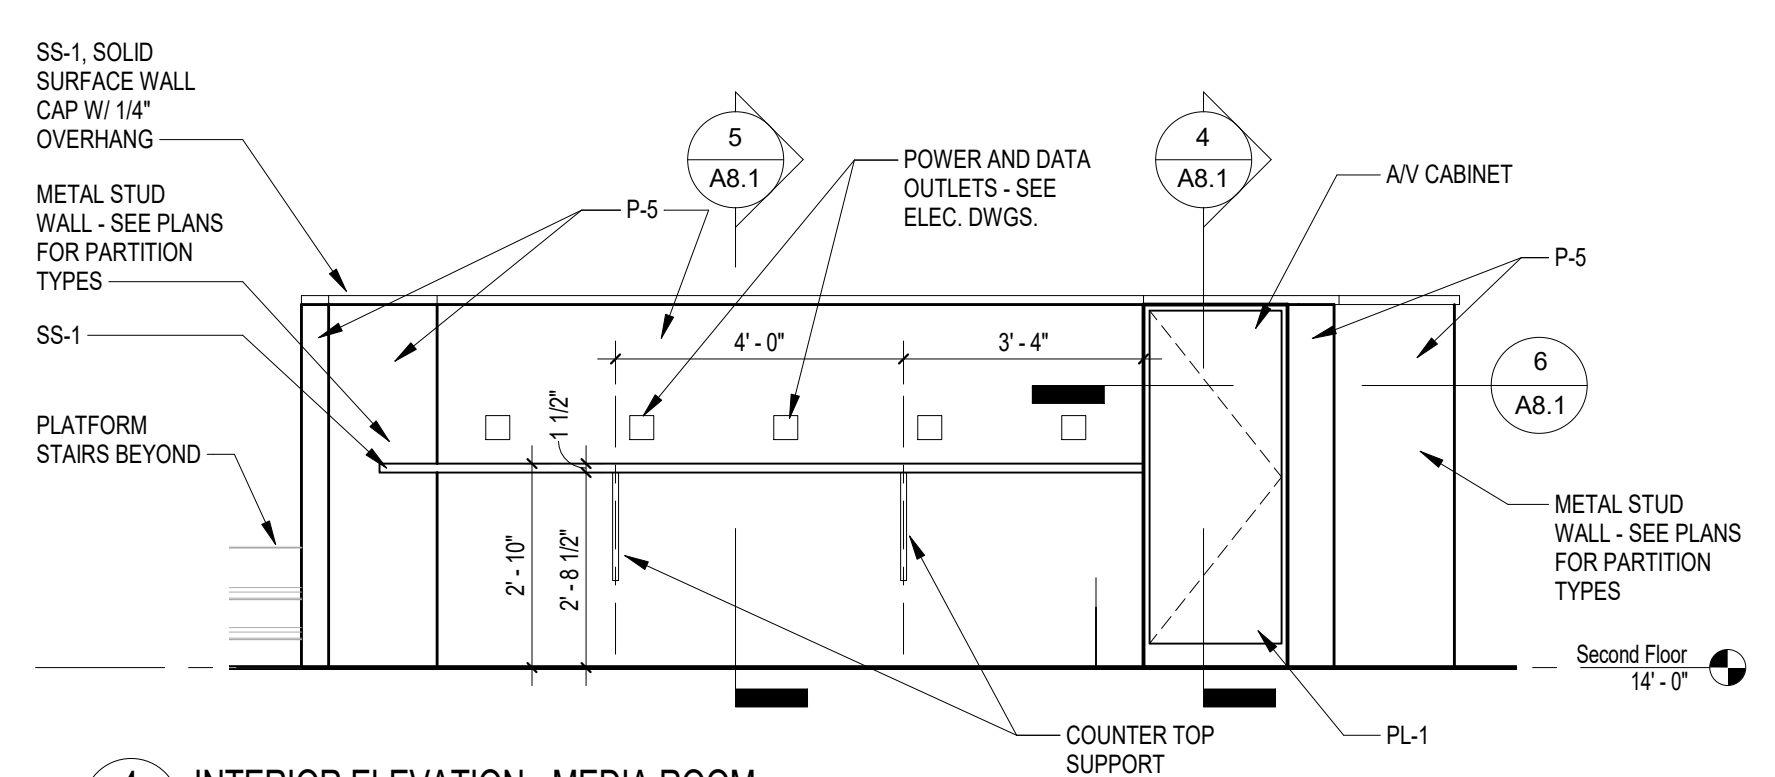

4 INTERIOR ELEVATION - MEDIA ROOM
 A4.2 3/8" = 1'-0"
 REFERENCED ON A1.2

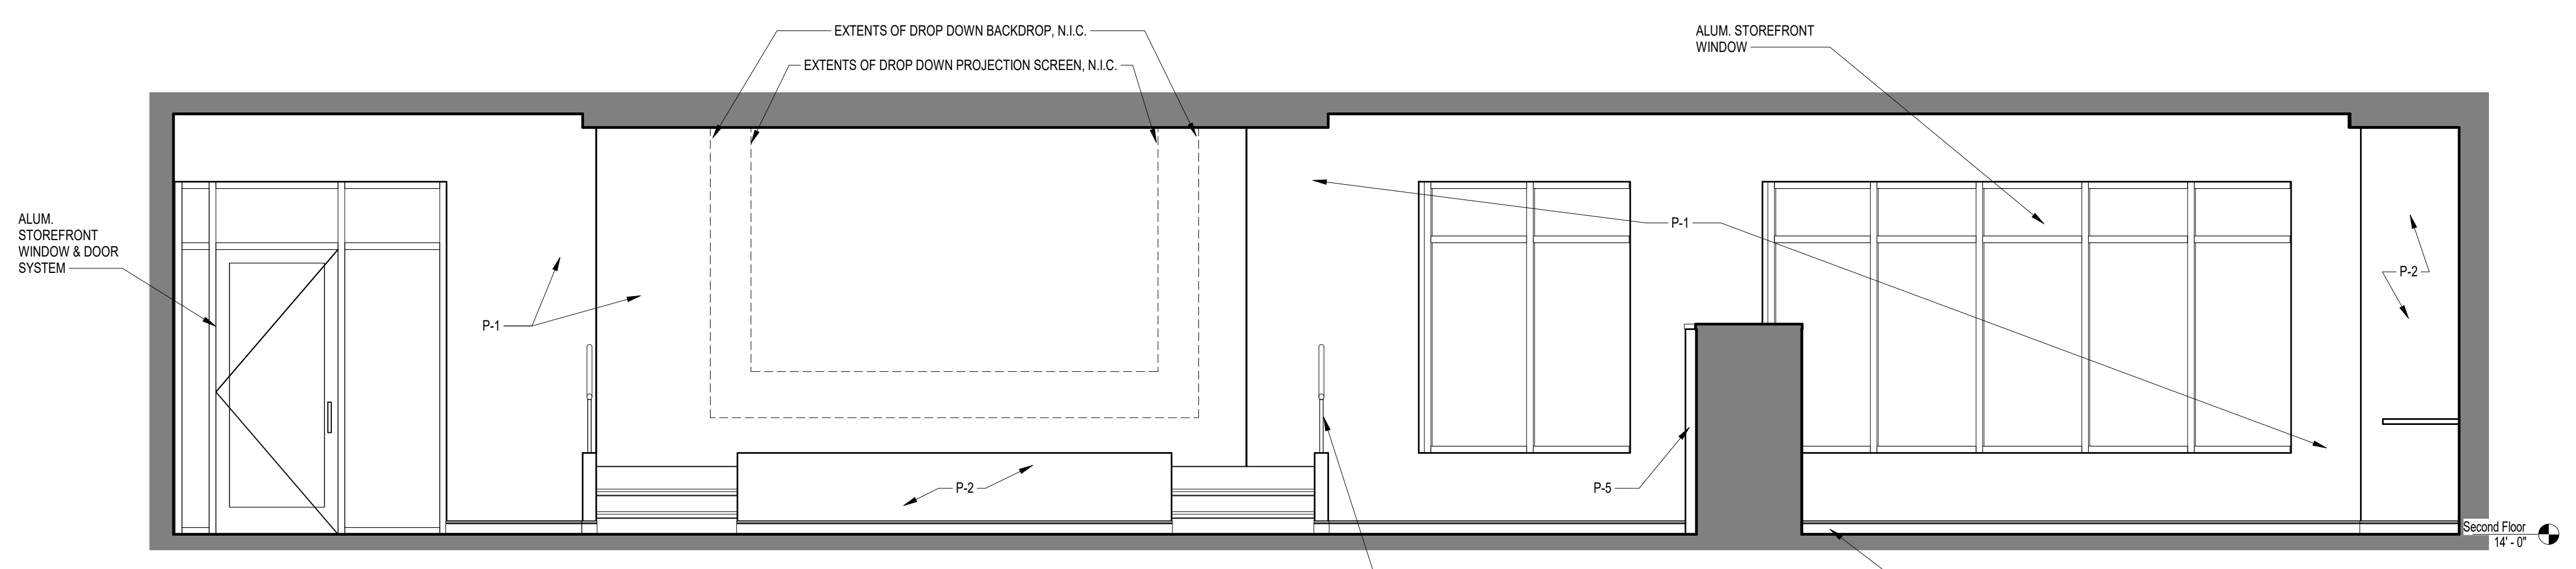

3 INTERIOR ELEVATION - MEDIA ROOM
 A4.2 3/8" = 1'-0"
 REFERENCED ON A1.2

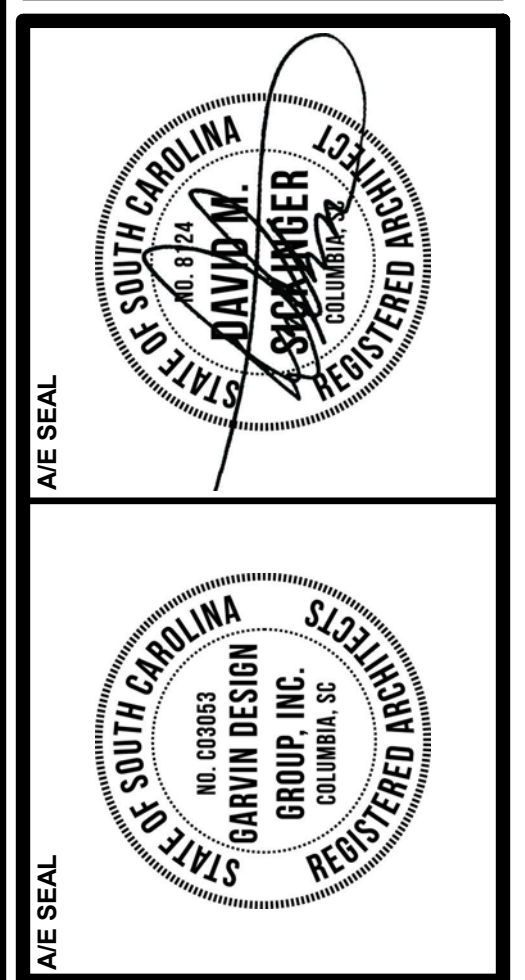


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NO.	REVISIONS	DATE


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BUILDING SECTIONS


PROJECT NO. 1426.16
 DATE 09.21.16
 DRAWING NO. **A5.1**




1 SECTION - PLAYERS LOUNGE
 A5.1 1/4" = 1'-0"
 REFERENCED: A1.1
 OK

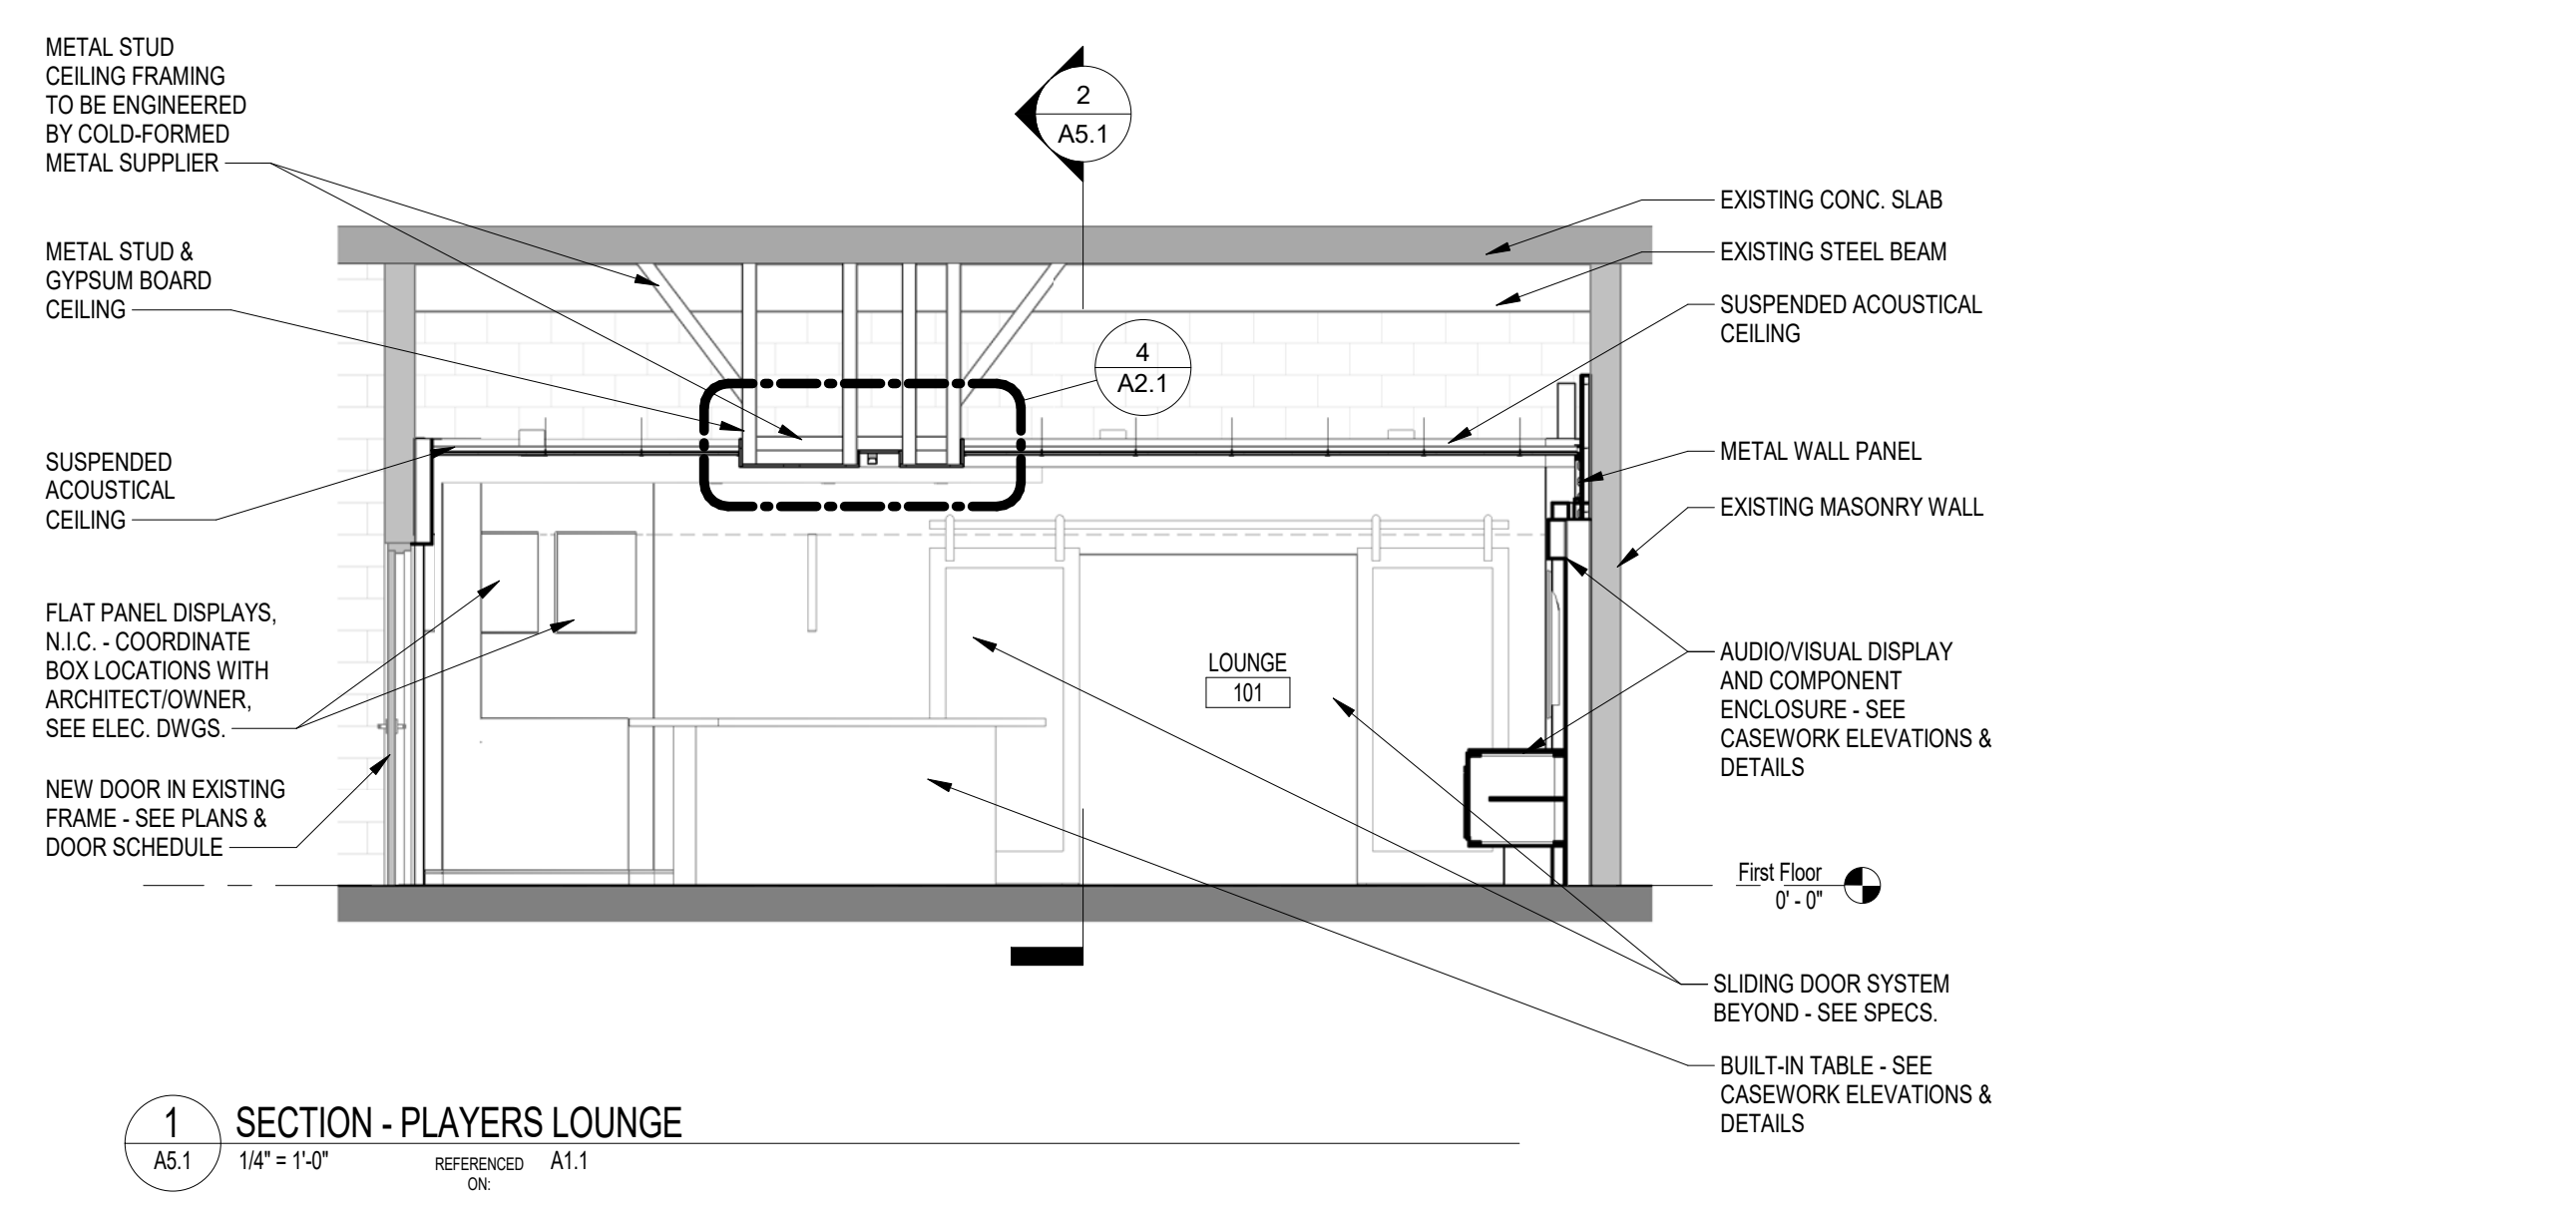

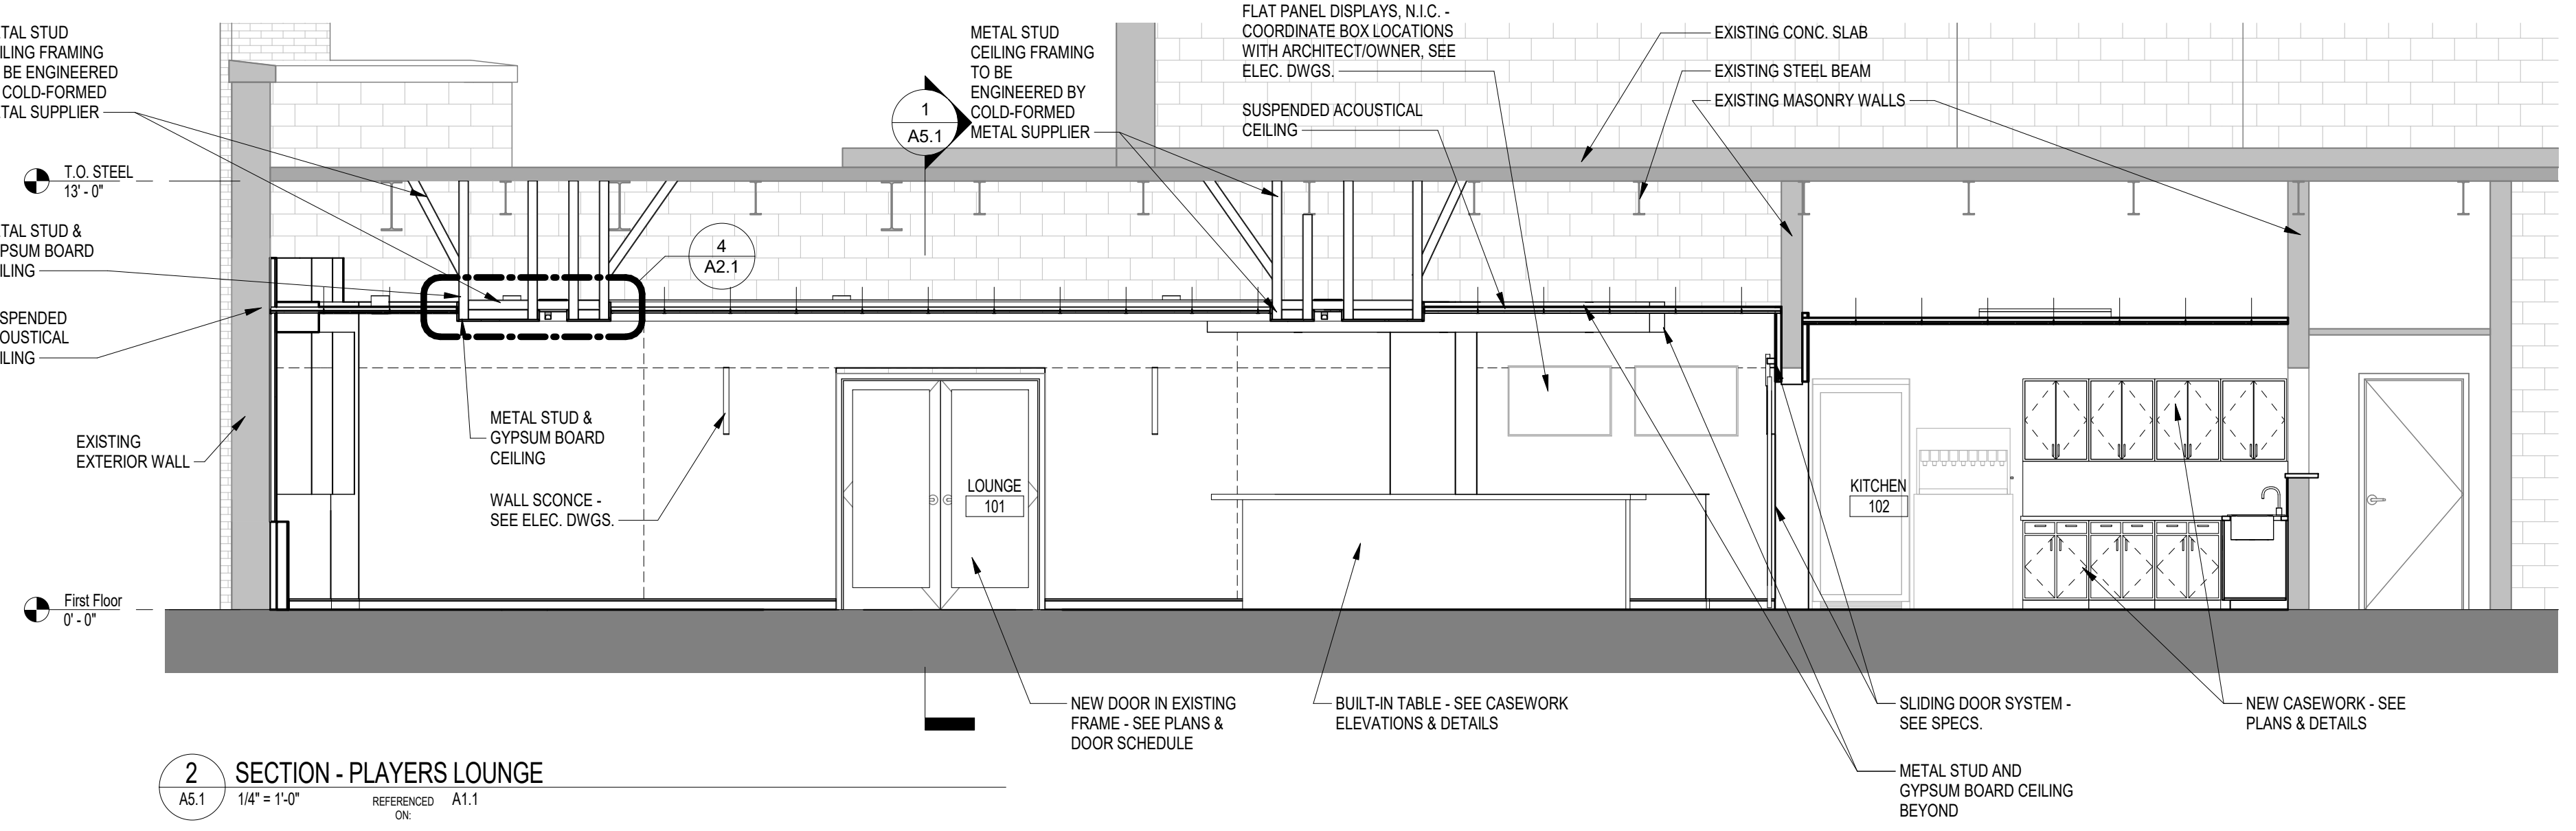
2 SECTION - PLAYERS LOUNGE
 A5.1 1/4" = 1'-0"
 REFERENCED: A1.1
 OK

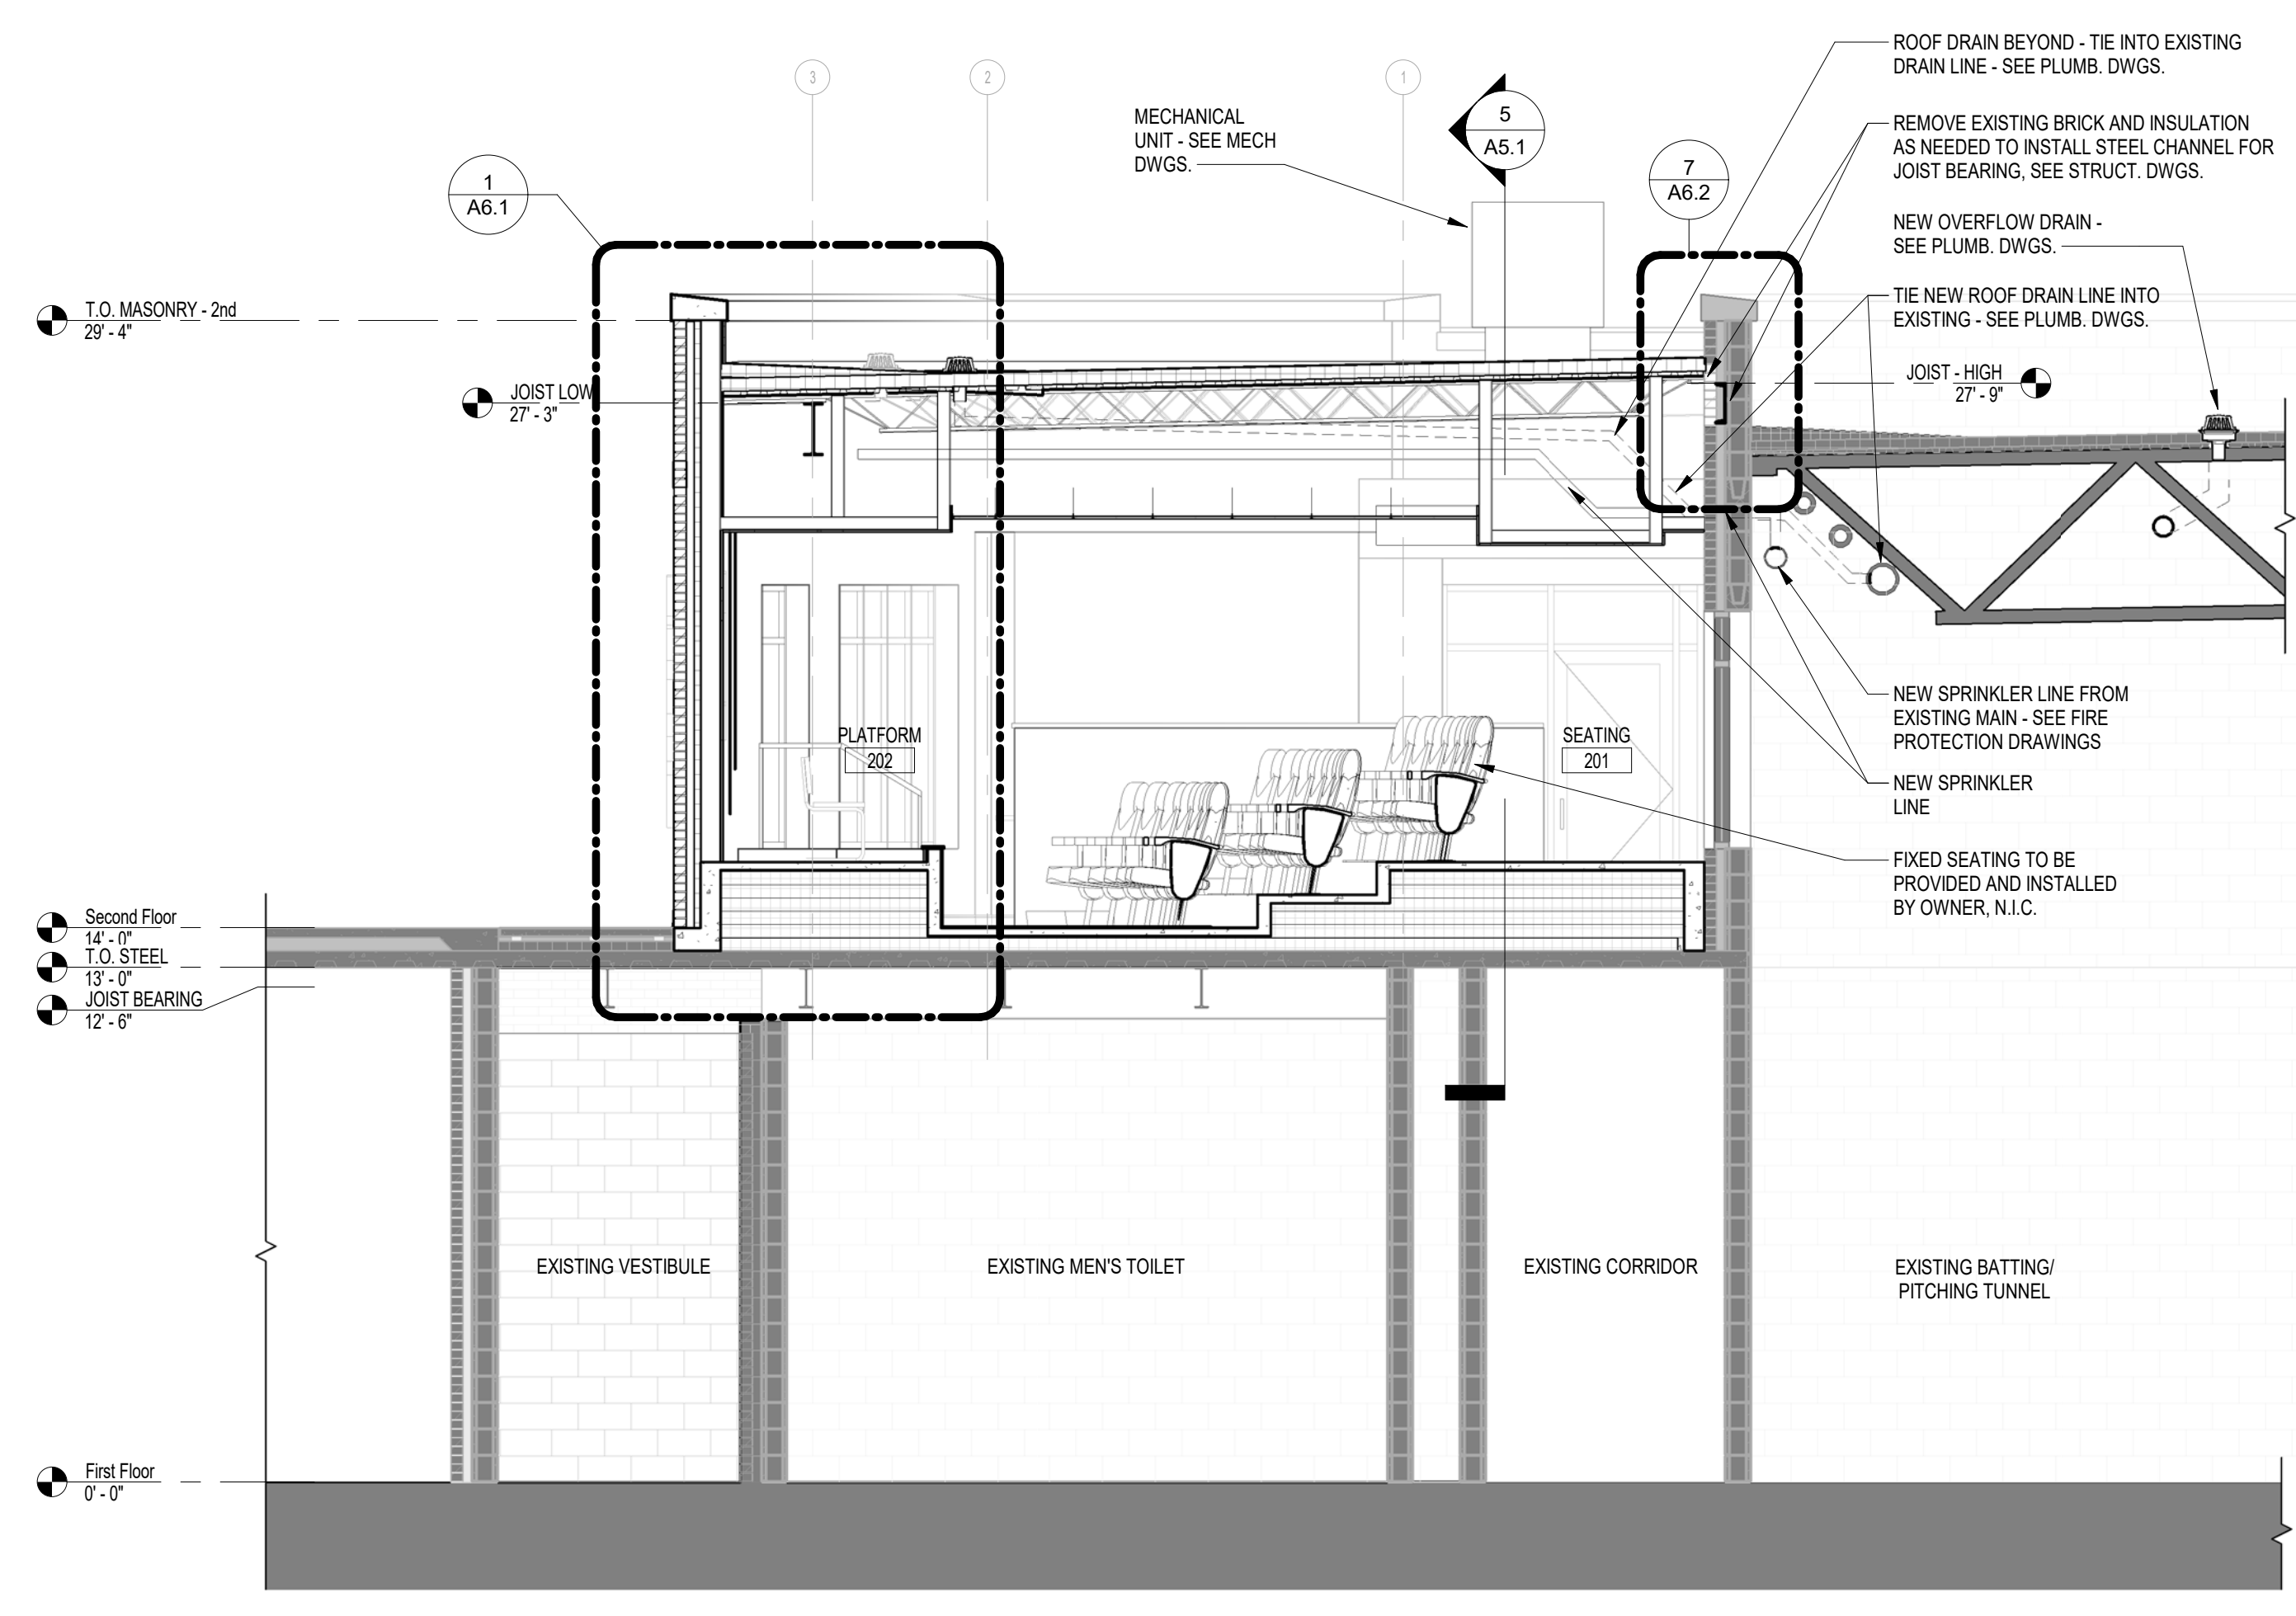

3 SECTION - MEDIA ROOM
 A5.1 1/4" = 1'-0"
 REFERENCED: A1.2
 OK

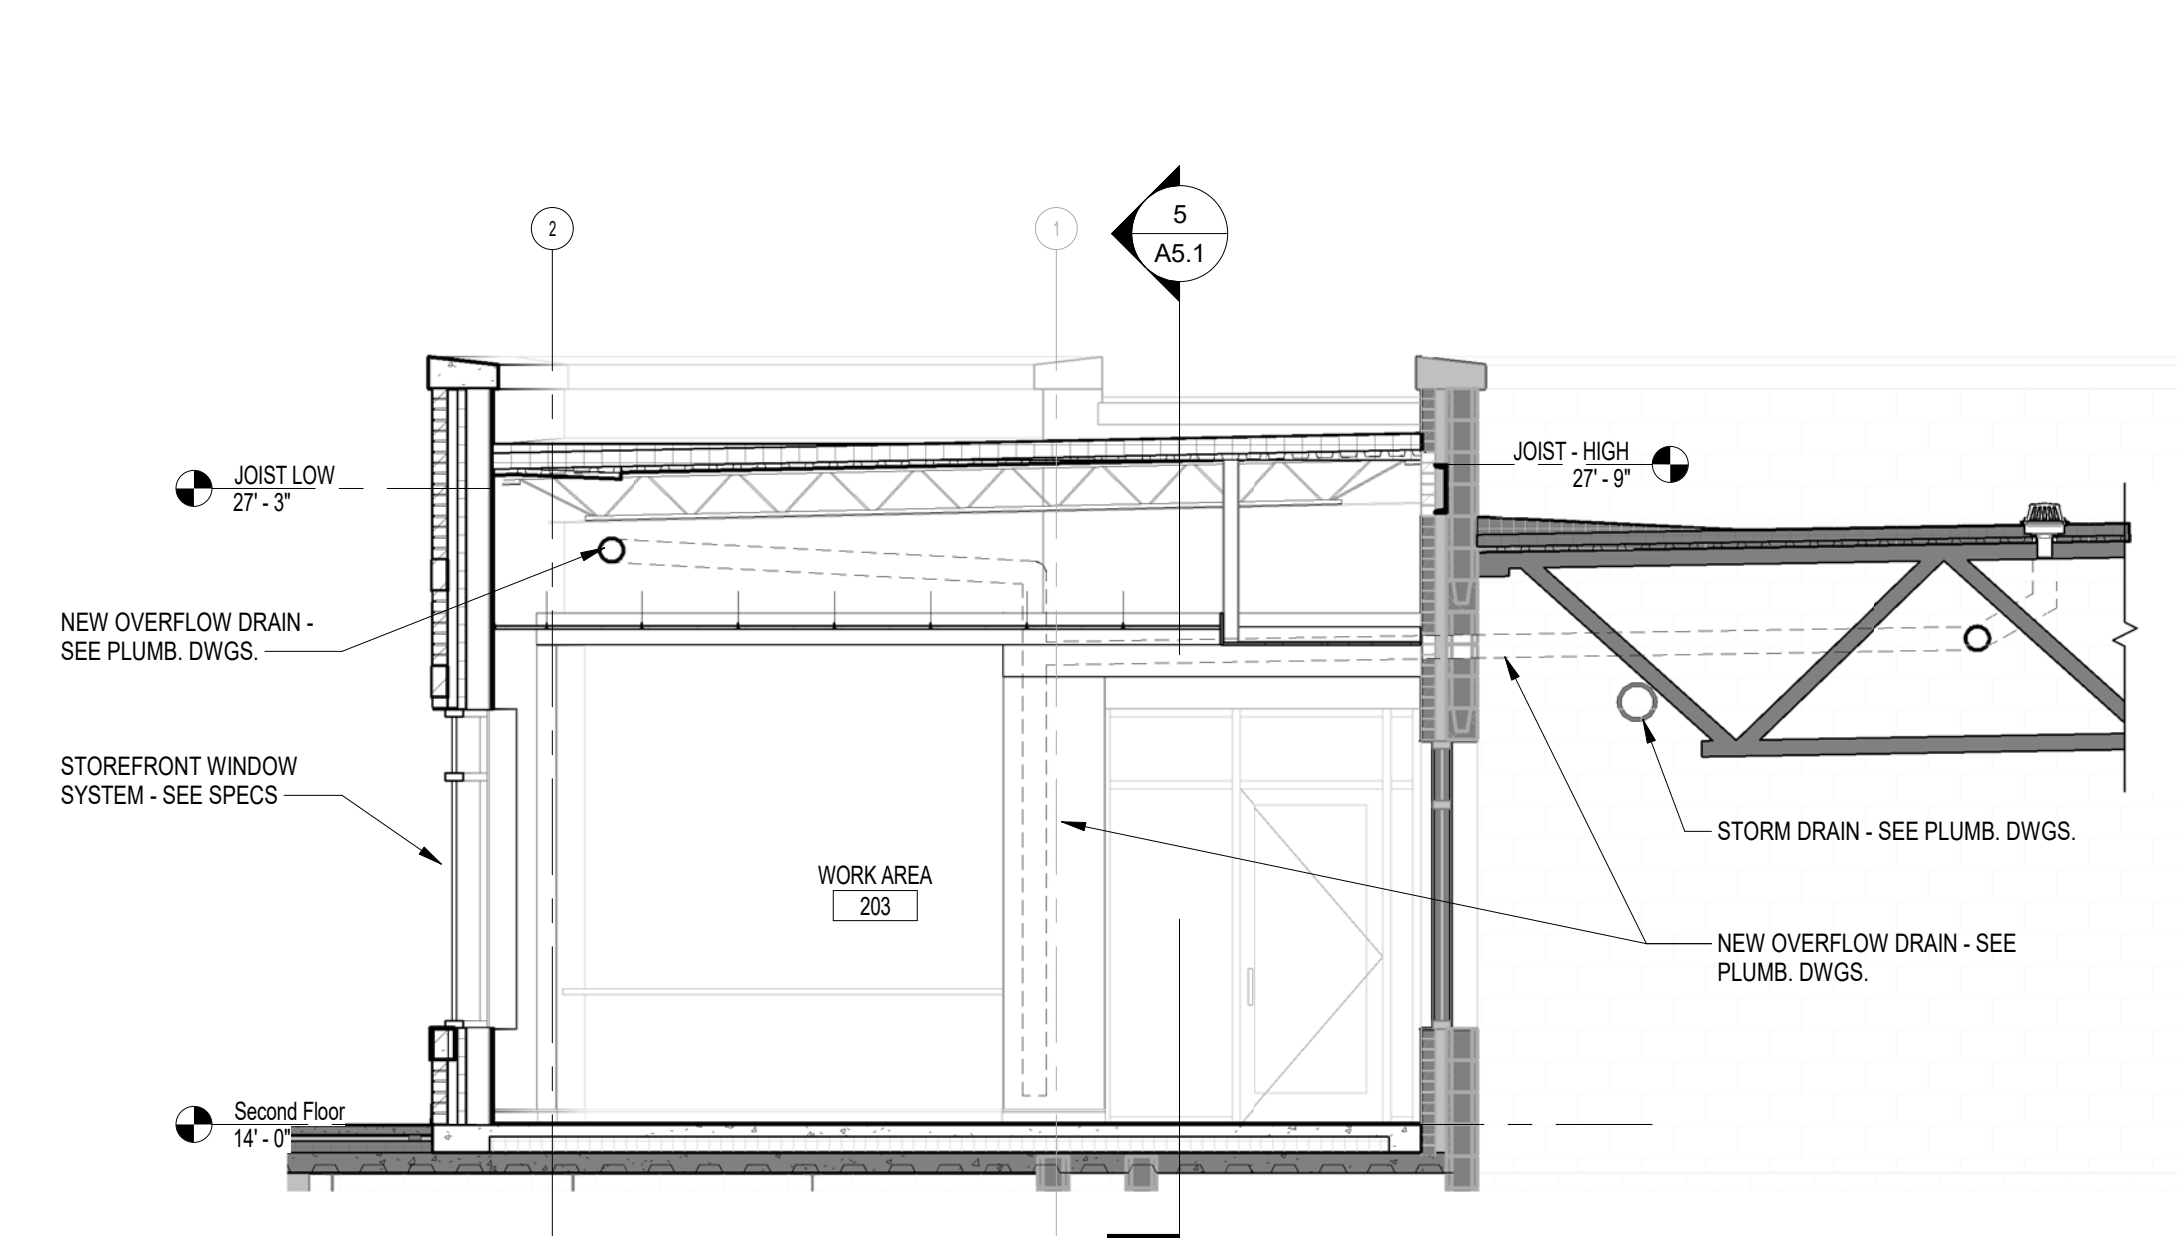


4 SECTION - MEDIA ROOM
 A5.1 1/4" = 1'-0"
 REFERENCED: A1.2
 OK

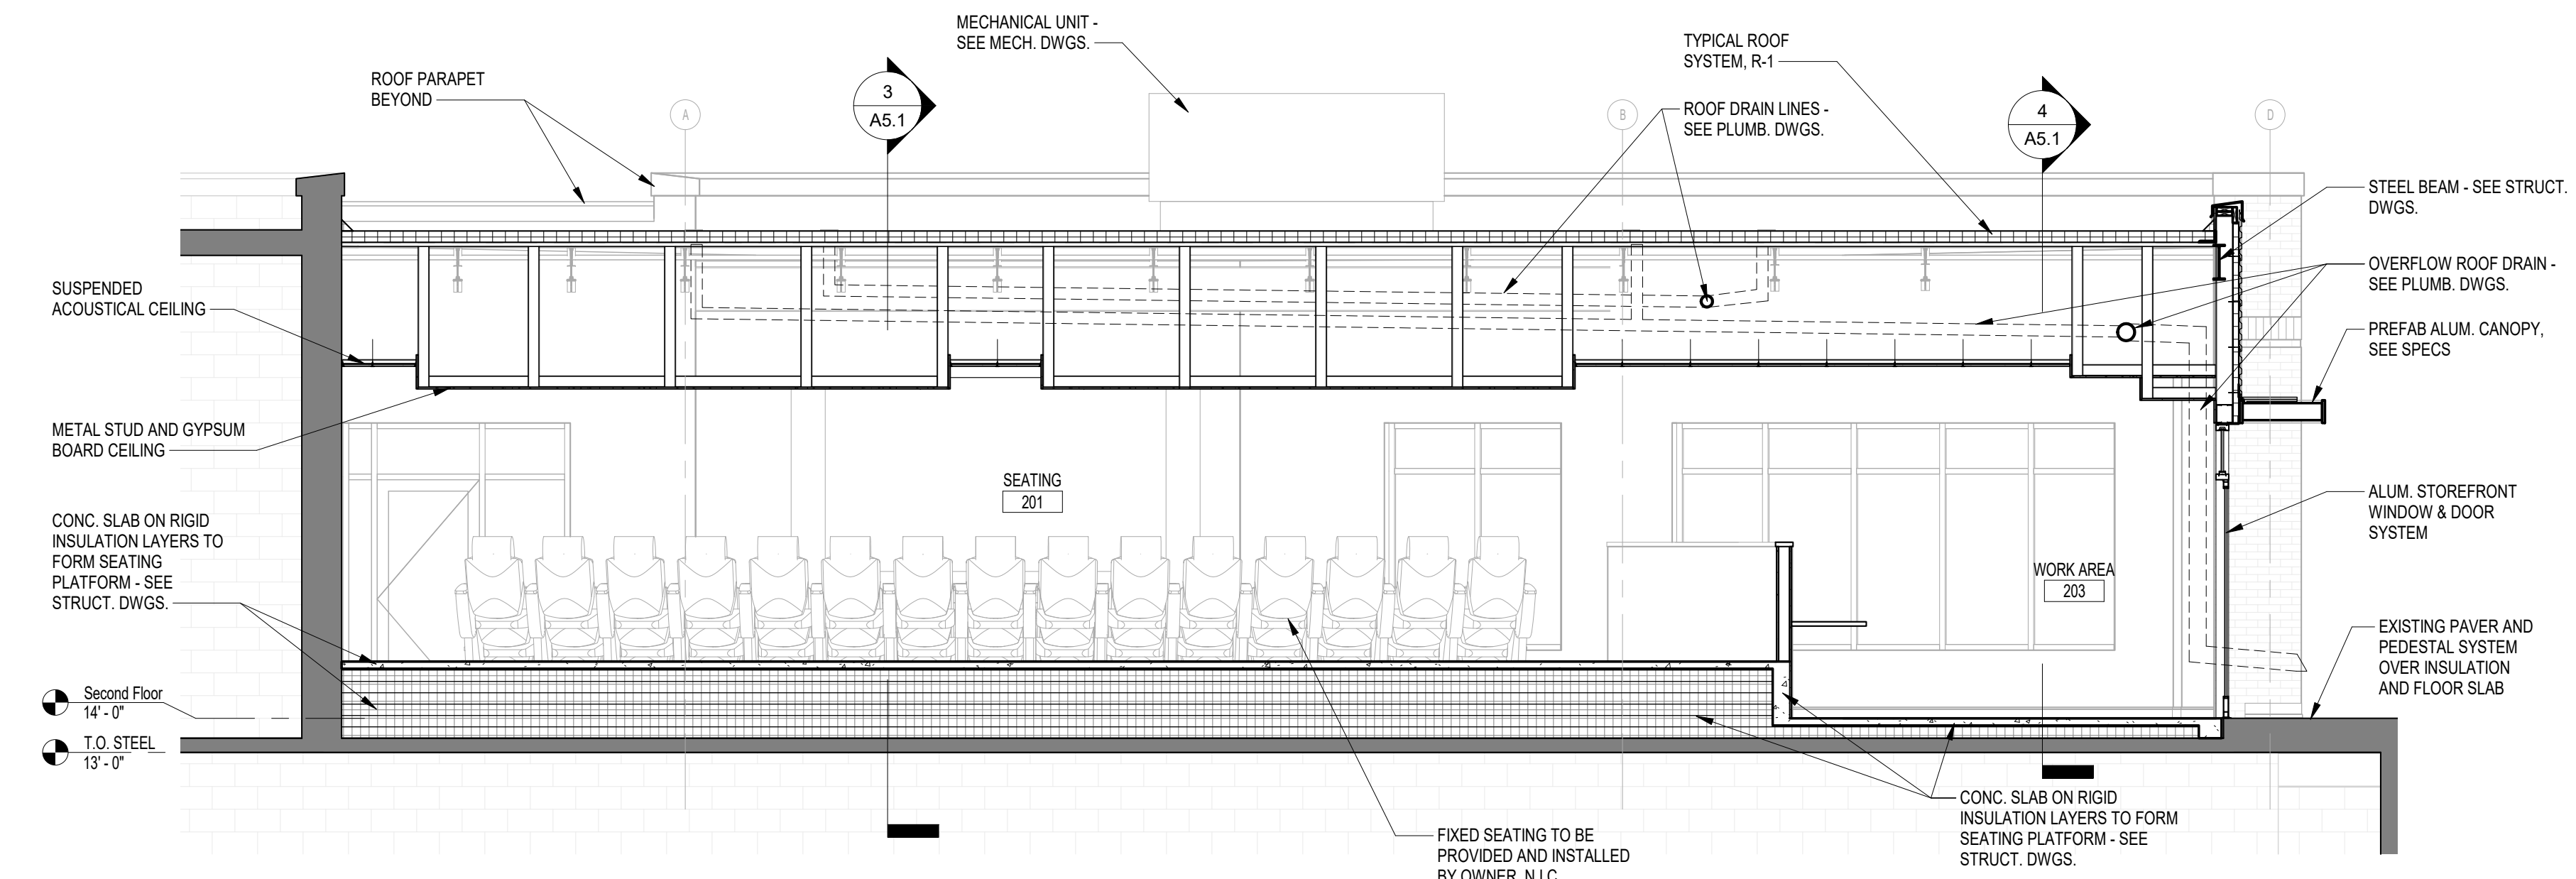


5 SECTION - MEDIA ROOM
 A5.1 1/4" = 1'-0"
 REFERENCED: A1.2
 OK


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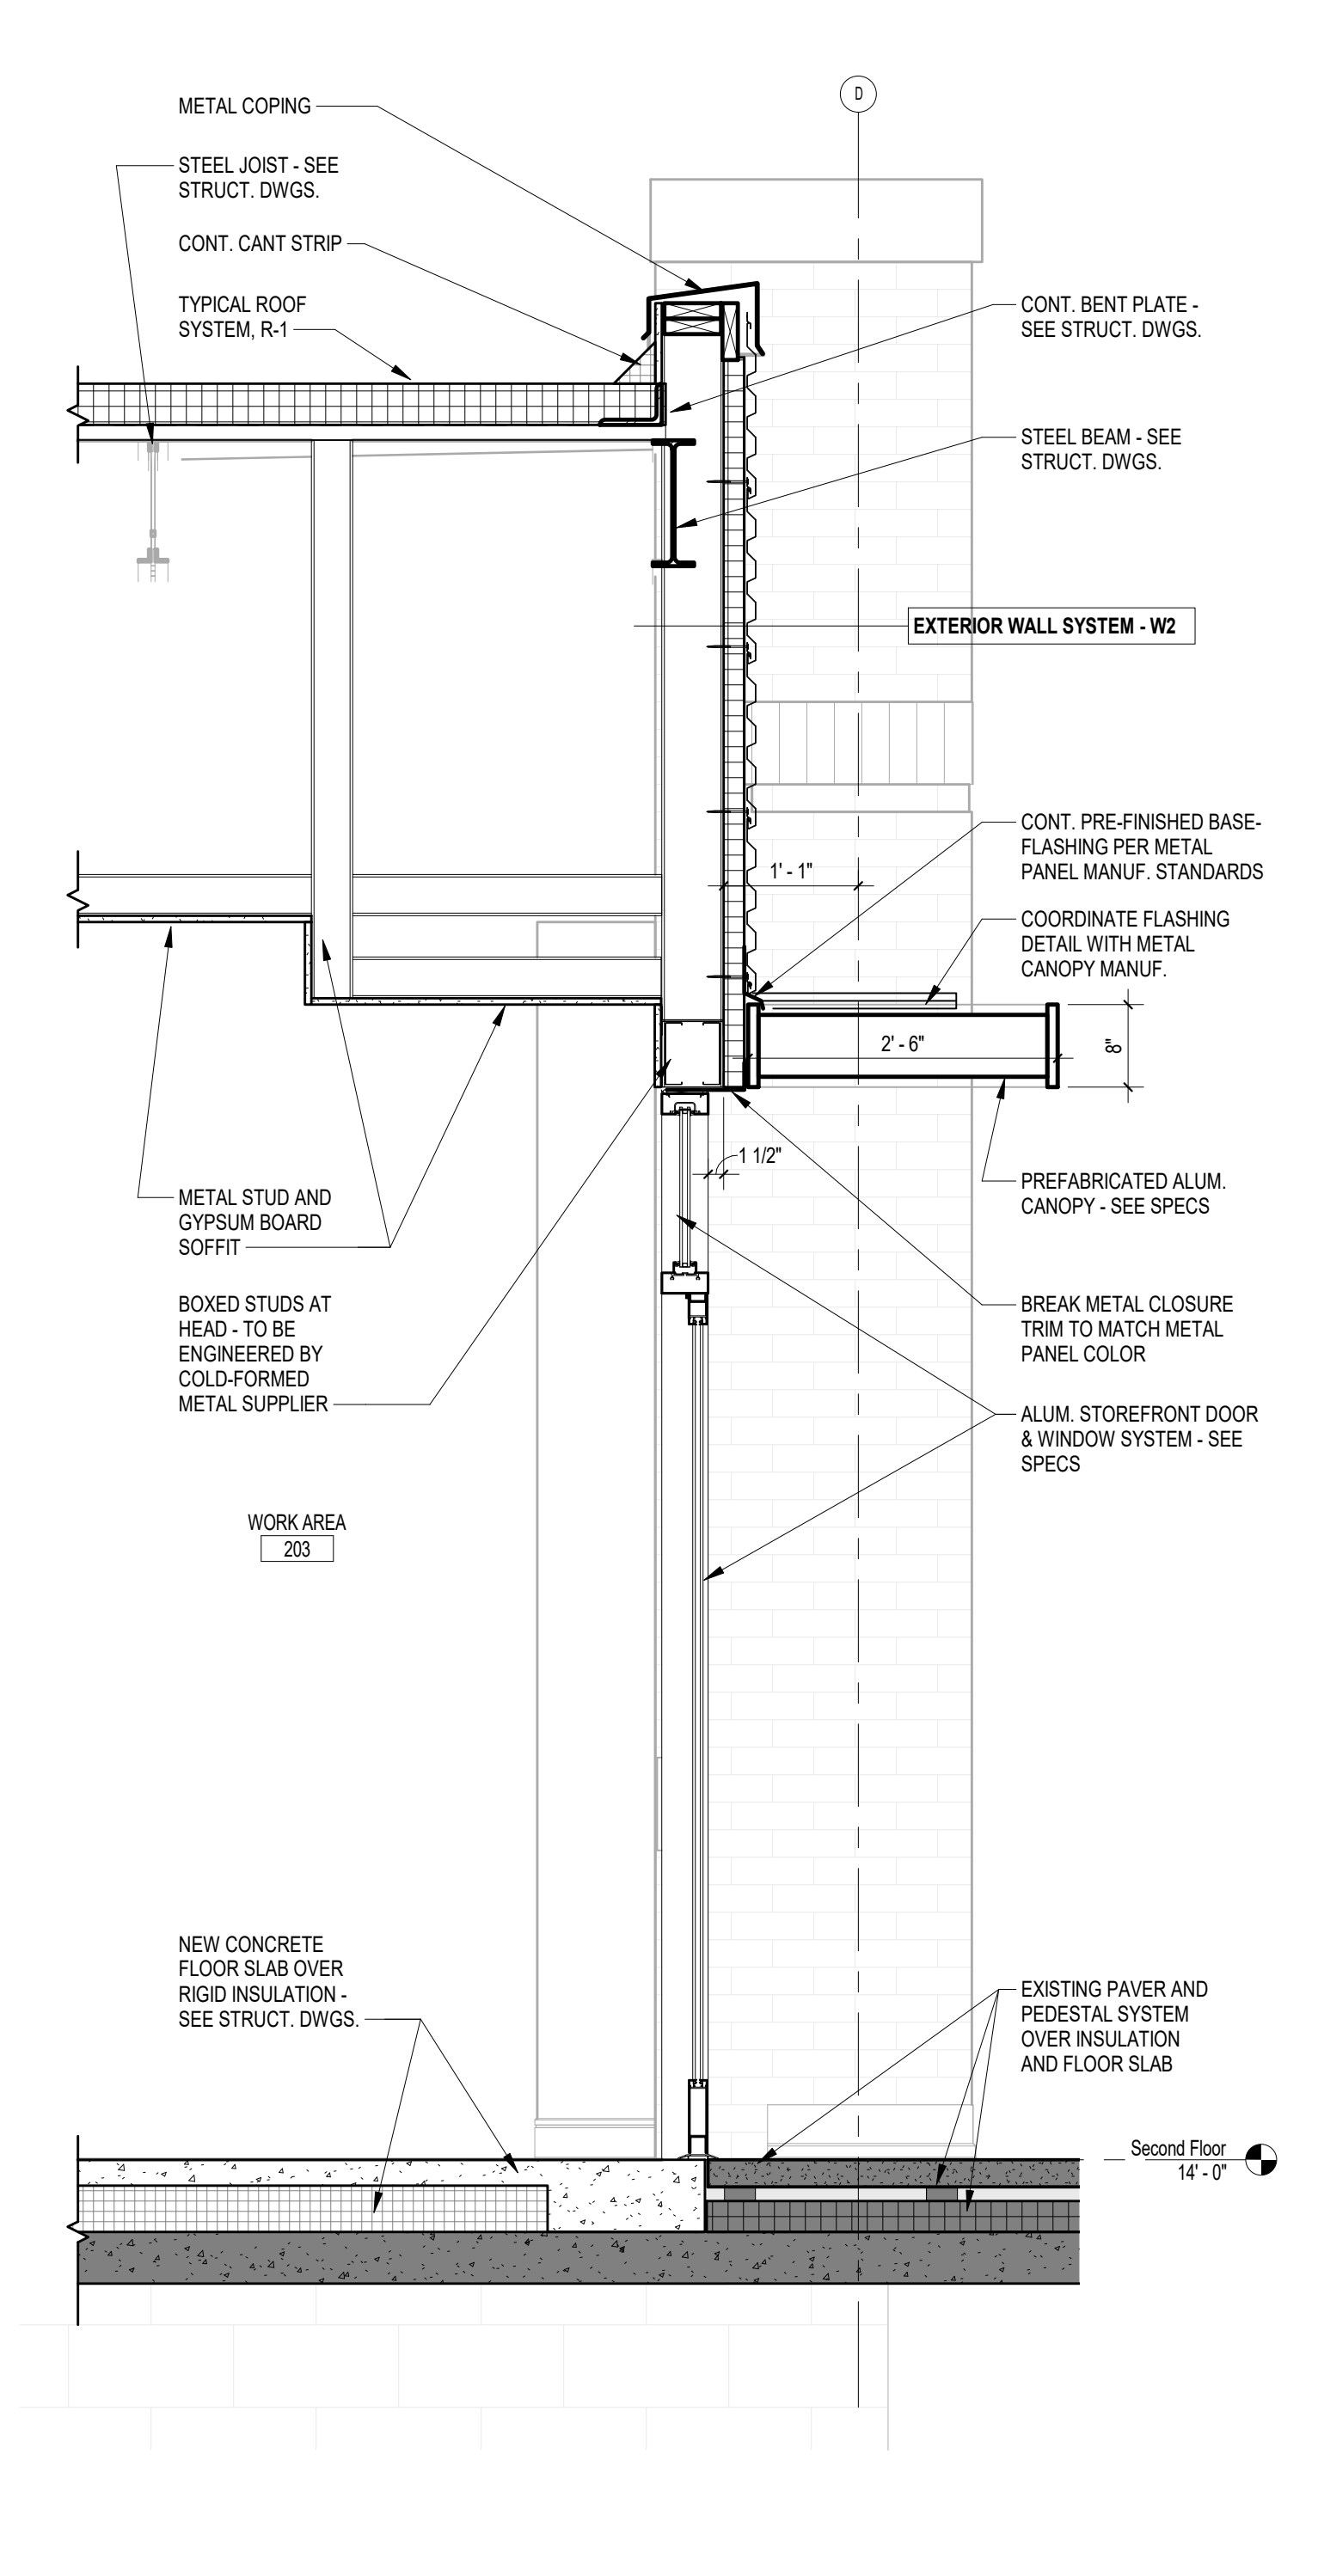
1 WALL SECTION
A6.1 3/4" = 1'-0" REFERENCED ON A1.2
OK

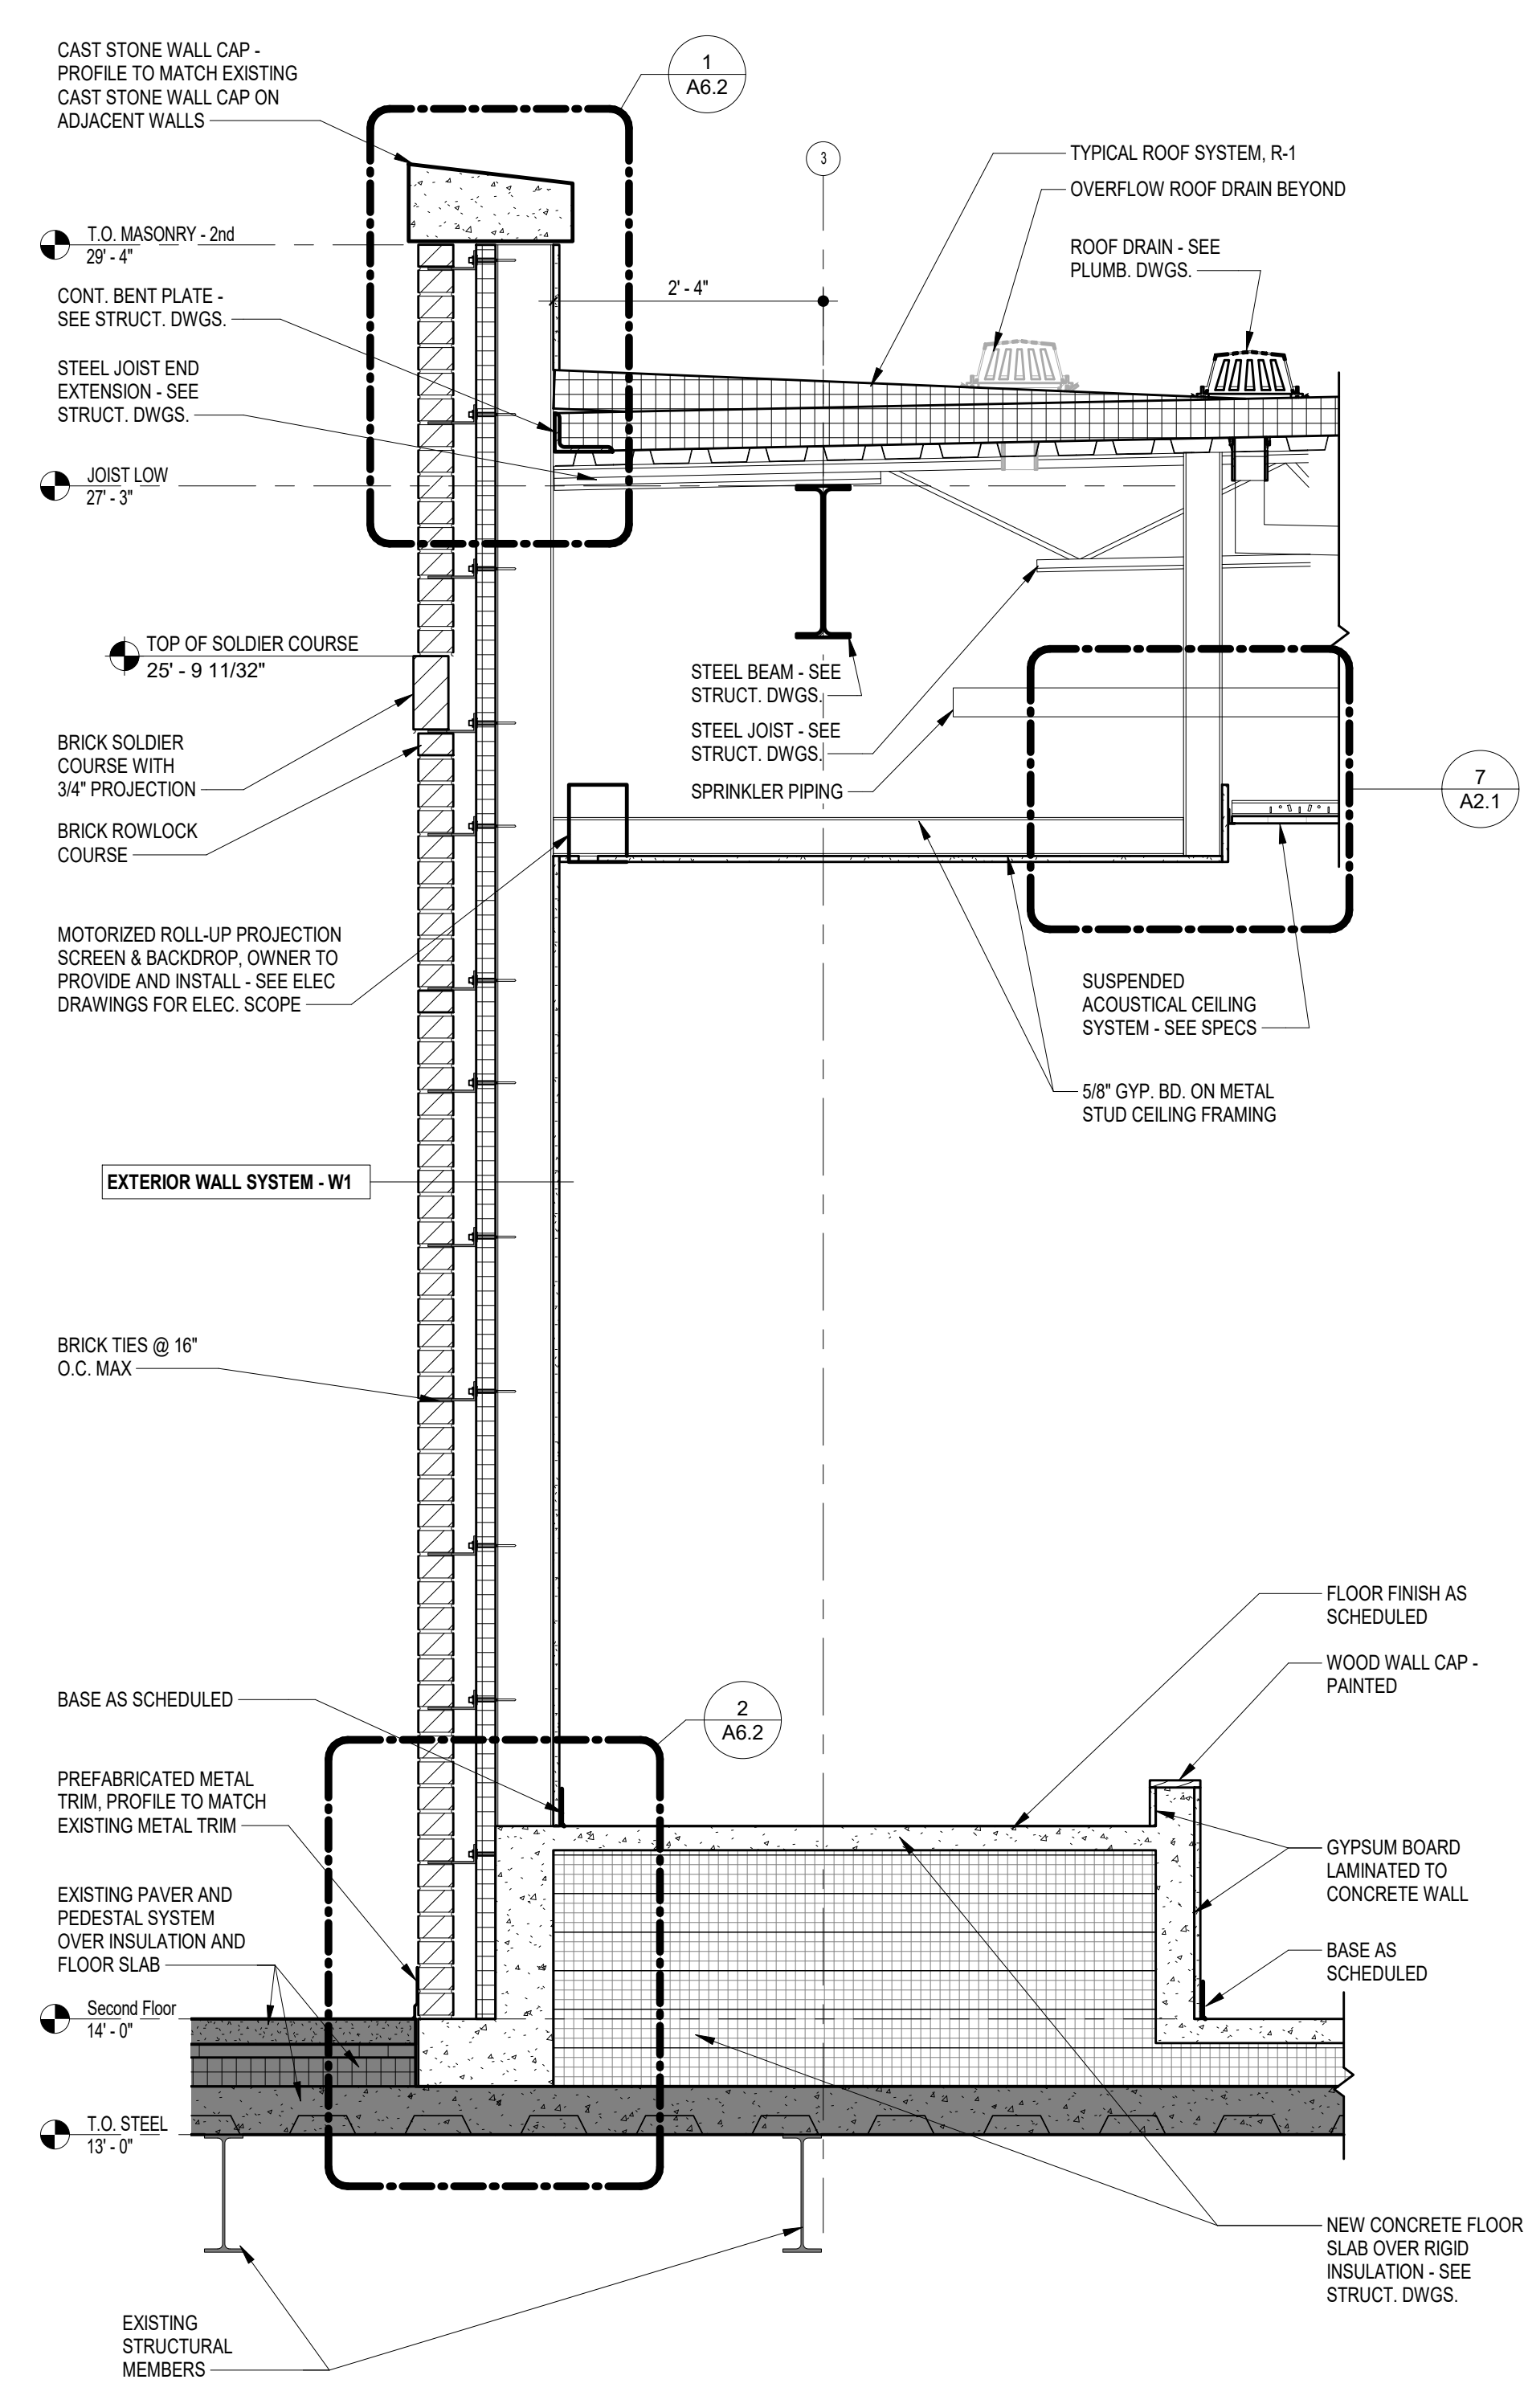


2 WALL SECTION
A6.1 3/4" = 1'-0" REFERENCED ON A1.2
OK

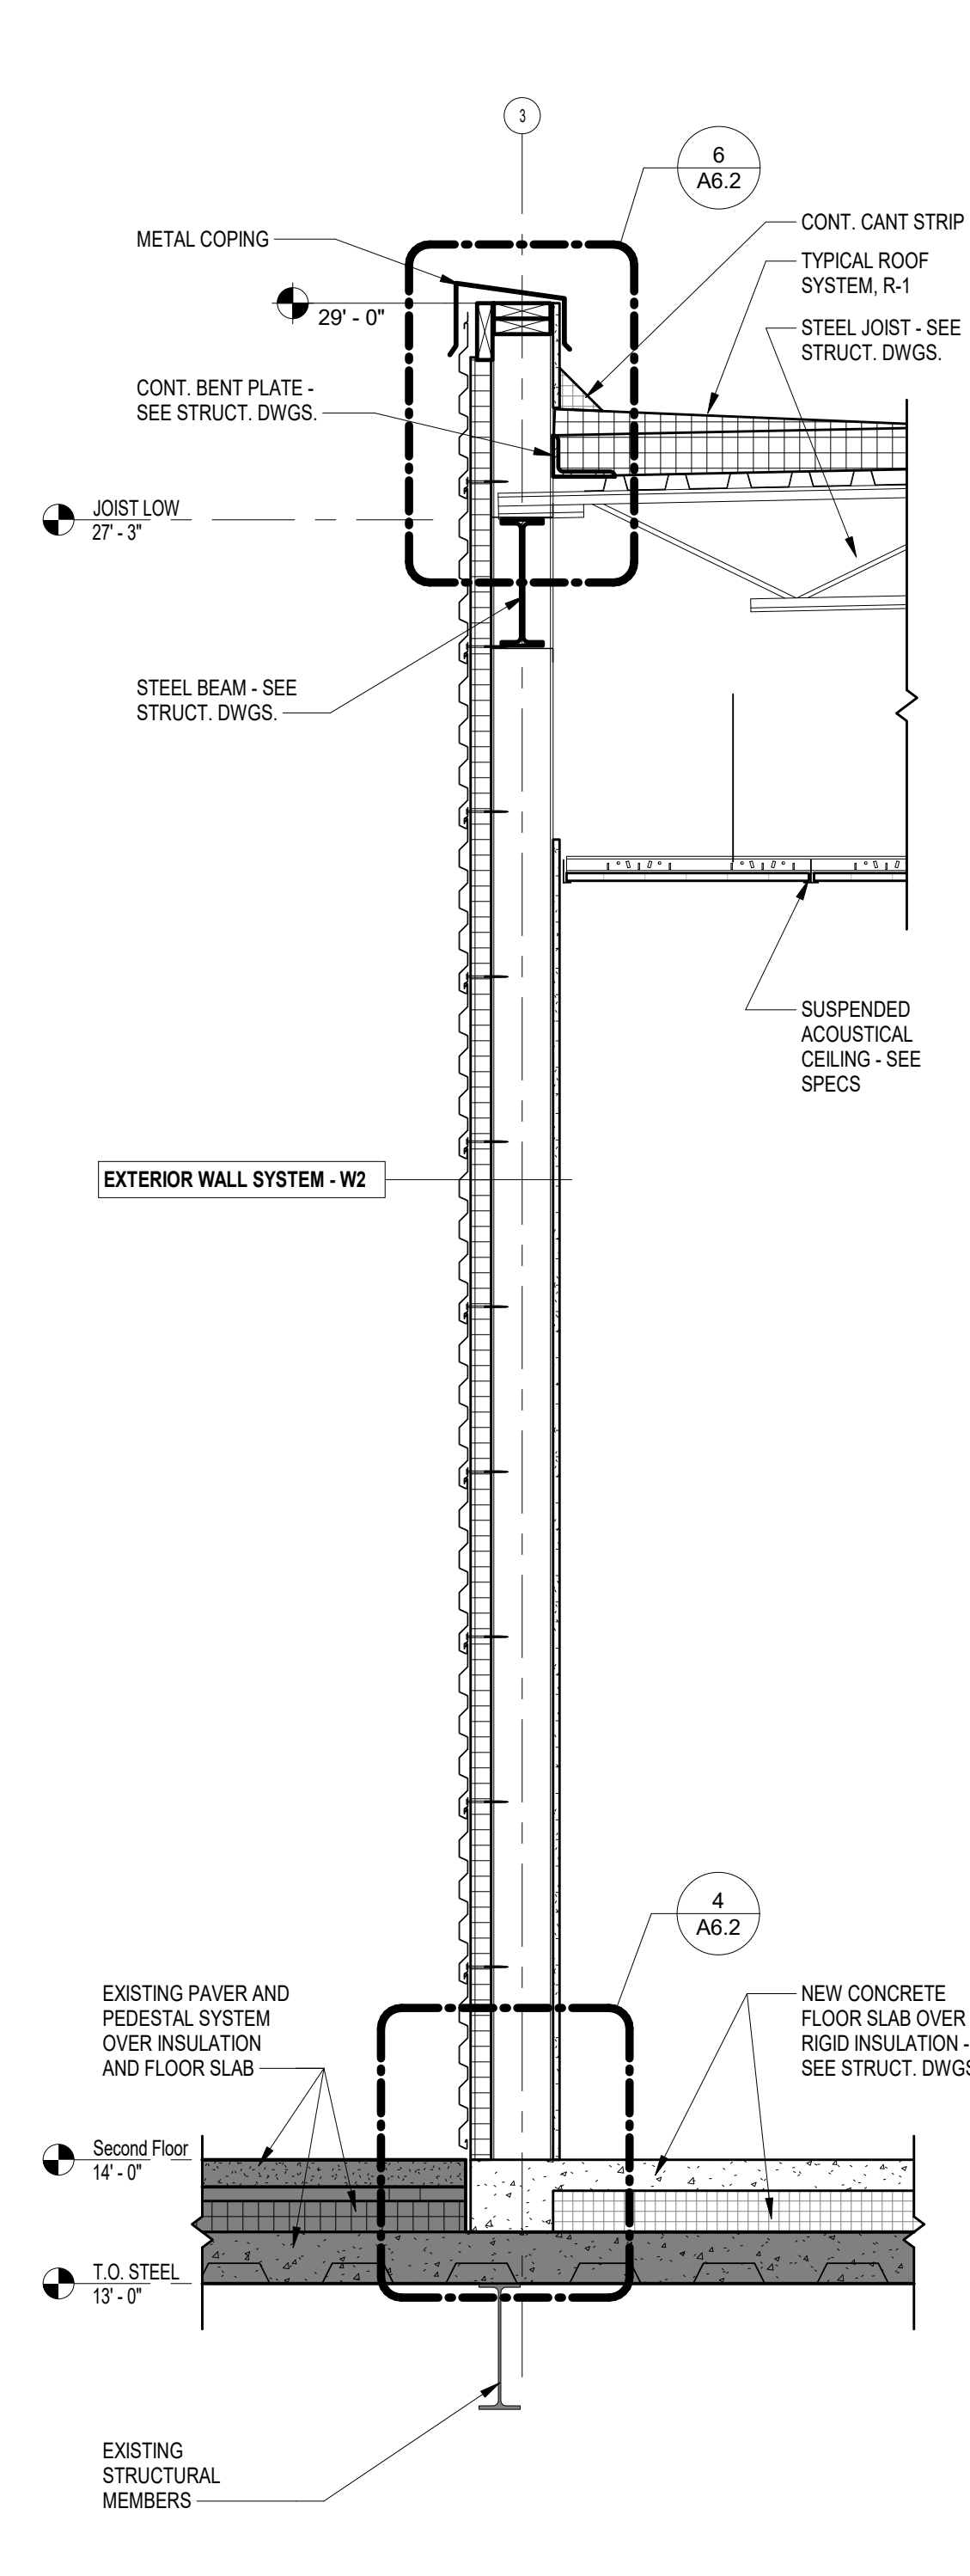


3 WALL SECTION
A6.1 3/4" = 1'-0" REFERENCED ON A1.2
OK

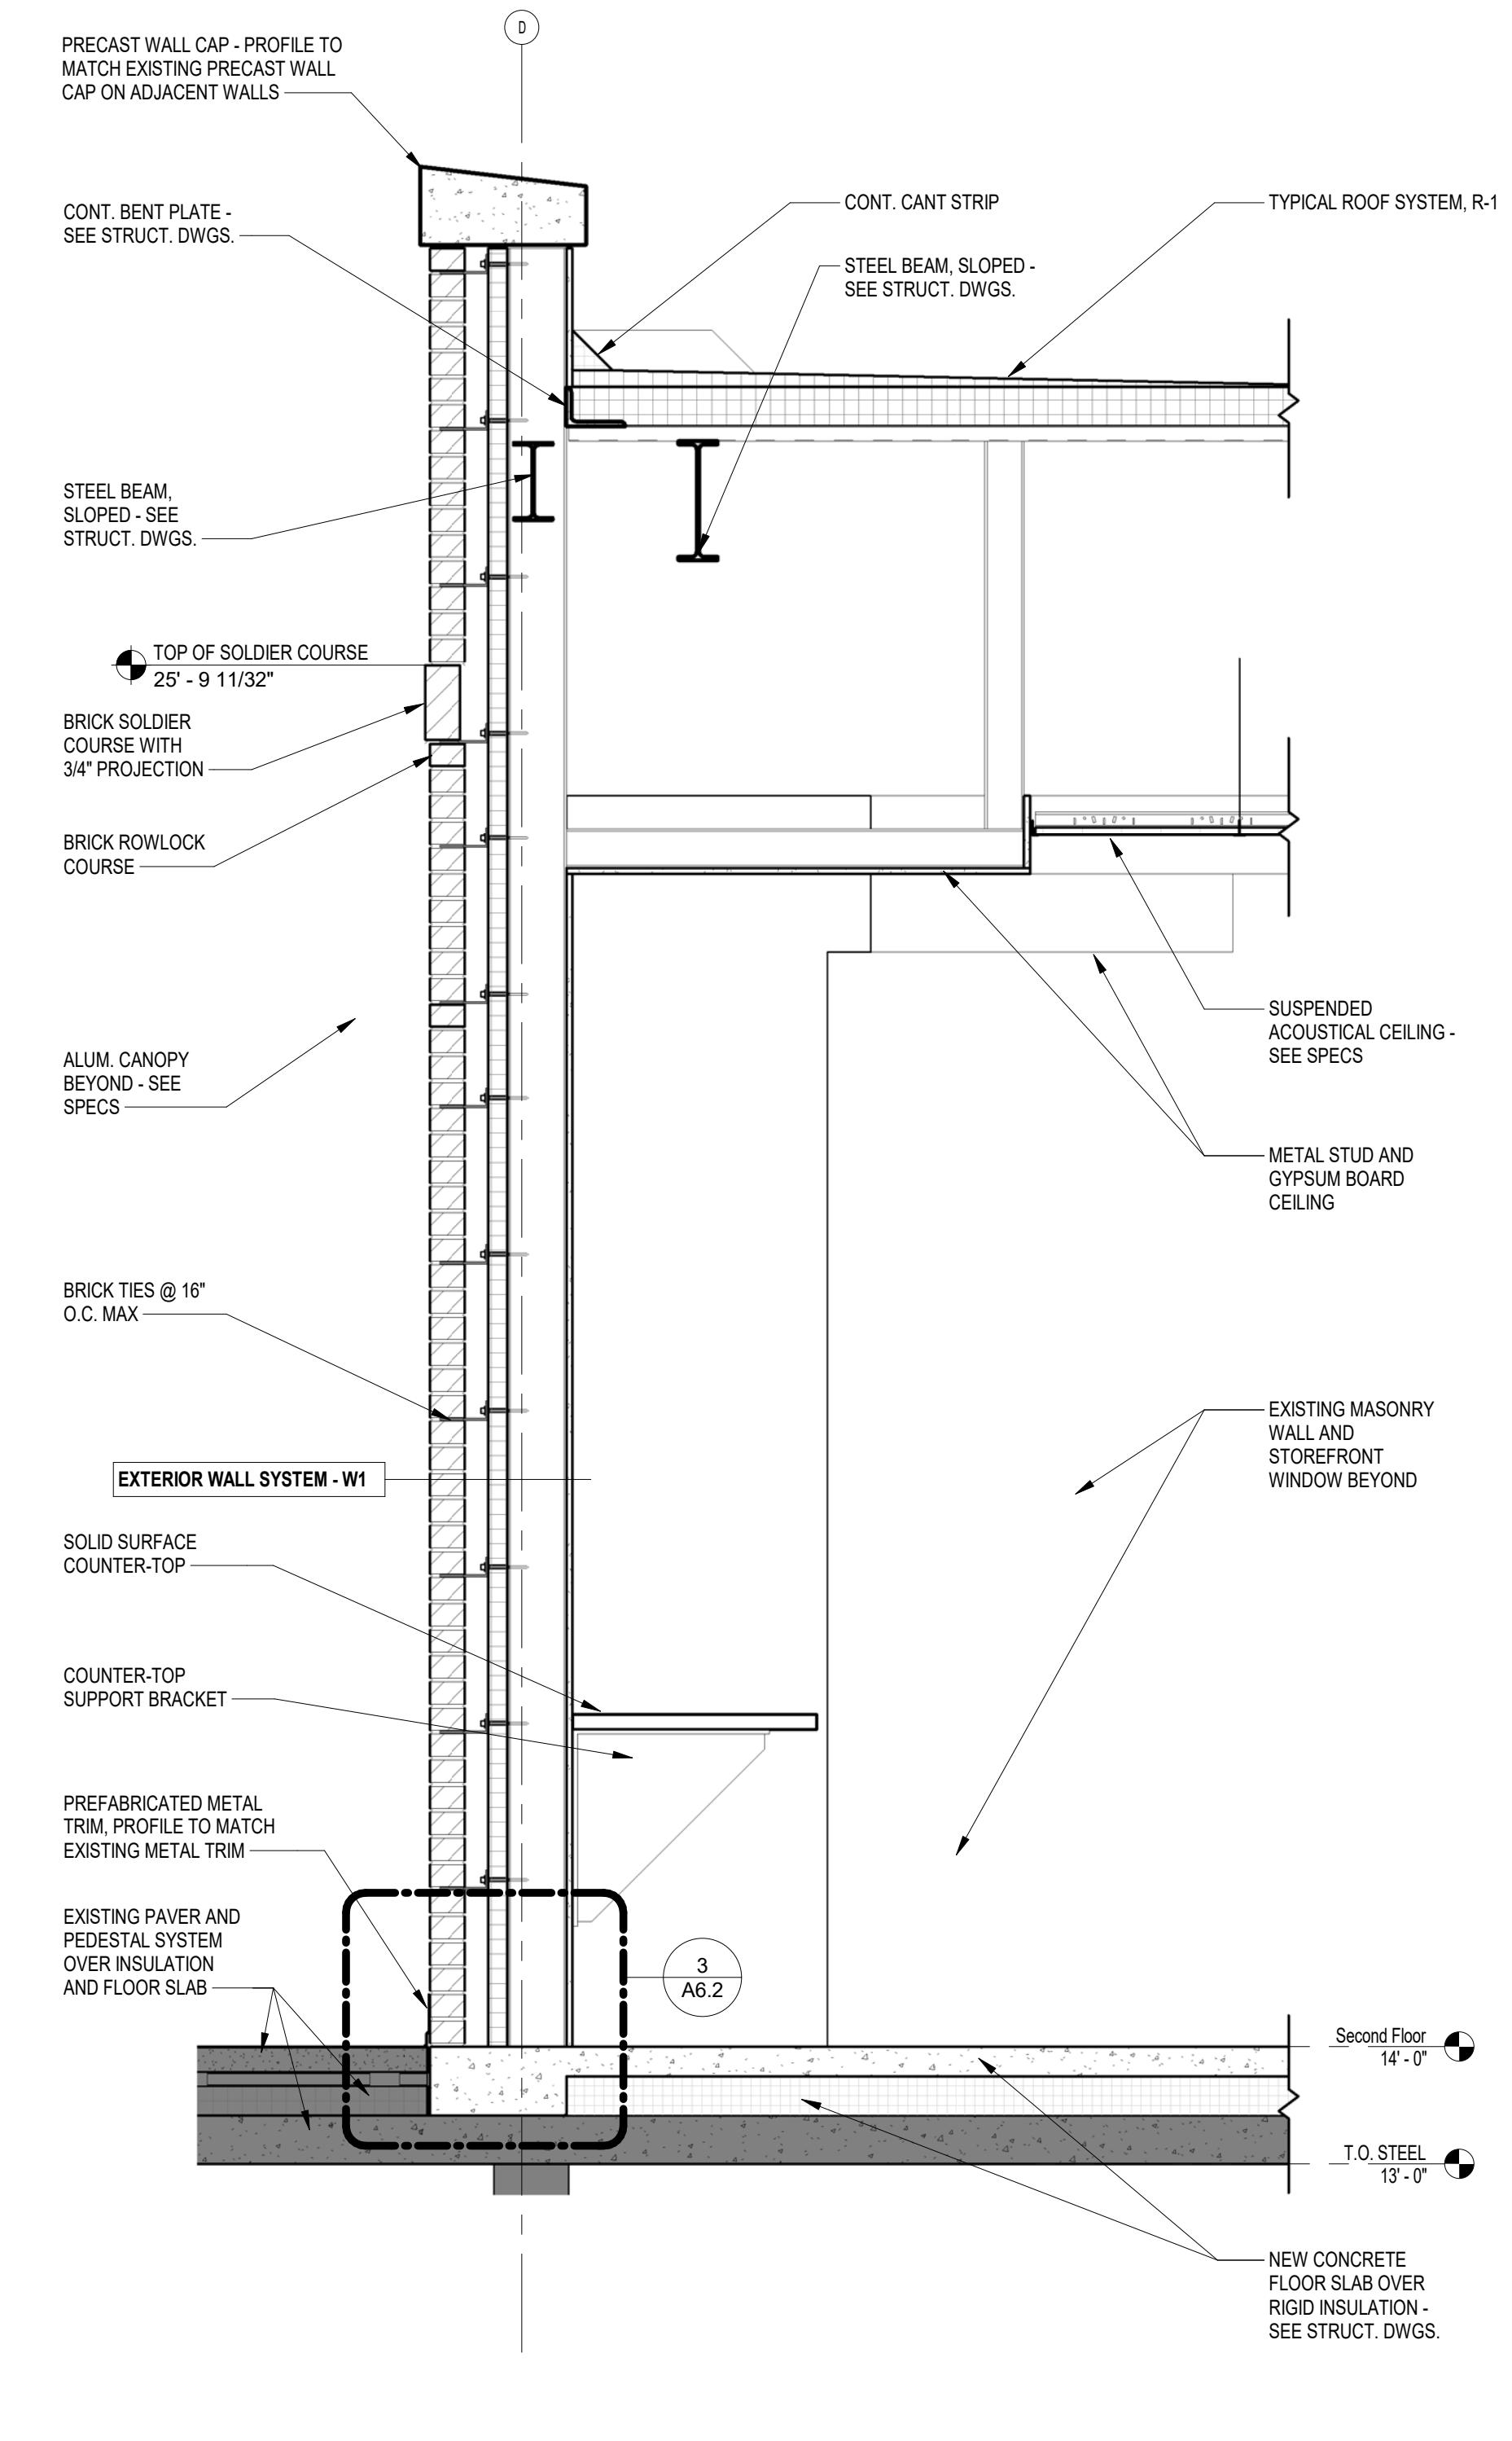


4 WALL SECTION
A6.1 3/4" = 1'-0" REFERENCED ON A1.2
OK

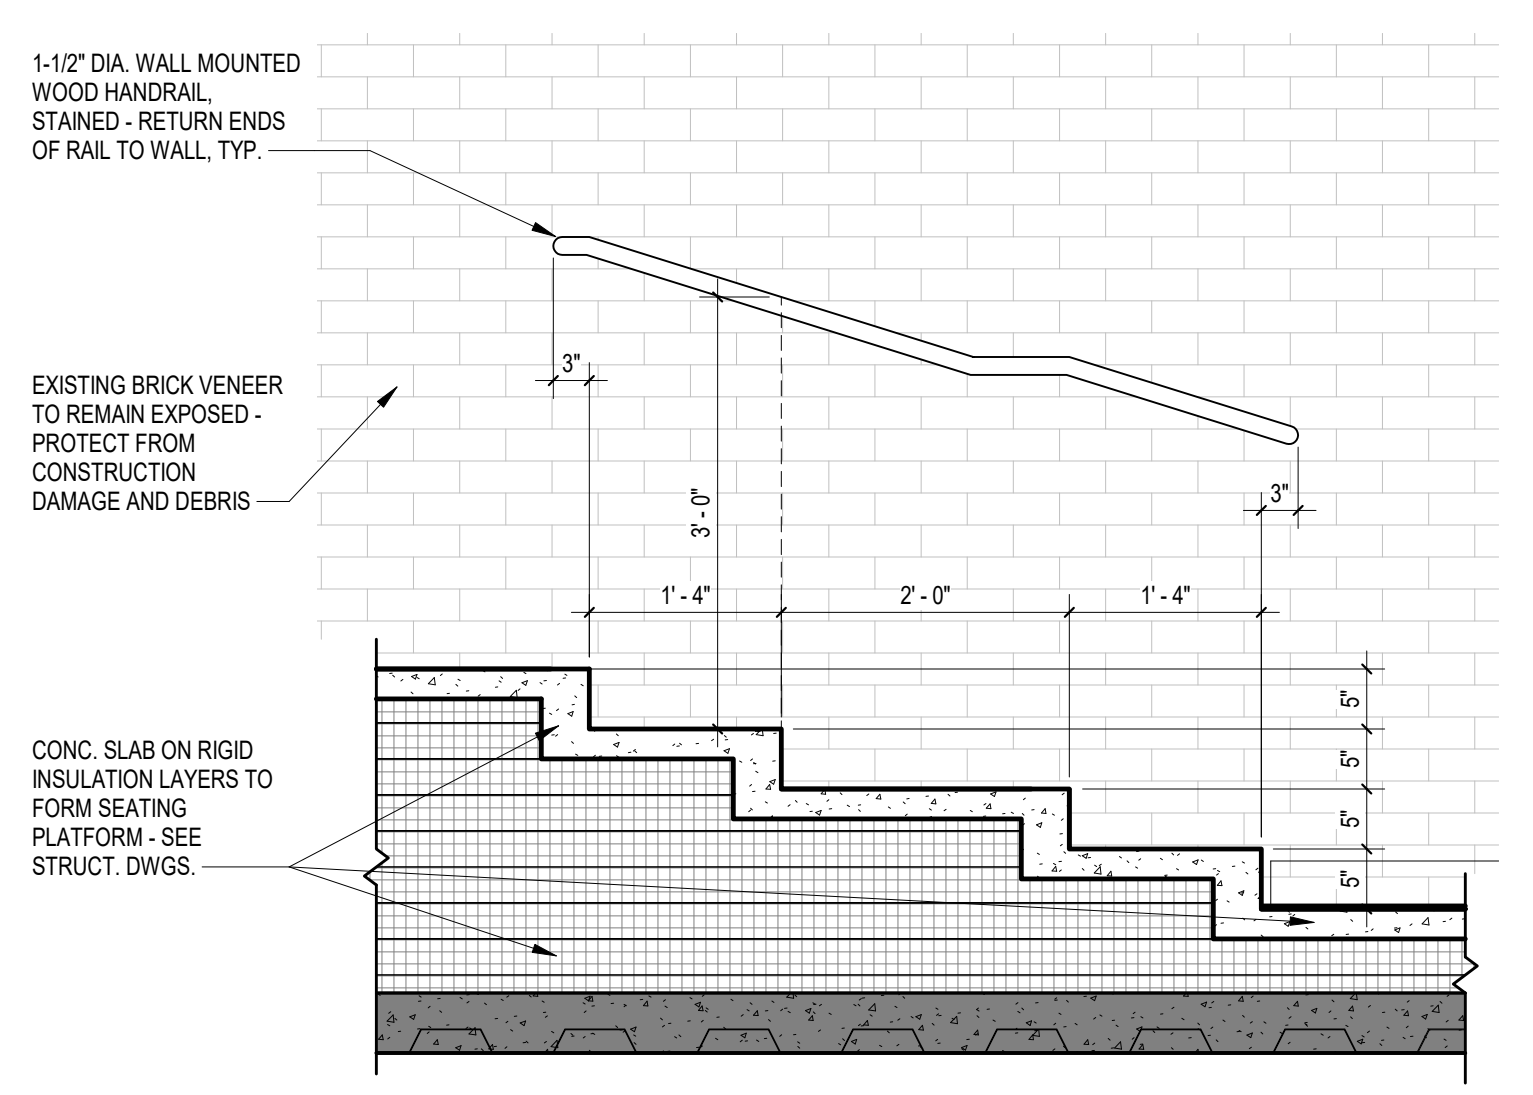

6 PLATFORM STAIR SECTION DETAIL
A6.1 3/4" = 1'-0" REFERENCED ON A1.2
OK

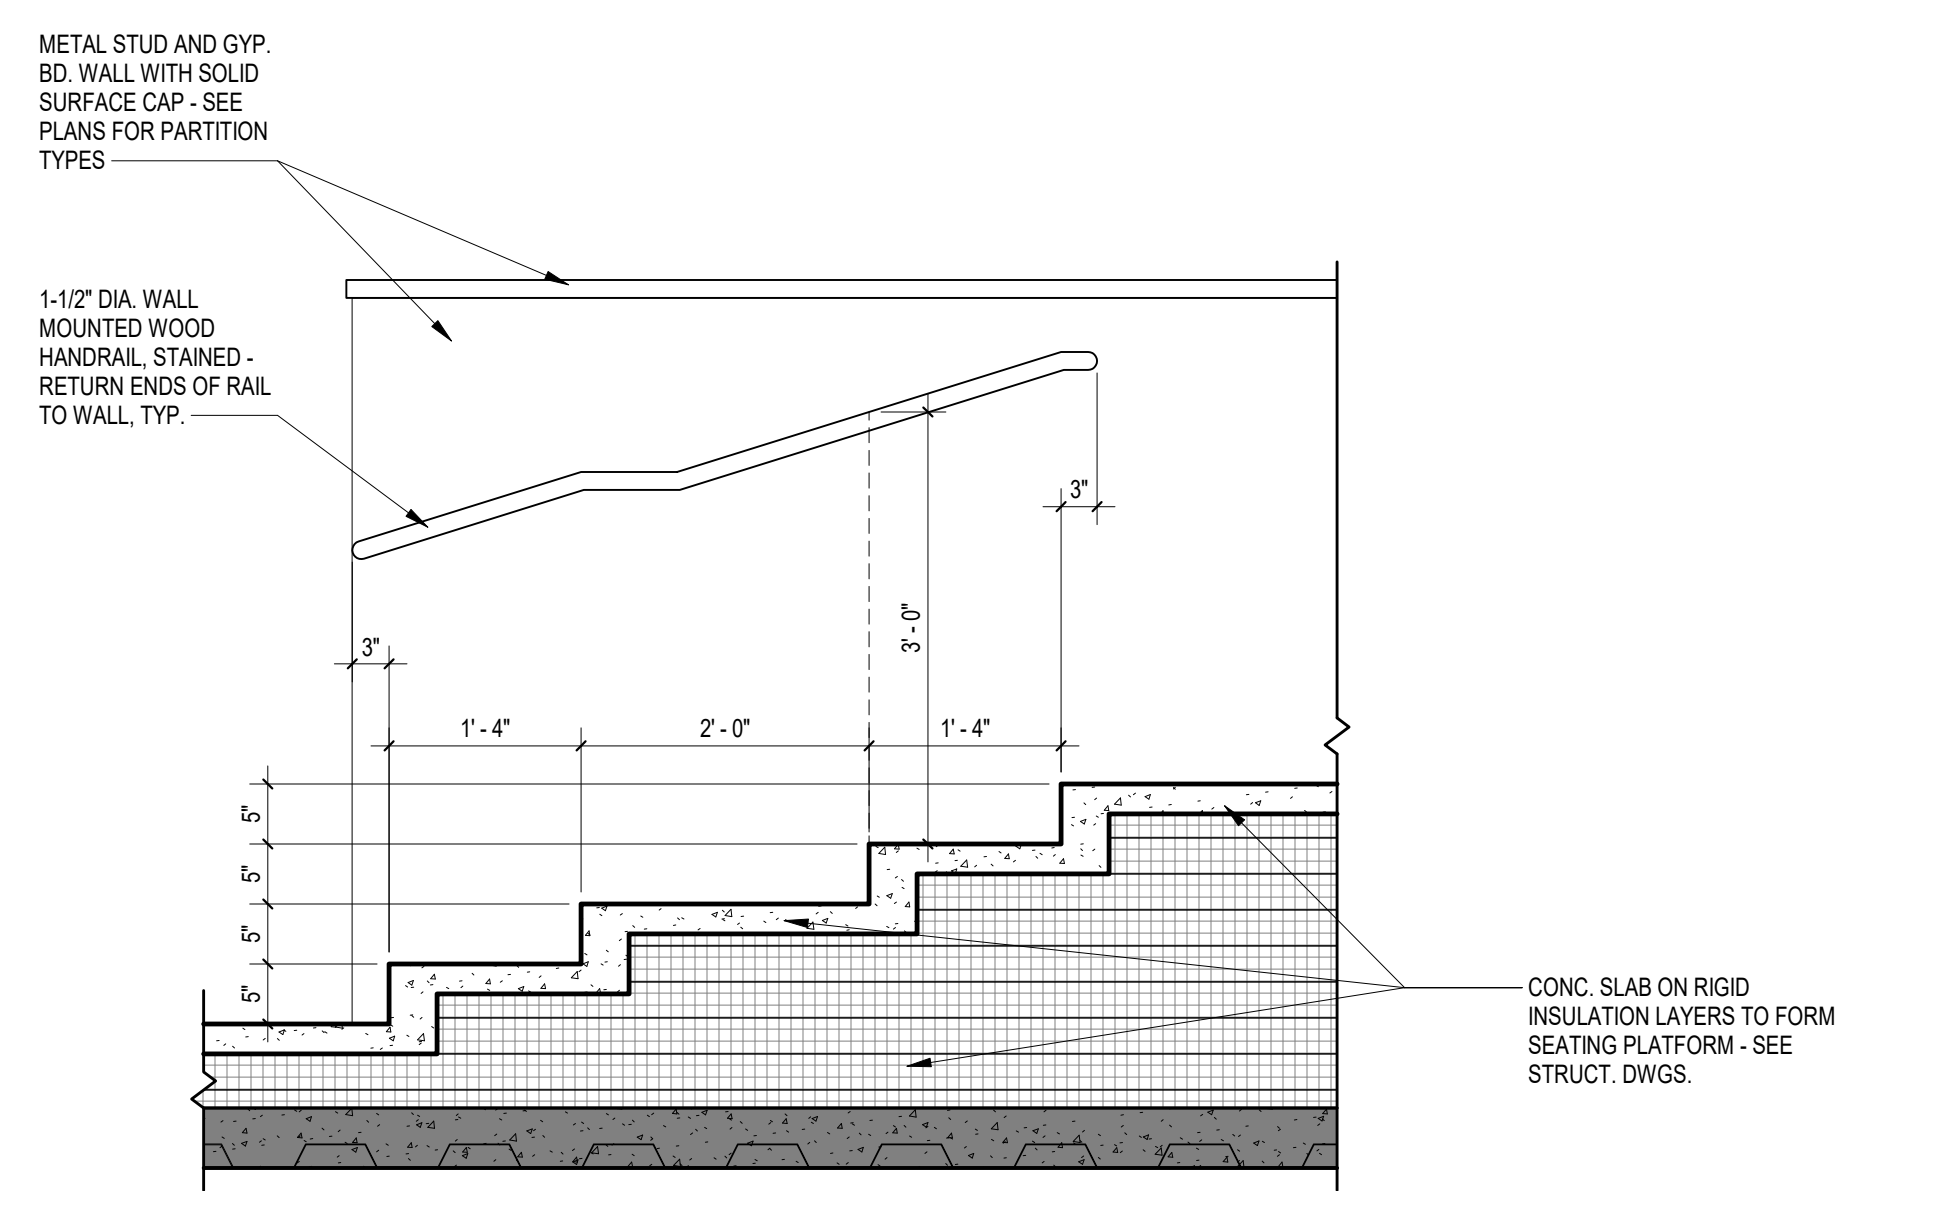

5 PLATFORM STAIR SECTION DETAIL
A6.1 3/4" = 1'-0" REFERENCED ON A1.2
OK

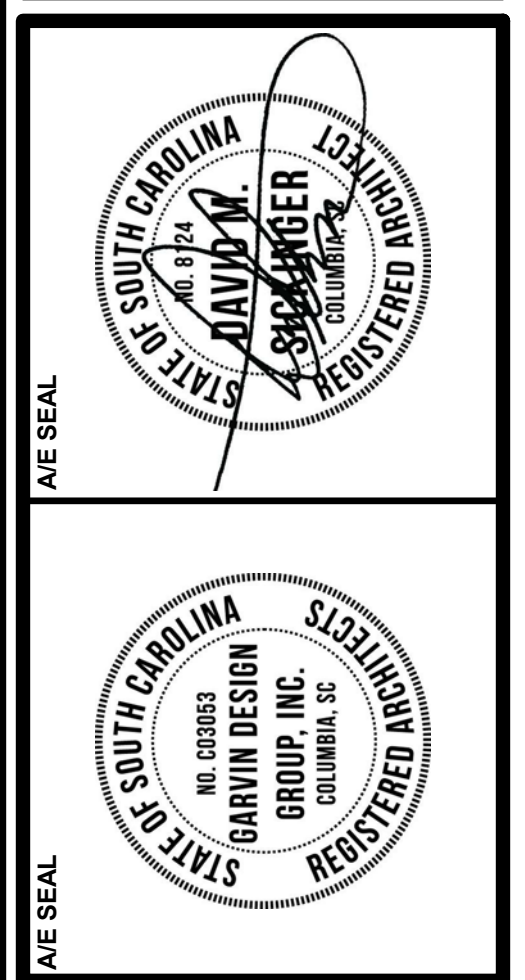


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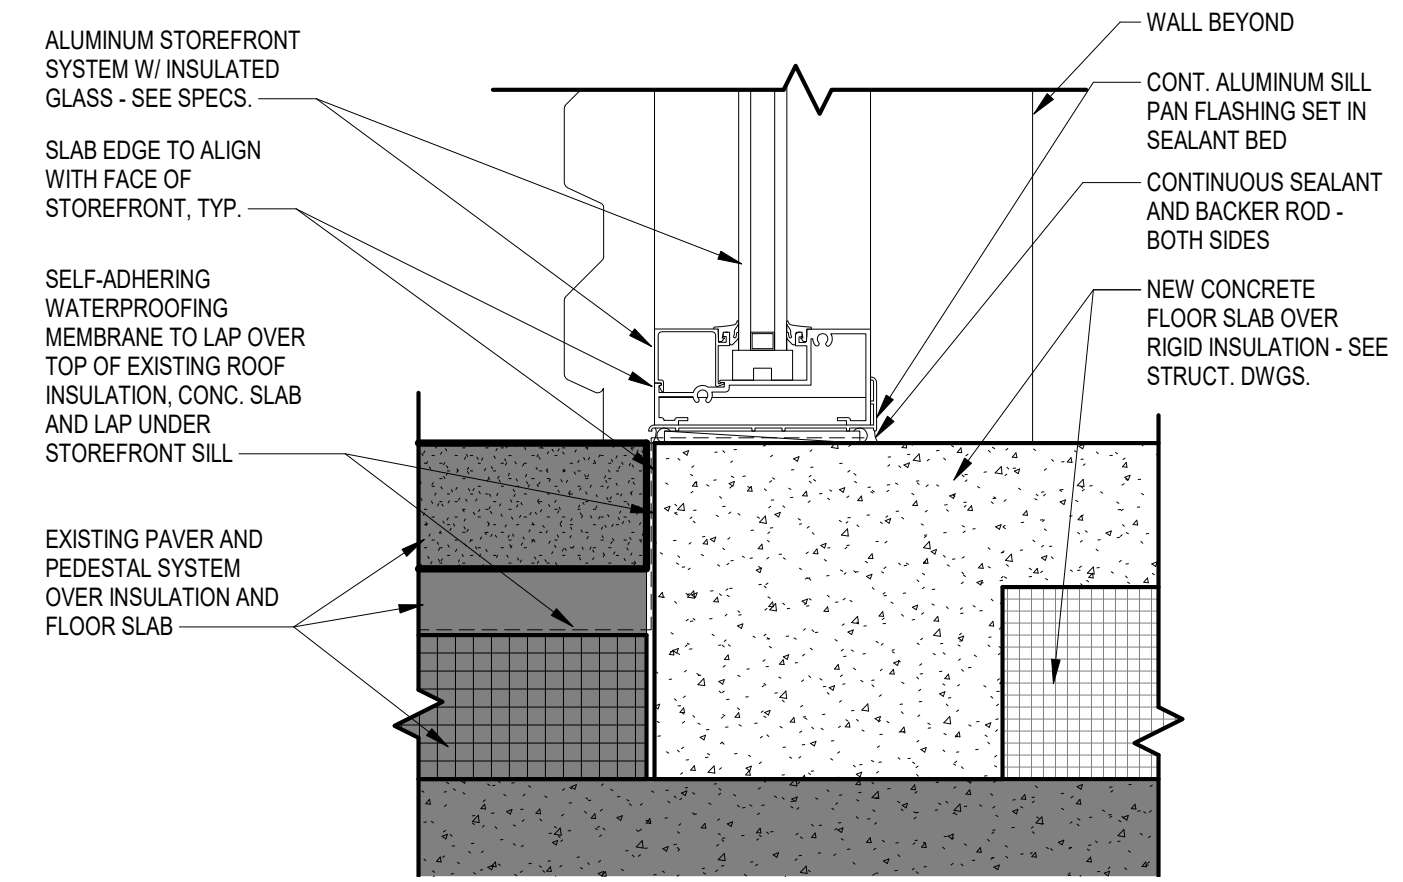
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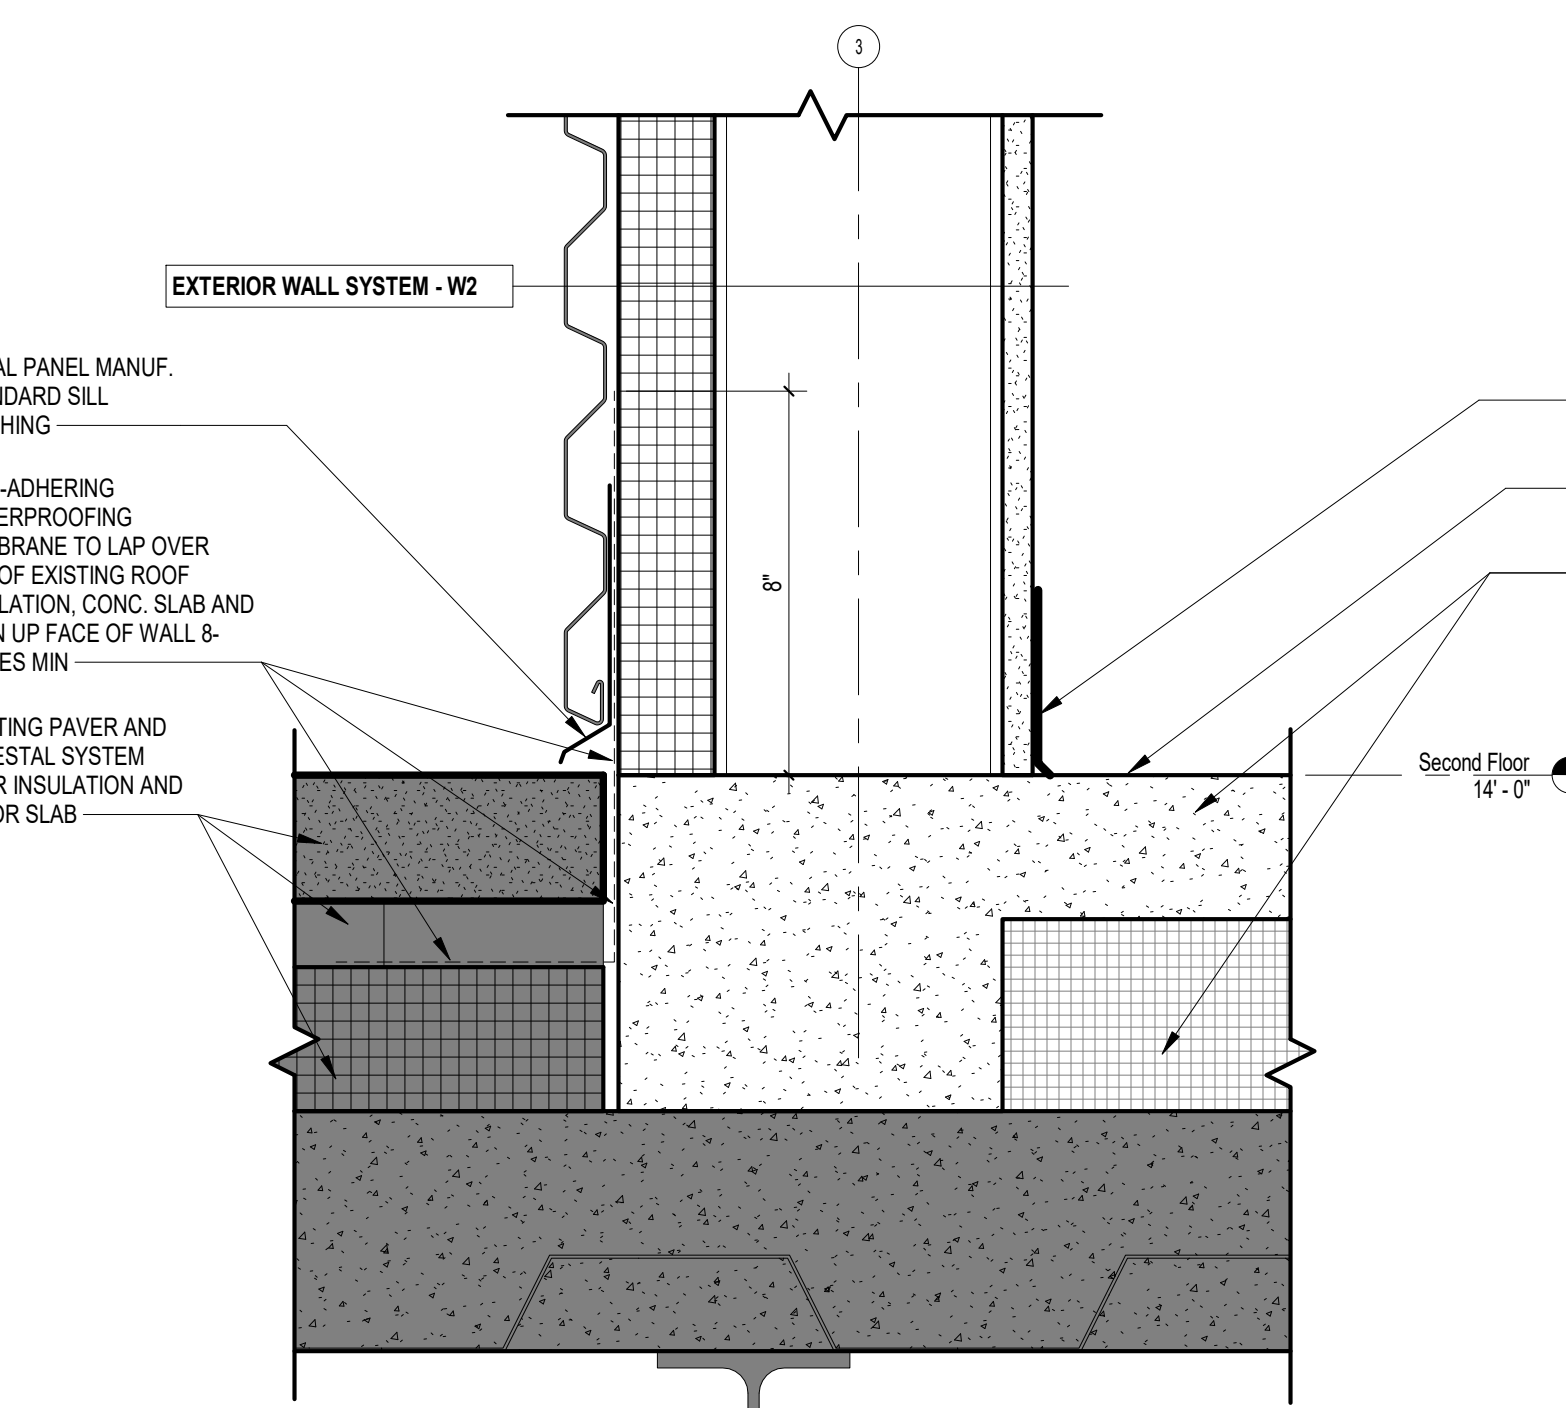
WALL SECTIONS




7 SECTION DETAIL - PARAPET
A6.2 1/12" = 1'-0" REFERENCED ON: A5.1

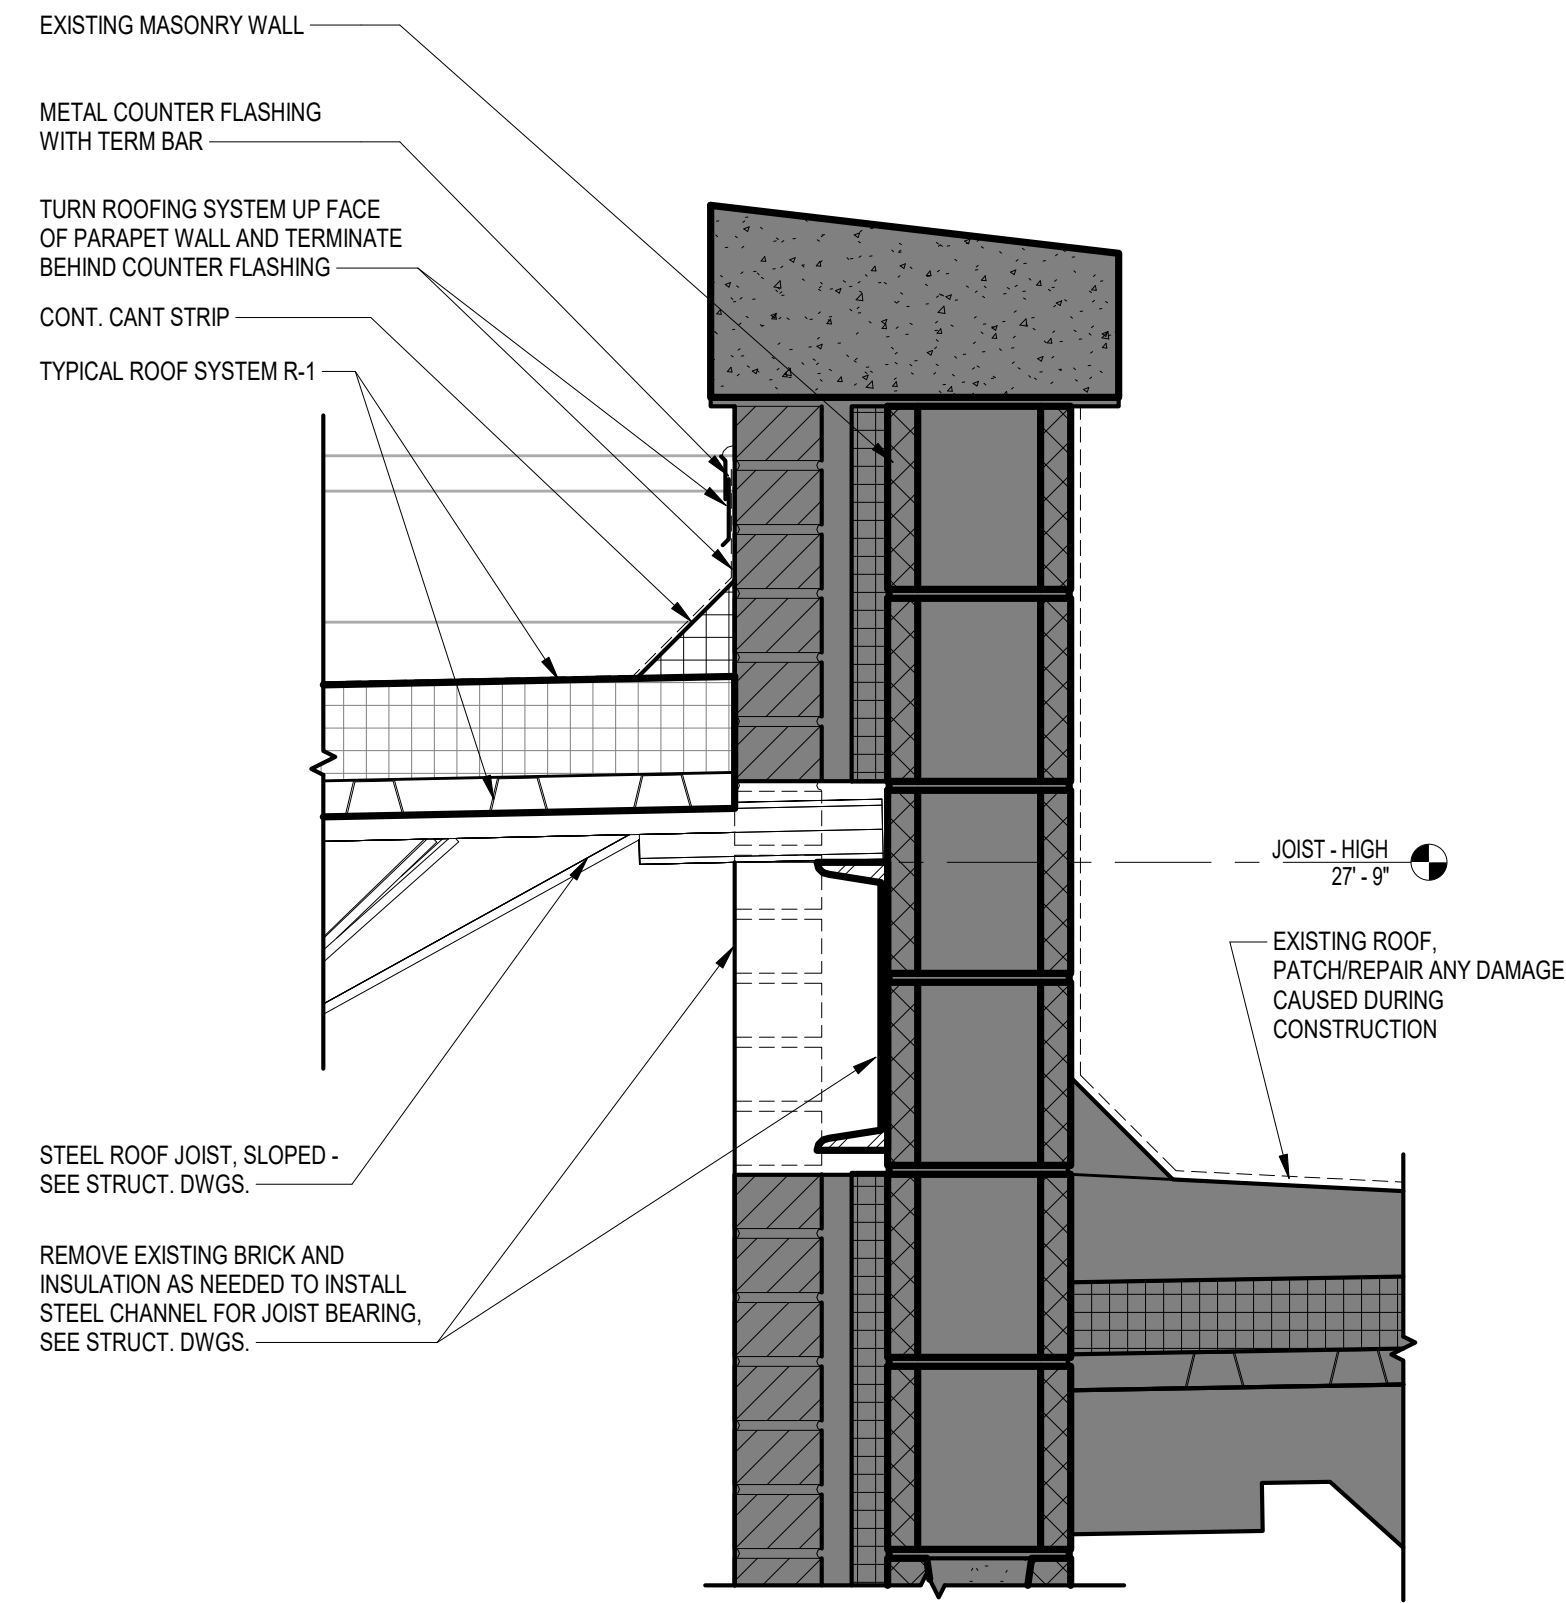


5 SILL SECTION DETAIL
A6.2 3" = 1'-0" REFERENCED ON: A7.1




4 SECTION DETAIL
A6.2 3" = 1'-0" REFERENCED ON: A6.1

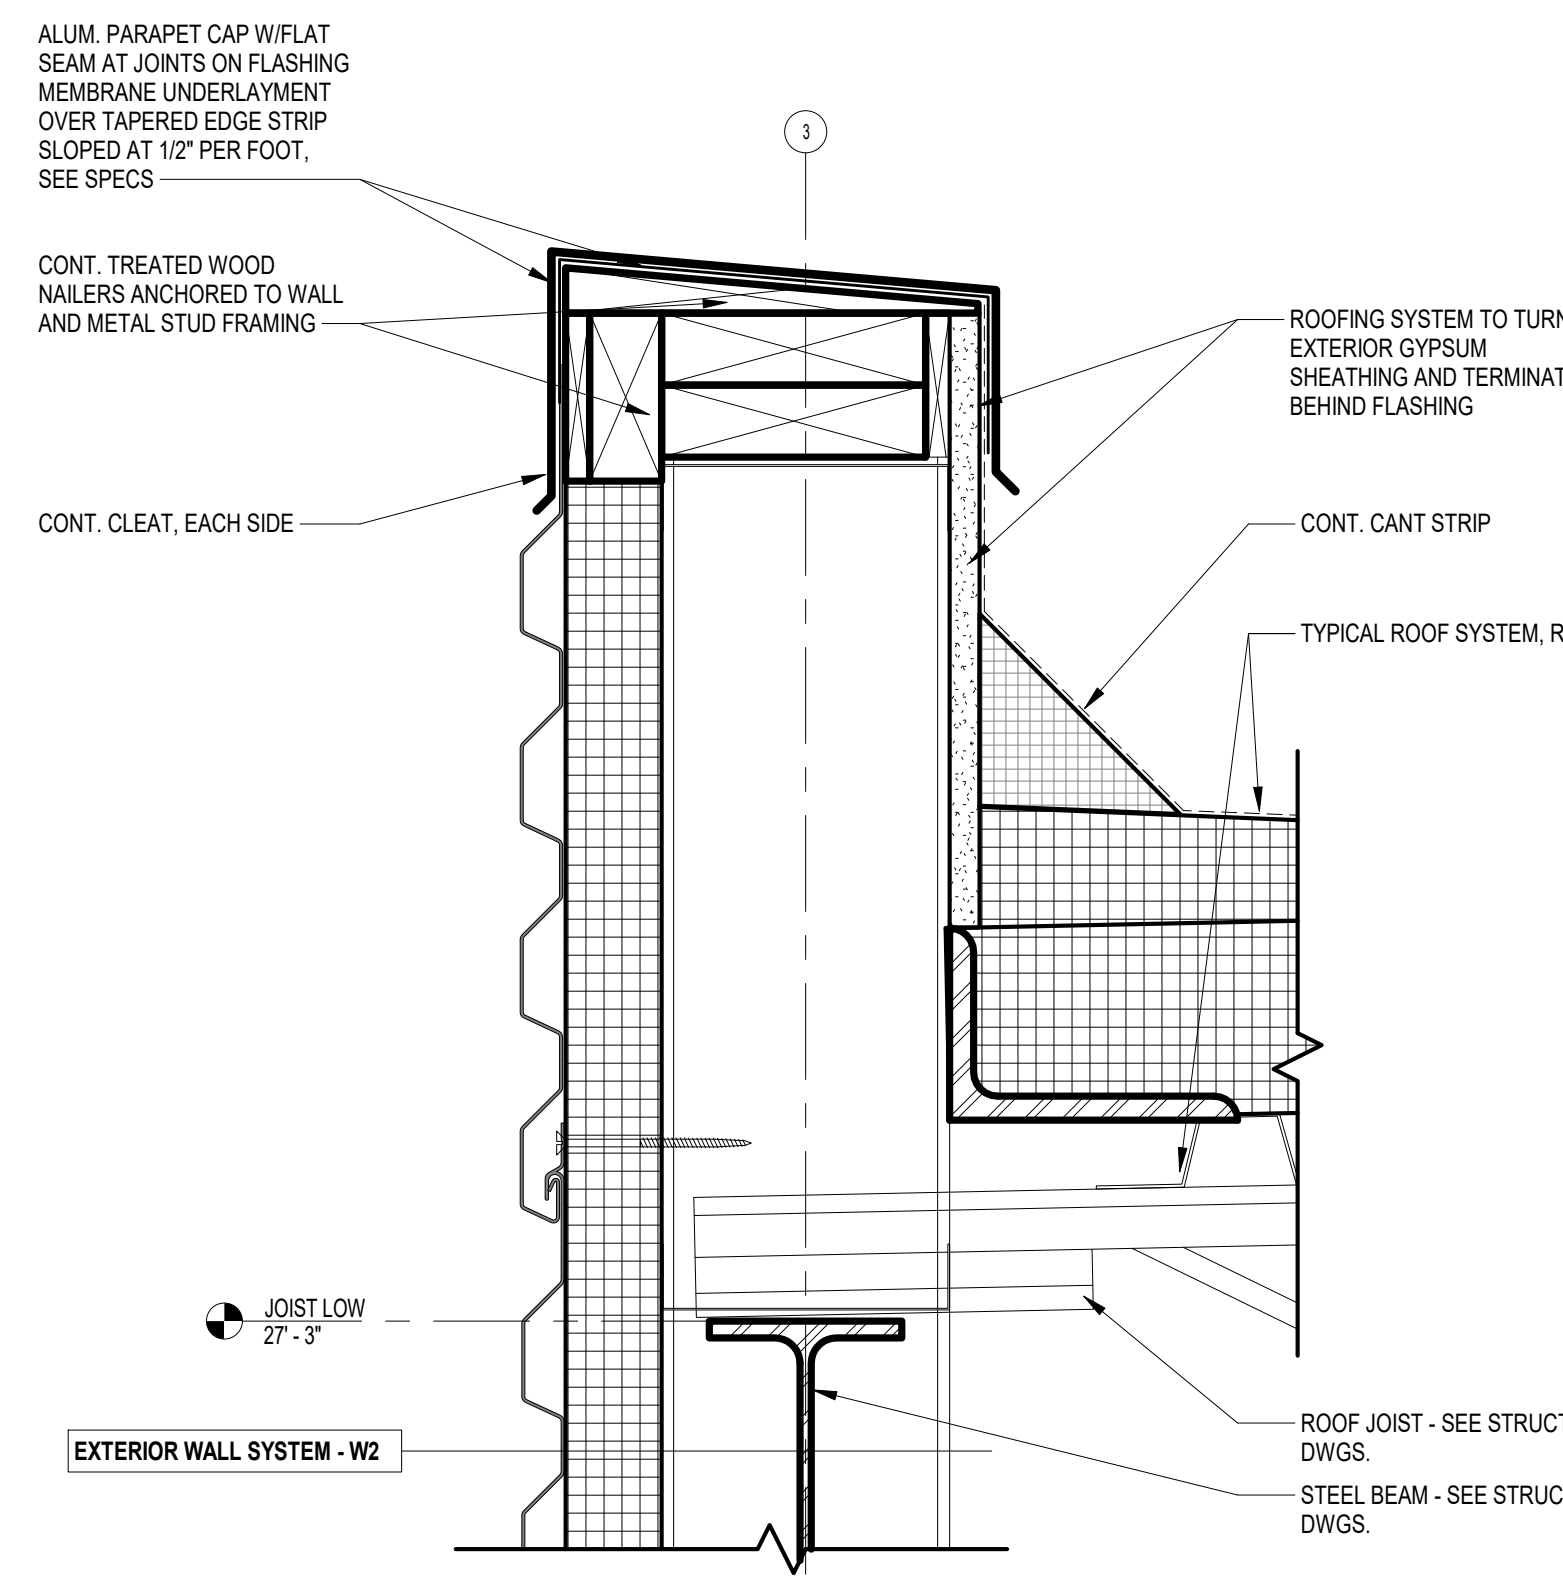


6 SECTION DETAIL - PARAPET
A6.2 3" = 1'-0" REFERENCED ON: A1.3

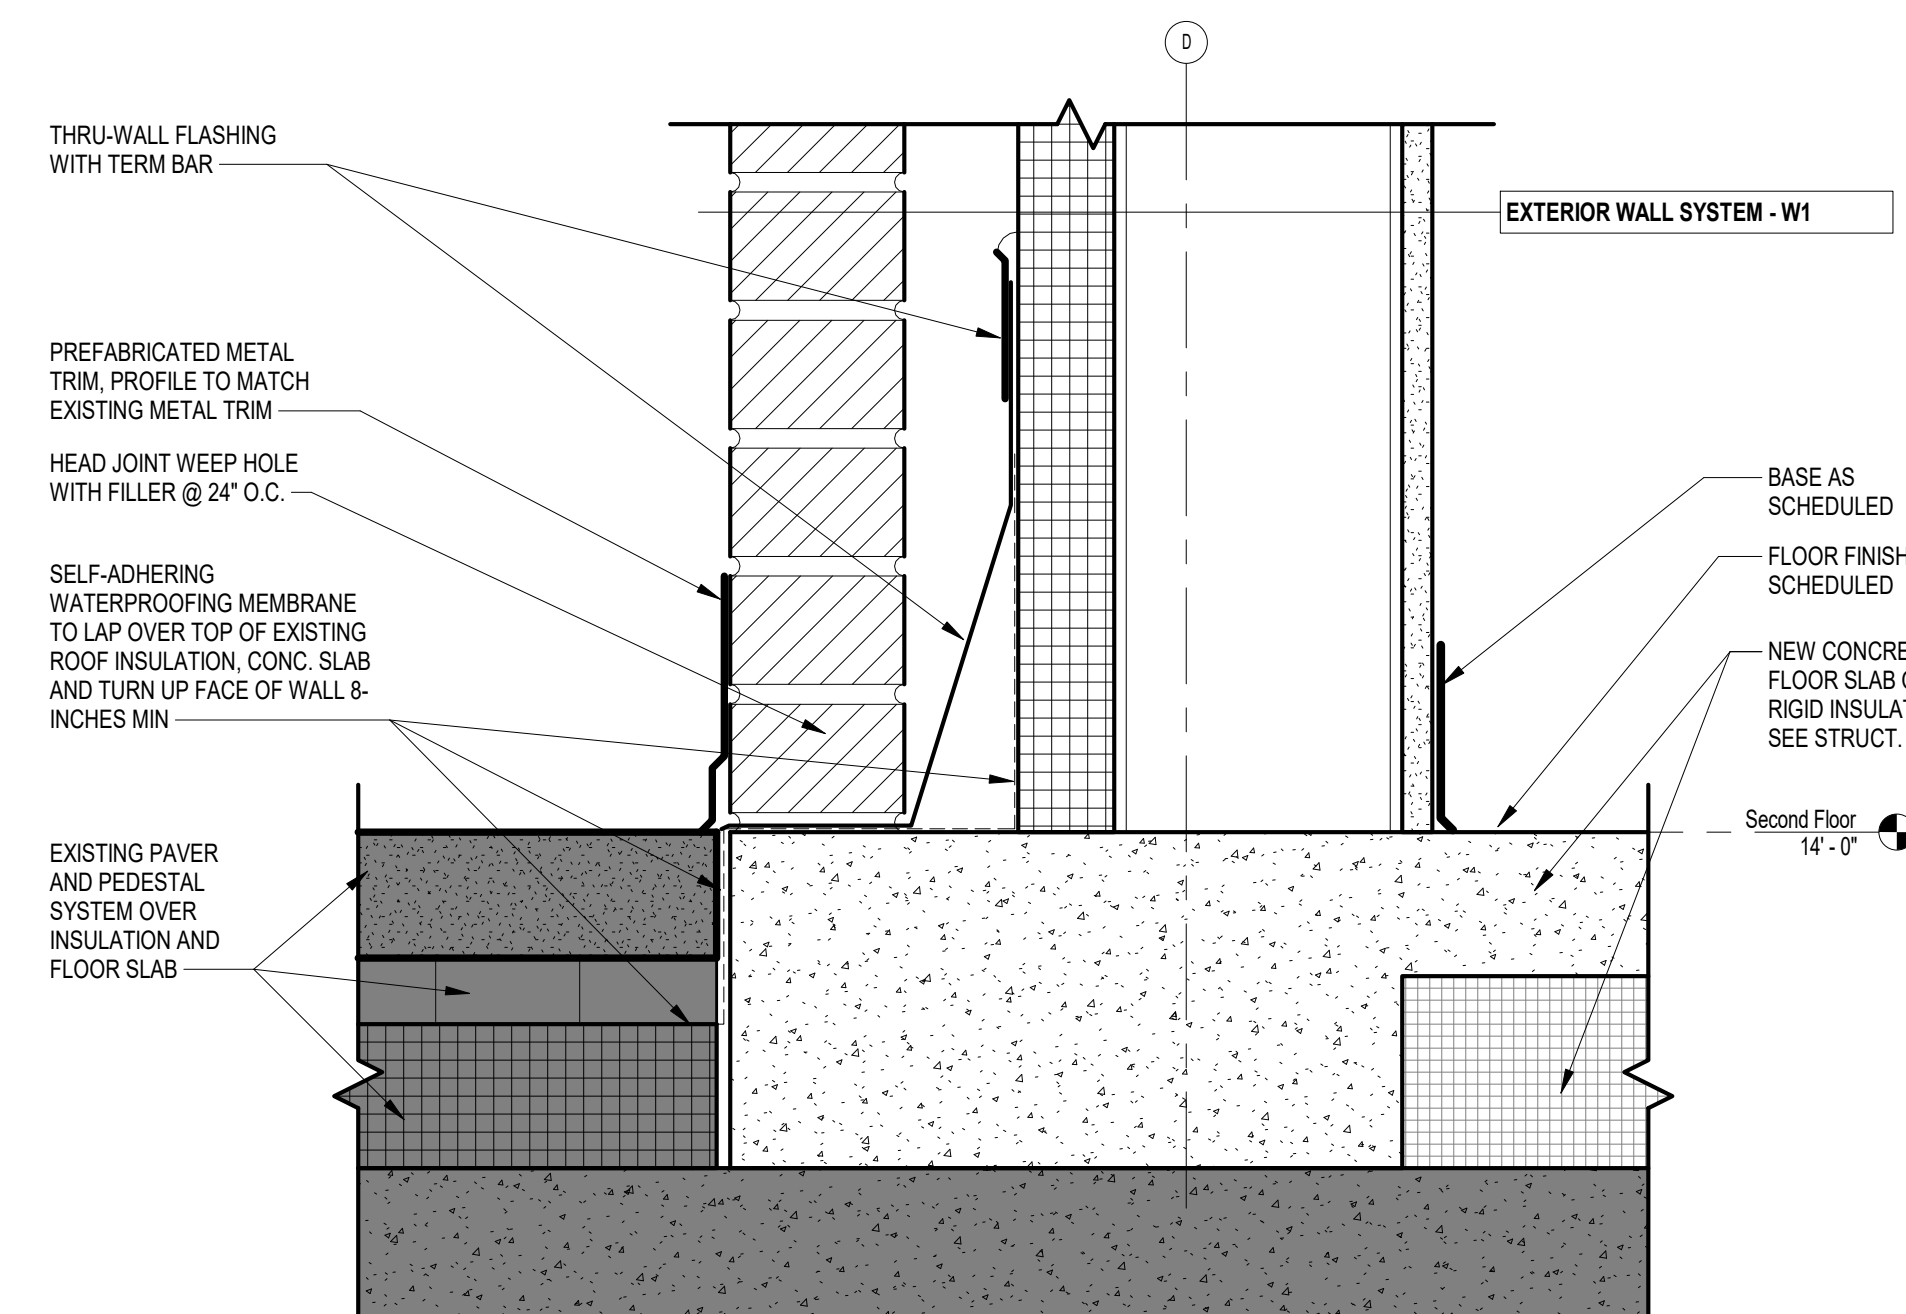

3 SECTION DETAIL
A6.2 3" = 1'-0" REFERENCED ON: A6.1

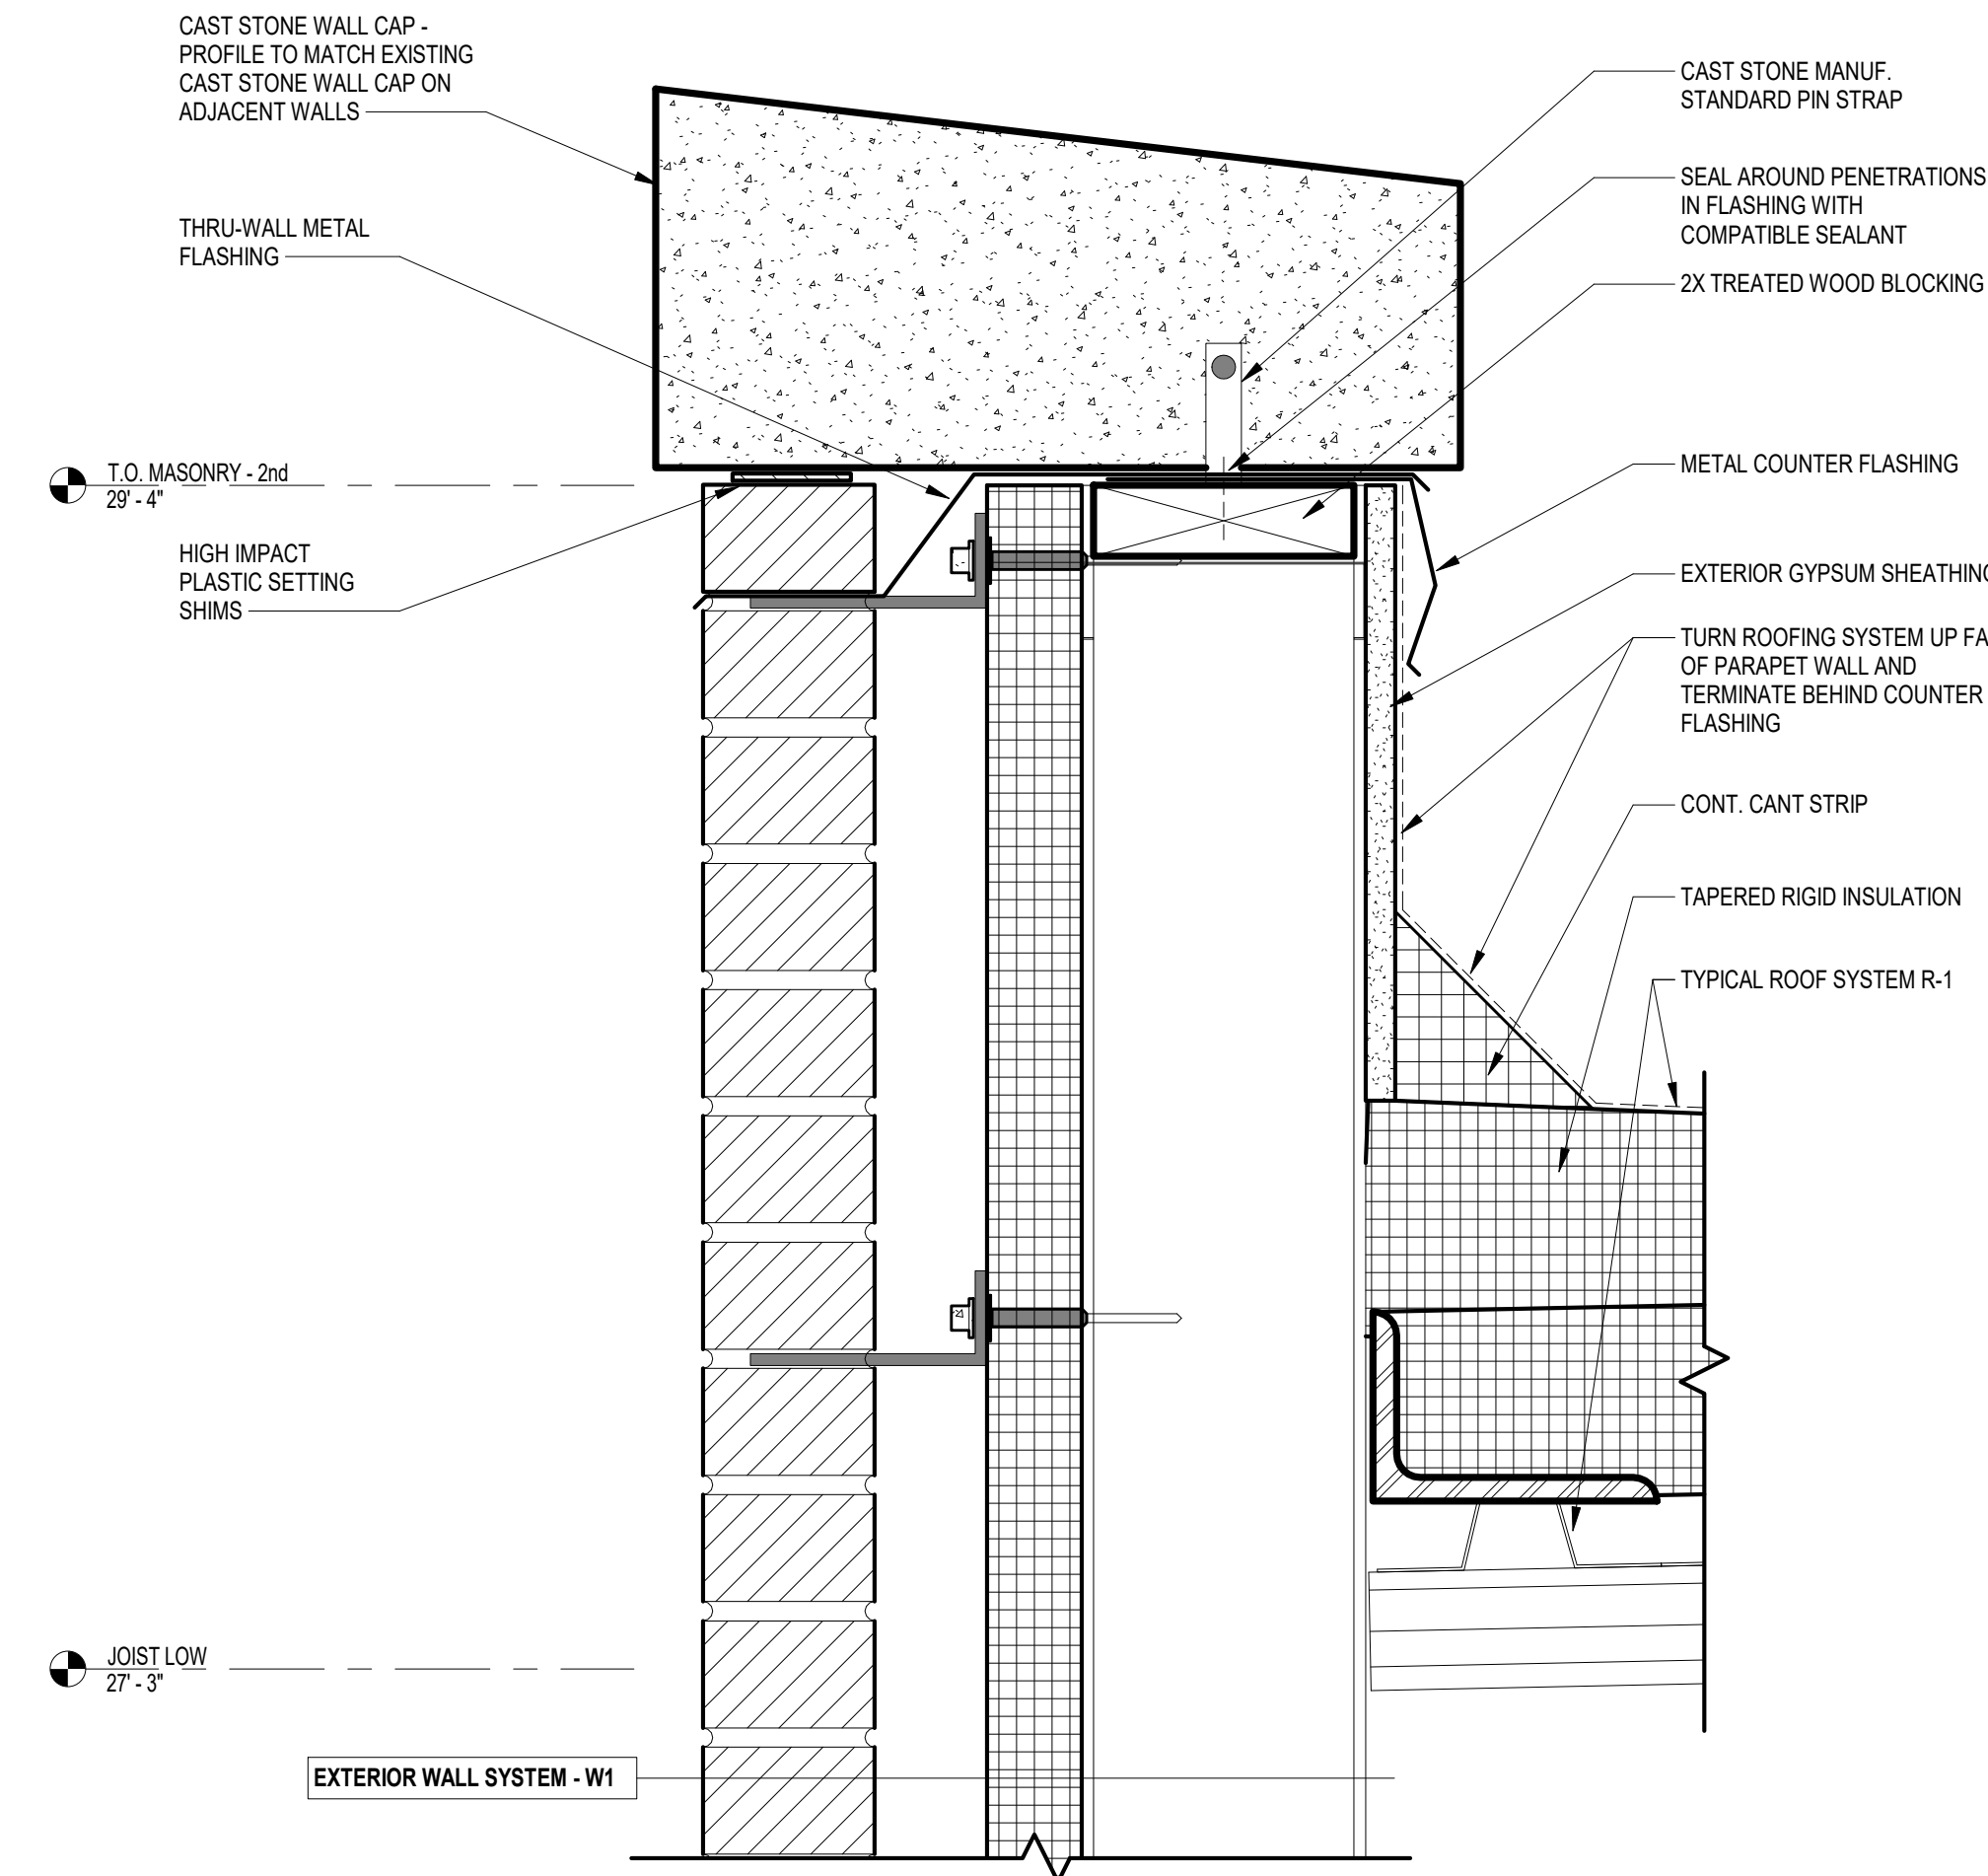

1 SECTION DETAIL - PARAPET
A6.2 3" = 1'-0" REFERENCED ON: A1.3

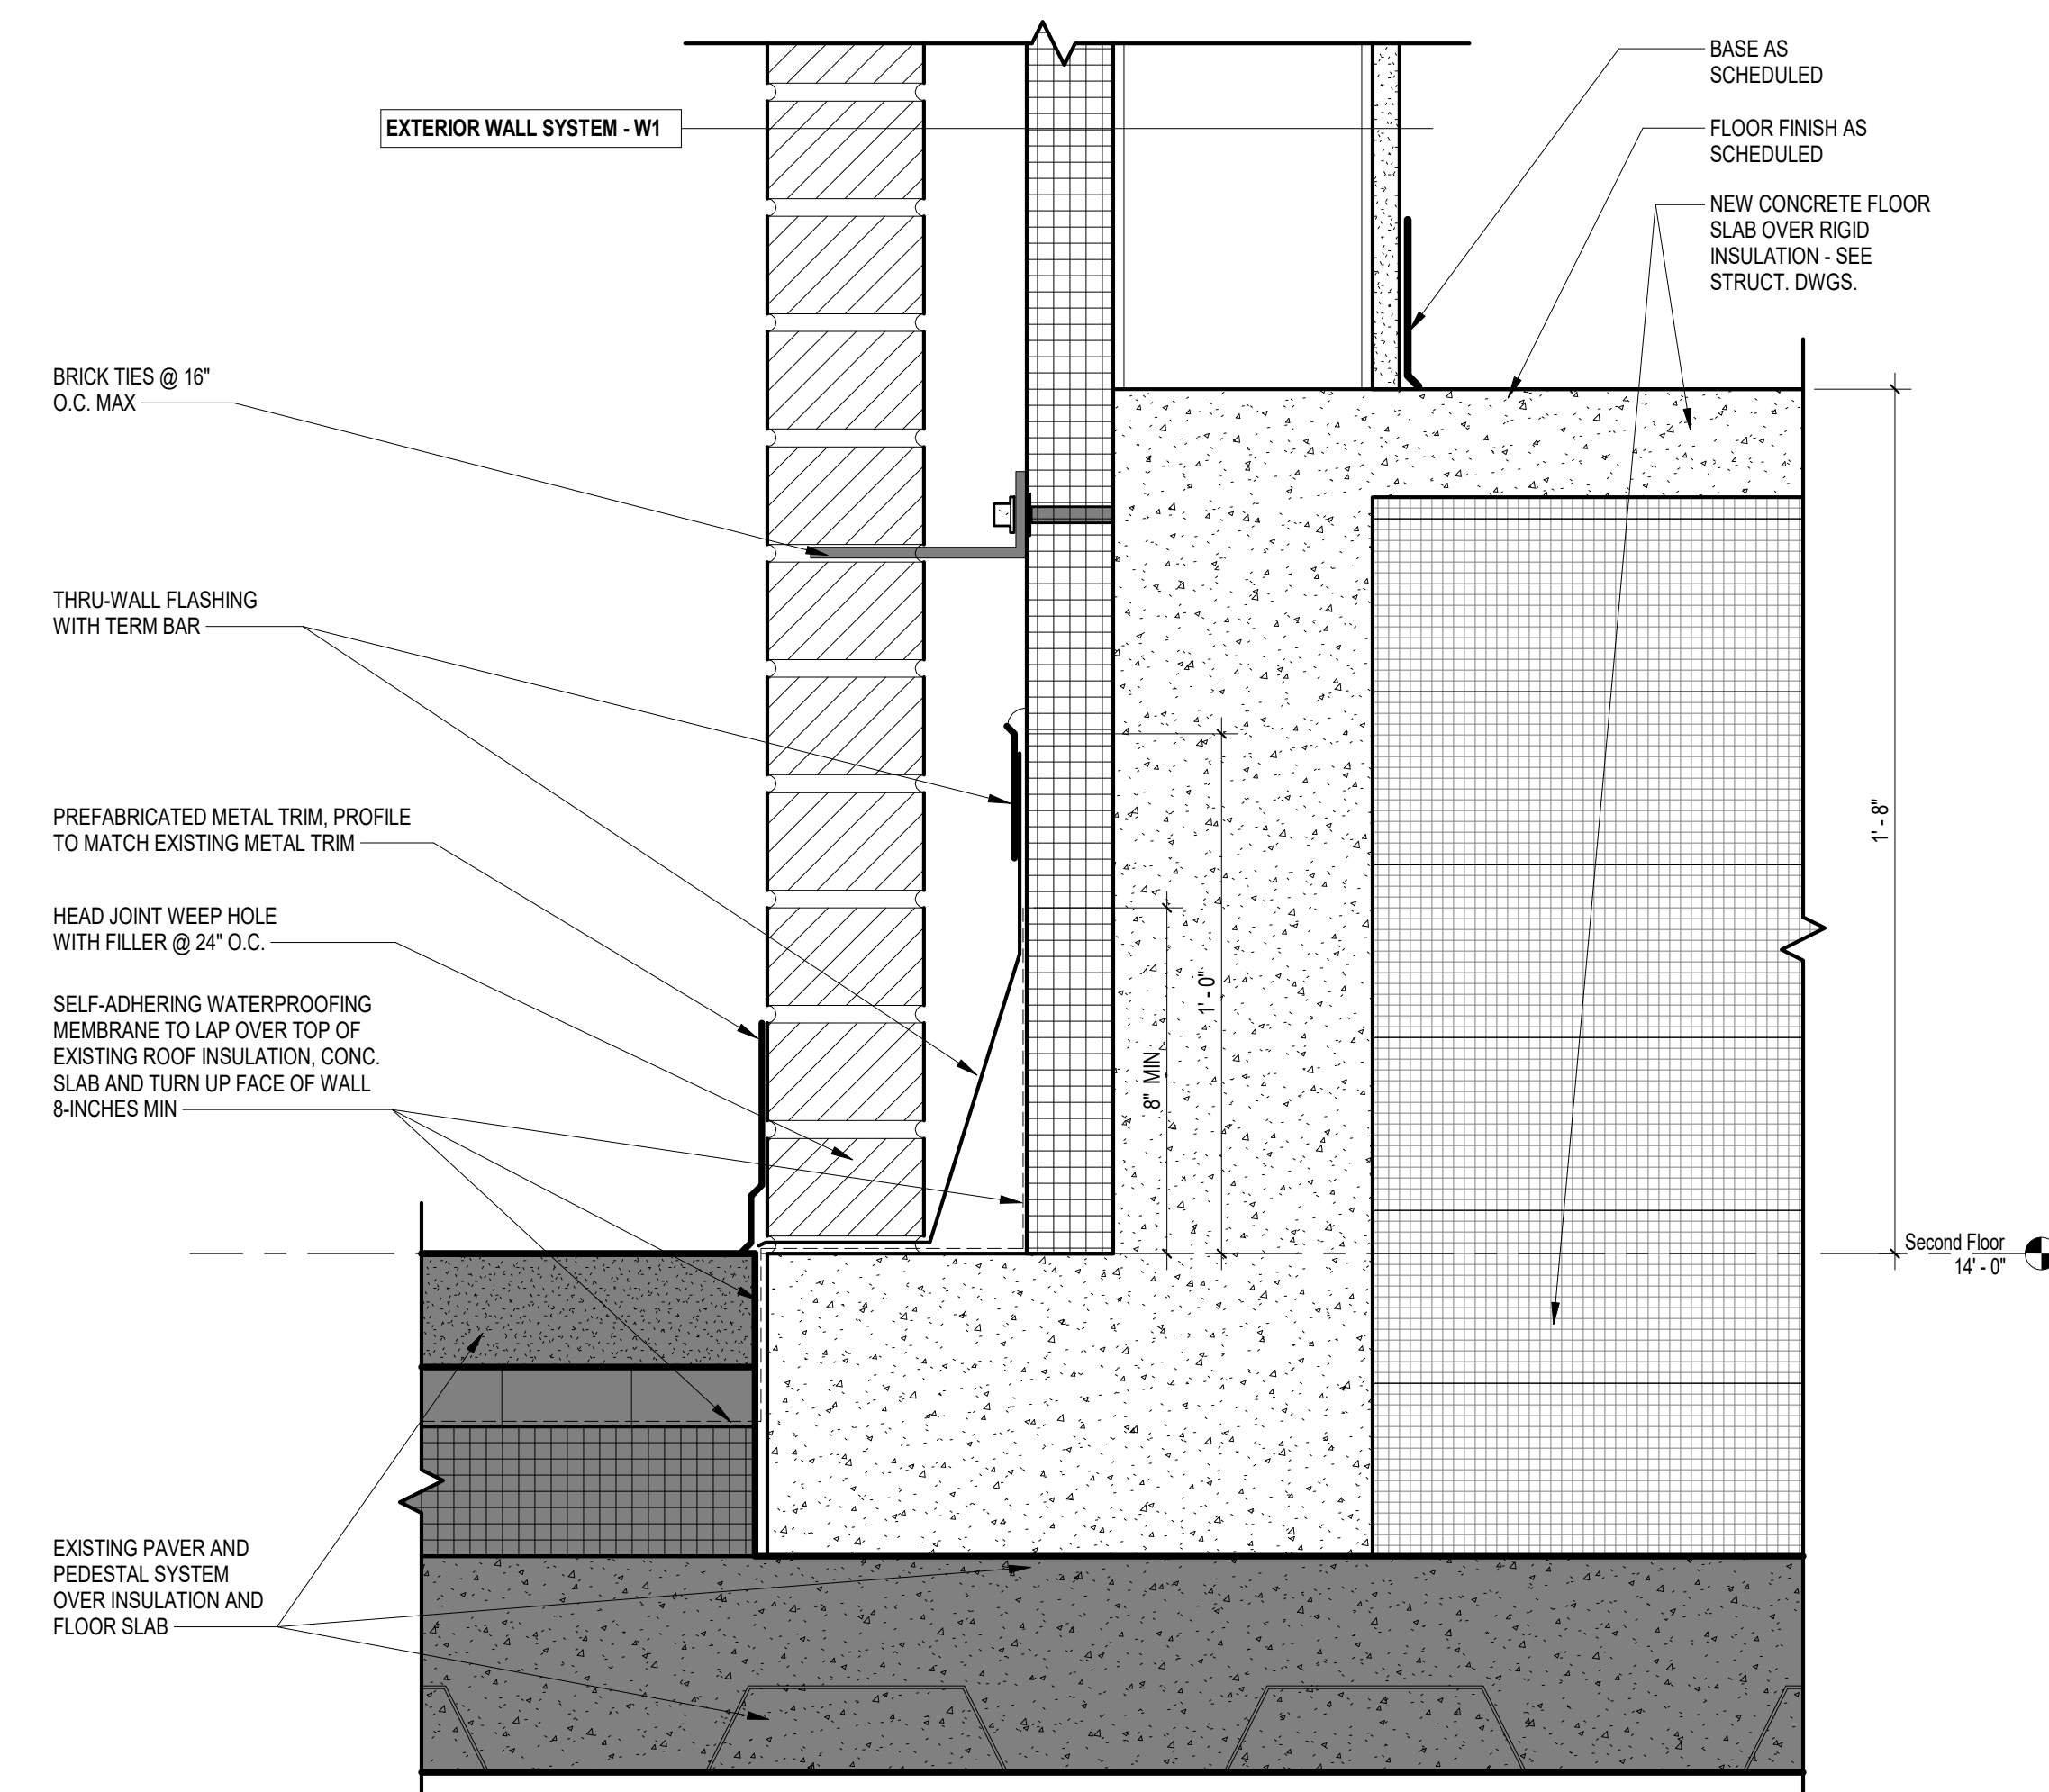

2 SECTION DETAIL
A6.2 3" = 1'-0" REFERENCED ON: A6.1

NO.	REVISIONS	NAME	DATE

DRAWN BY: AUTHZ
CHECKED BY: CHECKED
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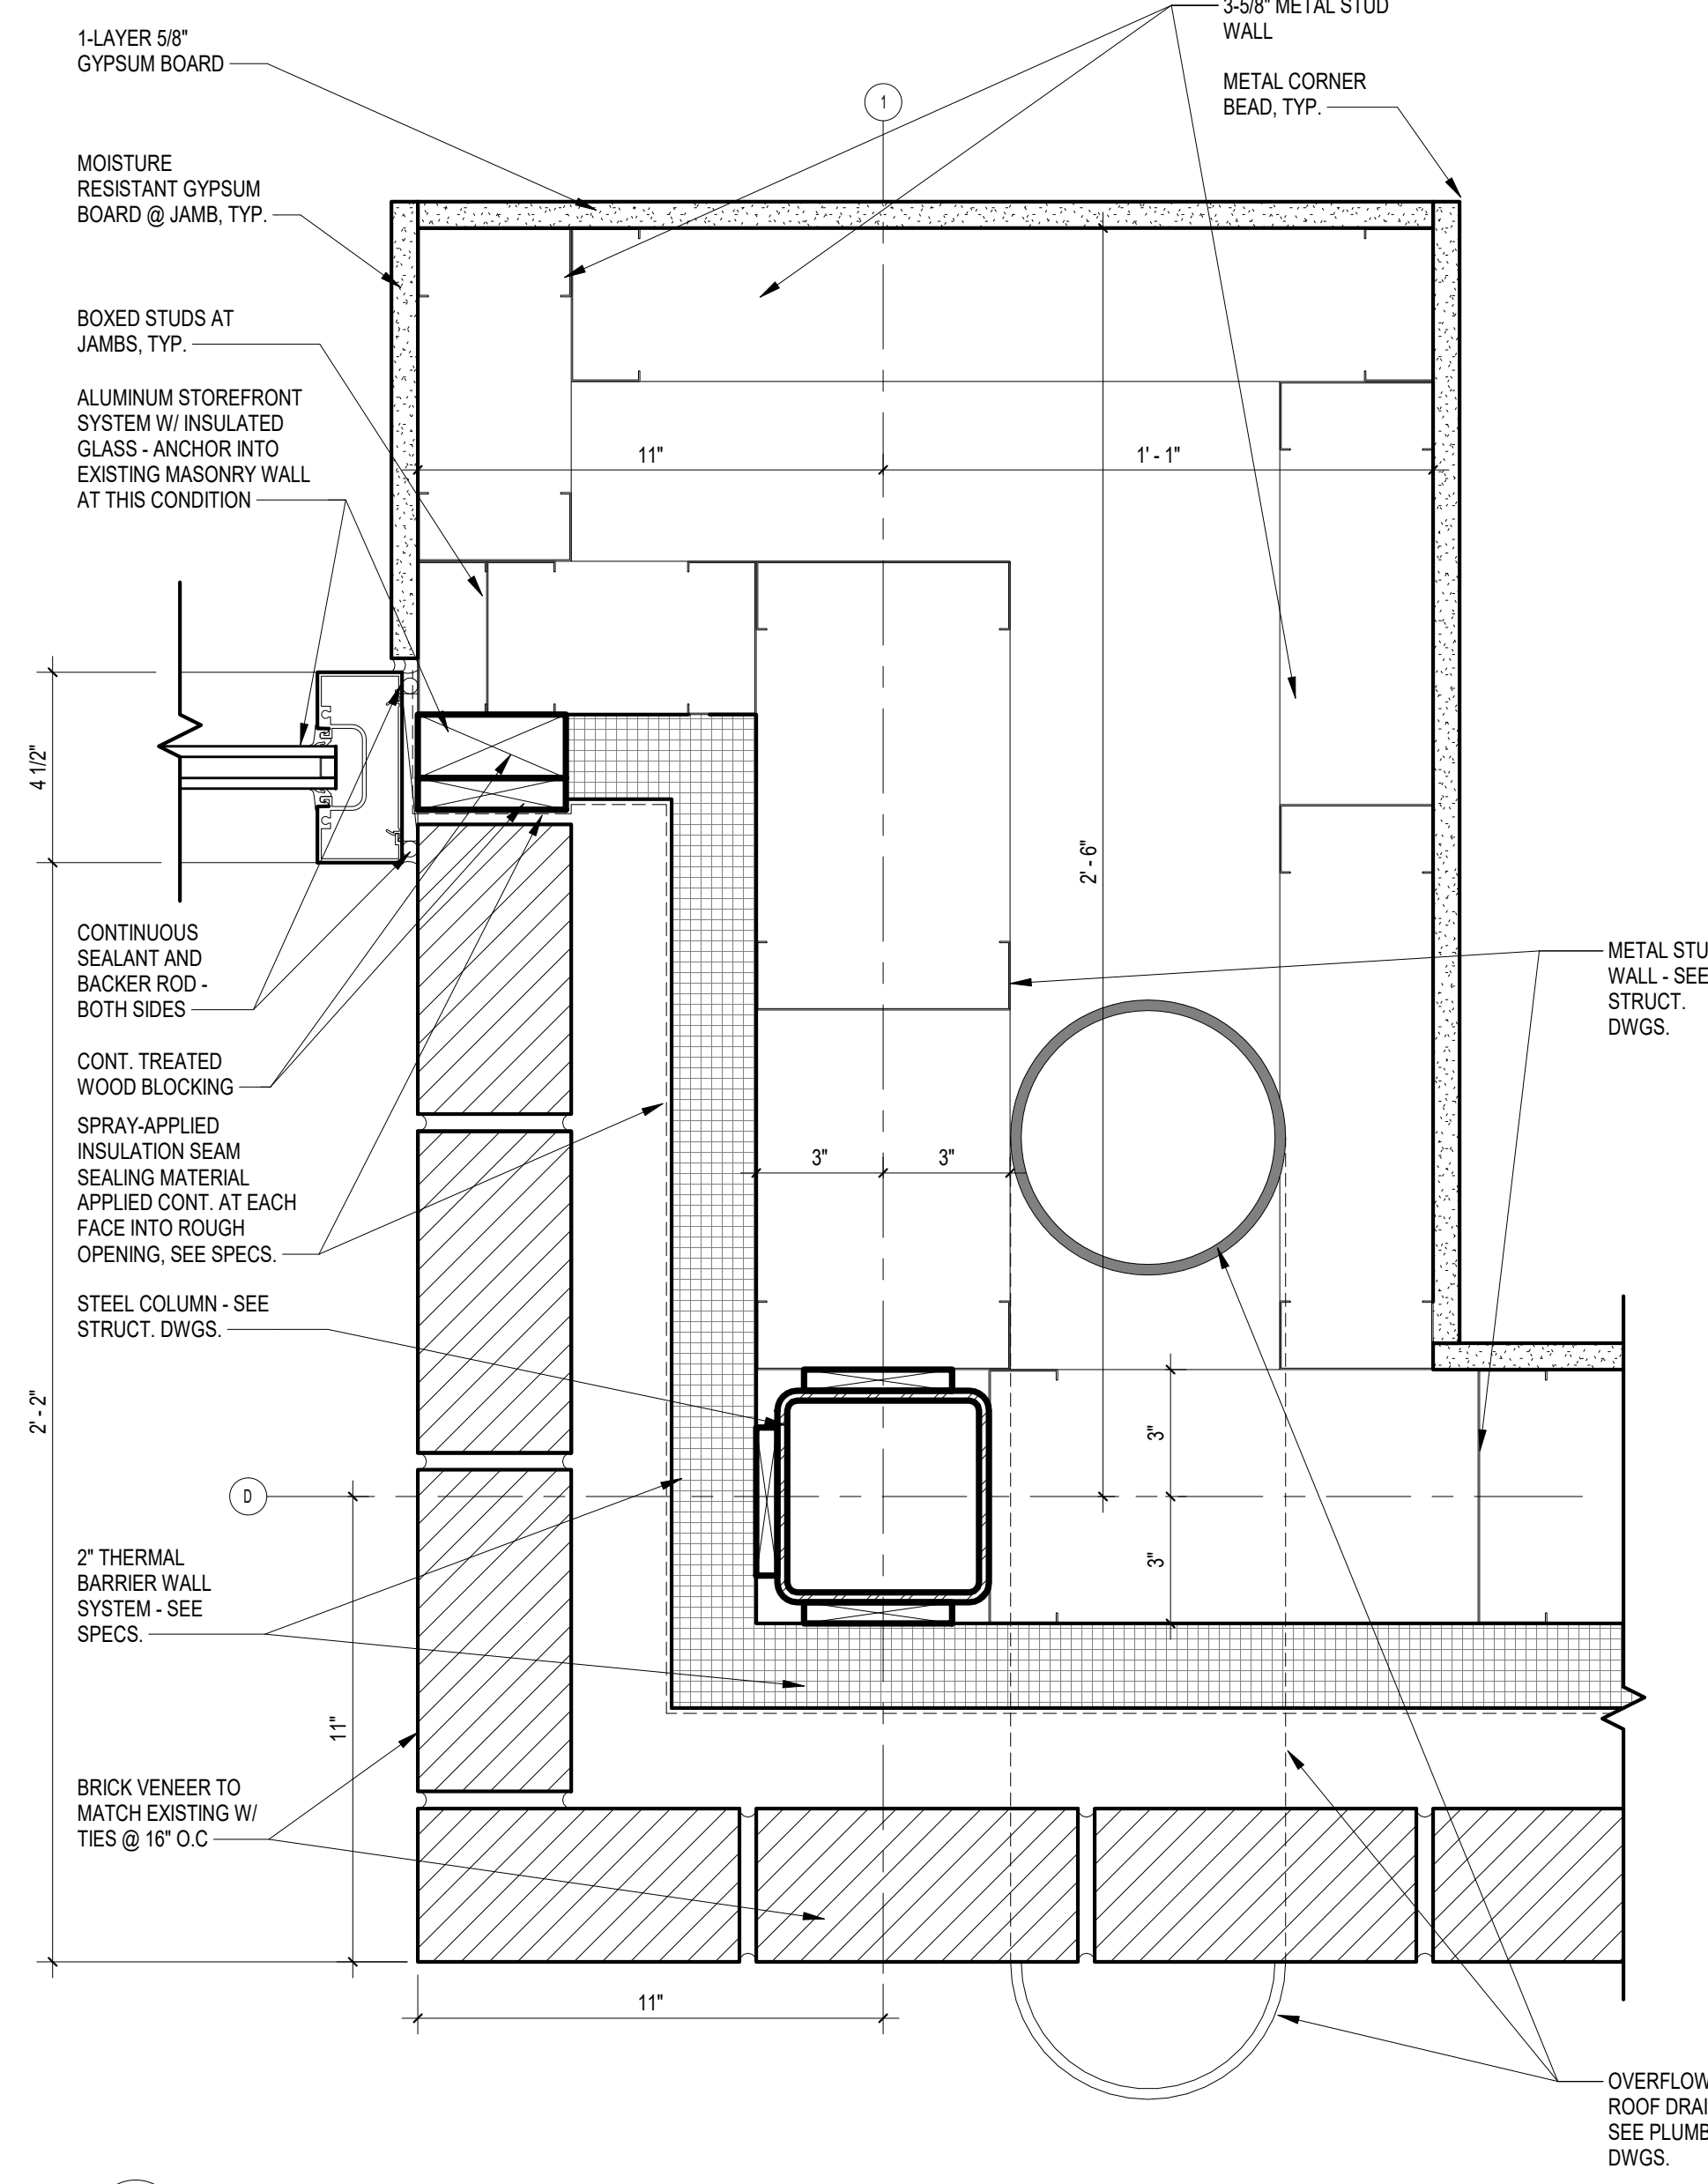
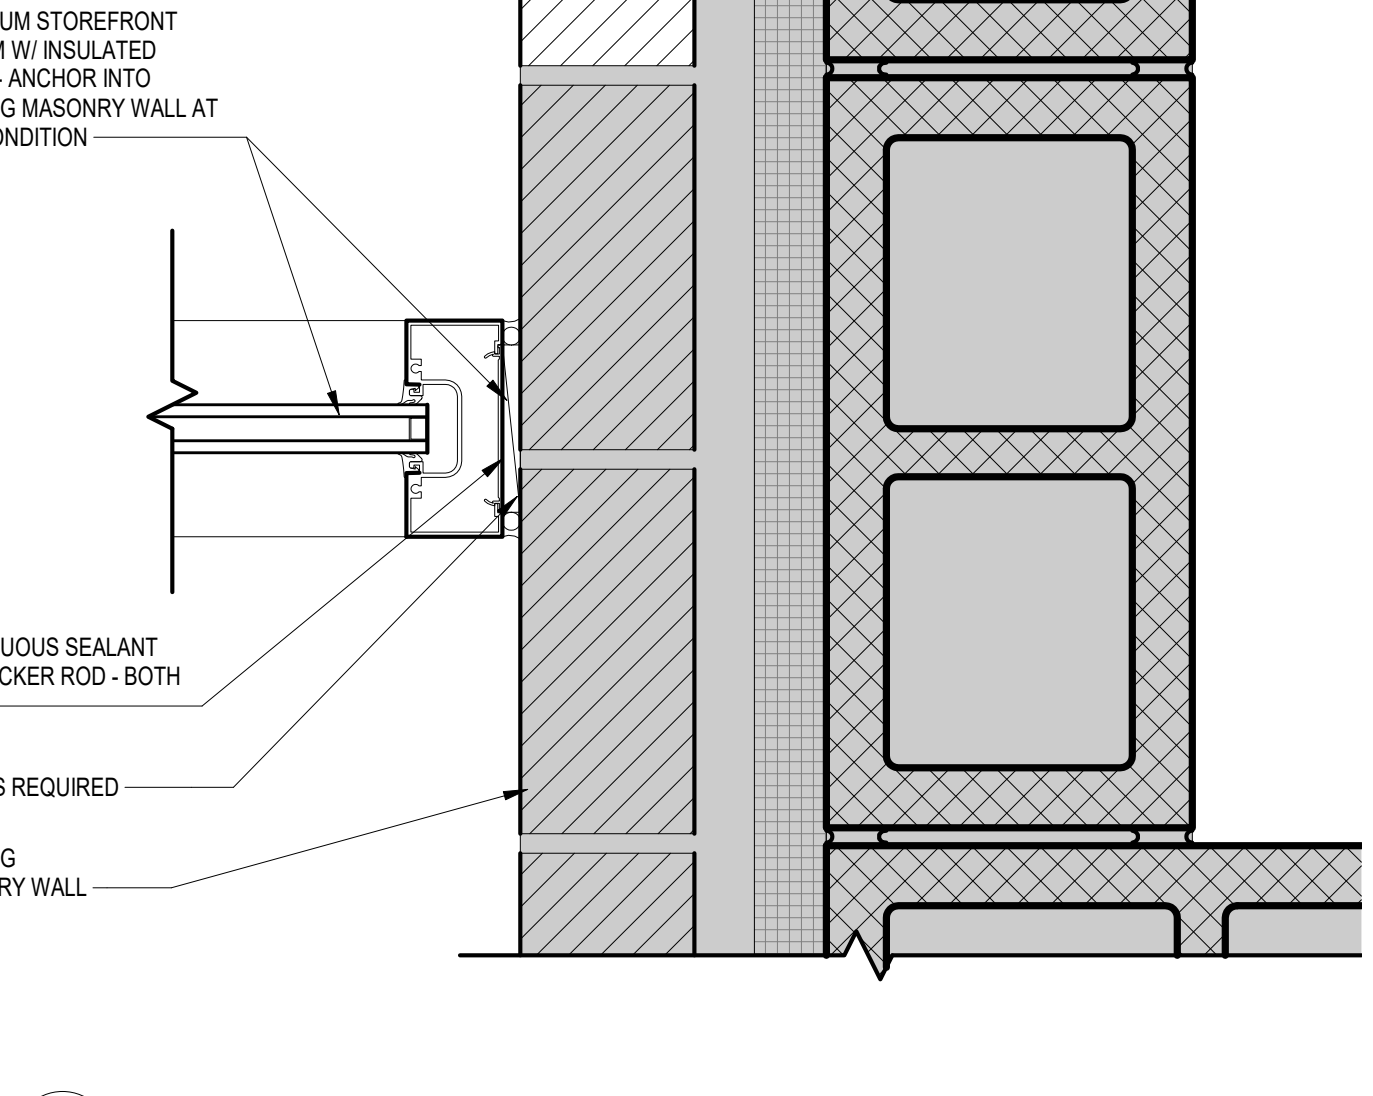
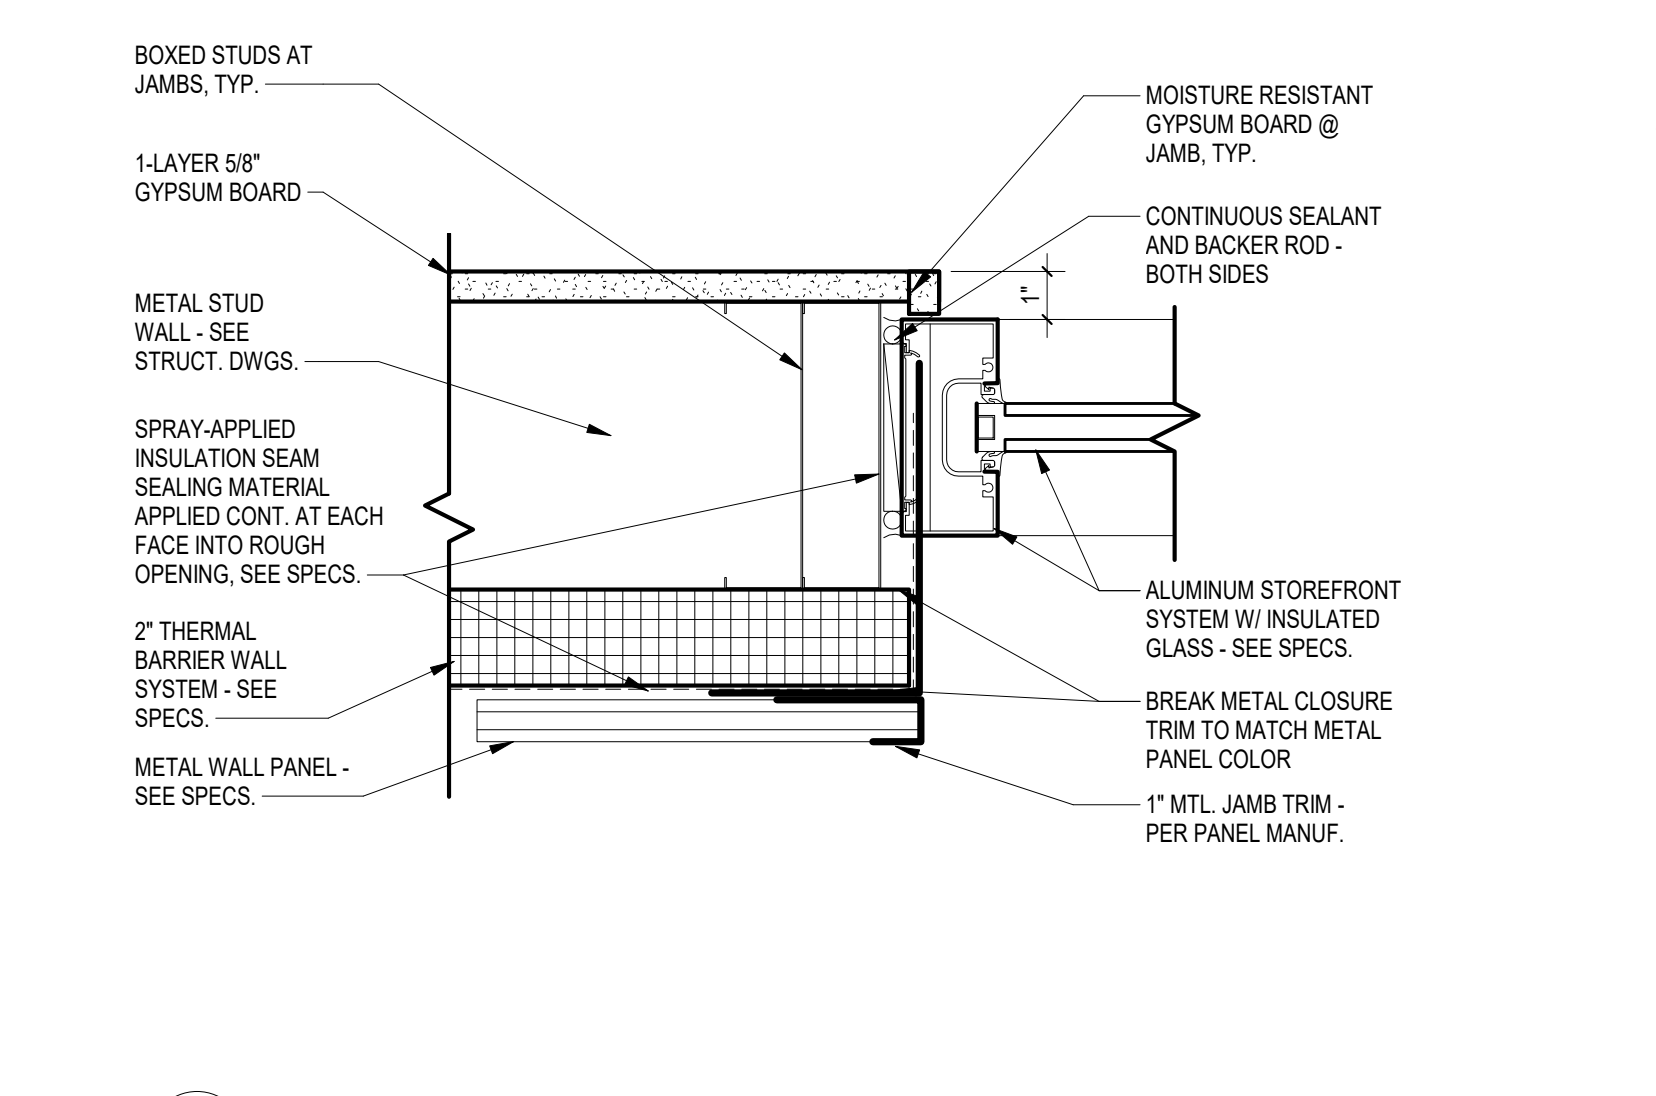
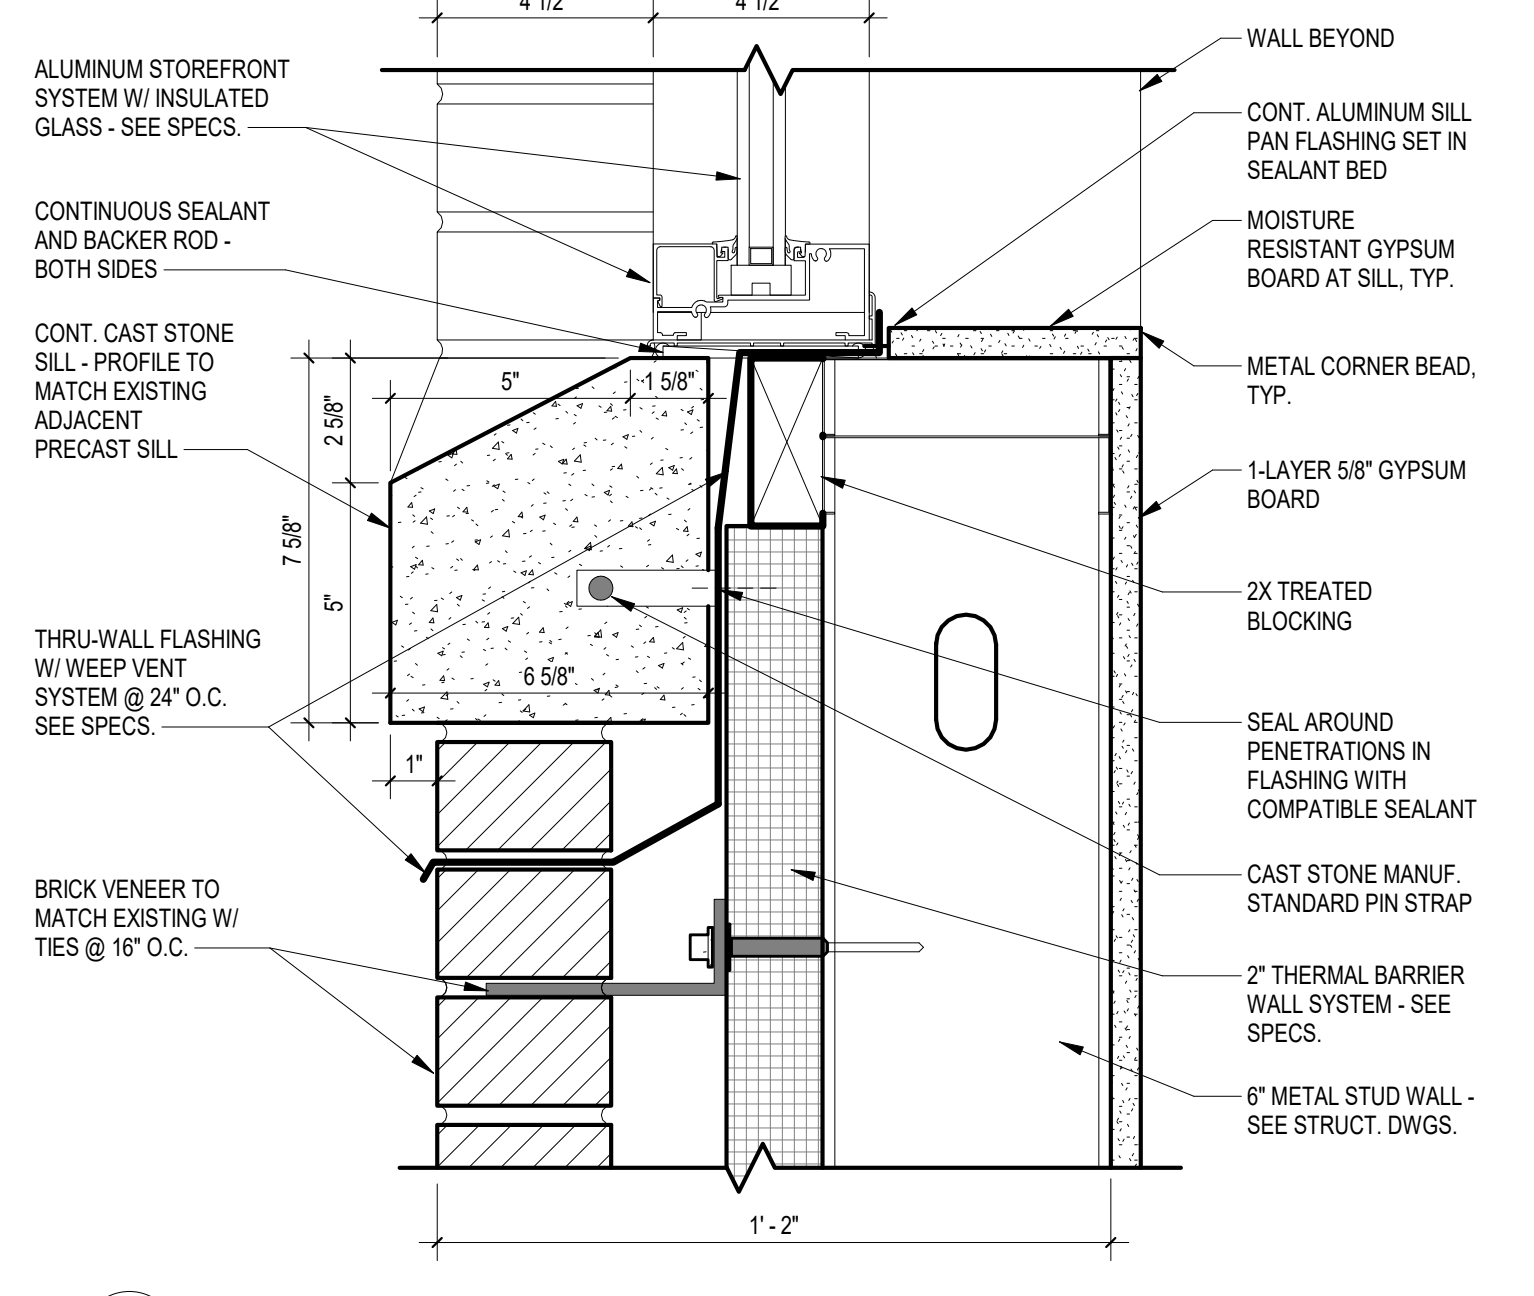
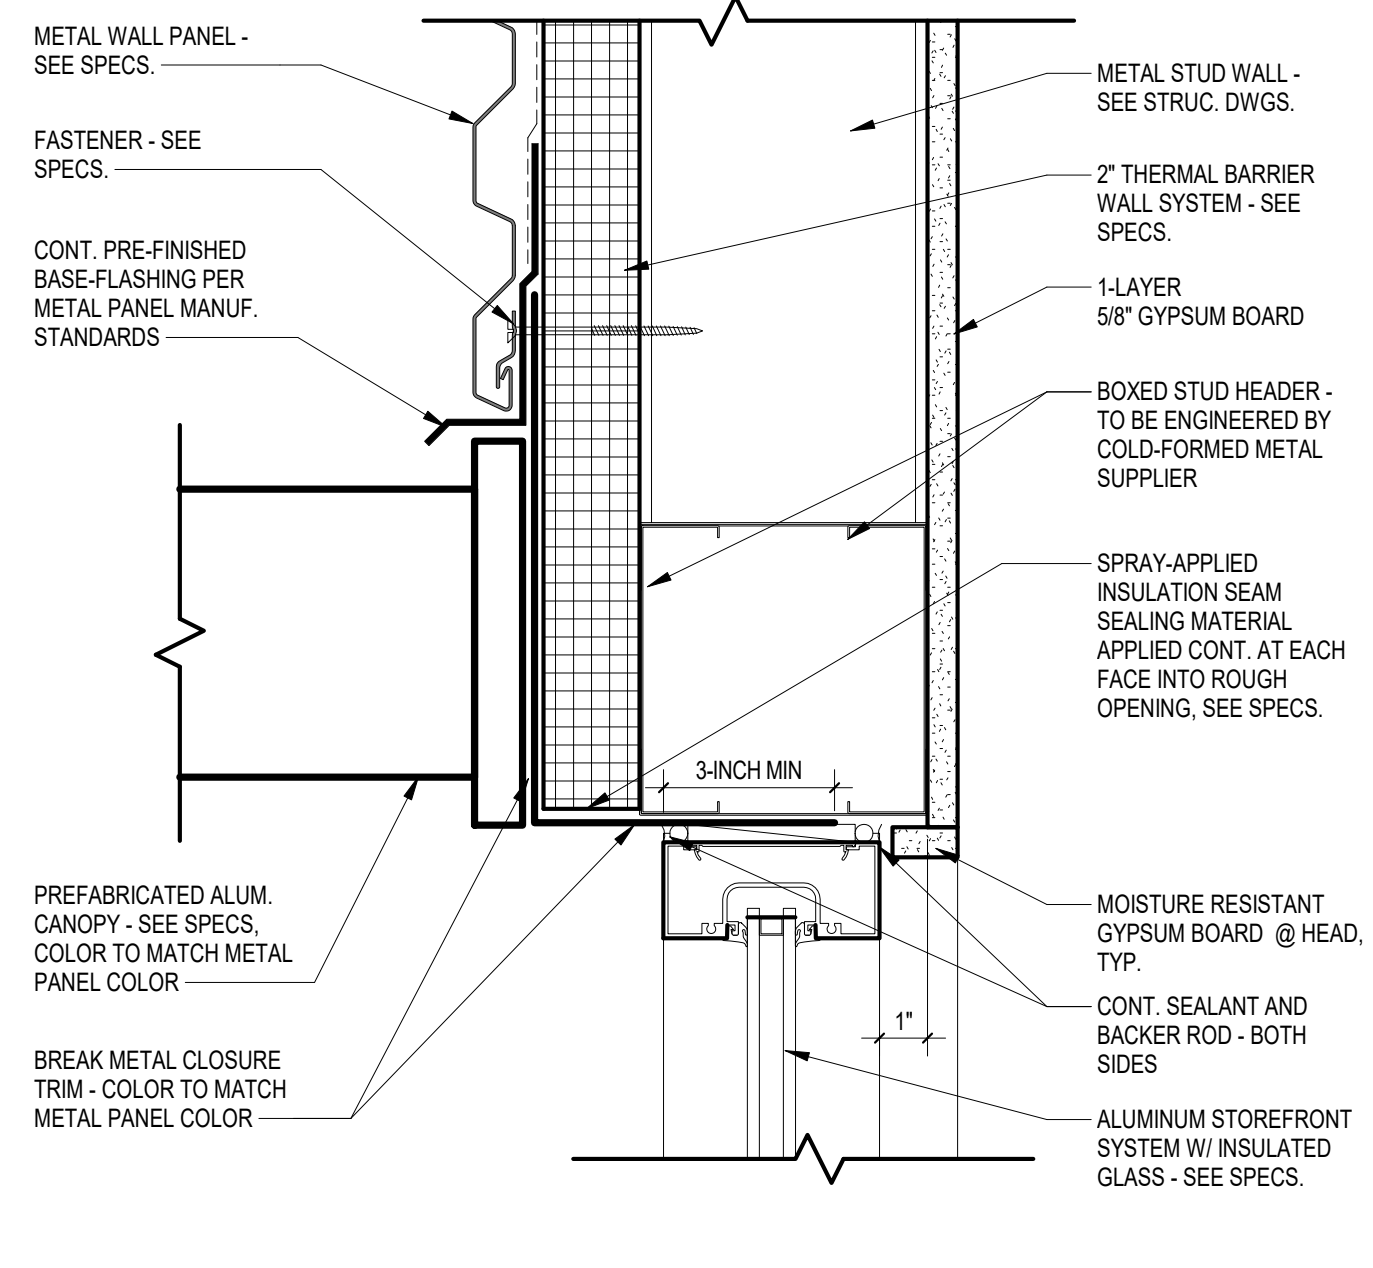
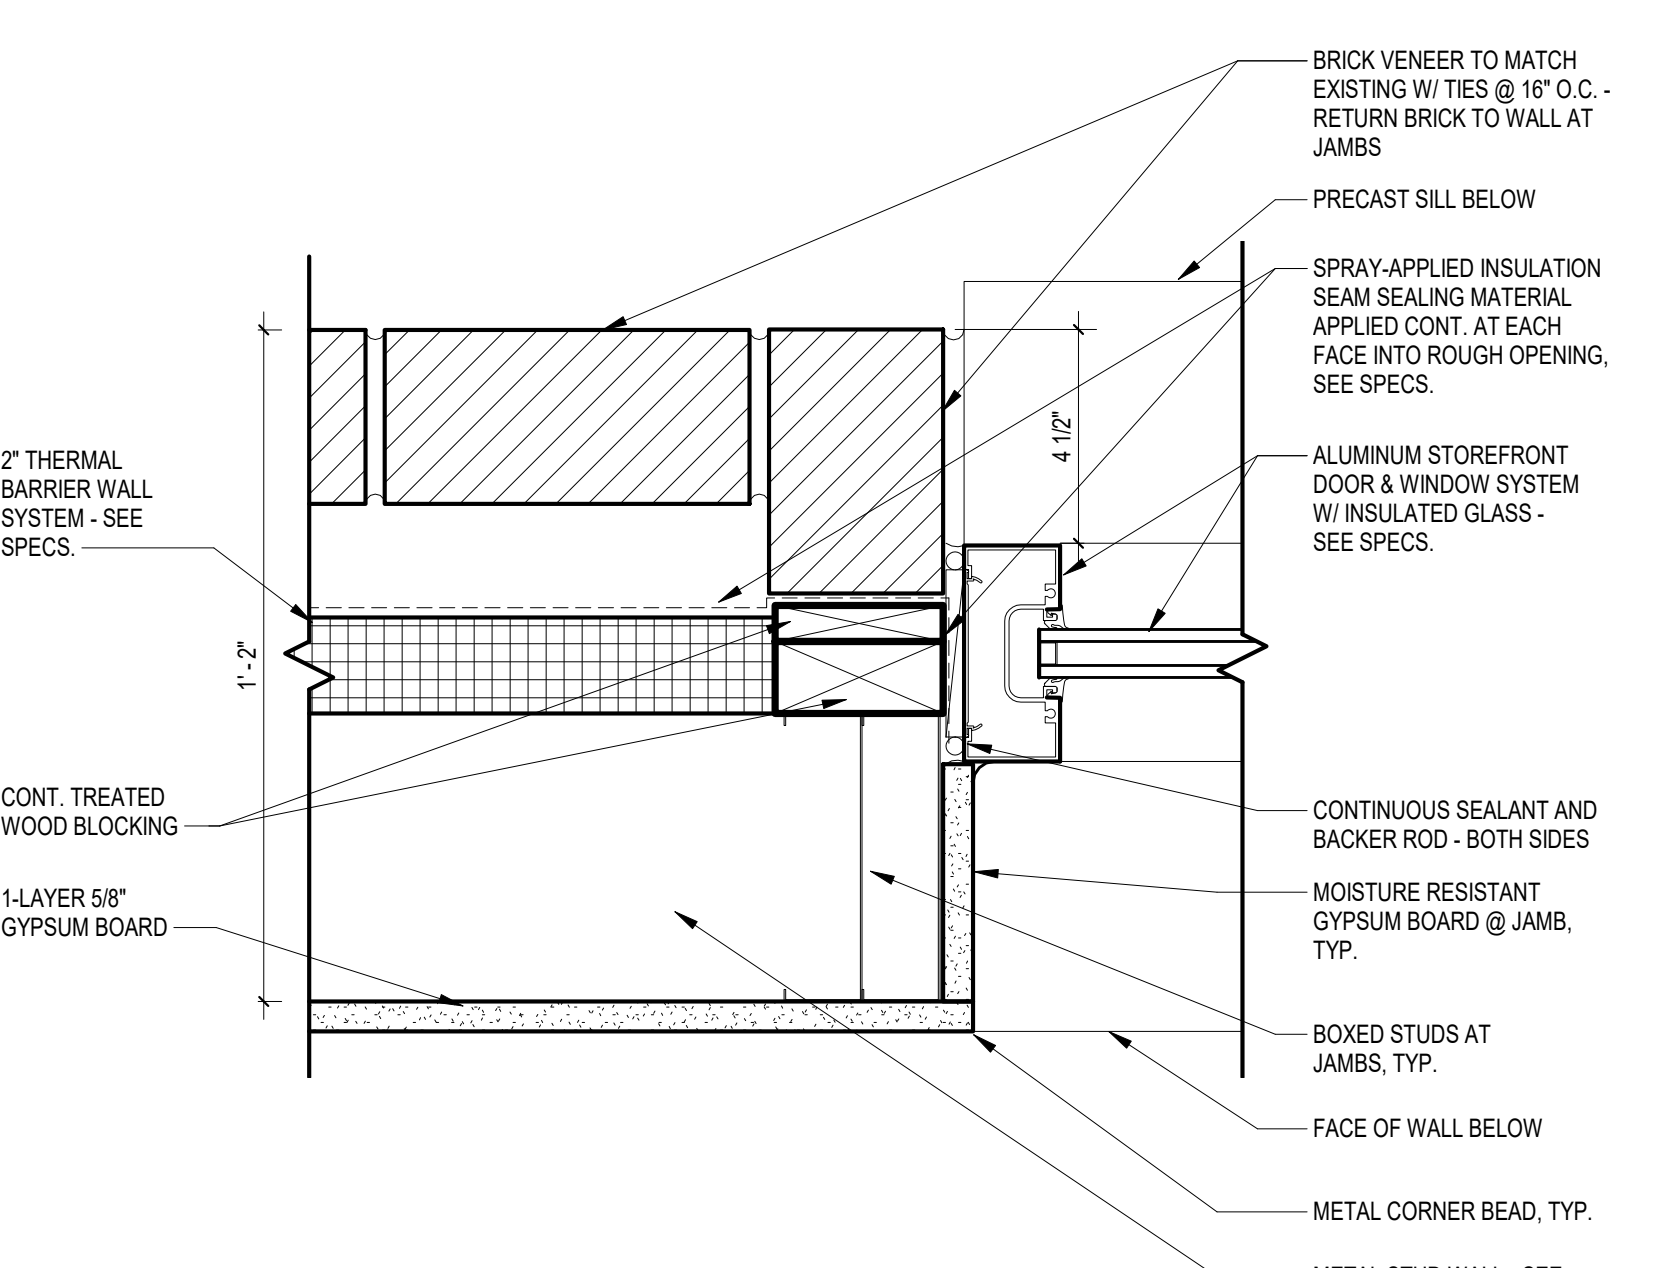
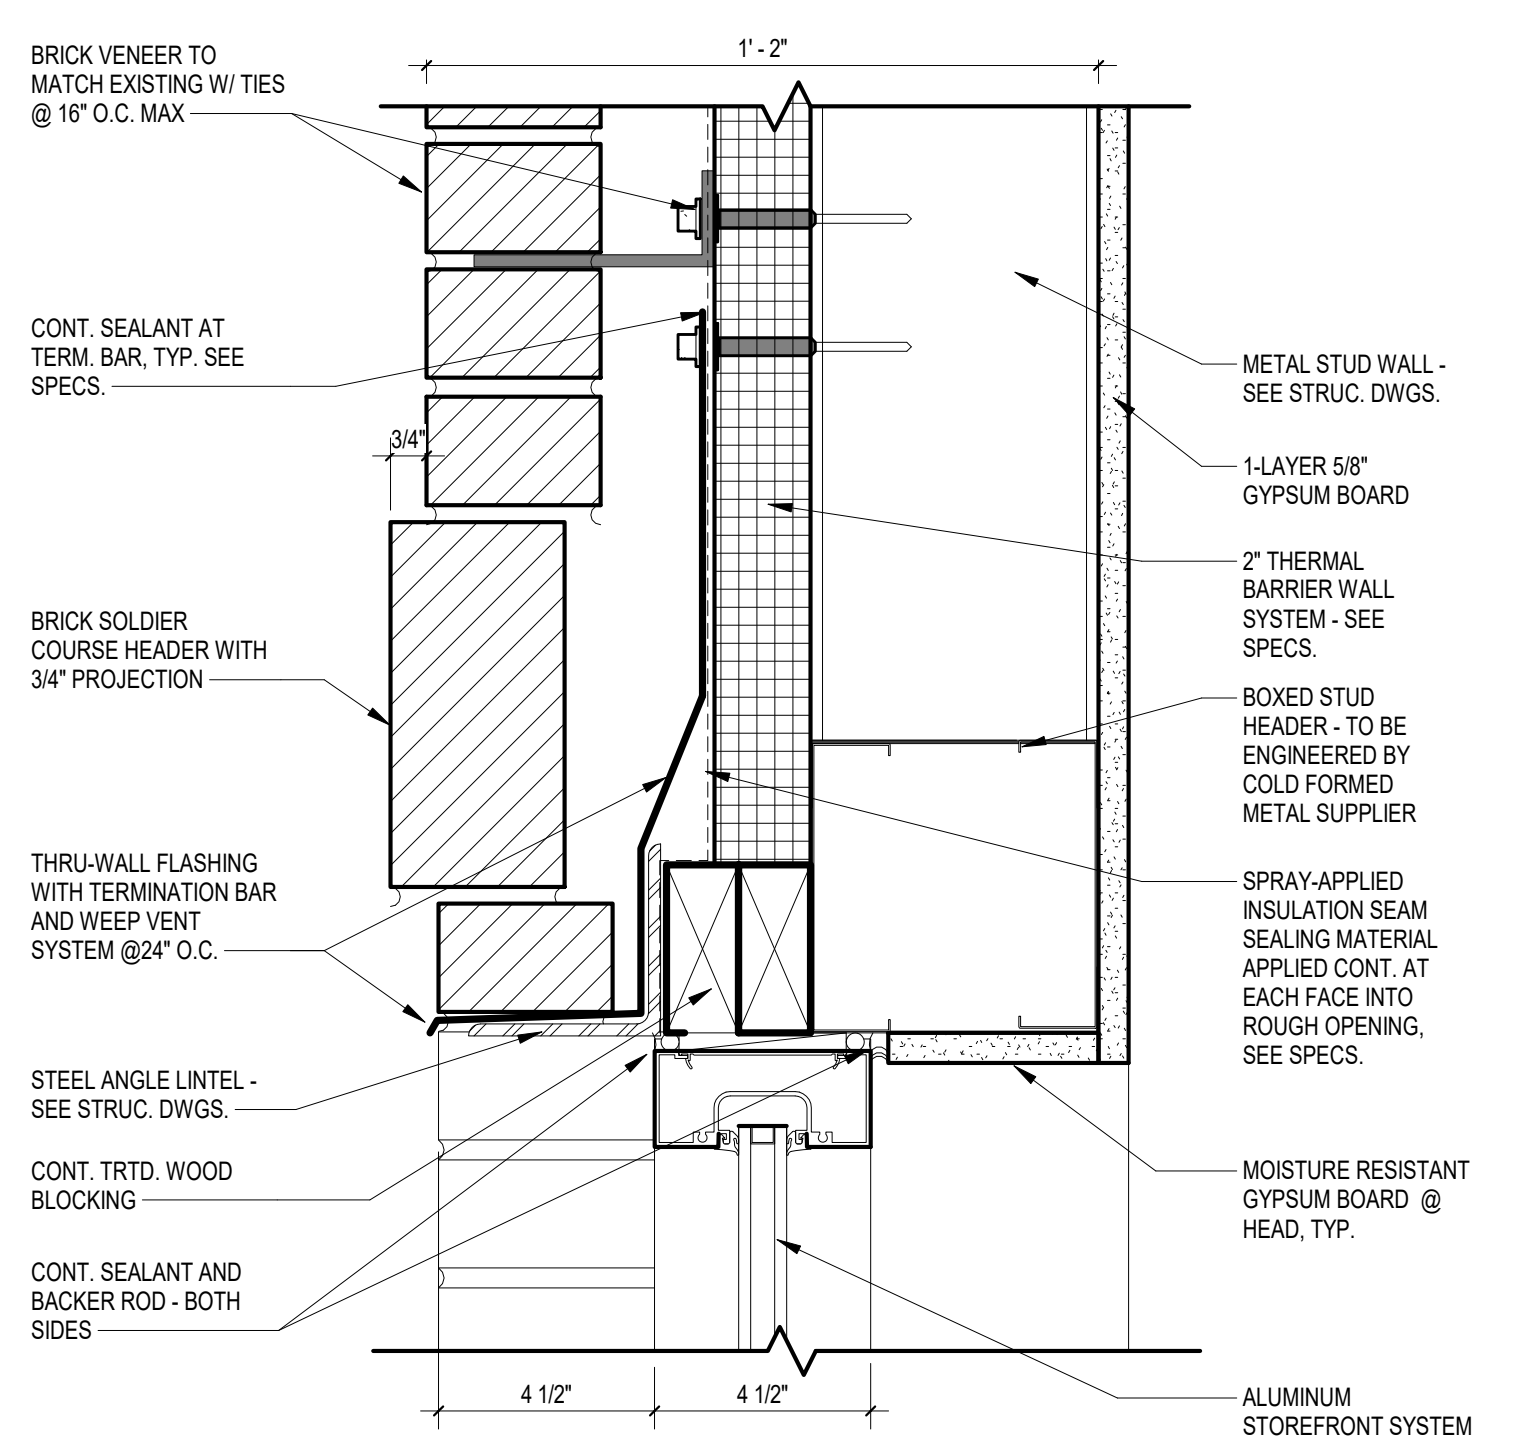
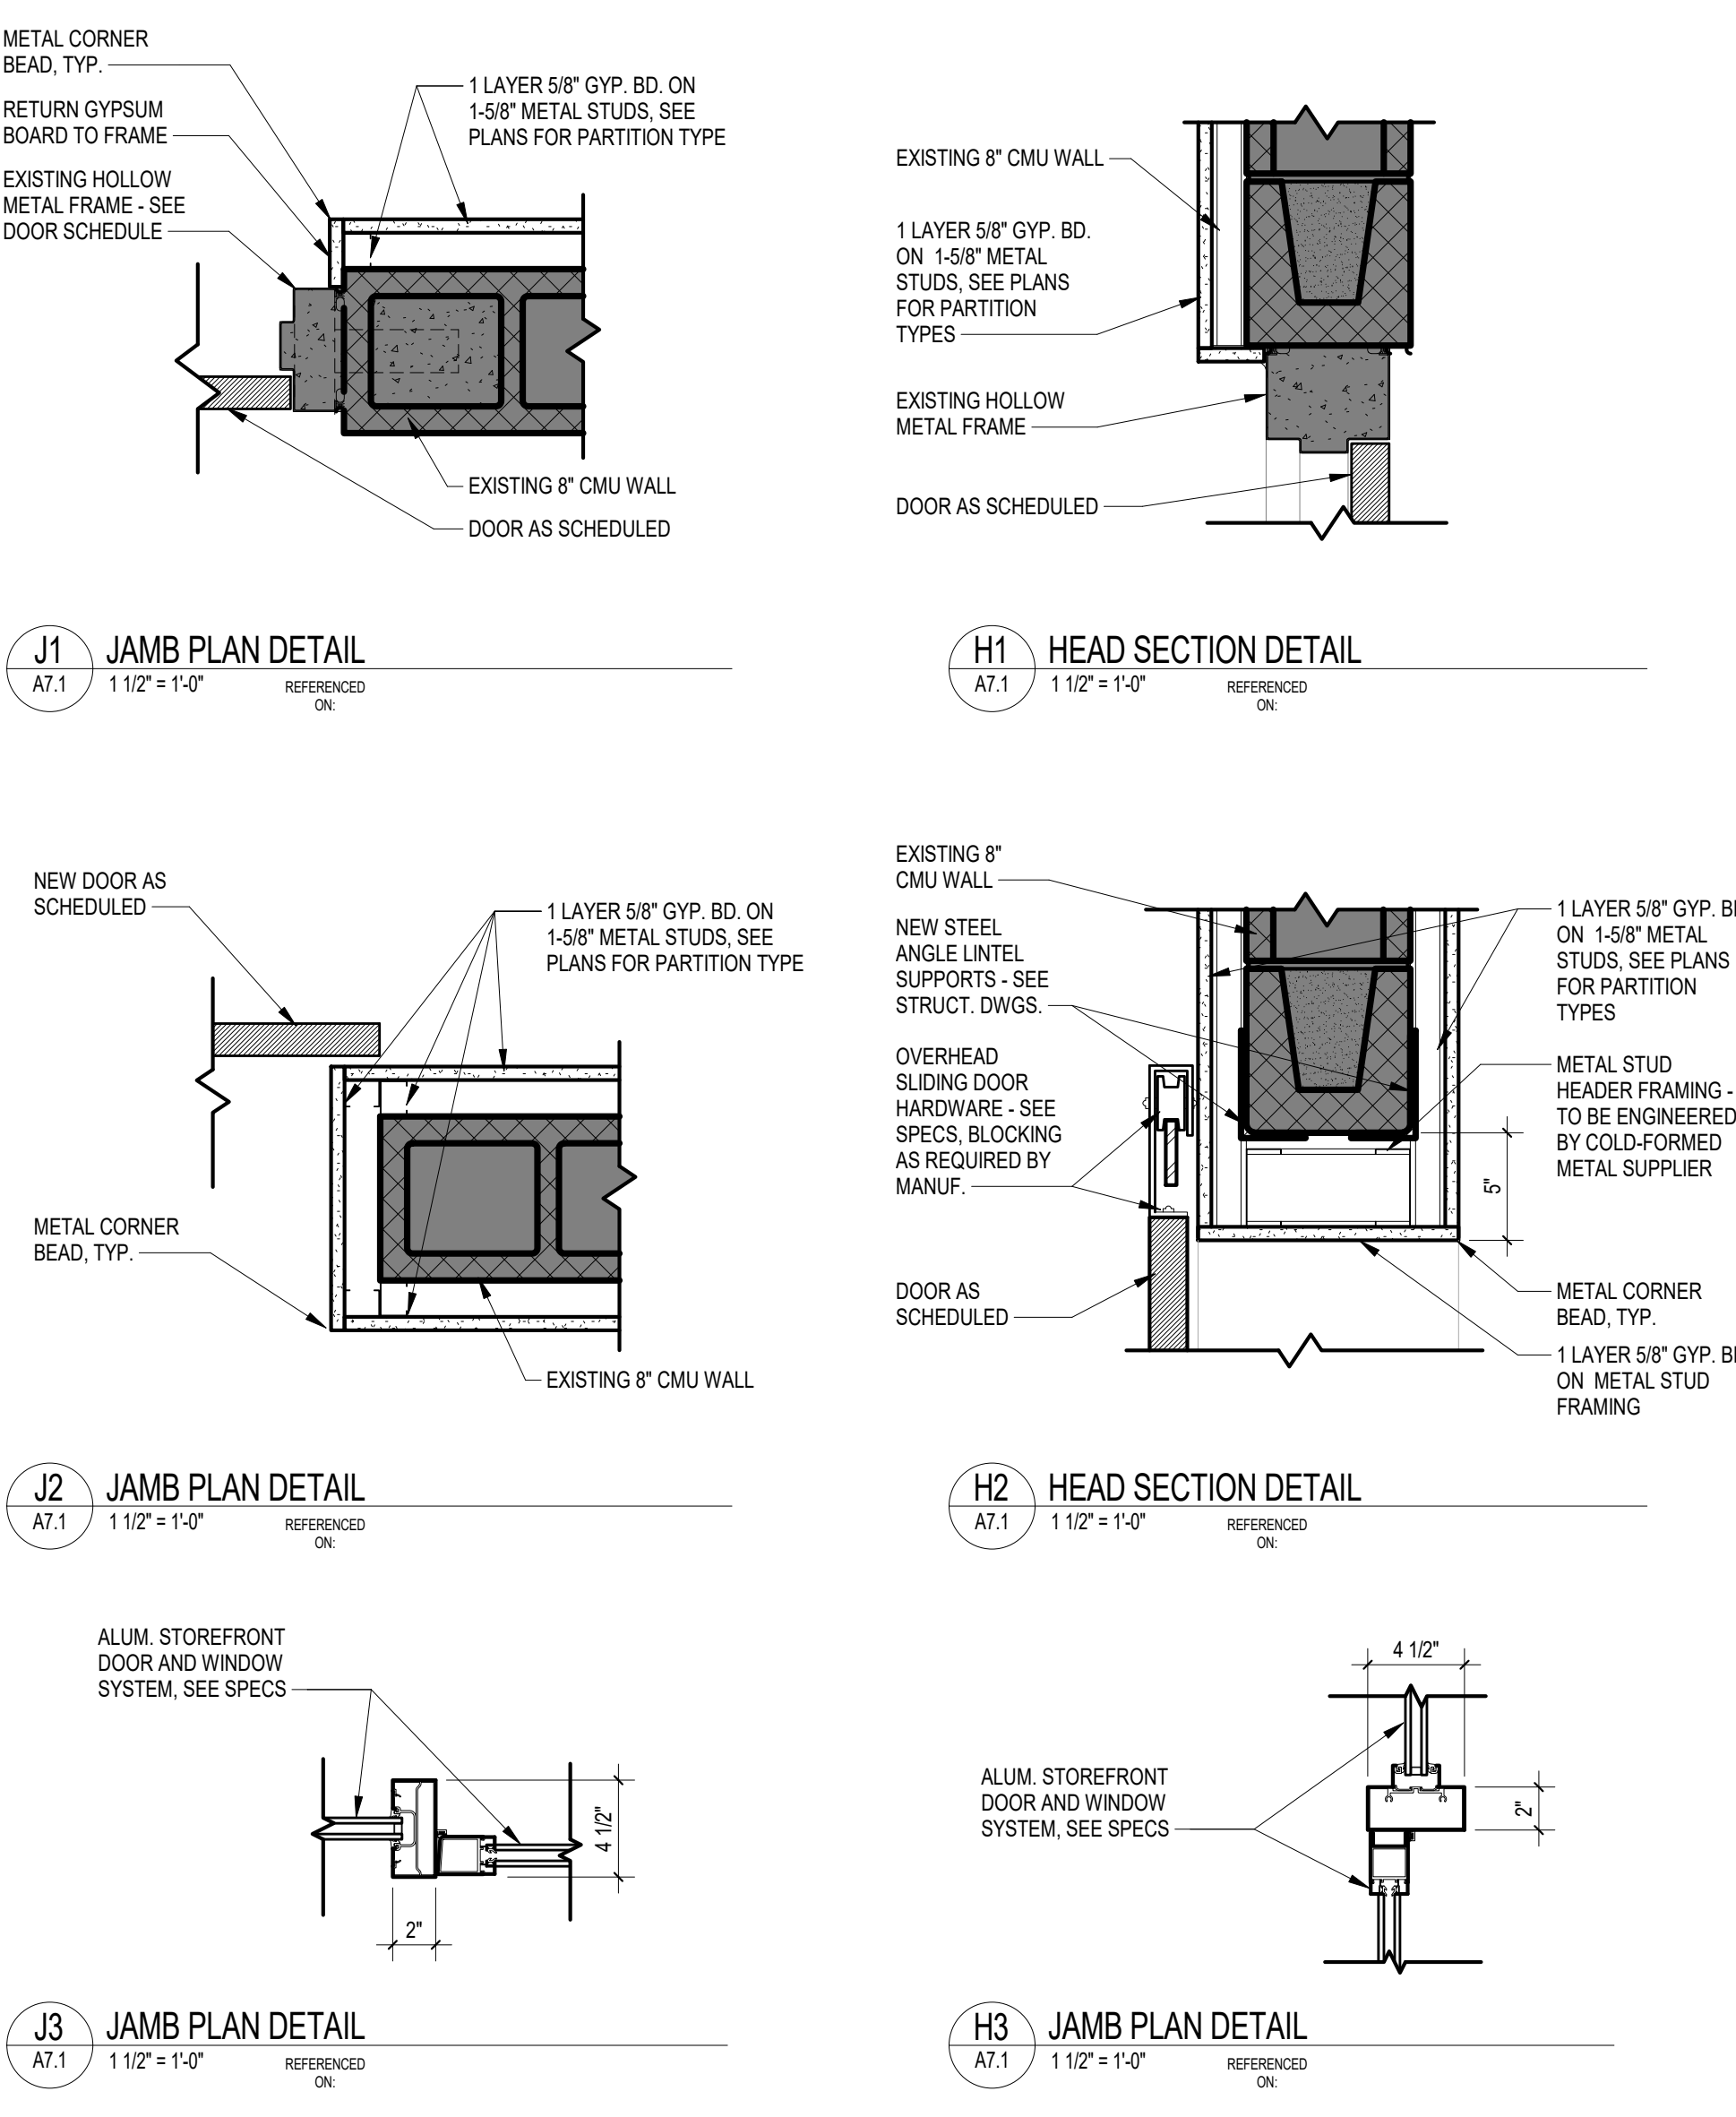
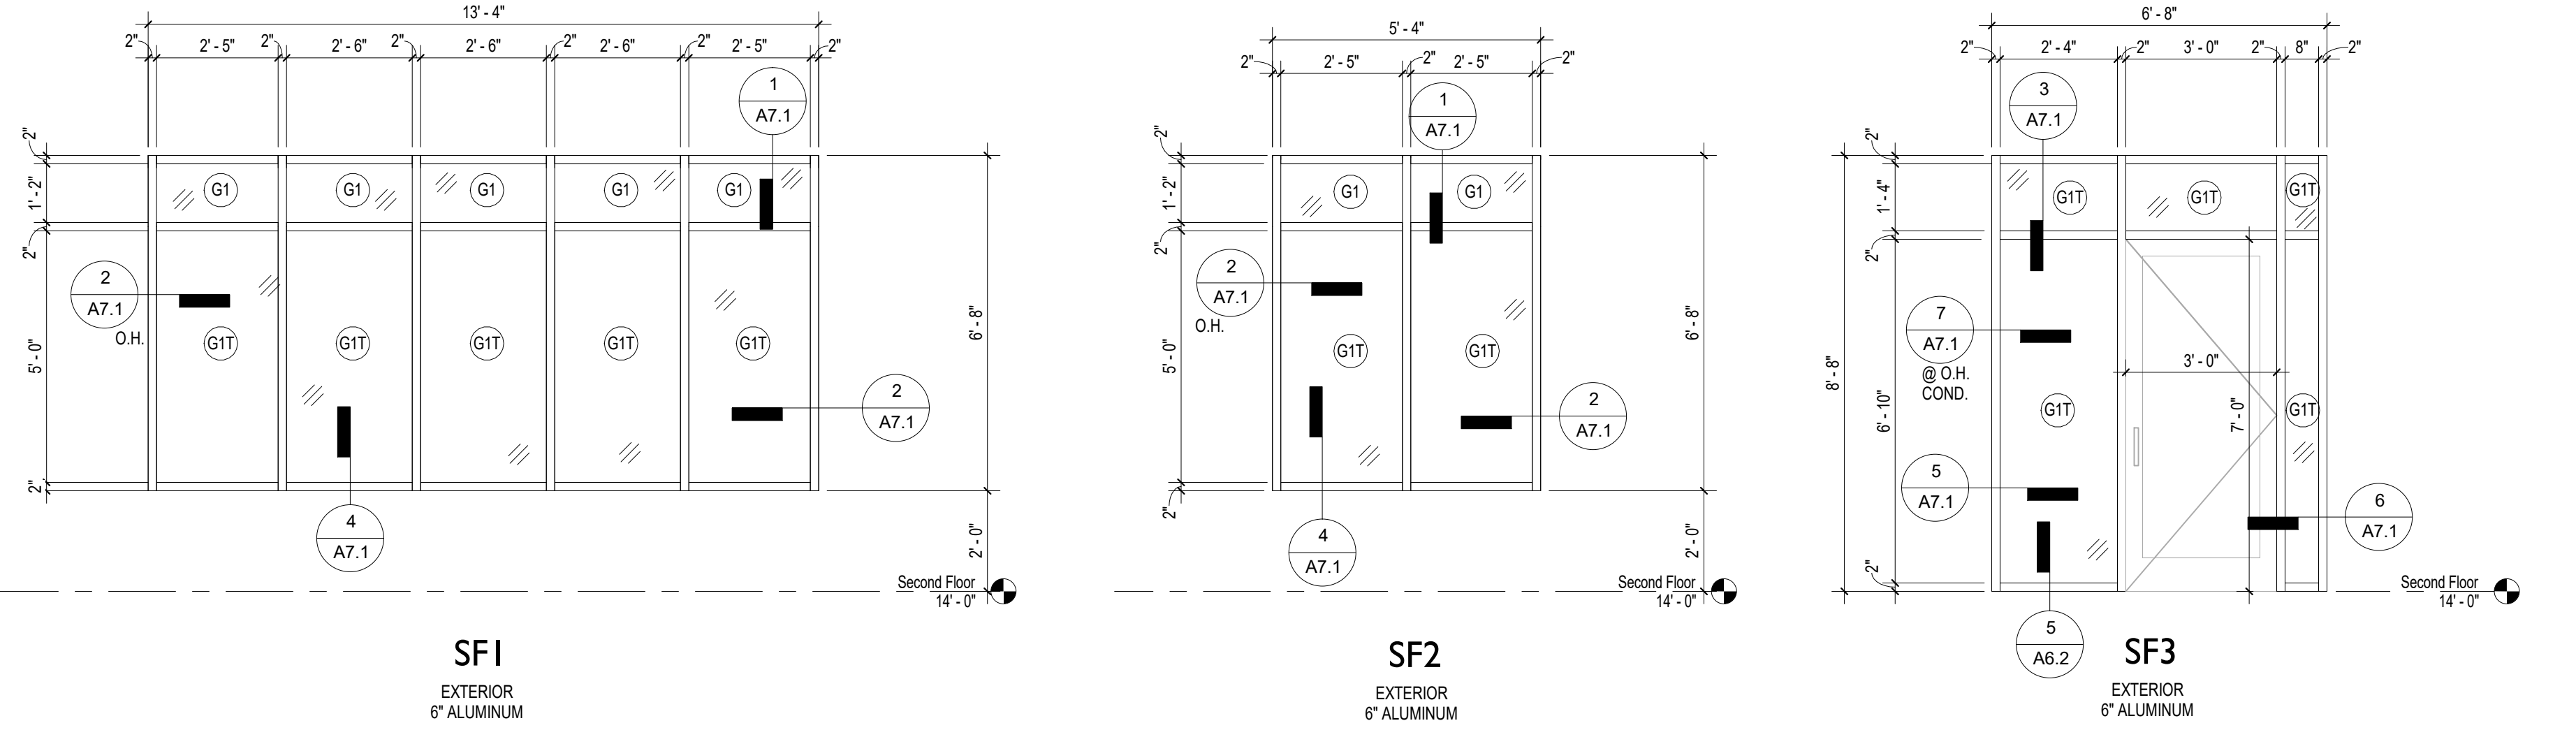
SECTION DETAILS

PROJECT NO. 1426.16
DATE 09.21.16
DRAWING NO. **A6.2**

DOOR SCHEDULE									
Mark	DOOR			DOOR TYPE	HEAD	JAMB	SILL	RATING	REMARKS
	WIDTH	HEIGHT	FRAME TYPE						
101A	6'-0"	7'-0"	EXISTING	D1	H1	J1	--	--	--
101B	6'-0"	7'-0"	N/A	D2	H2	J2	--	--	--
201A	3'-0"	7'-0"	F1	D3	H3	J3	--	--	--
203A	3'-0"	7'-0"	F1	D3	H3	J3	--	--	--

GLAZING SCHEDULE

GLASS DESCRIPTION TYPE
G1 1" INSULATED LOW-E EXTERIOR GLASS EACH LITE: 1/4" INCH GLASS FLOT GLASS FIRST (EXTERIOR) SURFACE CLEAR AIR SPACE WIDTH 1/2" INCH COATING LOW-E ON SECOND SURFACE SEE SPECS
G1T SAME AS G1 WITH 1/4" TEMPERED GLAZING BOTH SIDES
G2 5/16" CLEAR LAMINATED GLASS 2 PLYS FULLY TEMPERED FLOT GLASS W/ CLEAR PVB INTERLAYER



9/21/2016 8:23:07 AM

GARVIN DESIGN GROUP
 803.212.1032 p / 803.212.1074 f
 Columbia, SC 29902
 1709 Lincoln Street

REGISTERED PROFESSIONAL ARCHITECT
DAVID M. GARVIN
 STATE OF SOUTH CAROLINA
 ARCHITECT NO. 35123







UNIVERSITY OF SOUTH CAROLINA
FOUNDERS PARK PLAYER'S LOUNGE
AND MEDIA ROOM ADDITION
 431 WILLIAMS STREET
 COLUMBIA, SC 29201

NO.	DATE	NAME

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DOORS AND WINDOWS

PROJECT NO. **A7.1**
 DATE 08.21.16
 DRAWING NO. **A7.1**

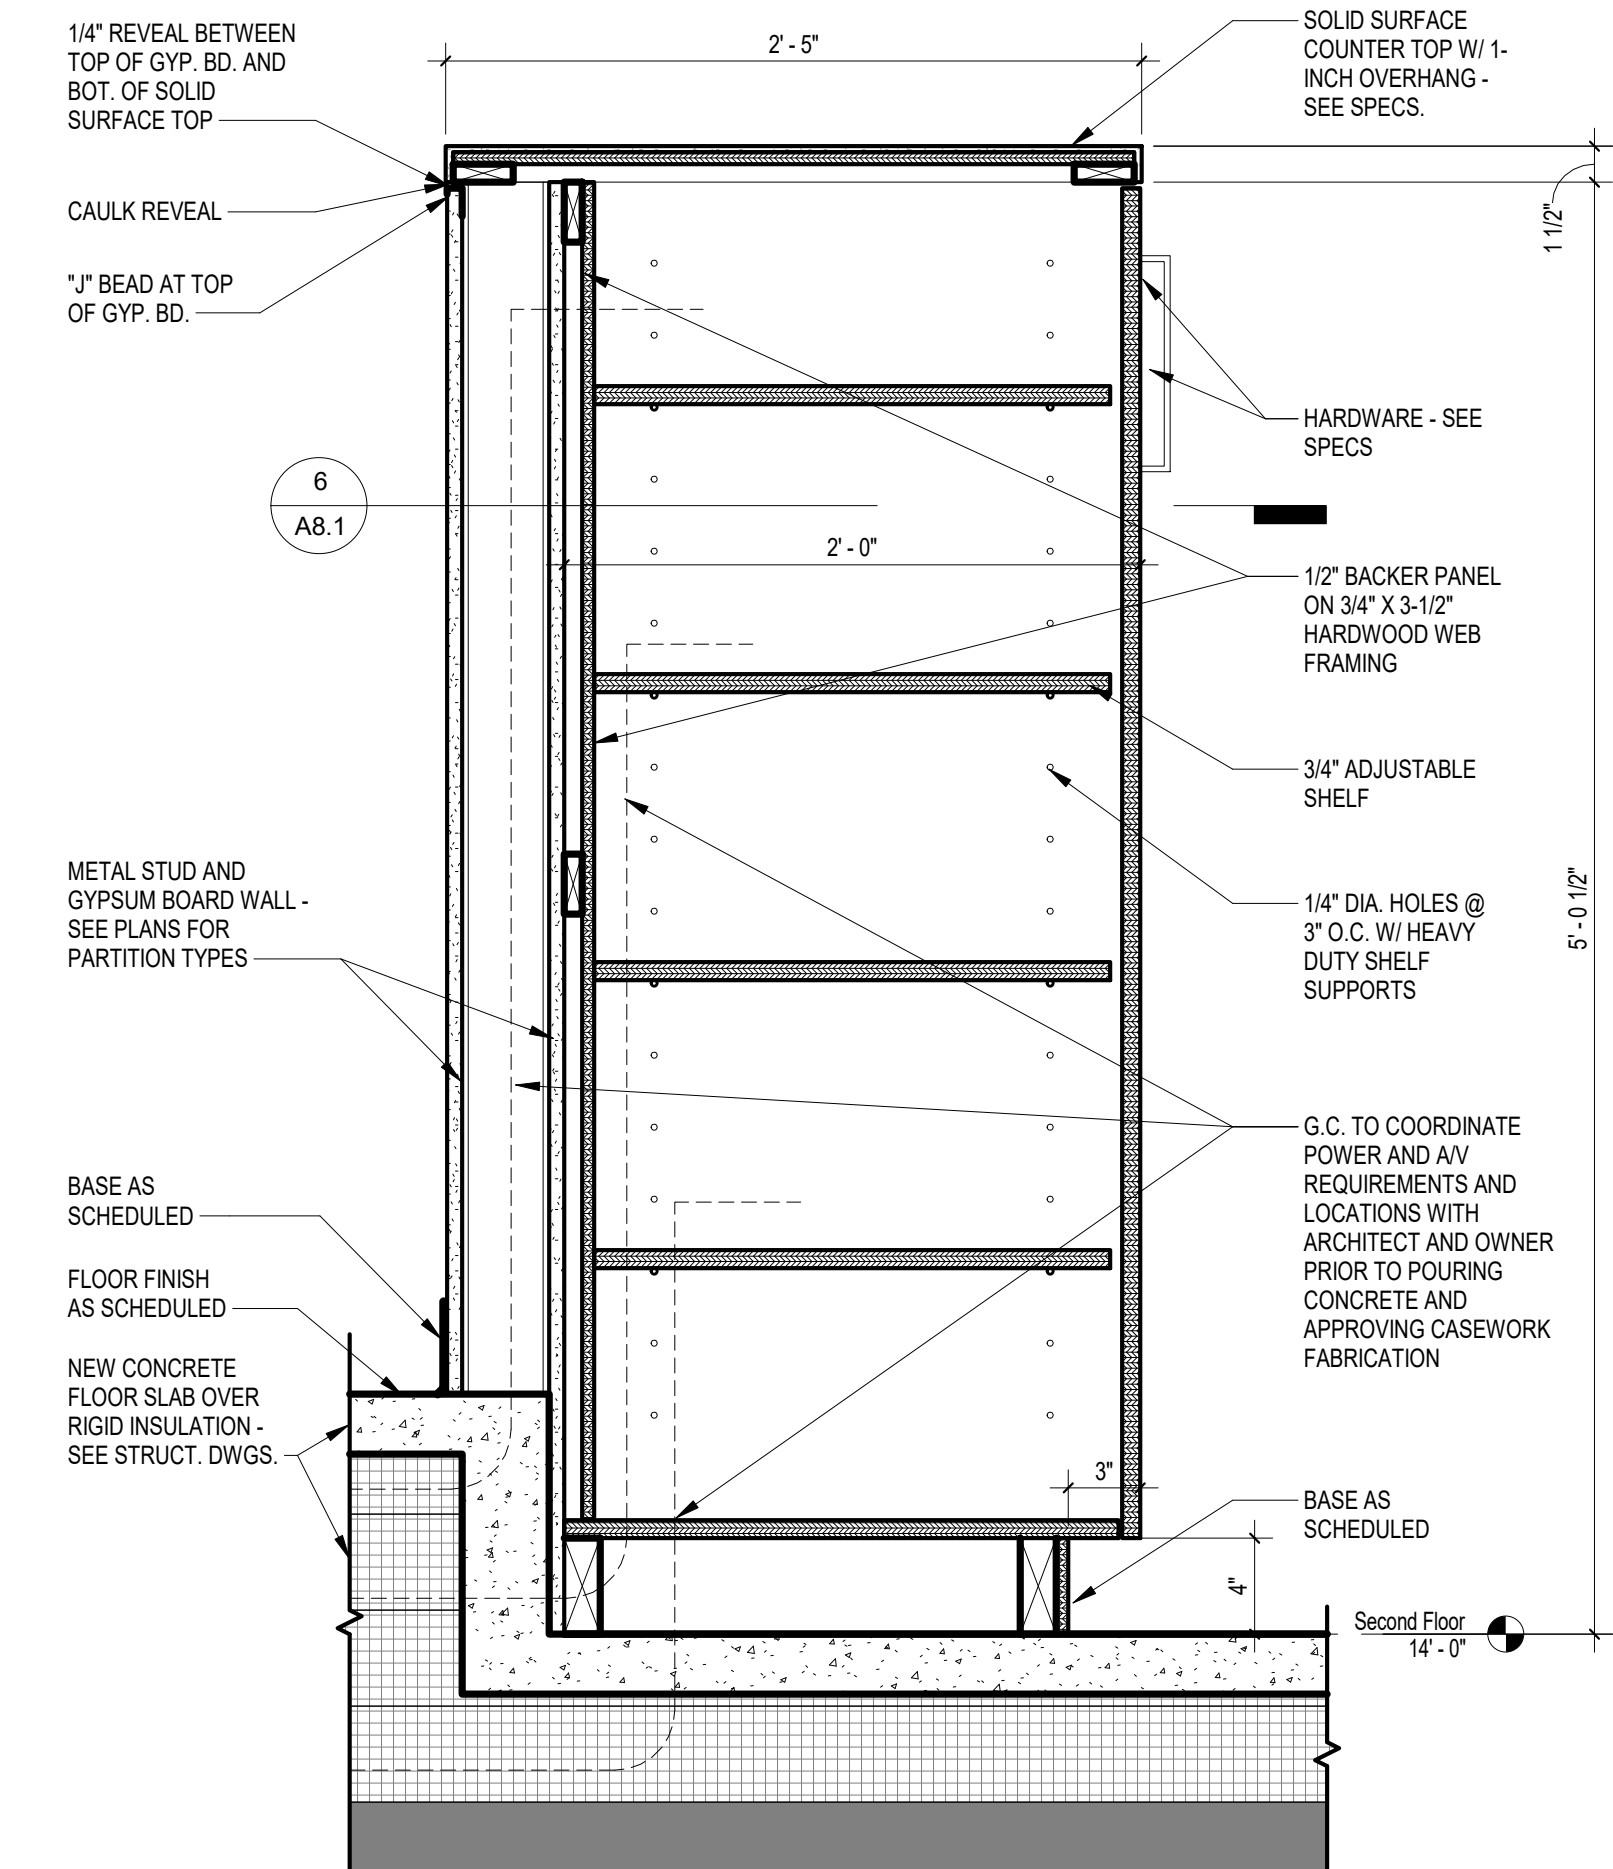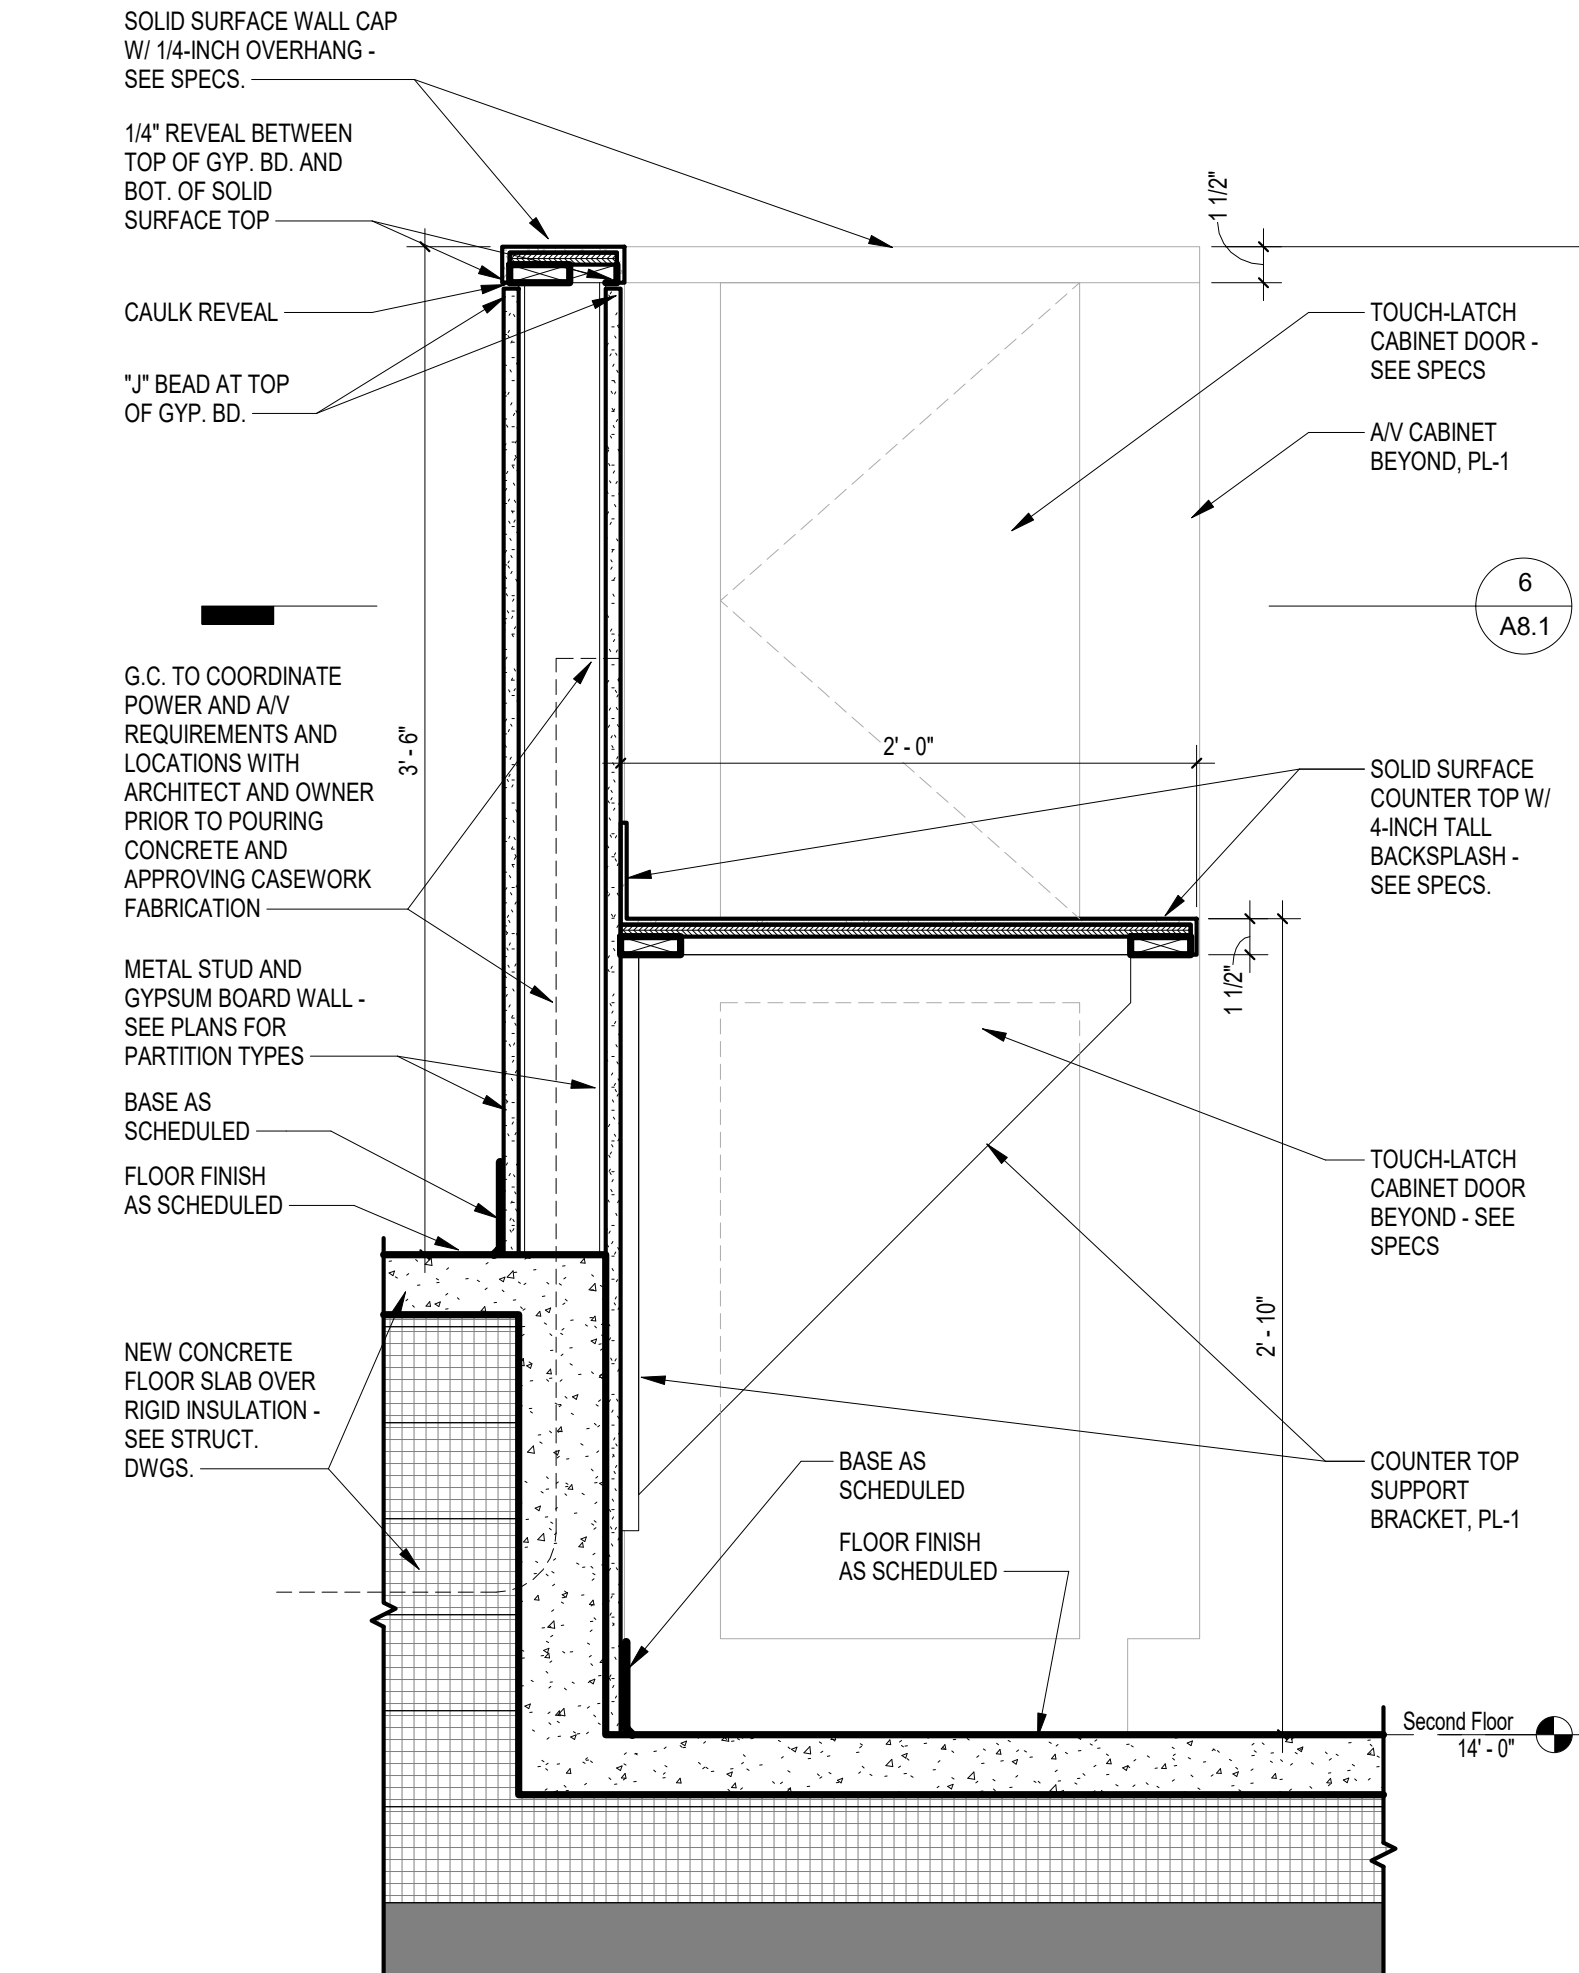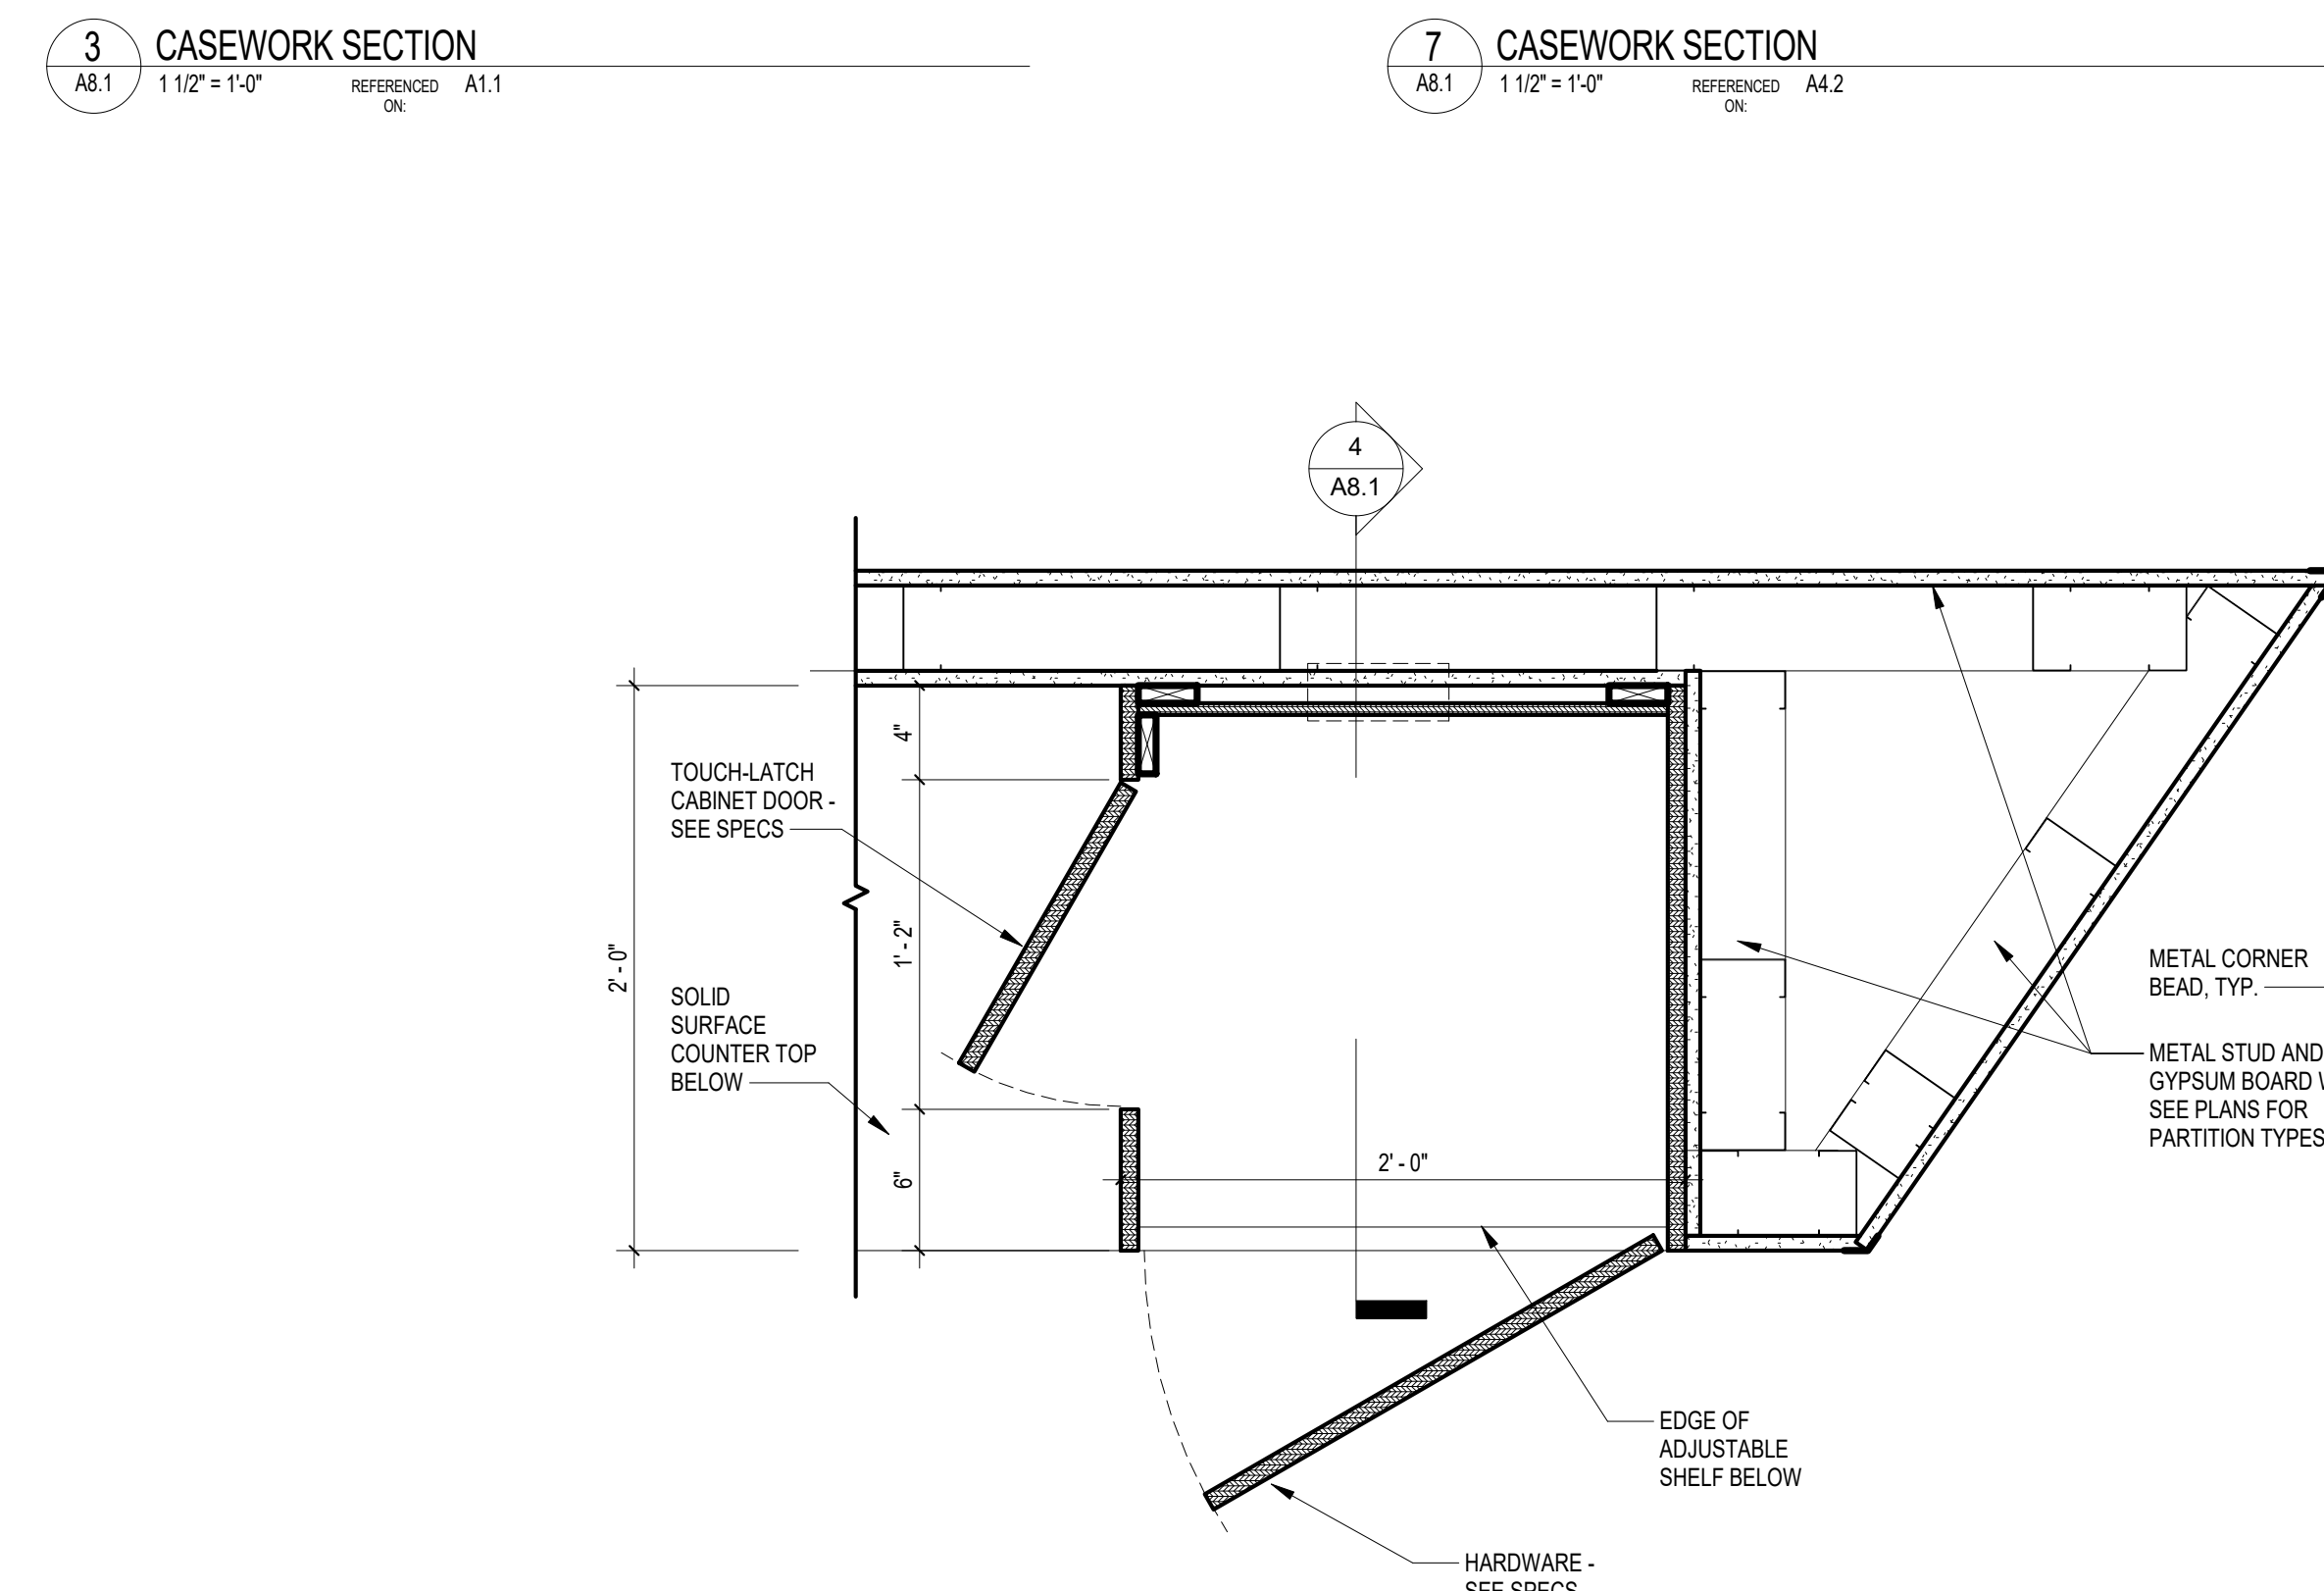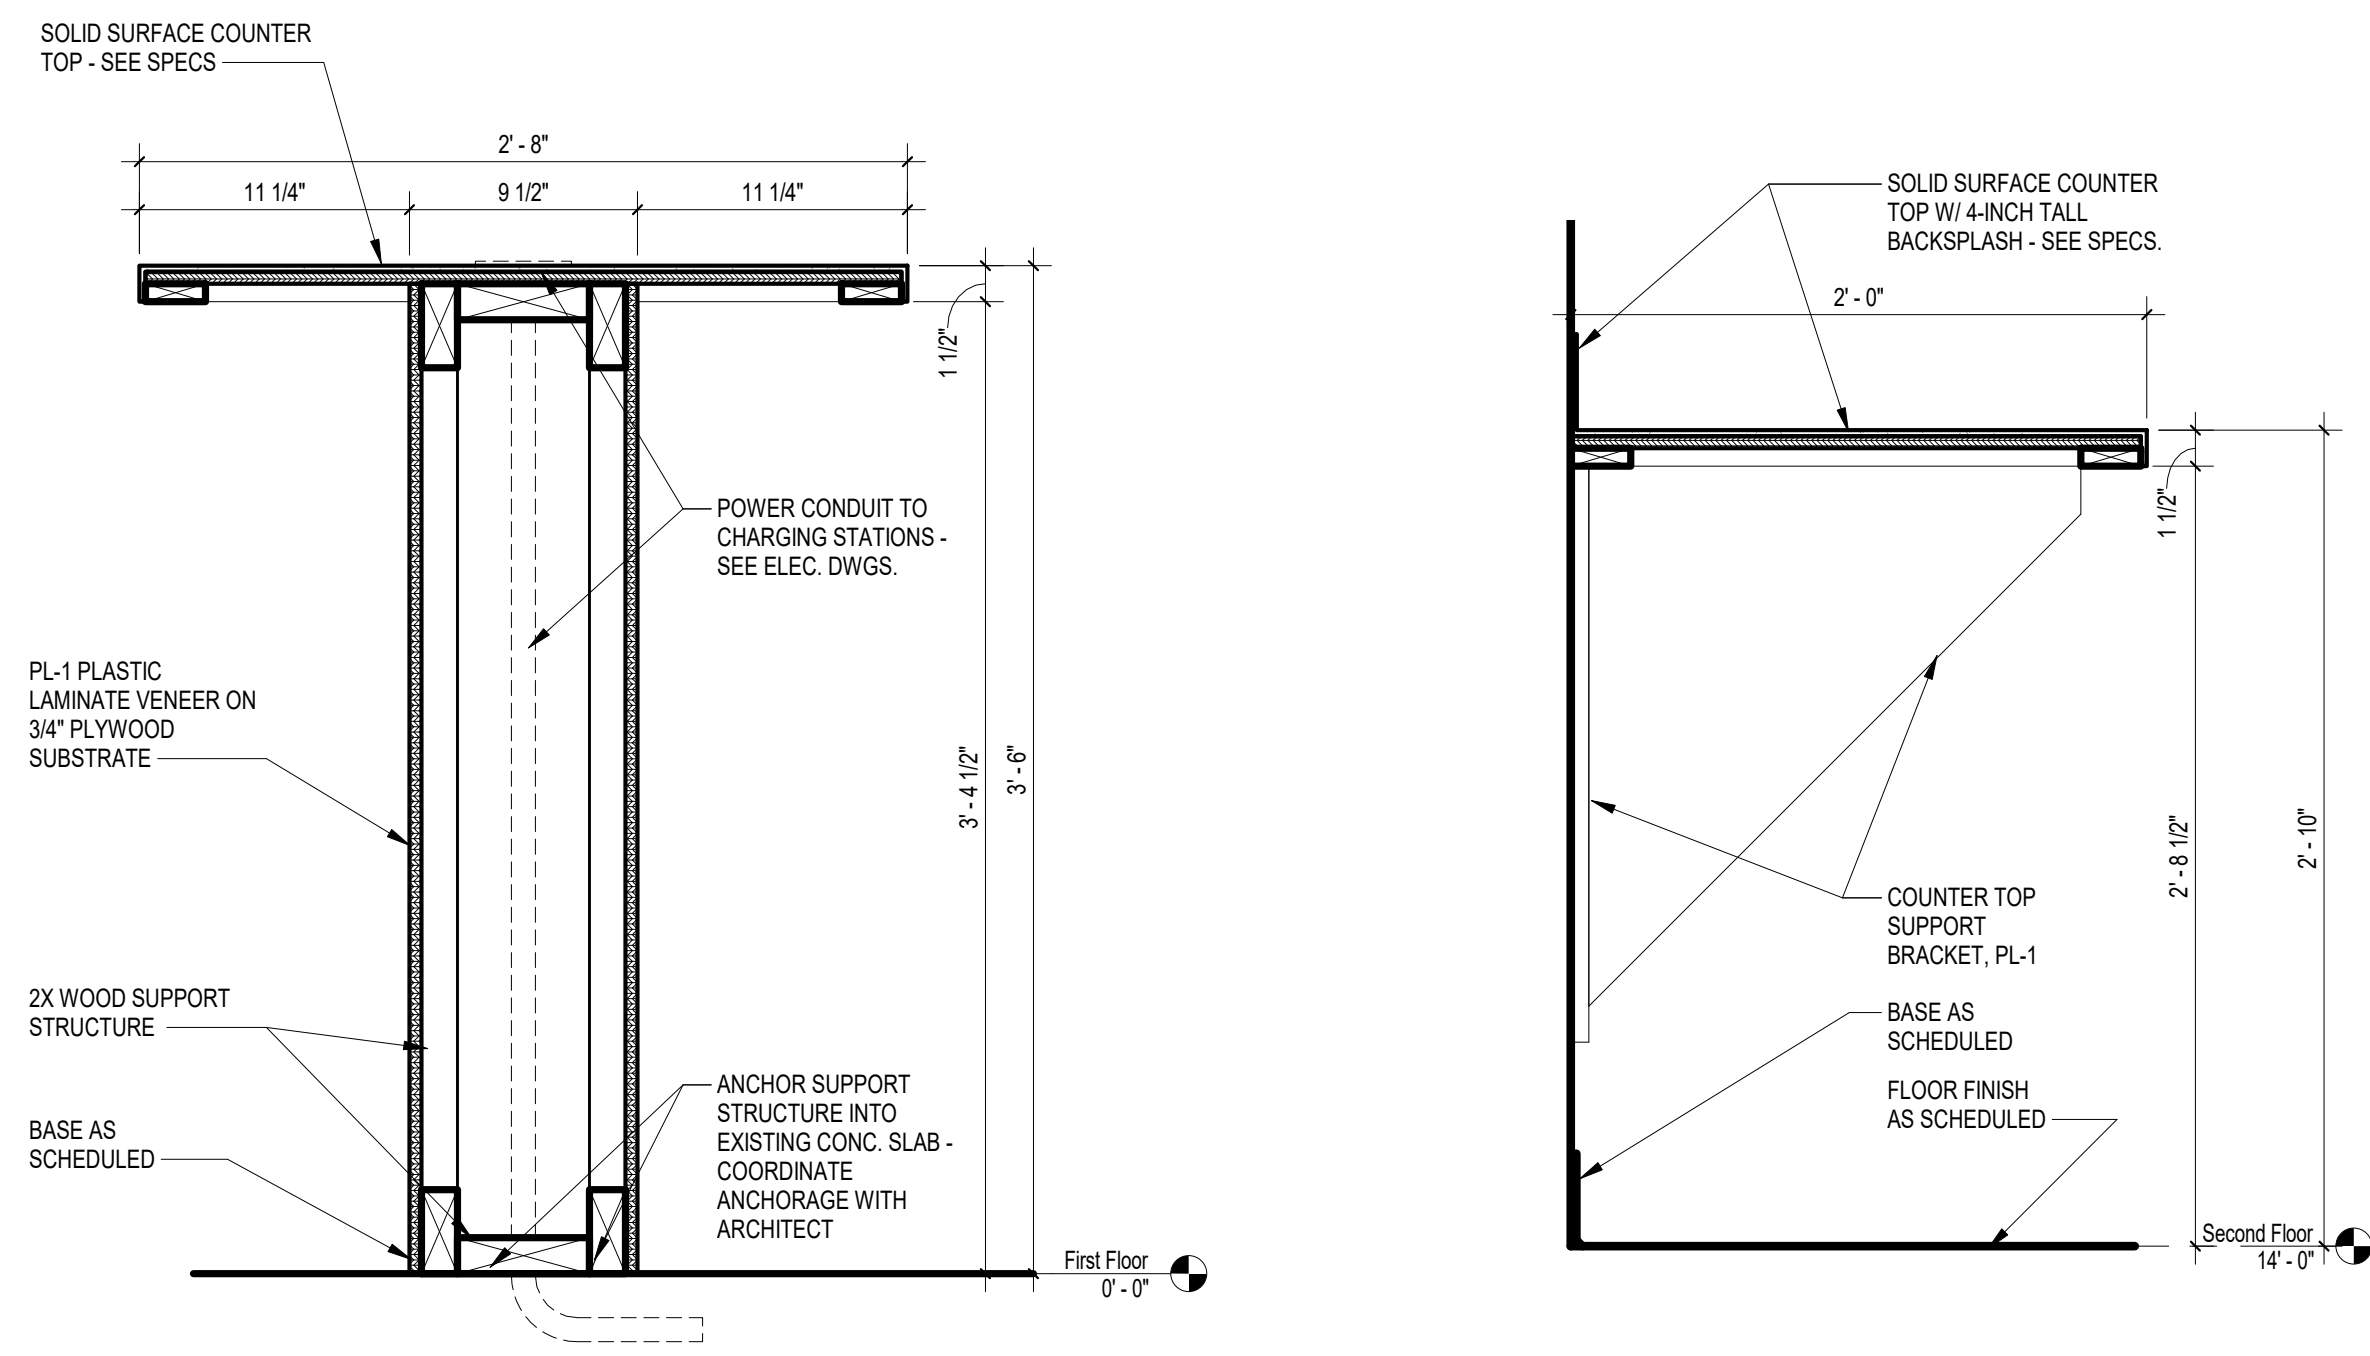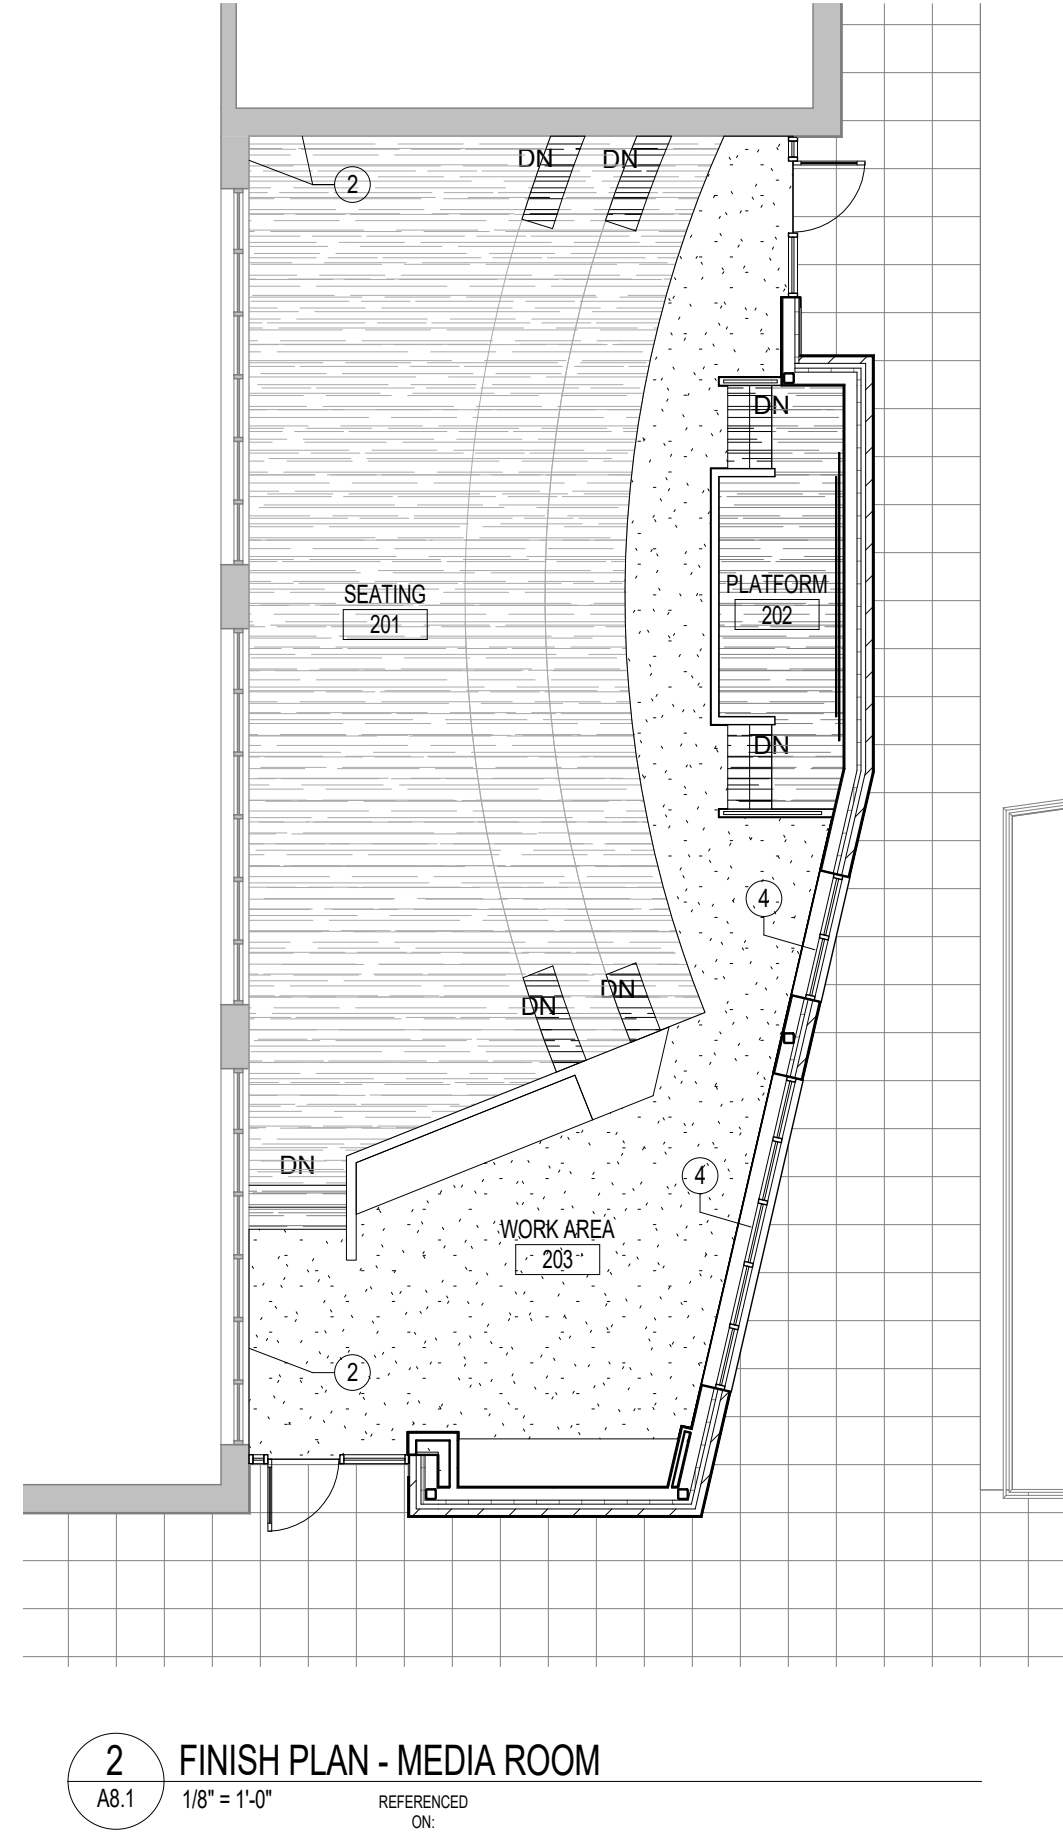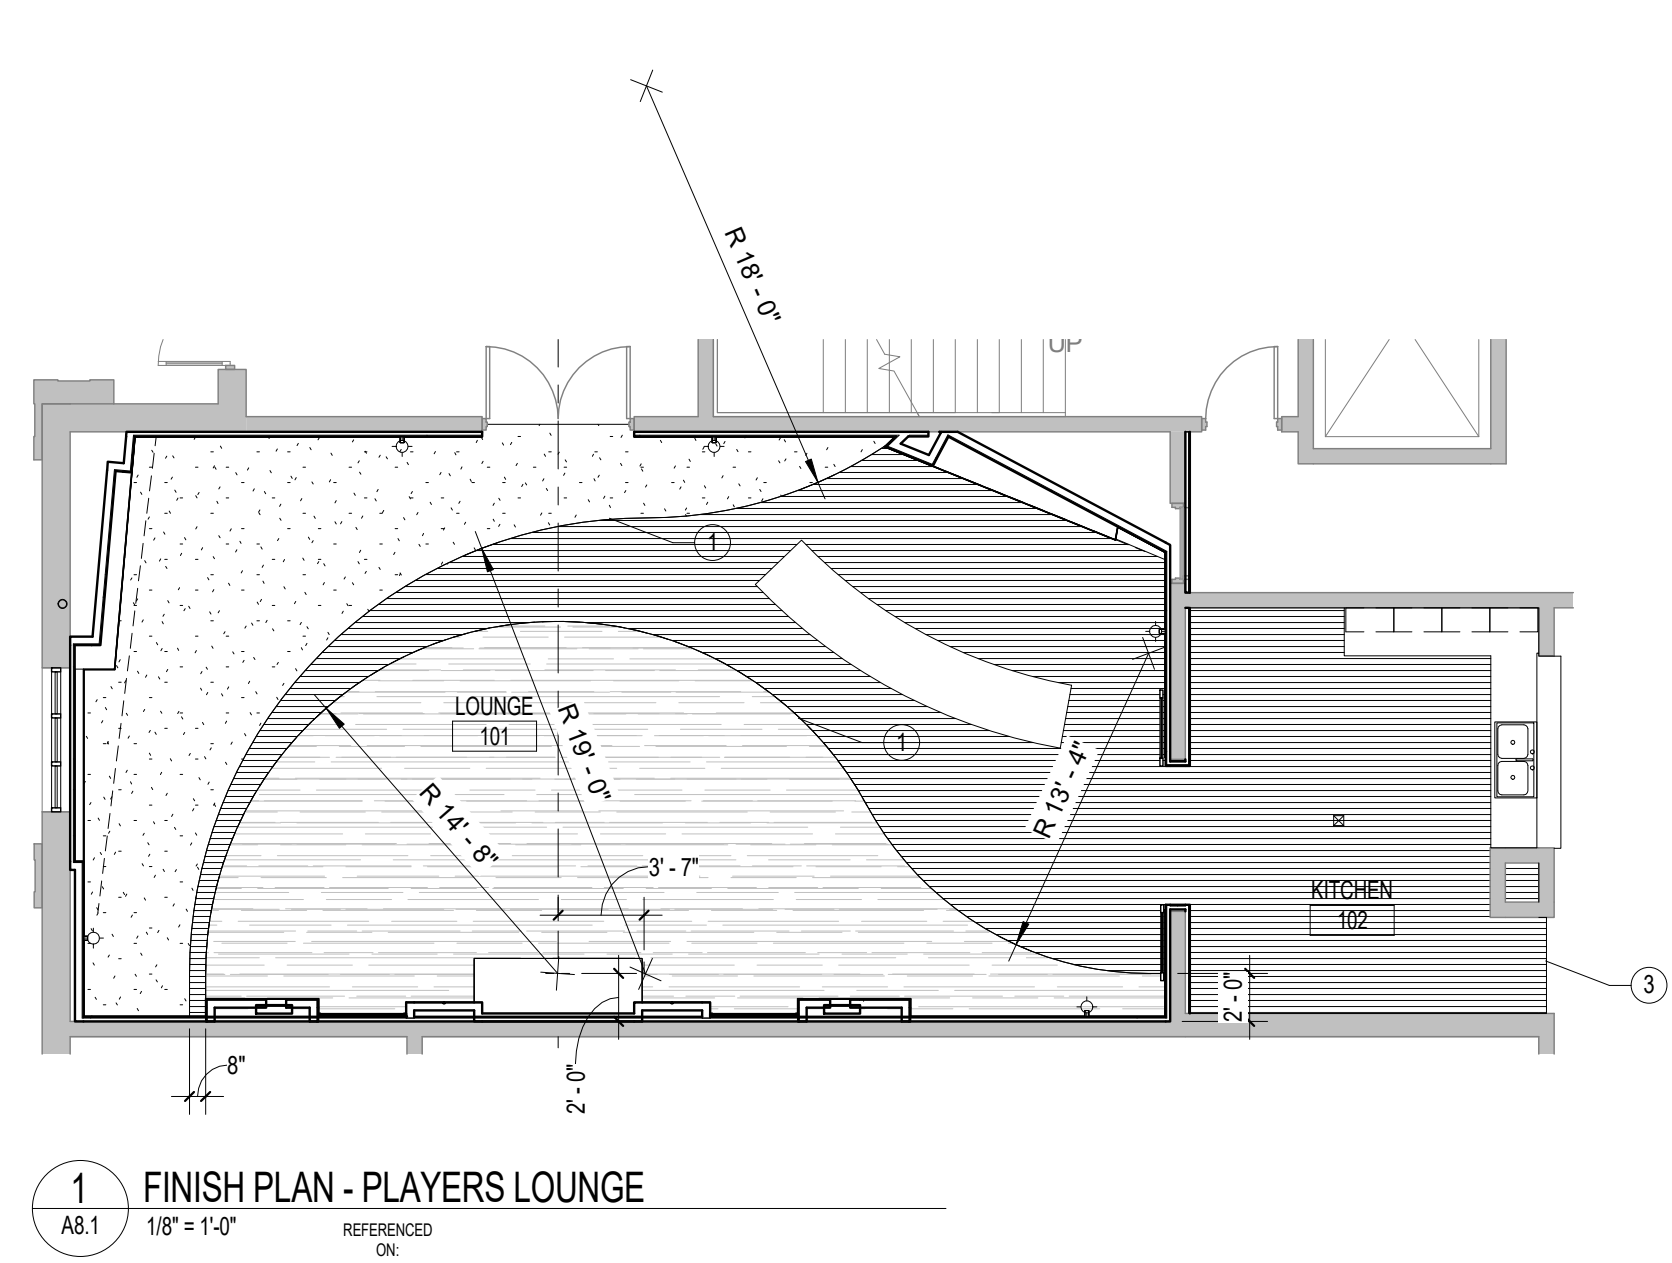

SCHEDULED INTERIOR FINISHES


ABBREVIATION	DESCRIPTION	BASIS OF DESIGN
BASE AND FLOORING TRANSITIONS		
RB-1	4" RUBBER COVE	JOHNSONITE RECESSED WALL BASE, COLOR: RWDC #179 STEEL W/ G
FT-1	FLOORING TRANSITION STRIP - CPT TO LVT	TANDUS CENTIVA METAL EDGE TROIS AME03, STEEL #00179, KERFED AT CURVES
FT-2	1/2" RESILIENT QTR. ROUND	JOHNSONITE, QTR-179-A, COLOR: #179 STEEL W/ G
FT-3	ADA TRANSITION TO EXISTING THRESHOLD	JOHNSONITE, CTA-XX-P OR SIM. #179 STEEL W/ G
FLOOR		
CPT-1	CARPET - GARNET 18X 36 TILES, ASHLAR	BENTLEY, DRY LAKE, #4DLT6, SCORPION QUEEN 402028
CPT-2	CARPET - GREY BROADLOOM	MILLIKEN LANDSCAPE LAN67 ROSS ICE SHELF
LVT-1	LUXURY VINYL TILE - PLANK	MILLIKEN FREELAY, FARGESIA BAMBOO, #FAR76
WALLS		
P-1	PAINT - GENERAL WALL COLOR	LOW-SHEEN, EGGSHELL, TO MATCH SW#7016 MINDFUL GRAY
P-2	PAINT - MAIN SOFFIT - FLAT	LOW-SHEEN, EGGSHELL, TO MATCH SW#7018 DOVETAIL
P-3	PAINT - WALL BUMP OUTS - FLAT	LOW-SHEEN, EGGSHELL, TO MATCH SW#6307 FINE WINE
P-4	PAINT - H.M. DOOR FRAME - SEMI-GLOSS	SEMI-GLOSS, COLOR TO MATCH SW#7642 PAVESTONE
P-5	PAINT - ACCENT	LOW-SHEEN, EGGSHELL, TO MATCH SW#7019 GAUNTLET GRAY
CEILING		
APC-1	ACOUSTICAL PANEL CEILING-HIGH NRC	ARMSTRONG, CIRRUS #556 OR EQ., WHITE (2X2 BEVELED TEGULAR), WHITE
GBP	GYPSUM WALL BOARD - PAINTED	SEE REFLECTED CEILING PLAN FOR COLOR DESIGNATIONS & LOCATIONS
MISC.		
RS	ROLLER SHADES	MOTORIZED ROLLER SHADE, SEE SPEC.
ST	STAIN @ WOOD HANDRAIL	ESPRESSO TONE TO MATCH ARCHITECT'S SAMPLE
CASEWORK		
SS-1	CASEWORK COUNTERTOPS	CORIAN, COLOR: DEEP STORM
PL-1	PLASTIC LAMINATE-GEN. CASEWORK	WILSONART #79331-76 CAFELLE

FINISH SCHEDULE - PLAYER'S LOUNGE

ROOM NO.	ROOM NAME	BASE	FLOOR	CEILING	WALL FINISH				Comments
					NORTH	EAST	SOUTH	WEST	
101	LOUNGE	RB-1	SEE KEY	APC-1, GB/P	P-1	P-1	P-1	P-1	1
102	KITCHEN	RB-1	LVT-1	APC-1	P-1	P-1	P-1	P-1	

FINISH SCHEDULE - MEDIA ROOM


ROOM NO.	ROOM NAME	BASE	FLOOR	CEILING	WALL FINISH				Comments
					NORTH	EAST	SOUTH	WEST	
201	SEATING	RB-1	CPT-2	APC-1, GB/P	P-1	P-1	P-1	P-1	1
202	PLATFORM	RB-1	CPT-2	GB/P	P-1	P-1	P-1	P-1	1
203	WORK AREA	RB-1	CPT-1	APC-1, GB/P	P-1	P-1	P-1	P-1	1

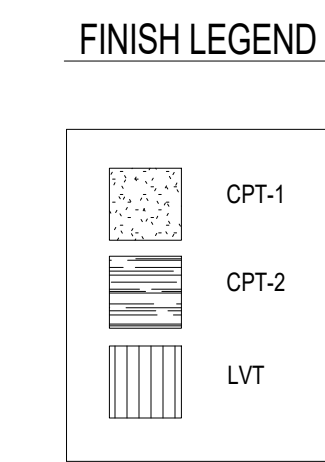

- INTERIOR FINISH KEY NOTES**
- 1 FT-1 TRANSITION, SEE FINISH SCHEDULE
 - 2 FT-2 TRANSITION @ BRICK WALLS, TYP.
 - 3 FT-3 TRANSITION @ EXISTING THRESHOLD.
 - 4 ROLLER SHADE LOCATIONS, FIELD VERIFY DIMENSIONS, SEE FINISH SCHEDULE.

COMMENTS

1. SEE INTERIOR ELEVATIONS & REFLECTED CEILING PLANS FOR ADDITIONAL ACCENT PAINT LOCATIONS AND EXTENTS FOR WALLS & CEILINGS

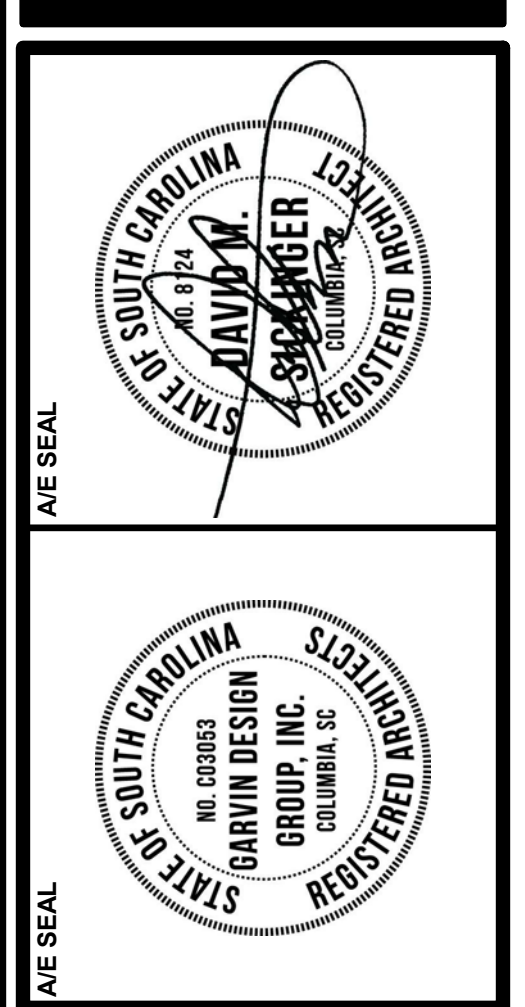


**UNIVERSITY OF SOUTH CAROLINA
FOUNDERS PARK PLAYER'S LOUNGE
AND MEDIA ROOM ADDITION**
431 WILLIAMS STREET
COLUMBIA, SC 29201

REVISIONS

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**SCHEDULED INTERIOR FINISHES,
FINISH PLANS, FINISH SCHEDULE,
CASEWORK DETAILS**



**UNIVERSITY OF SOUTH CAROLINA
 FOUNDERS PARK PLAYER'S LOUNGE
 AND MEDIA ROOM ADDITION**
 431 WILLIAMS STREET
 COLUMBIA, SC 29201

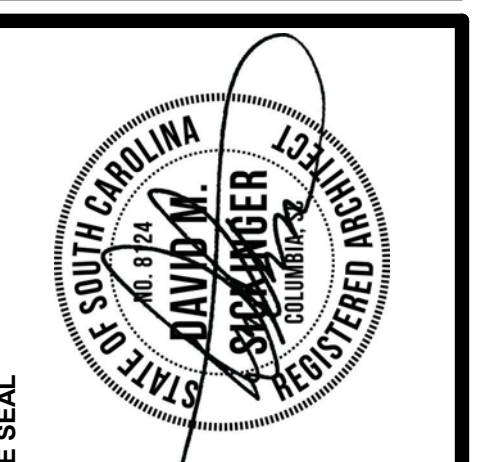
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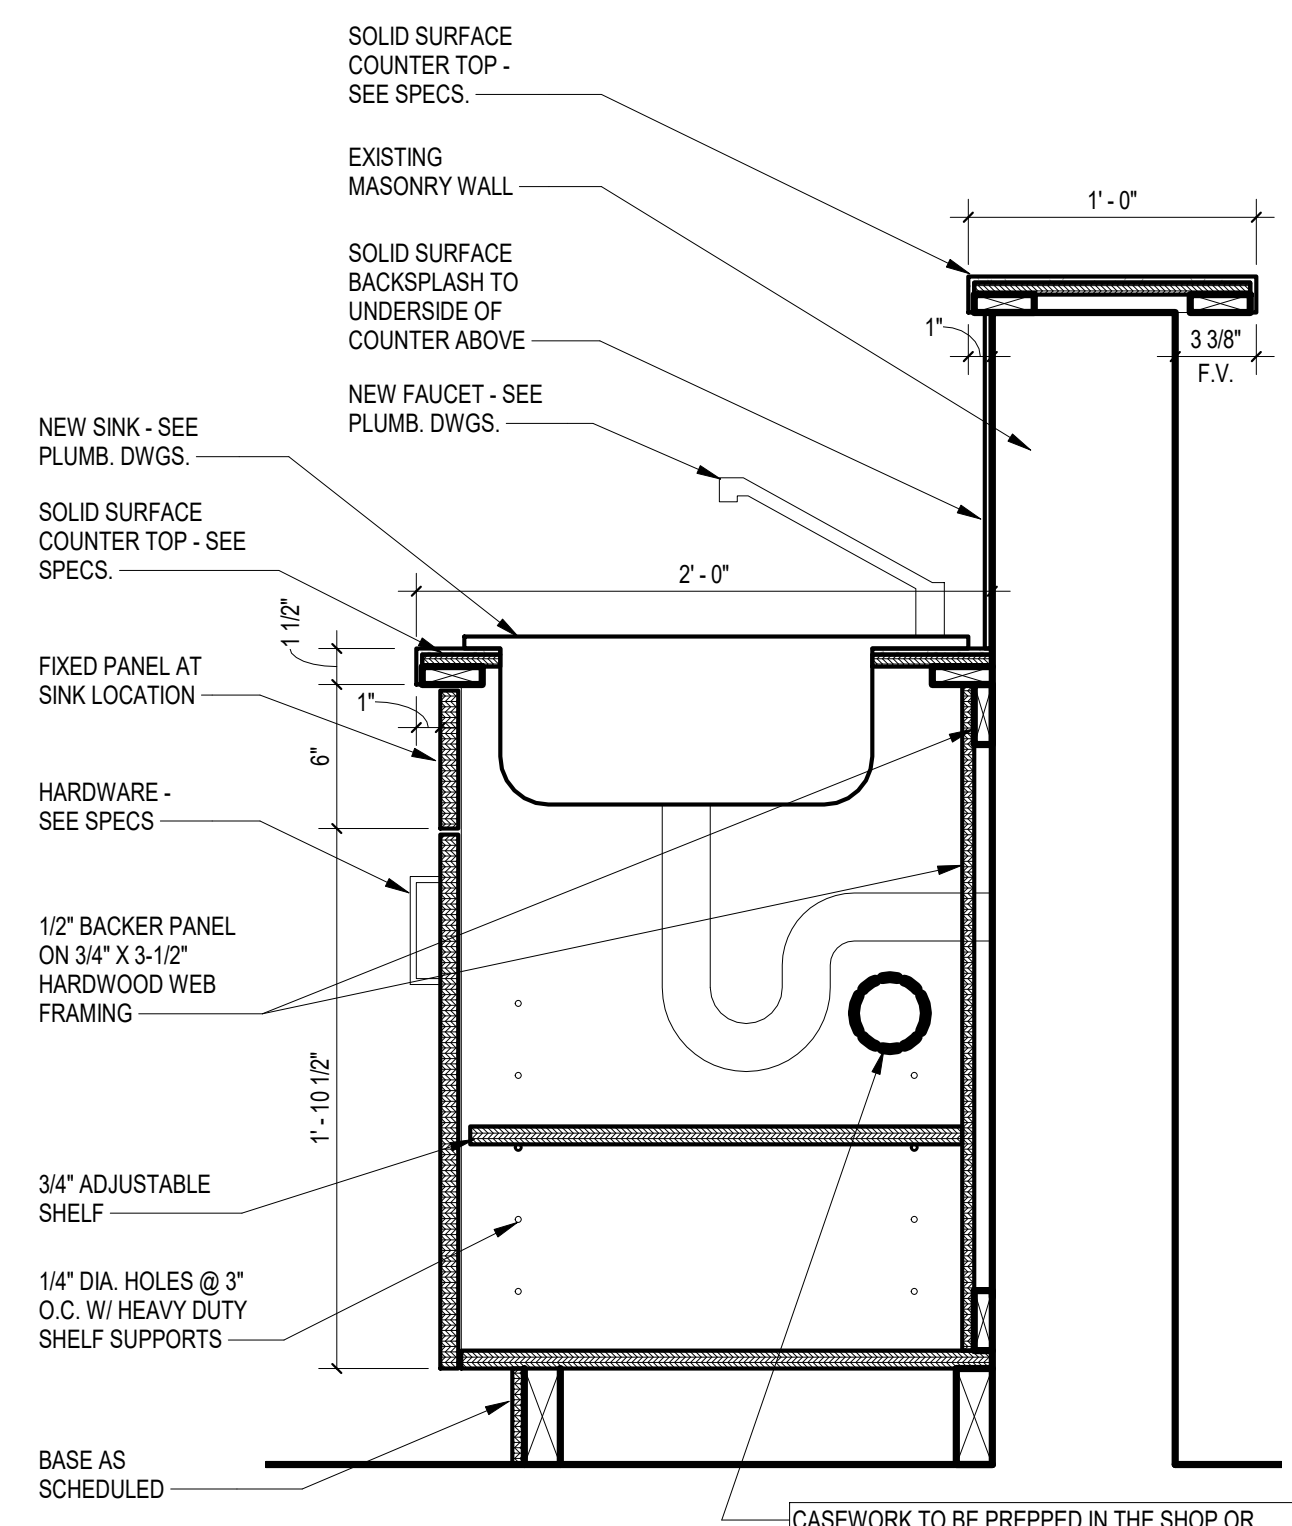
**CASEWORK ELEVATIONS,
 SECTIONS & DETAILS**

GENERAL CASEWORK NOTES


- SEE SPECIFICATIONS FOR HARDWARE DESIGNATIONS: PULLS, DRAWERS, ETC.
- CASEWORK BASE TO MATCH BASE CABINET, BASE ADDED BY FLOORING CONTRACTOR WHERE CABINETS OCCUR ON RESILIENT FLOORING, U.N.O.
- SEE SPECIFICATIONS FOR FABRICATION GRADE, EDGE TREATMENTS, SPECIFIC REQUIREMENTS AND HARDWARE




4 CASEWORK SECTION
 A8.2 1/2" = 1'-0"
 REFERENCED ON: A8.2

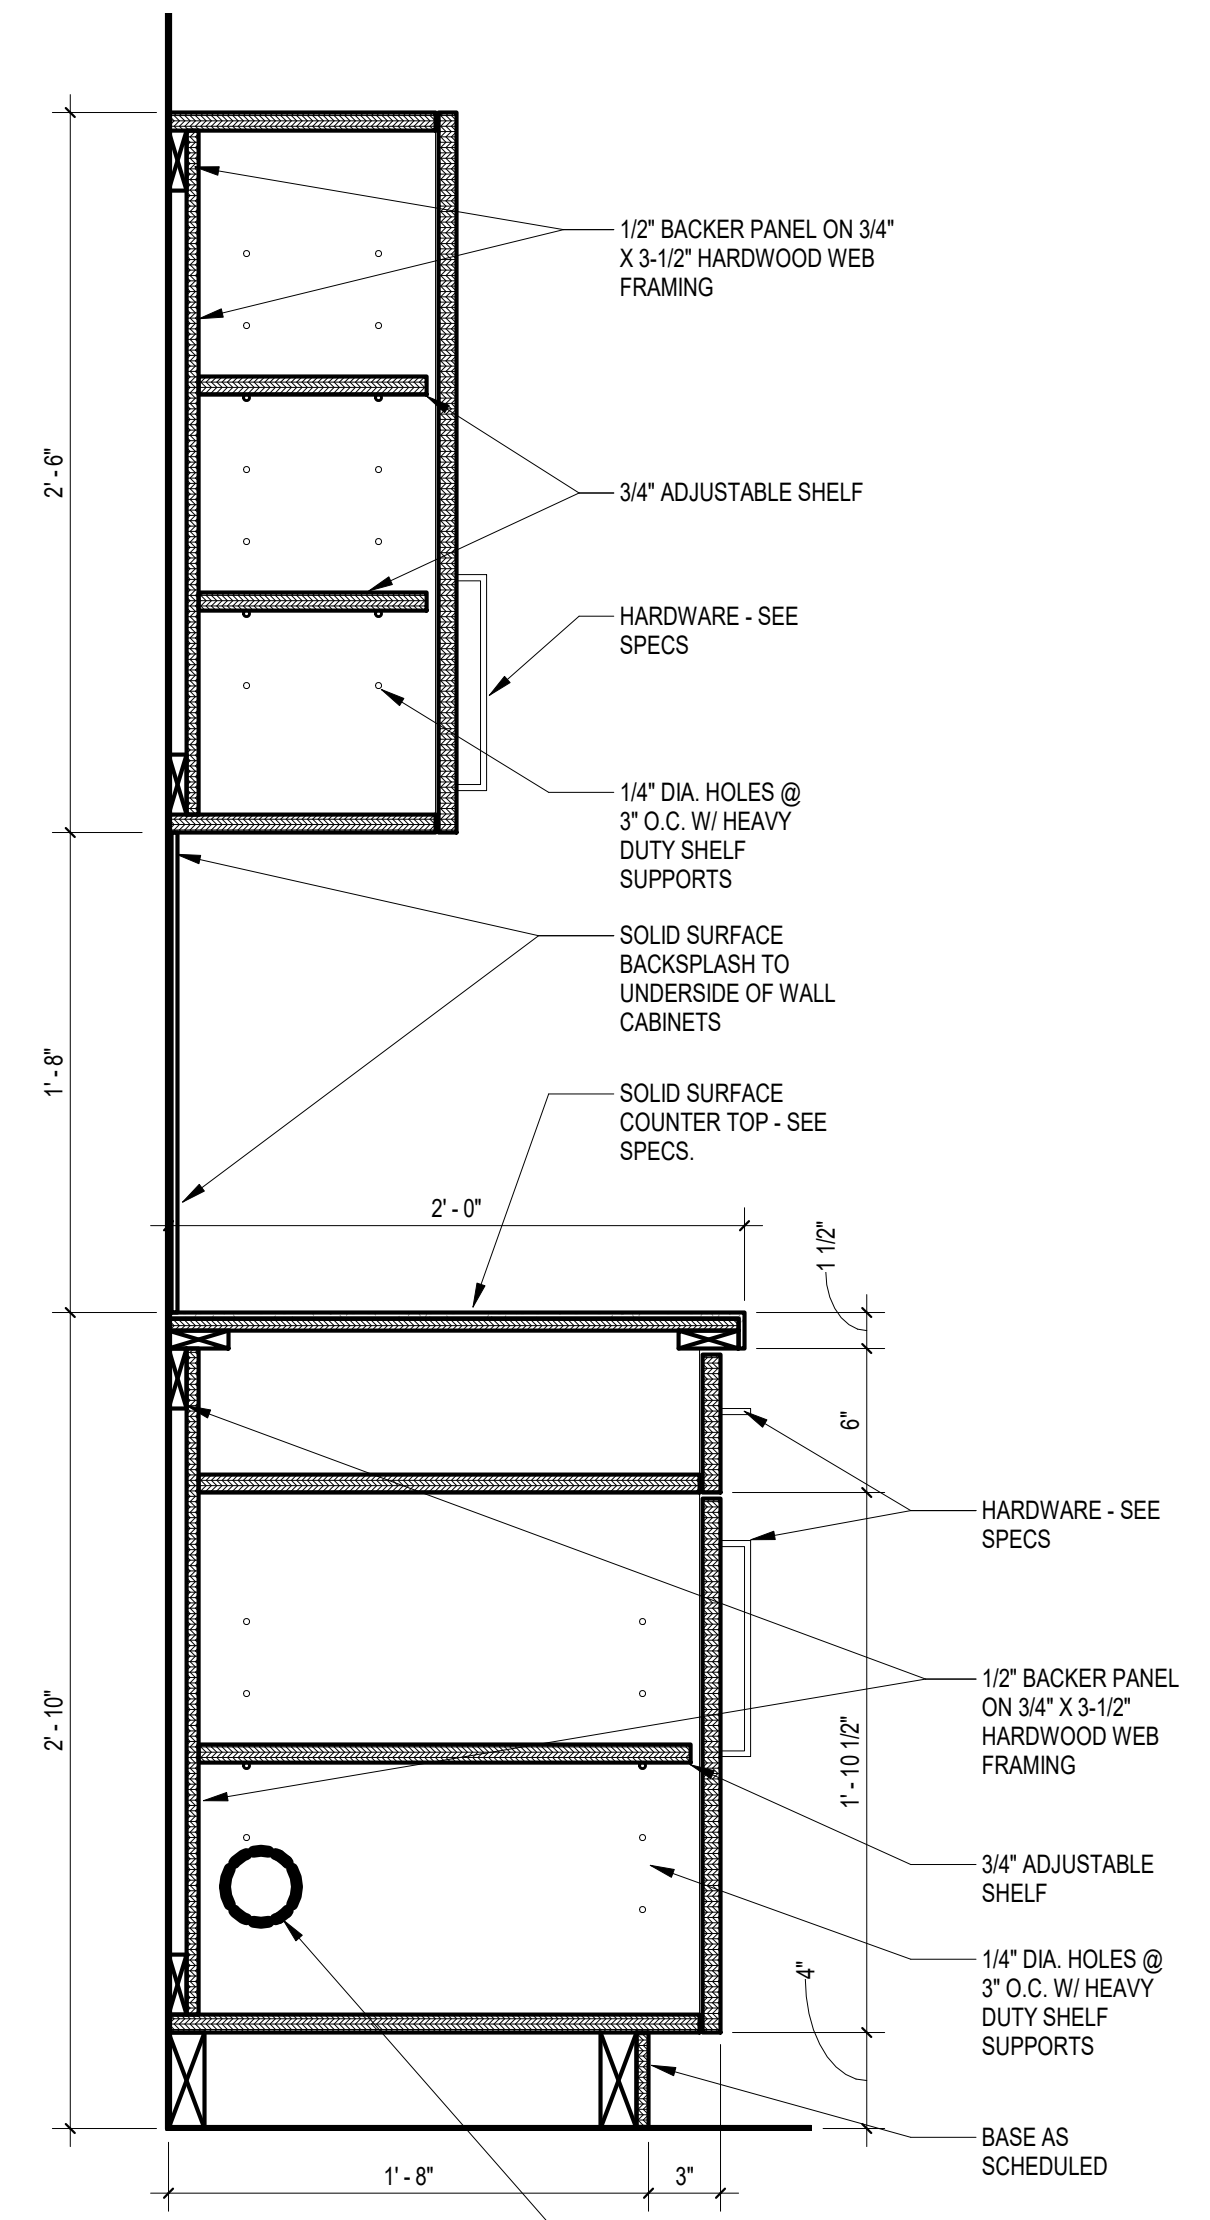


5 CASEWORK SECTION
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 REFERENCED ON: A8.2

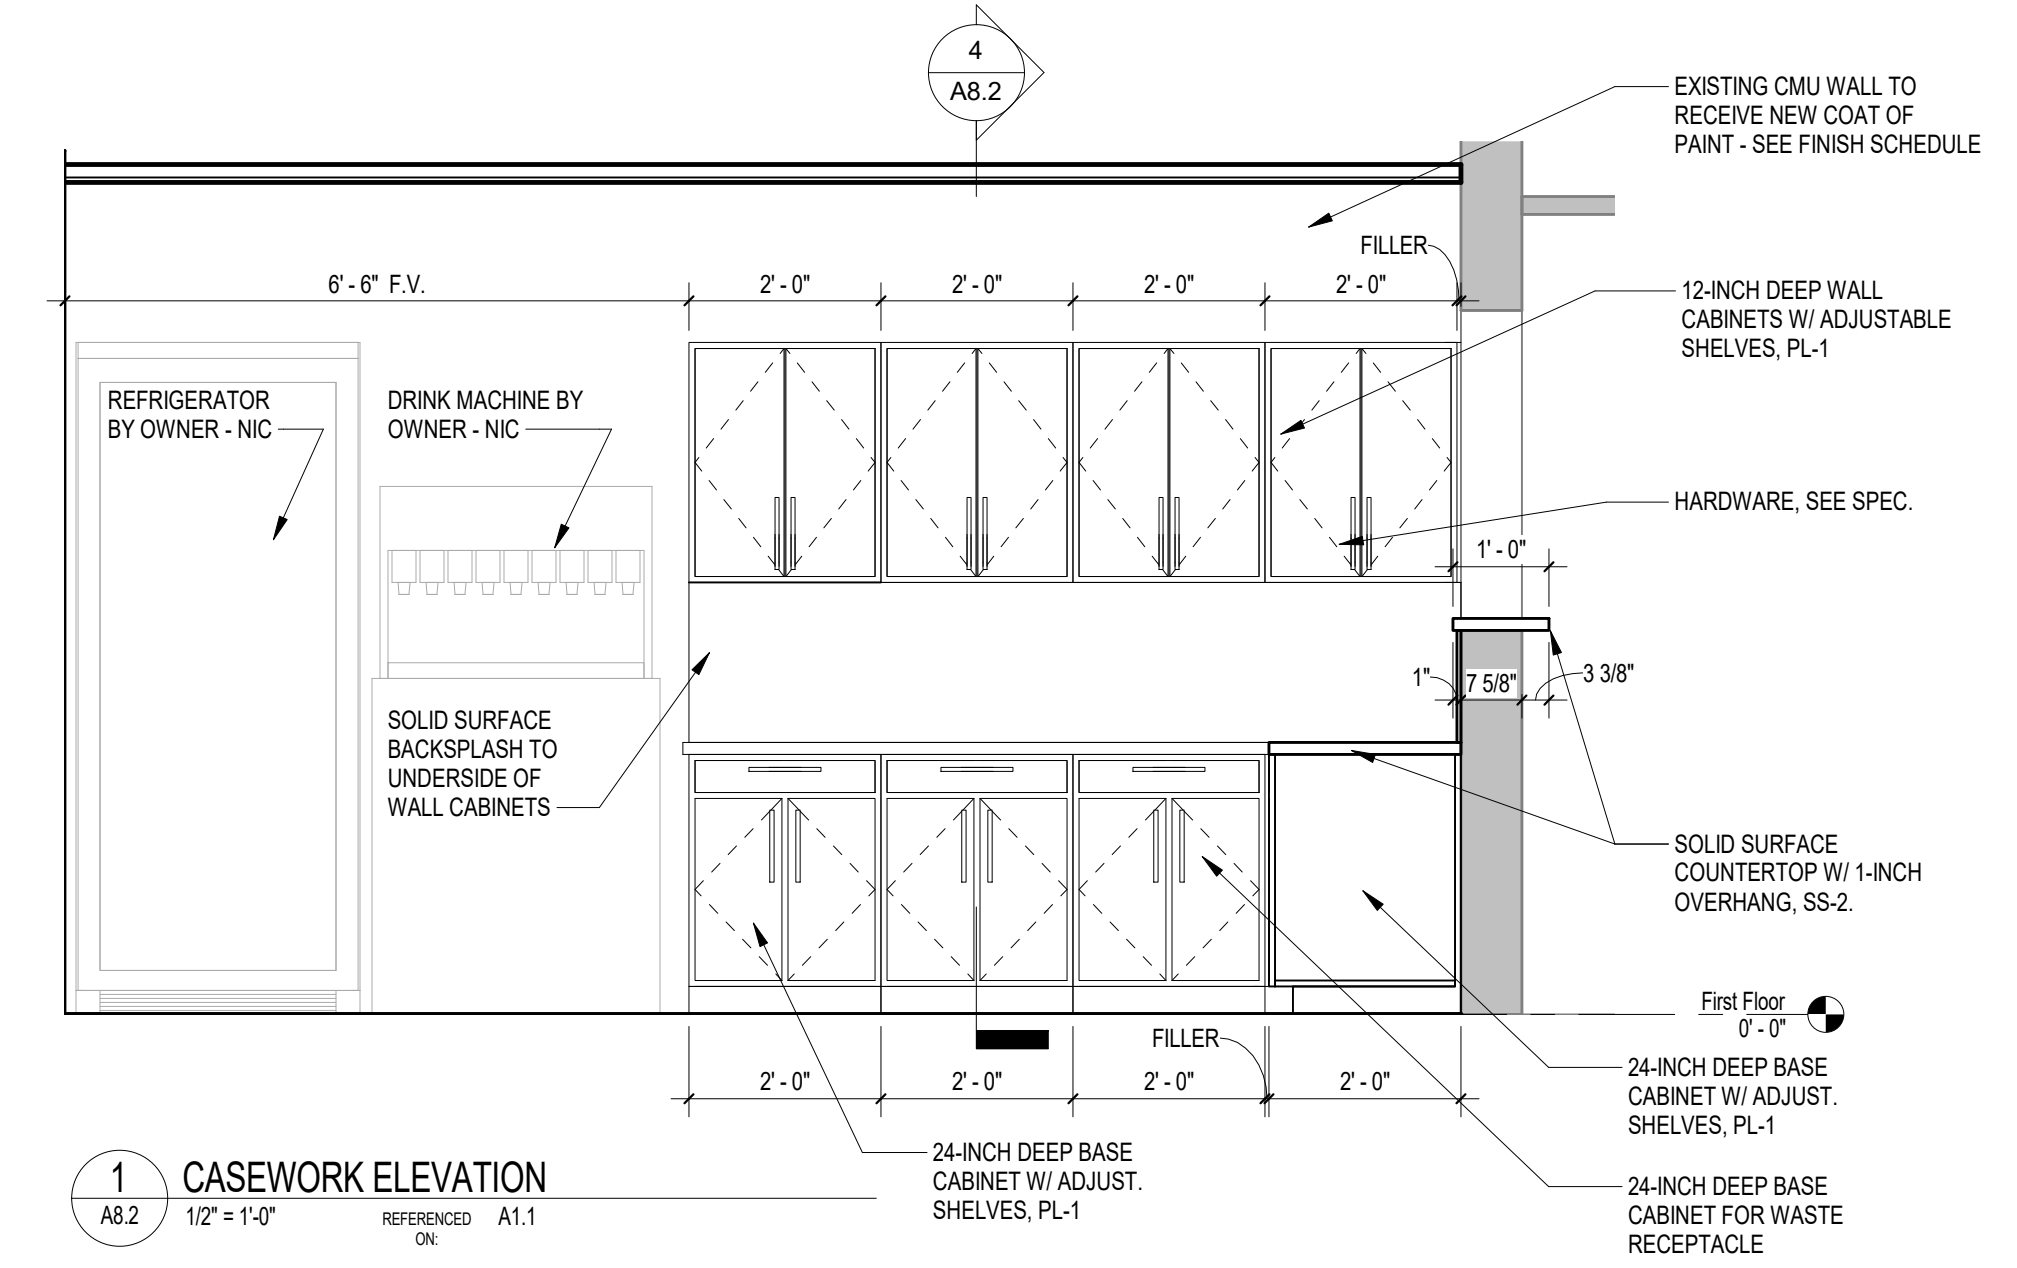


1 CASEWORK ELEVATION
 A8.2 1/2" = 1'-0"
 REFERENCED ON: A1.1

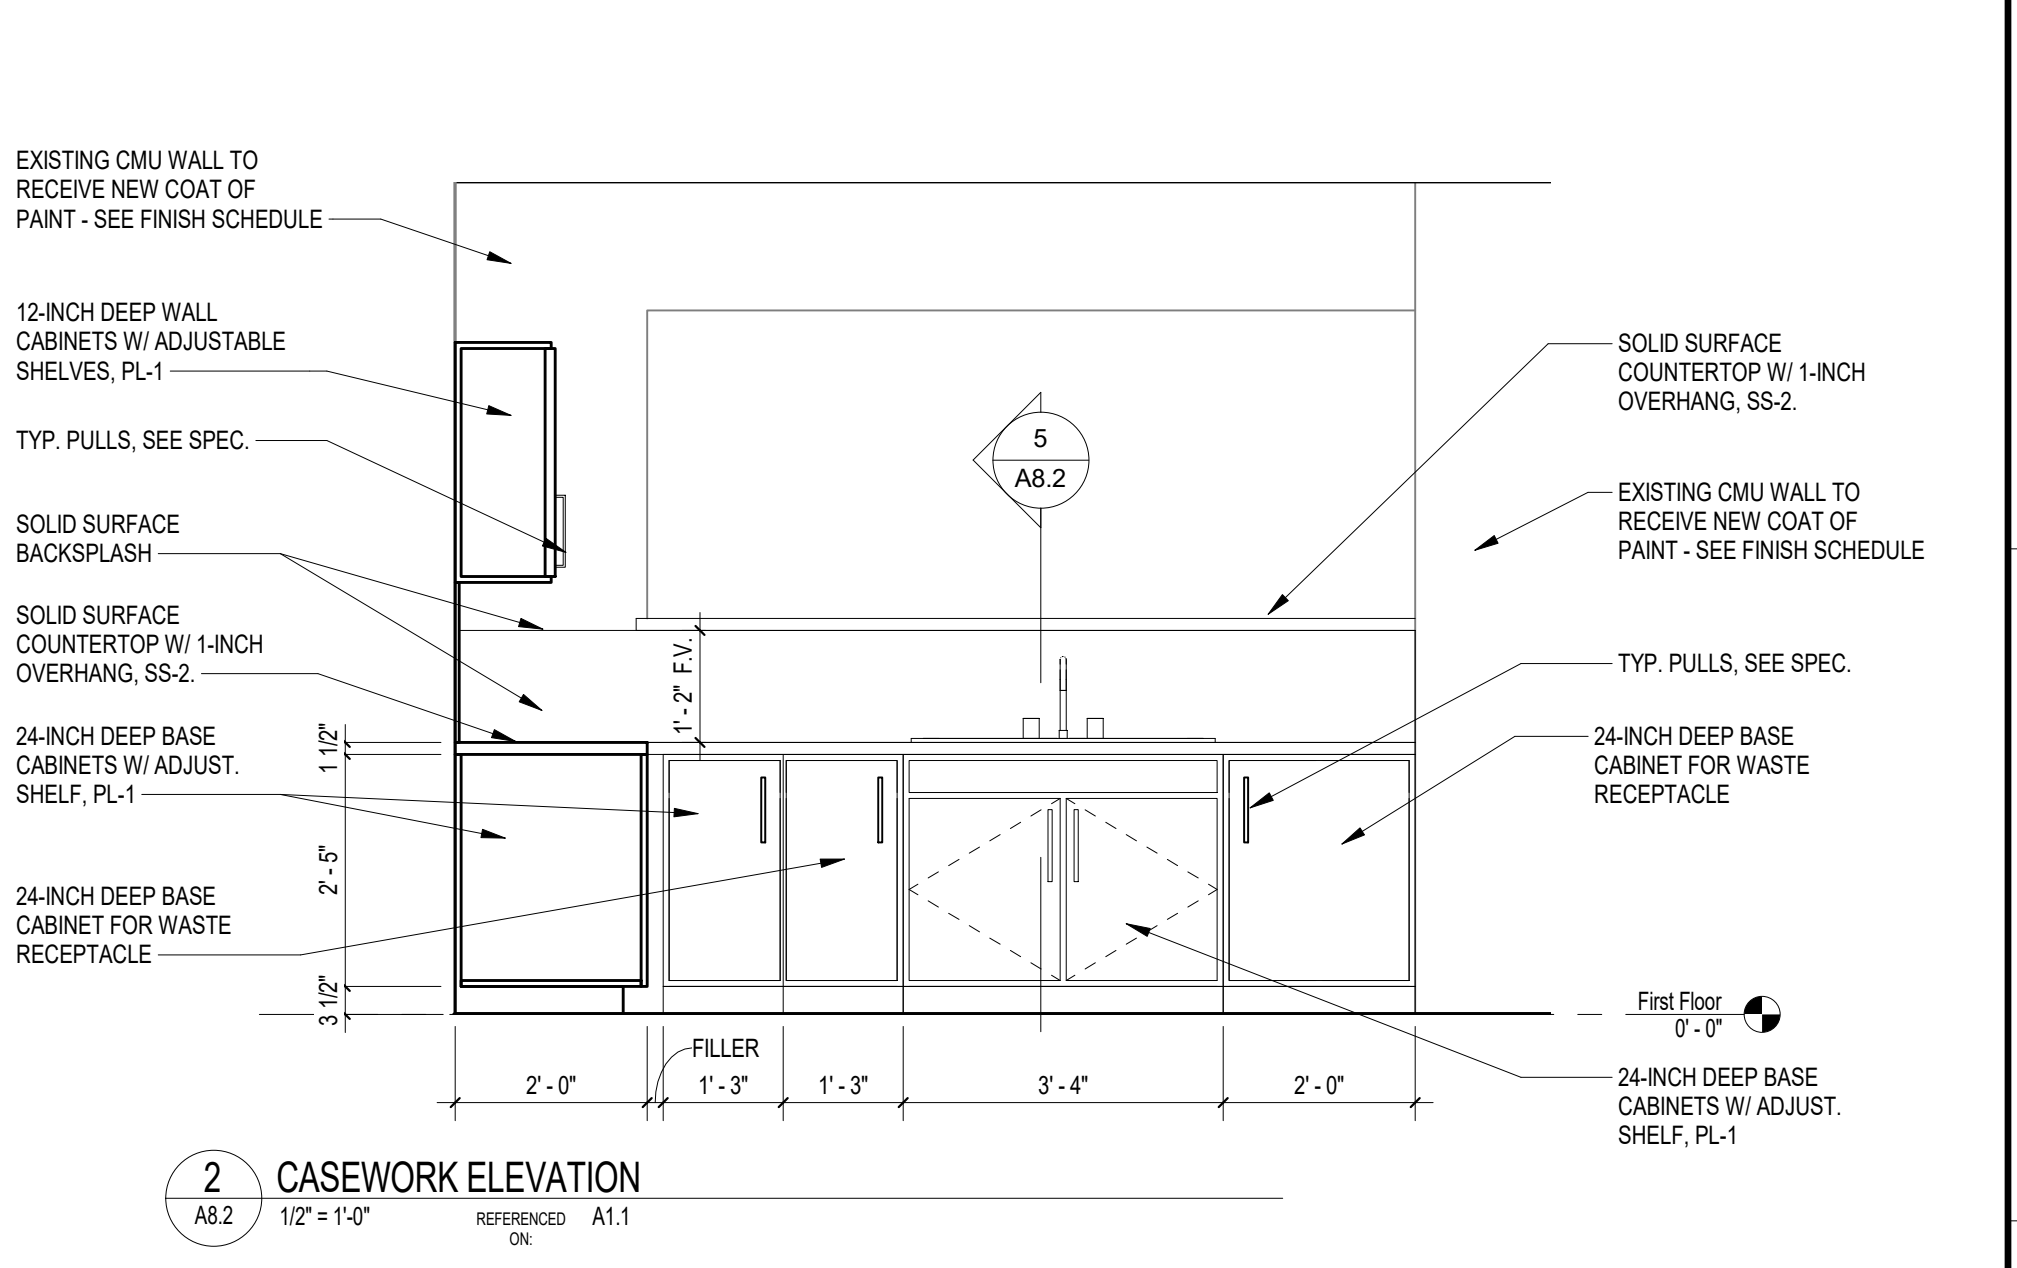


2 CASEWORK ELEVATION
 A8.2 1/2" = 1'-0"
 REFERENCED ON: A1.1

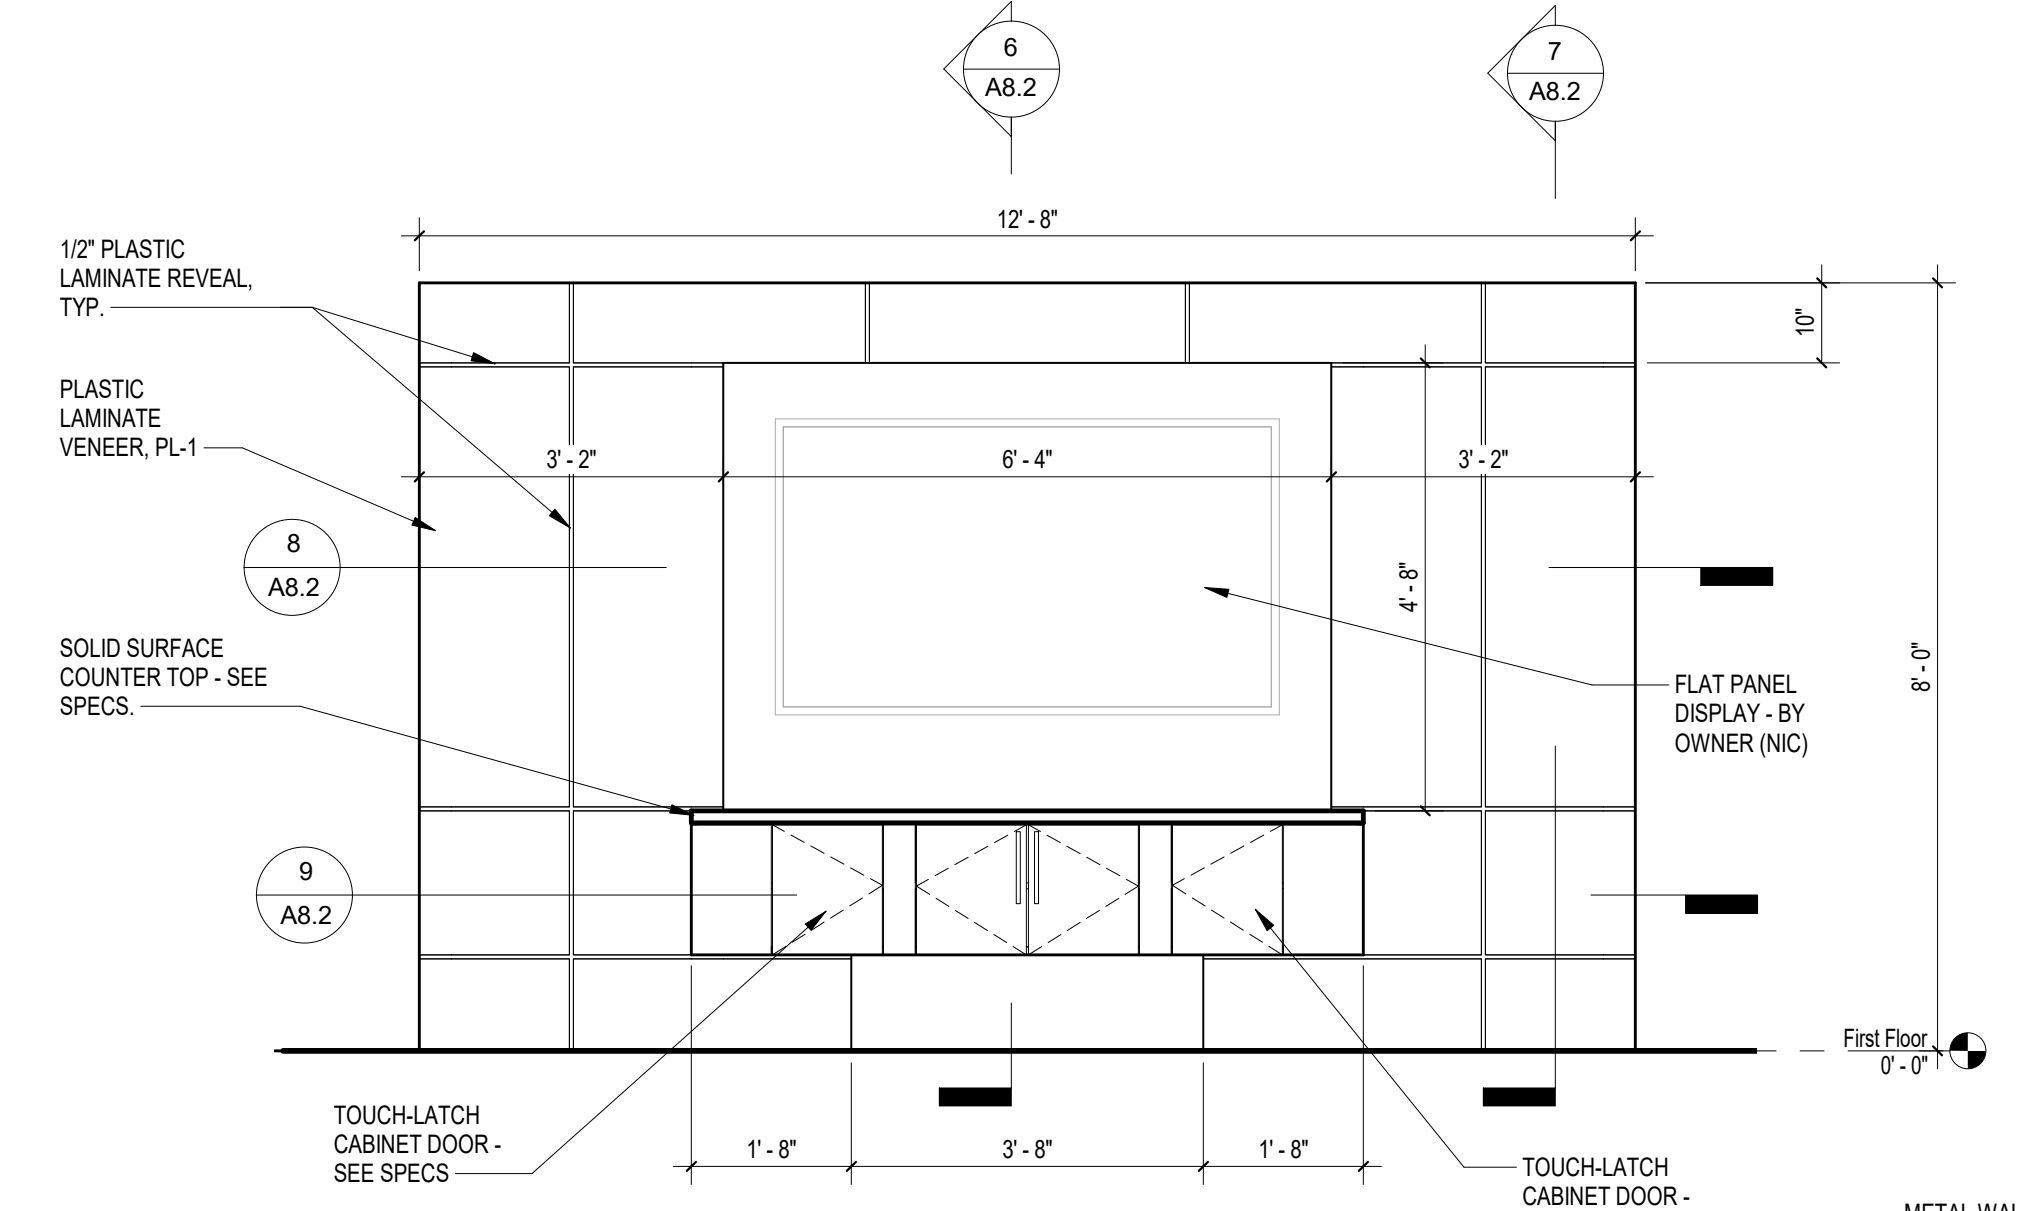


3 CASEWORK ELEVATION
 A8.2 1/2" = 1'-0"
 REFERENCED ON: A1.1

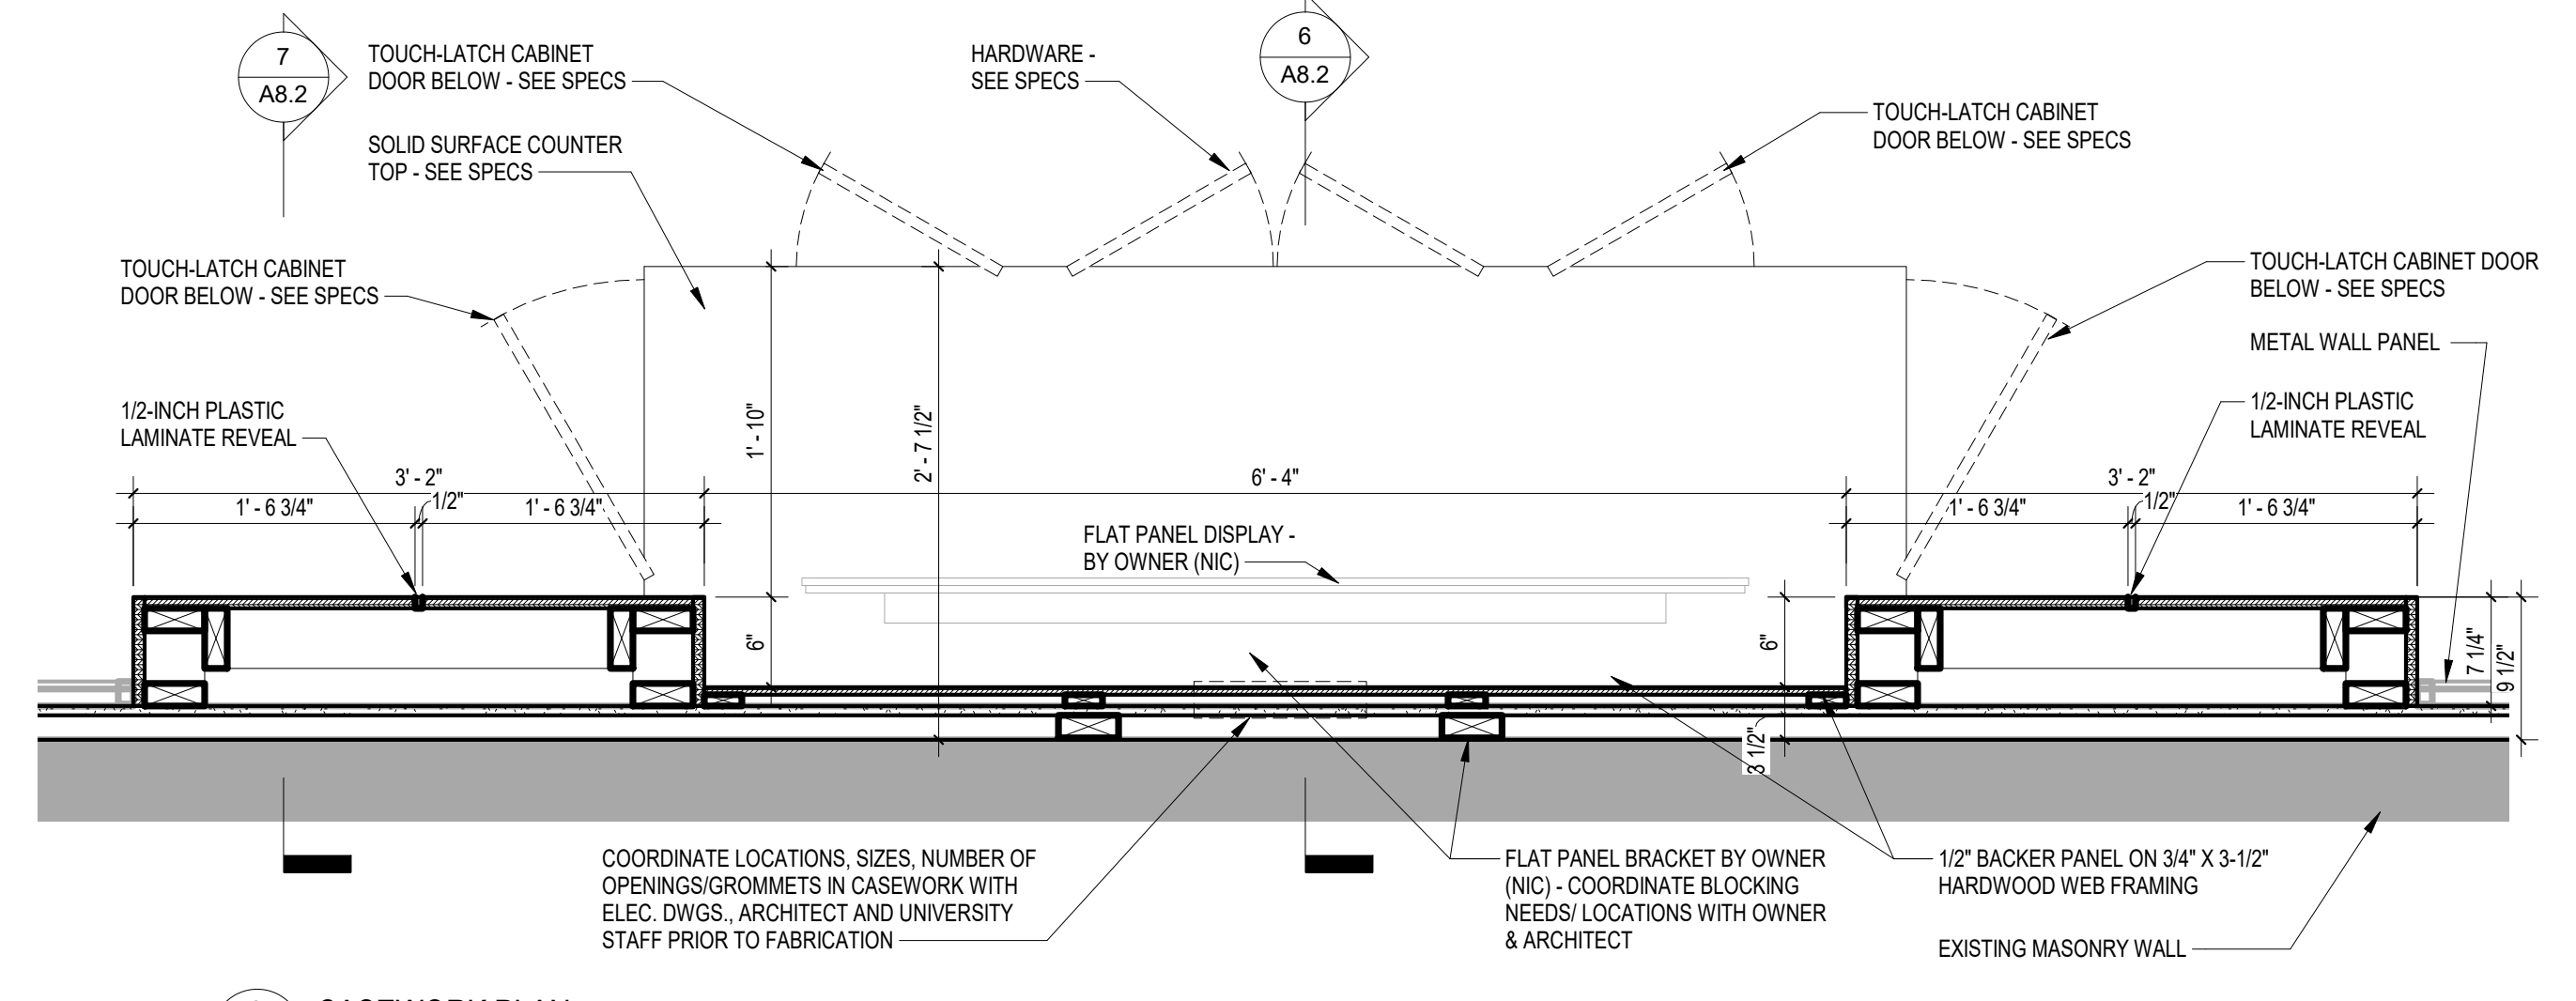


8 CASEWORK PLAN
 A8.2 1" = 1'-0"
 REFERENCED ON: A1.1

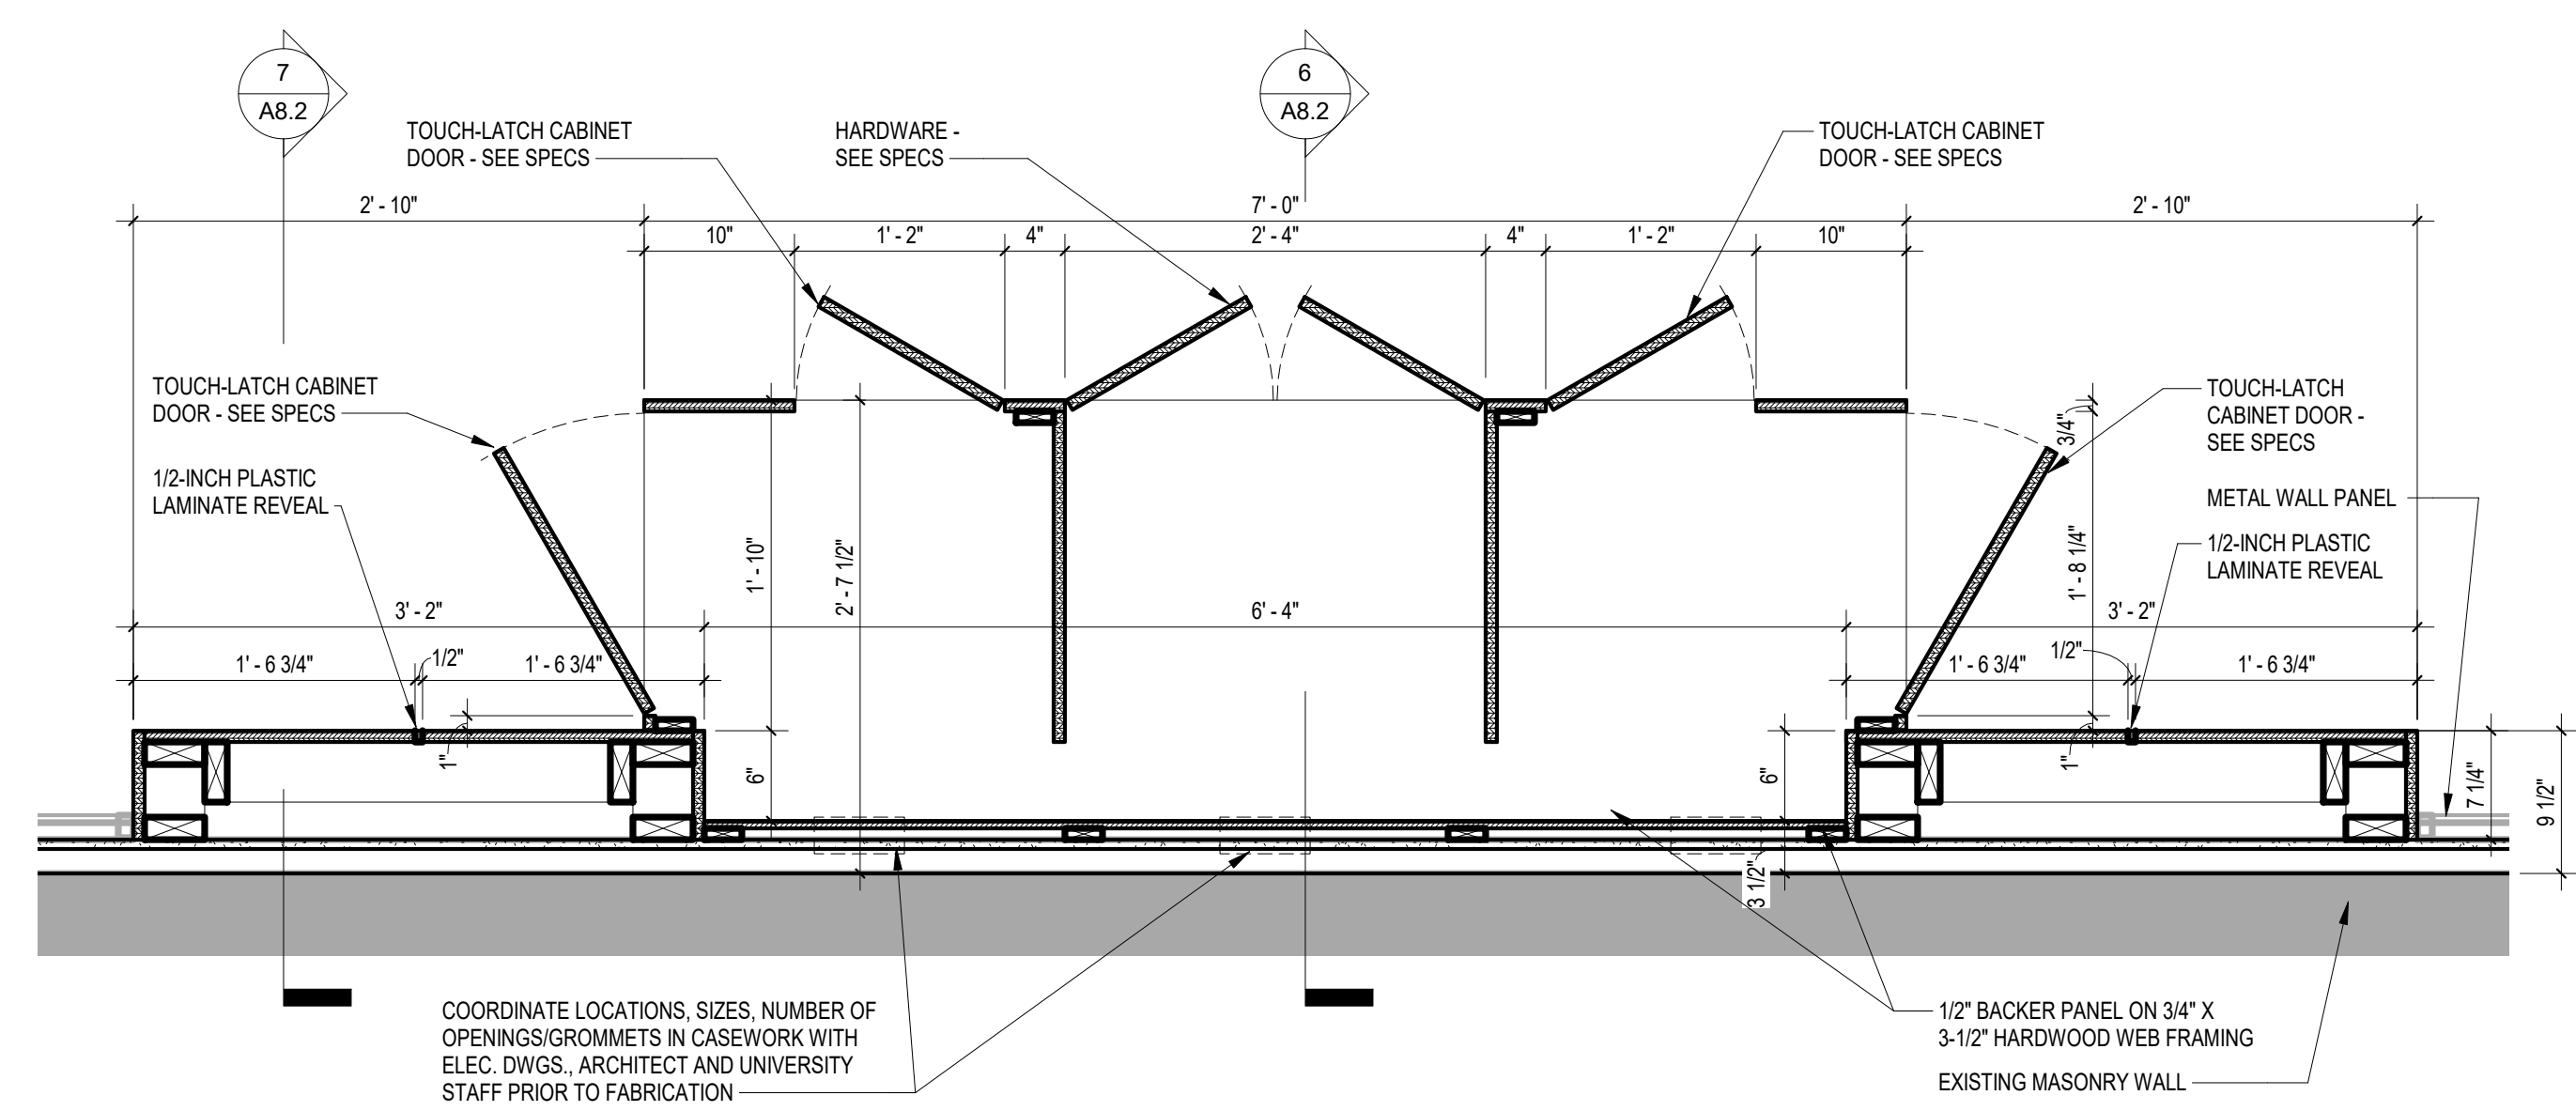

9 CASEWORK PLAN
 A8.2 1" = 1'-0"
 REFERENCED ON: A8.2

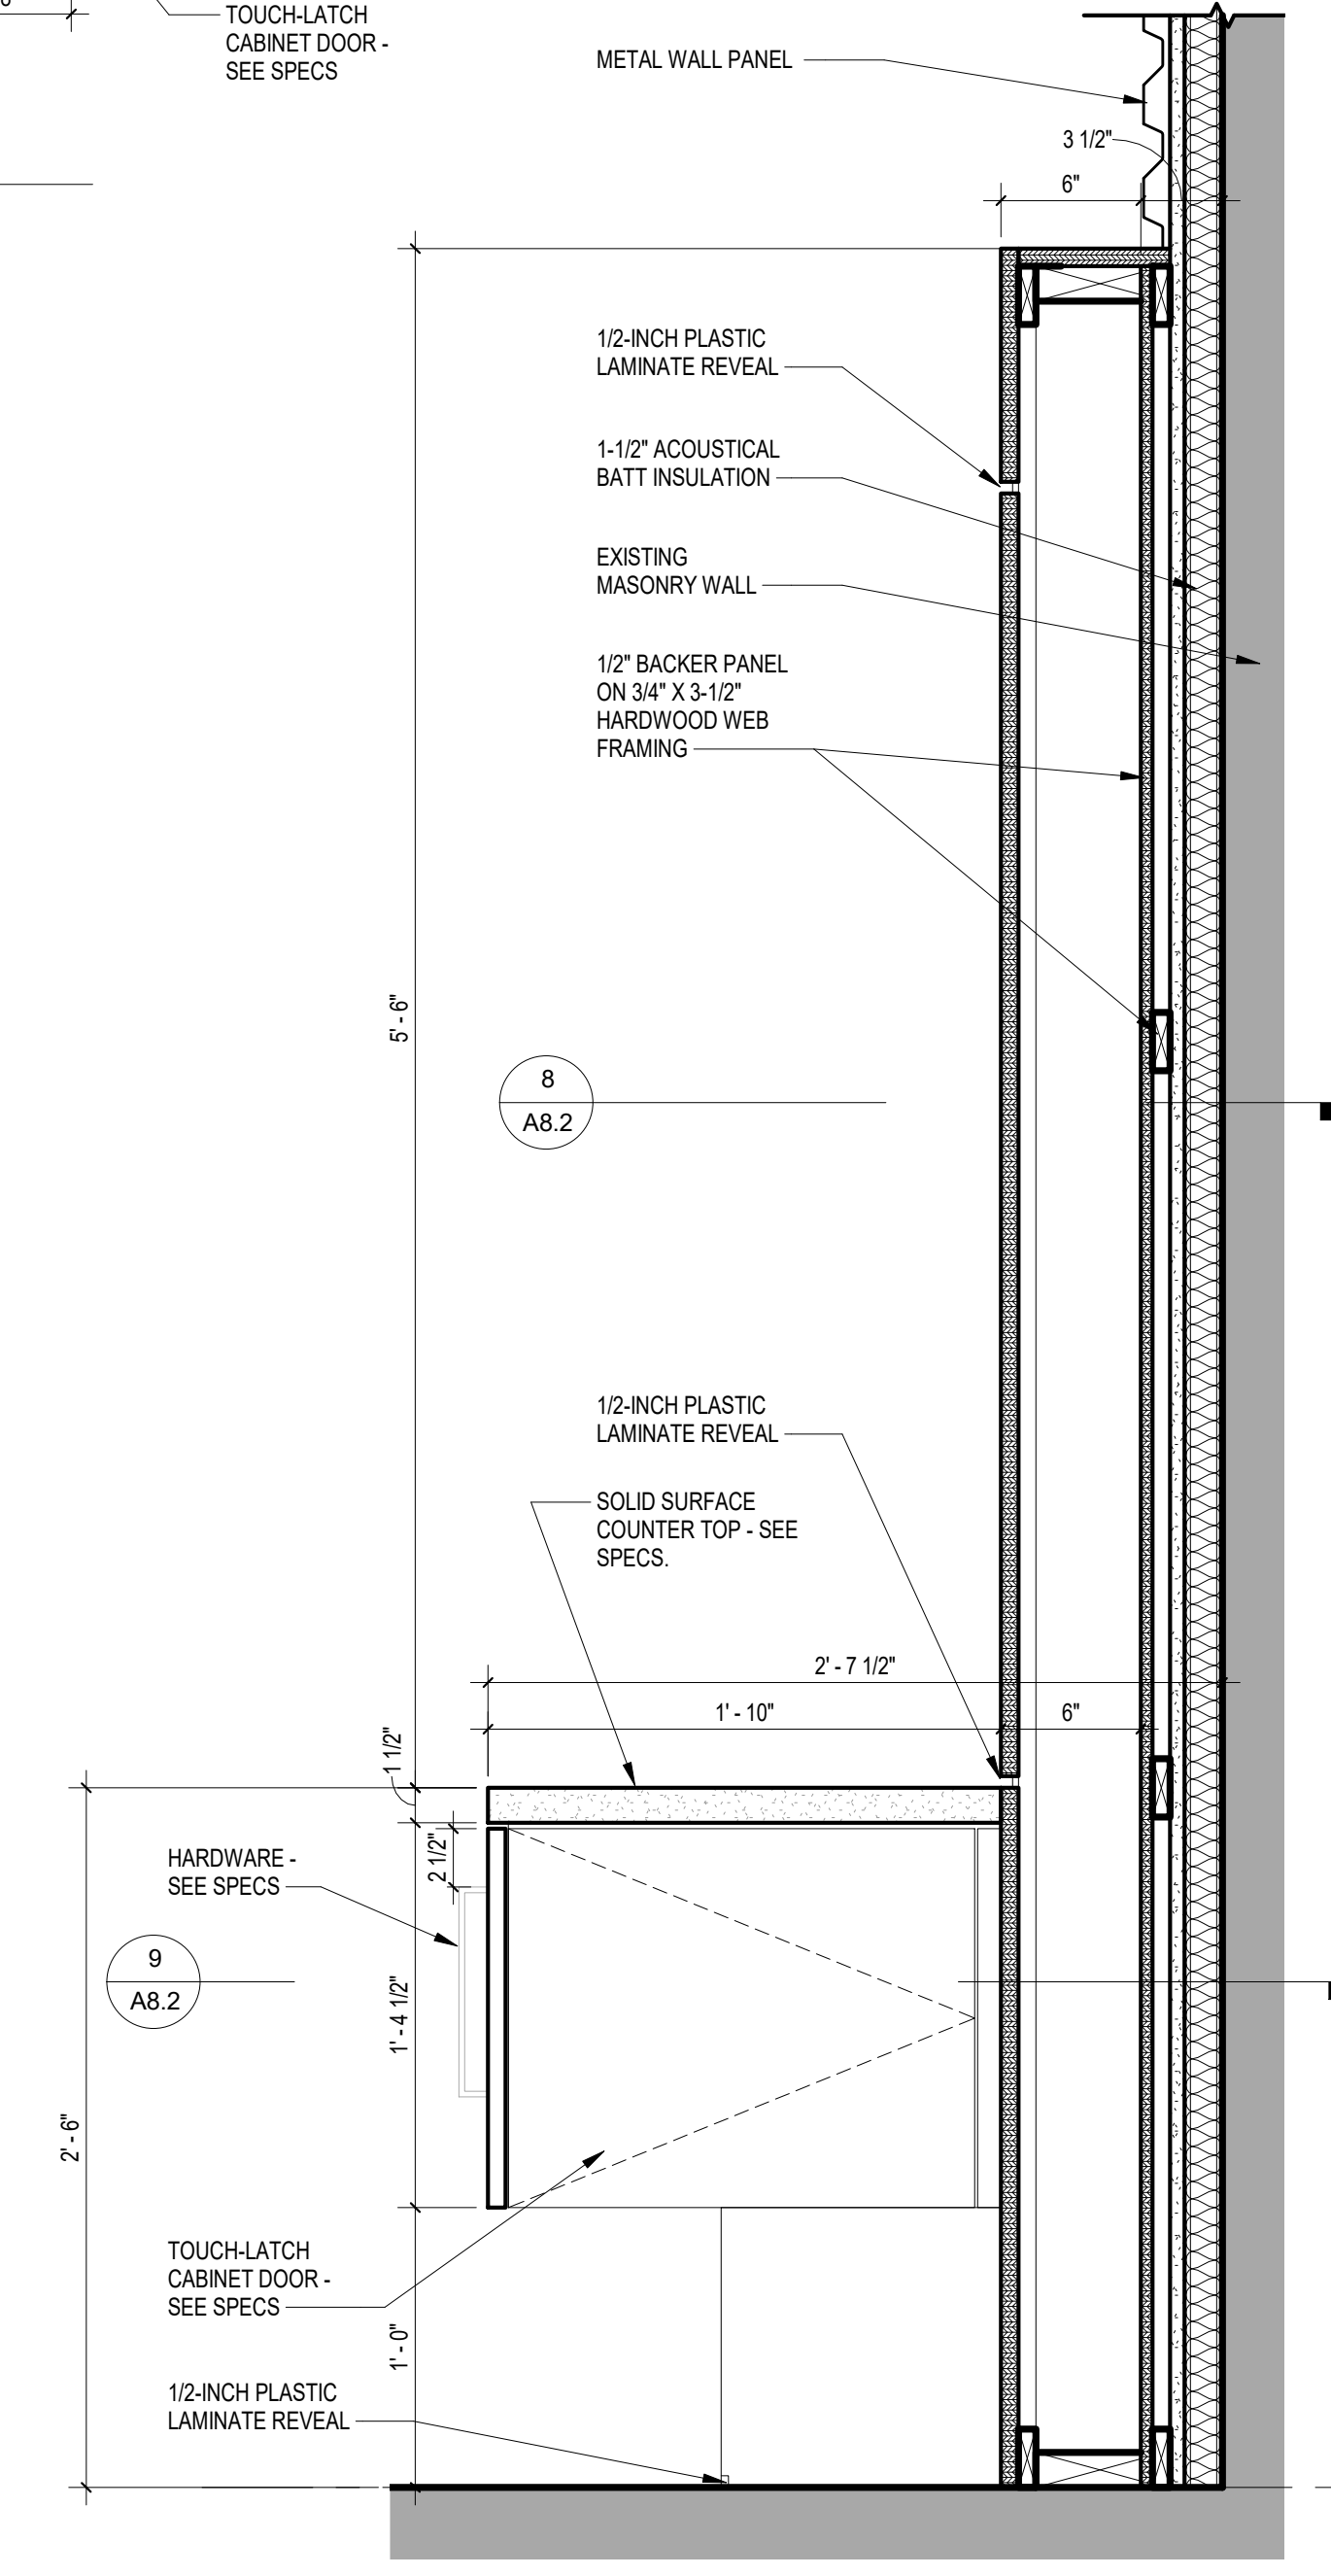


7 CASEWORK SECTION
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 REFERENCED ON: A8.2

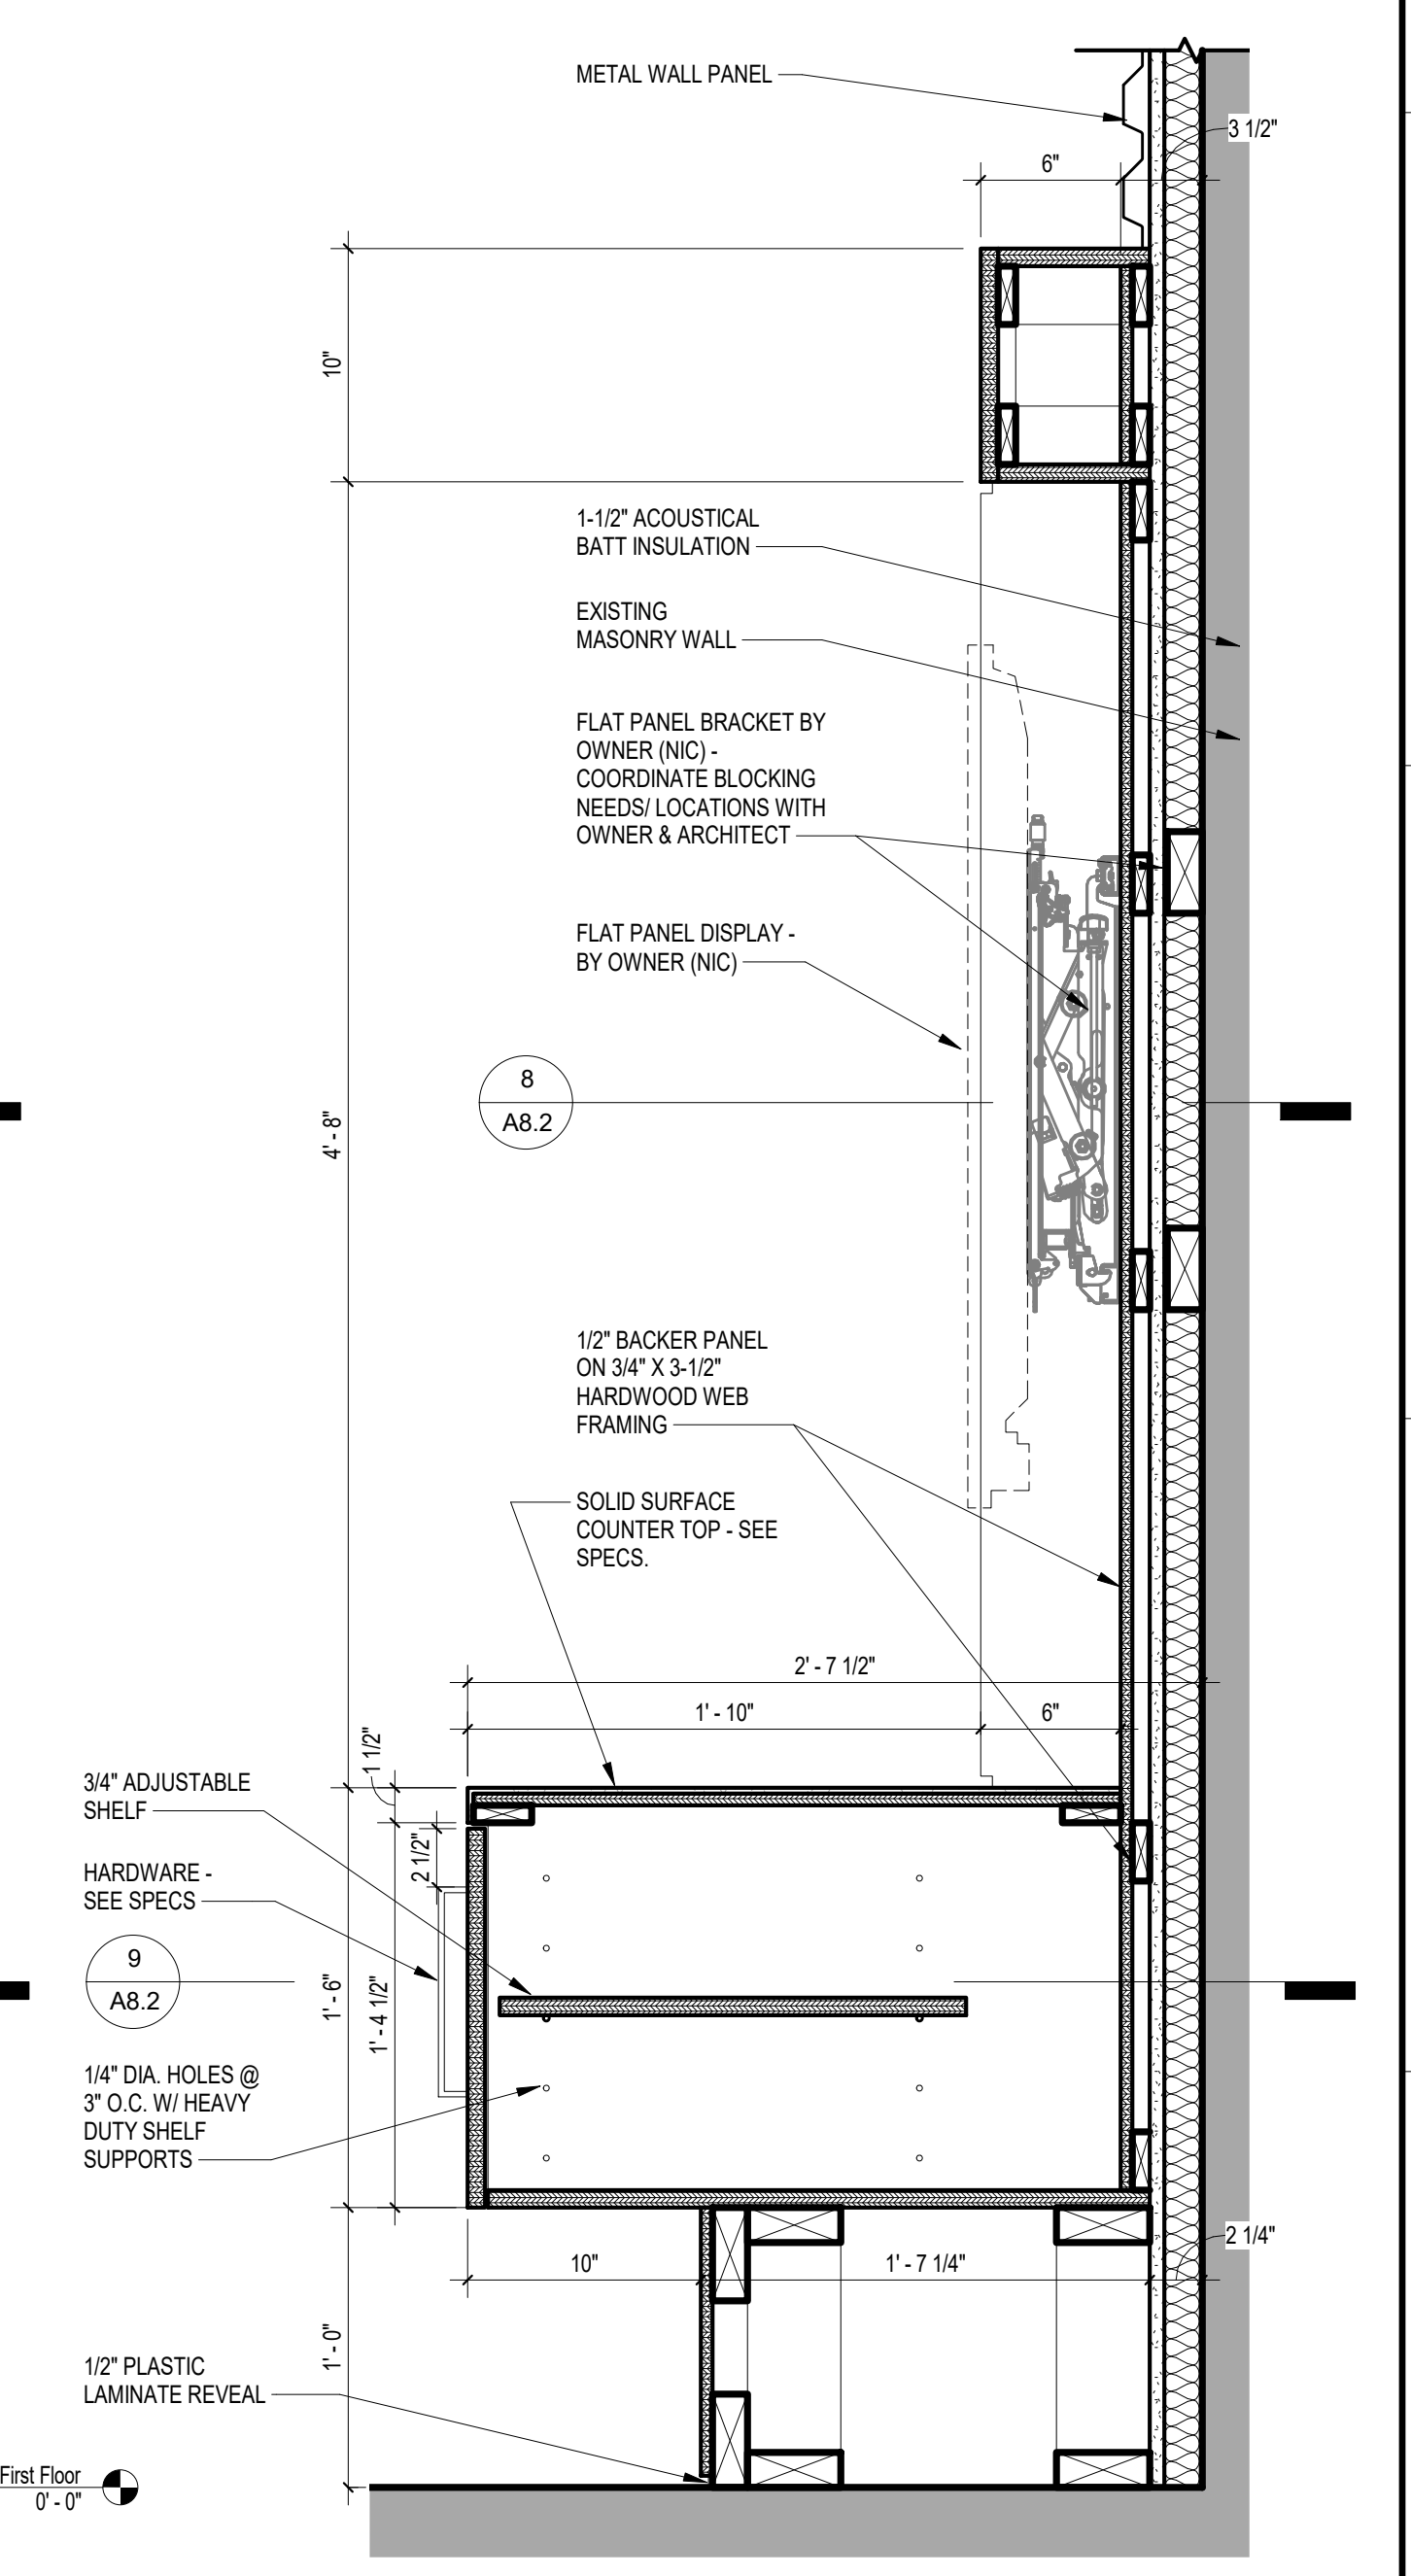


6 CASEWORK SECTION
 A8.2 1 1/2" = 1'-0"
 REFERENCED ON: A8.2


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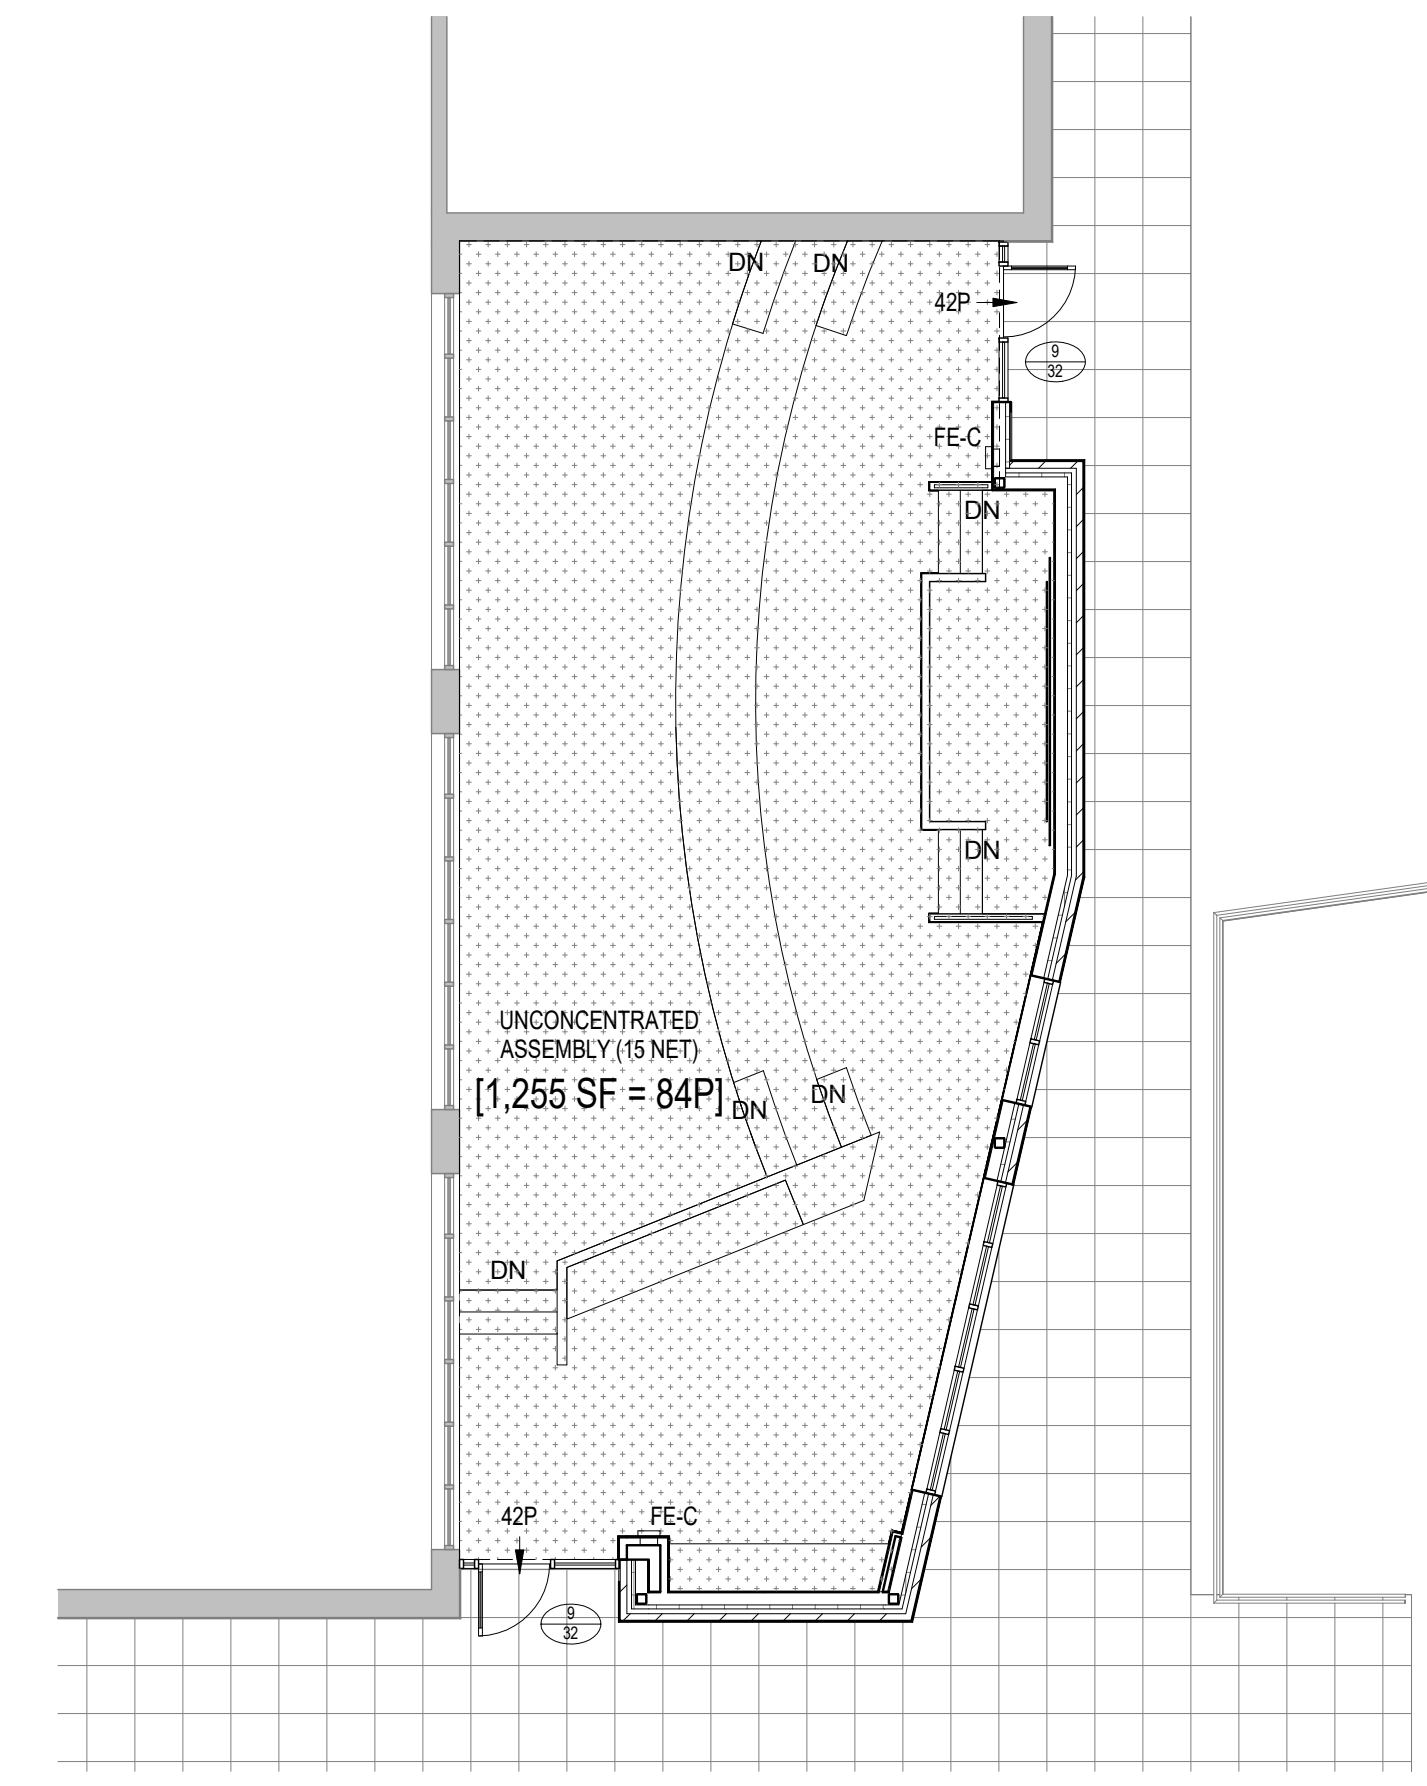
3 FEC PLAN DETAIL
X1.1 1 1/2" = 1'-0" REFERENCED OR

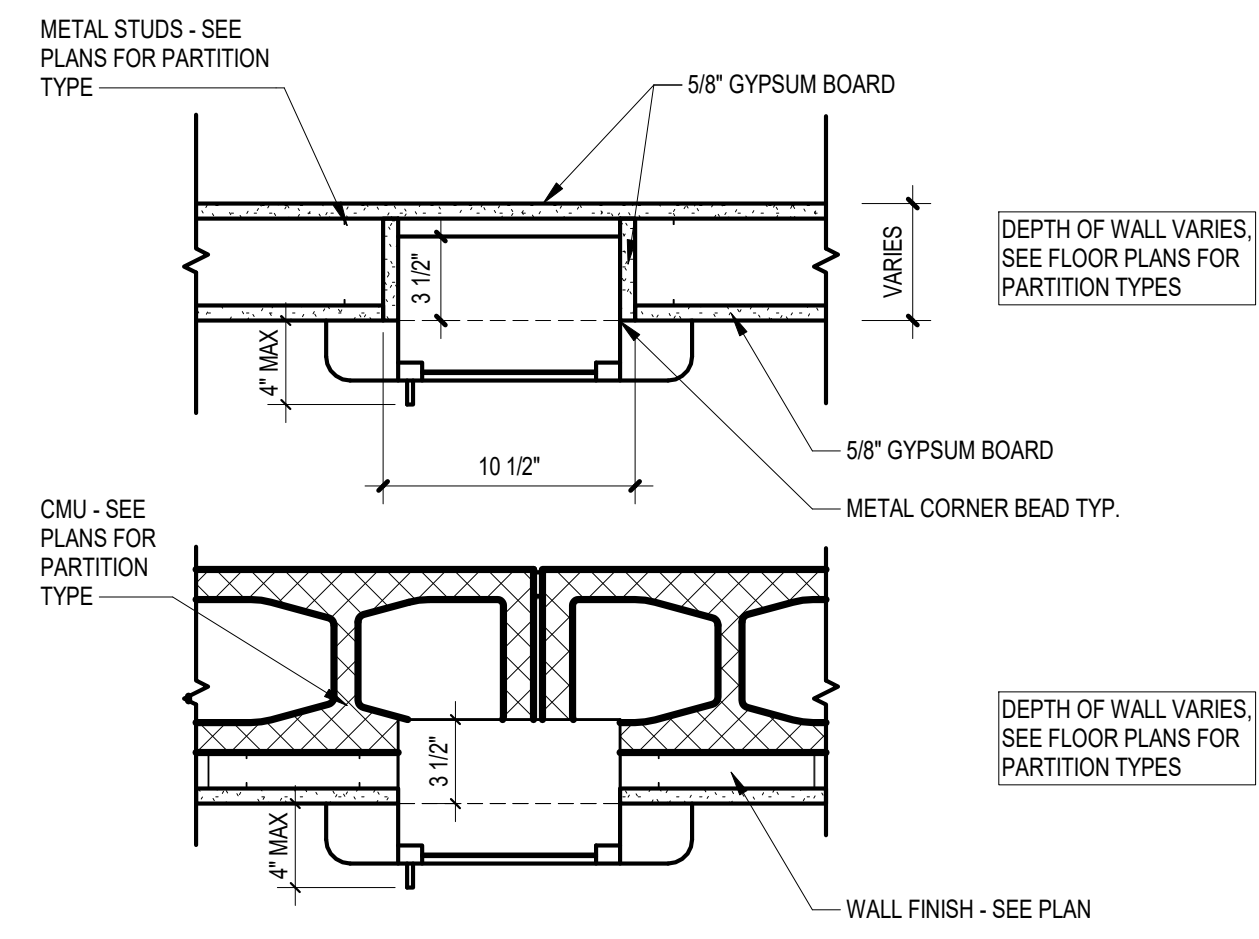

4 FEC SECTION DETAIL
X1.1 1 1/2" = 1'-0" REFERENCED OR

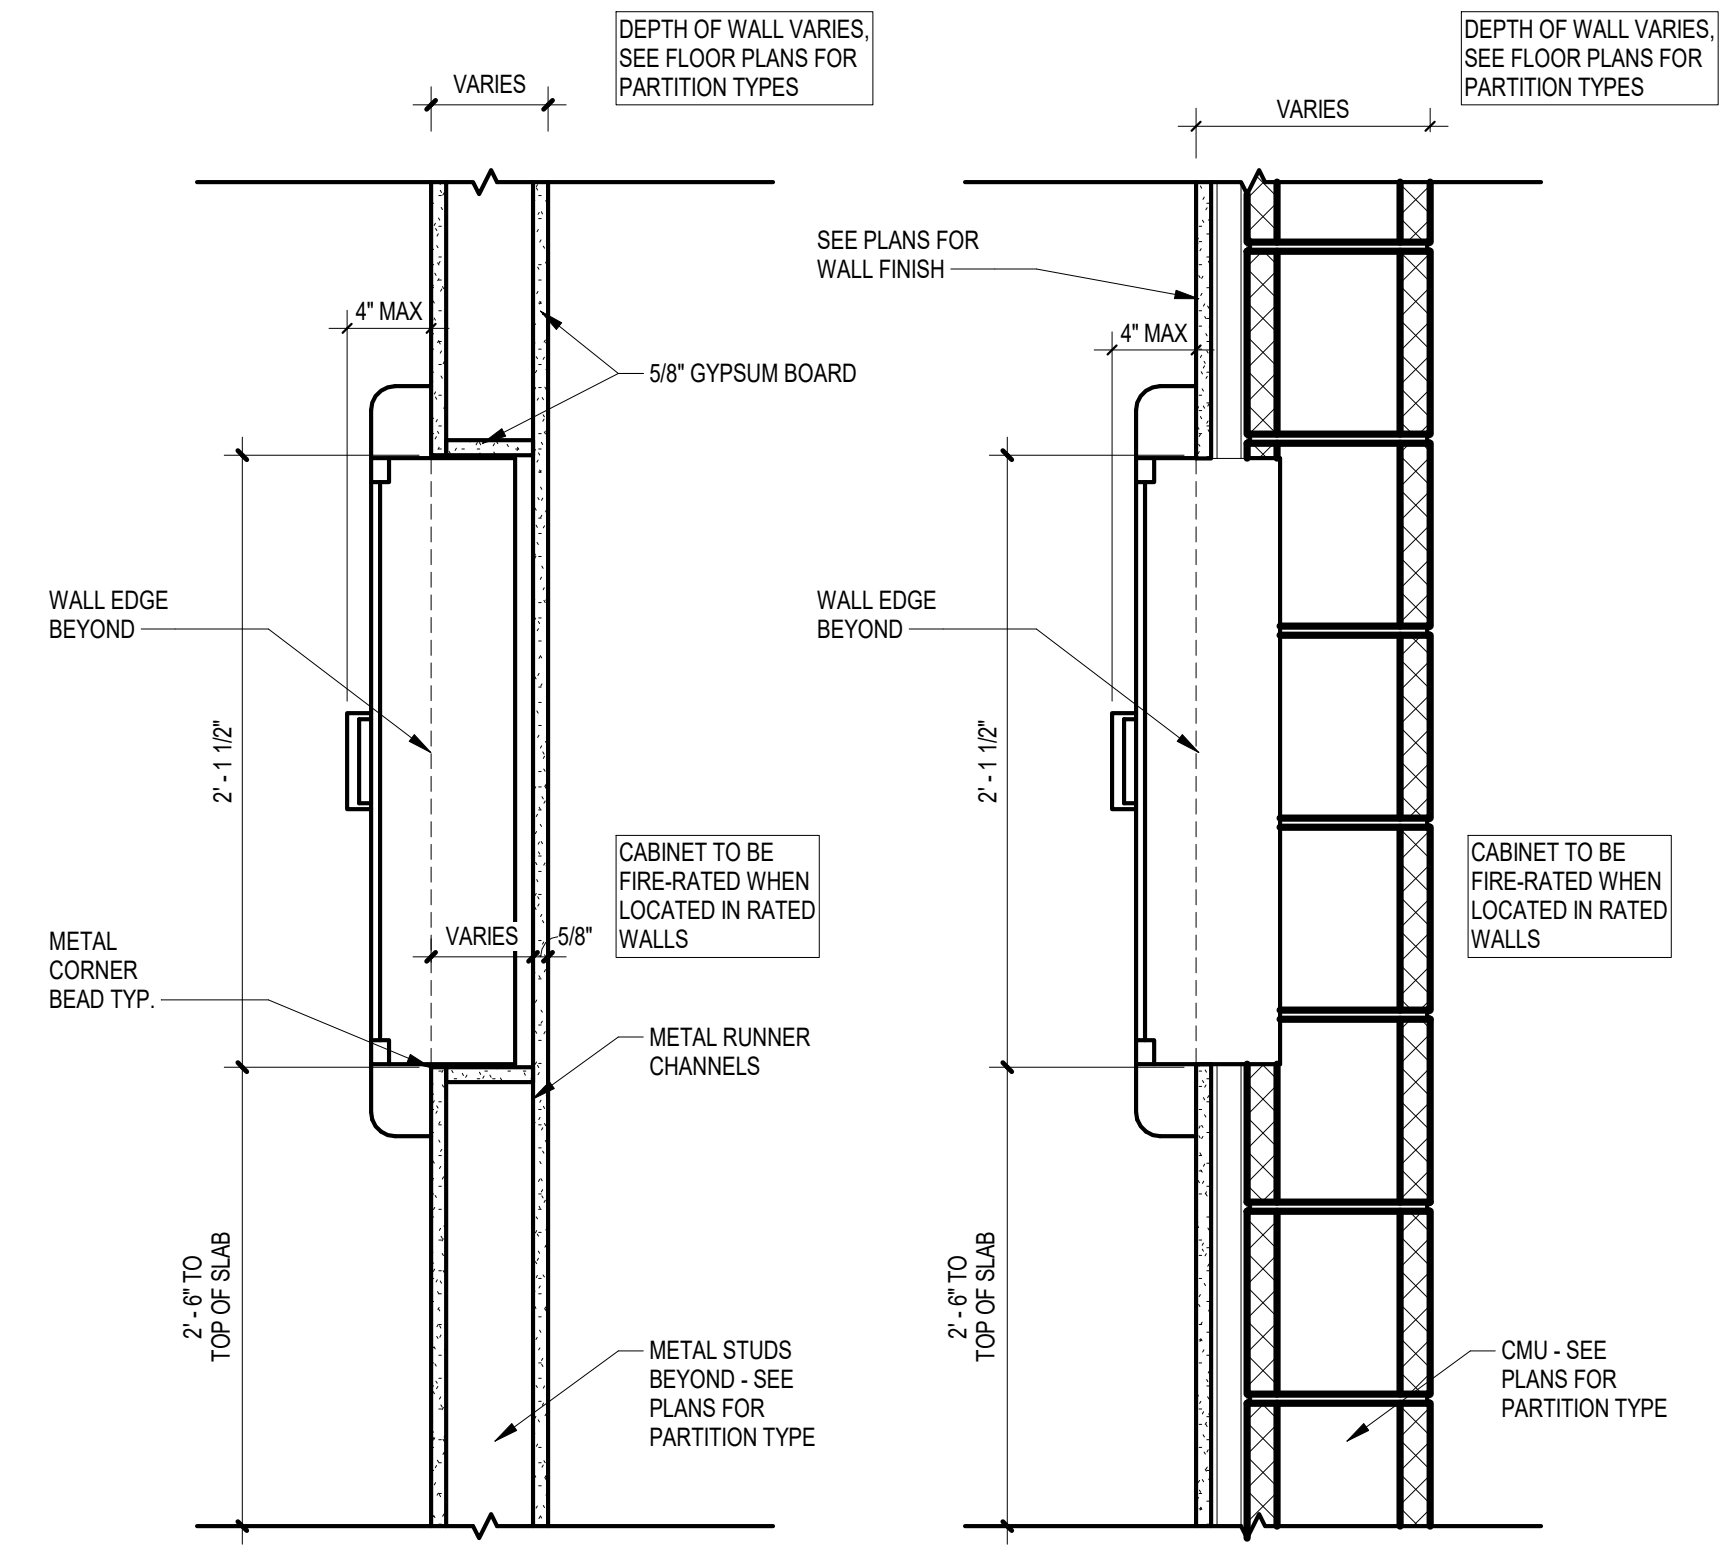


2 LIFE SAFETY PLAN - PLAYERS LOUNGE
X1.1 1/8" = 1'-0" REFERENCED OR

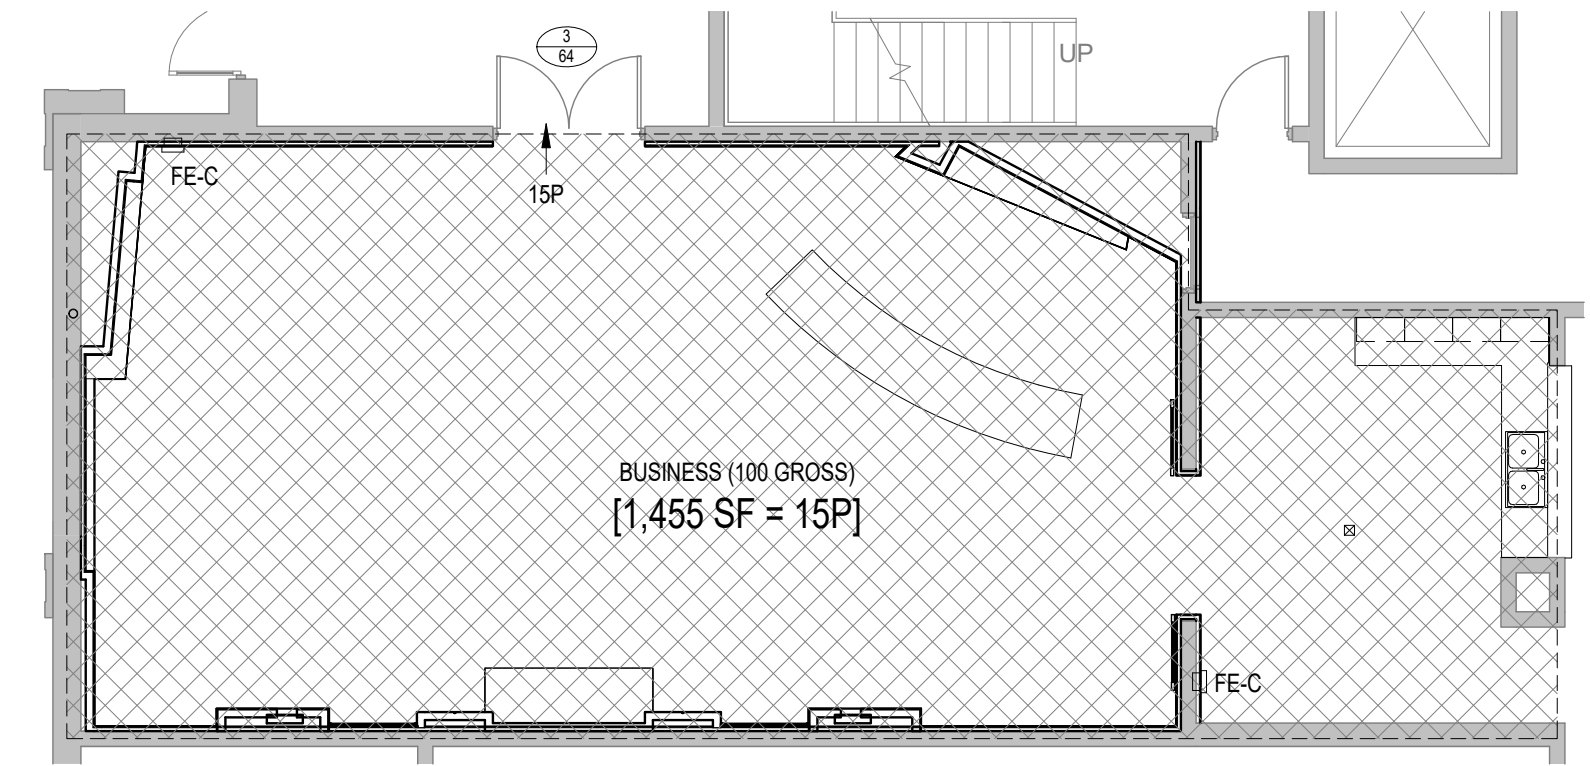

1 LIFE SAFETY PLAN - MEDIA ROOM
X1.1 1/8" = 1'-0" REFERENCED OR

LEGEND - LIFE SAFETY

- ONE-HOUR FIRE-RATED WALL ASSEMBLY
- SEE PARTITION TYPES FOR UL DESIGN NO'S.
- FE-C FIRE EXTINGUISHER RECESSED IN WALL CABINET
- FE-B FIRE EXTINGUISHER MOUNTED ON WALL BRACKETS
- EXIT LIGHTS - SEE ELECTRICAL DRAWINGS FOR LOCATIONS
- EGRESS WIDTH SYMBOLS**
- 5/34 REQUIRED EGRESS WIDTH AT DOOR, IN INCHES
EGRESS WIDTH PROVIDED AT DOOR, IN INCHES
- 4'-0"/(2'-4") EGRESS WIDTH PROVIDED AT PASSAGE
REQUIRED EGRESS WIDTH AT PASSAGE
- 23 # OF PEOPLE/DIRECTION OF TRAVEL
- (9,860 SF = 50P) NET (OR GROSS) SQ. FT./# OF PEOPLE (OCCUPANCY OF SPACE)
- TRAVEL DISTANCE LEGEND**
- 248'-1" TRAVEL DIST.
- 250' TO EXIT FROM REMOTE CORNER

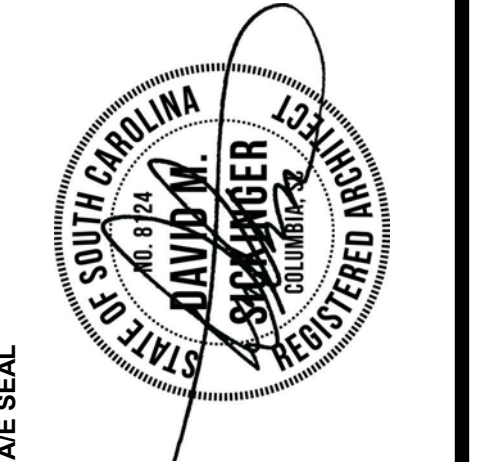

**UNIVERSITY OF SOUTH CAROLINA
FOUNDERS PARK PLAYERS LOUNGE
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431 WILLIAMS STREET
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LIFE SAFETY PLANS, FIRE EXTINGUISHER CABINET DETAILS

STRUCTURAL/GENERAL NOTES:

- 1. THE NOTES PRESENTED IN THESE STRUCTURAL DRAWINGS ARE TO PROVIDE THE CONTRACTOR (AND SUBCONTRACTORS) WITH INFORMATION PERTAINING TO THE STRUCTURAL DESIGN FOR THIS PROJECT...
2. THE STRUCTURAL NOTES FOR THIS PROJECT ARE GENERALLY CATEGORIZED AS TO WORK TRADE...
3. THE LEAD (ARCHITECTURAL) DRAWINGS SHALL BE CONSIDERED THE ORIGINAL SOURCE FOR THE DIMENSIONS FOR THE PROJECT...
4. AS PART OF MEANS AND METHODS, THE CONTRACTOR IS SOLELY RESPONSIBLE FOR THE DESIGN AND ERECTION OF TEMPORARY BRACING AND SHORING AS REQUIRED FOR STABILITY OF THE STRUCTURAL SYSTEM AND STRUCTURAL COMPONENTS DURING ALL PHASES OF CONSTRUCTION...
5. IT IS THE CONTRACTOR'S RESPONSIBILITY TO IDENTIFY, GATHER AND SUBMIT ALL SHOP DRAWINGS TO THE ARCHITECT OR LEAD DESIGNER FOR STRUCTURAL COMPONENTS...
6. THE ENGINEER'S APPROVAL OF SHOP DRAWINGS SHALL NOT RELIEVE THE CONTRACTOR OF THE RESPONSIBILITY FOR DEVIATIONS FROM REQUIREMENTS IN THE CONTRACT DOCUMENTS AND THE PROJECT SPECIFICATION REQUIREMENTS...
7. THESE STRUCTURAL DRAWINGS ARE FOR DESCRIBING THE STRUCTURAL DESIGN FOR THE PROJECT, IN AN EFFORT TO PREVENT FINISH ISSUES, FLOOR AND WALL FINISHES (PAINT, ETC.), TILE, FIXTURES AND ALL OTHER NON-STRUCTURAL COMPONENTS SHALL BE DESIGNED AND/OR SELECTED BY THE CONTRACTOR...
8. ALL SUSPENDED CEILING/OFFSET SYSTEMS (INCLUDING LIGHT FIXTURES) SHALL BE DESIGNED AS REQUIRED BY THE MANUFACTURERS', ATTACHMENTS, WIRES, STRUTS AND OTHER SUPPORTS SHALL BE SUFFICIENT TO RESIST THE CODE REQUIRED WIND (BOTH NEGATIVE AND POSITIVE PRESSURES) AND SEISMIC LOADS PER THE APPLICABLE EDITION OF THE APPROPRIATE BUILDING CODE(S)...
9. THE CONTRACTOR SHALL REFER TO ARCHITECTURAL DRAWINGS FOR ALL HALL OPENINGS INCLUDING DOORS AND WINDOWS, REFER TO ELECTRICAL AND MECHANICAL PLANS AND/OR REQUIREMENTS FOR SIZE AND LOCATION OF ALL OPENINGS FOR DUCTS, PIPING, CONDUITS, ETC...
10. THE CONTRACTOR SHALL REFER TO THE ARCHITECTURAL AND/OR VENDOR DRAWINGS FOR LOCATIONS OF DEPRESSED FLOOR AREAS, FLOOR DRAINS, FLOOR TOPPING, CURB COURSING AND ANY OTHER DETAILS NOT SHOWN ON THE STRUCTURAL DRAWINGS...
11. THESE DRAWINGS ARE AN INSTRUMENT OF SERVICE AND SHALL NOT BE REPRODUCED, ALTERED OR REUSED IN WHOLE OR IN PART WITHOUT THE WRITTEN PERMISSION OF KYZER & TIMMERMAN STRUCTURAL ENGINEERS...
12. QUESTIONS RELATING TO THESE STRUCTURAL DRAWINGS MAY BE SUBMITTED IN WRITING, THROUGH THE ARCHITECT OR PRIME PROFESSIONAL TO THE STRUCTURAL ENGINEER, THE STRUCTURAL ENGINEER SHALL BE COPIED AT: KYZER & TIMMERMAN STRUCTURAL ENGINEERS 580 Chris Drive, West Columbia, SC 29164 (803) 791-4511 (803) 791-4522 FAX

CONCRETE:

- 1. ALL CONCRETE AND REINFORCING BARS SHALL BE INSTALLED ACCORDING TO STANDARDS SET FORTH BY THE LATEST EDITION OF ACI-308.
2. REINFORCEMENT SHALL BE HELD IN PLACE DURING CONCRETE PLACEMENT. IF REQUIRED, ADDITIONAL BARS MAY BE PROVIDED BY THE CONTRACTOR TO FURNISH SUPPORT FOR ALL BARS.
3. 20 DAY MINIMUM CONCRETE COMPRESSIVE STRENGTH SHALL BE 4000 PSI UNO.
4. NO ADDITIONAL WATER SHALL BE ADDED TO THE CONCRETE ABOVE THAT PRESCRIBED IN THE MIX DESIGN UNLESS APPROVED BY THE ARCHITECT OR STRUCTURAL ENGINEER.
5. REINFORCING STEEL SHALL BE GRADE 60, MINIMUM LAP IN CONCRETE SHALL BE IN ACCORDANCE W/ ACI-308.
6. HELDED WIRE FABRIC SHALL BE LAPPED A MINIMUM OF 1'-0".
7. A QUALIFIED TESTING LABORATORY SHALL BE RETAINED TO COLLECT CYLINDERS AND PERFORM THE NECESSARY CONCRETE TESTS. A MINIMUM OF FIVE (5) CONCRETE CYLINDERS (OR FIVE (5) CONCRETE CUBES) SHALL BE TAKEN FOR EACH CONCRETE TYPE/STRENGTH SUPPLIED. THE CONCRETE CYLINDERS SHALL BE TAKEN AFTER WATER AND ADMIXTURES (IF ANY) ARE ADDED TO THE MIX. IT IS RECOMMENDED THAT ONE CYLINDER BE TESTED AT 7 DAYS, TWO AT 28 DAYS AND HOLD THE FINAL CYLINDER IN RESERVE. IT IS RECOMMENDED THAT TEST REPORTS BE SENT DIRECTLY TO THE GENERAL CONTRACTOR, OWNER, ARCHITECT AND STRUCTURAL ENGINEER. ANY CYLINDER BREAKS (INCLUDING 1 AND 14 DAY BREAKS) SHALL BE FLAGGED AND BROUGHT TO THE ATTENTION OF THE APPROPRIATE DESIGN PROFESSIONAL.

STRUCTURAL AND MISCELLANEOUS STEEL:

- 1. SHOP DRAWING NOTE: THIS NOTE IS DIRECTED TO THE CONTRACTOR, STEEL SUPPLIERS AND DETAILERS FOR STRUCTURAL AND MISCELLANEOUS STEEL, DECKING, JOISTS AND JOIST GIRDERS. THE DETAILERS/SUPPLIERS SHALL BE PROVIDED A FULL SET OF CONSTRUCTION DOCUMENTS (INCLUDING ADDENDUMS AND SPECIFICATIONS) BY THE CONTRACTOR FOR THEIR USE IN ORDER TO PROPERLY DETAIL THE PROJECT, DECK EDGES, DIMENSIONS, TOP OF STEEL, SLOPES, ARE CONTROLLED BY THE ARCHITECTURAL DRAWINGS. THE CONTRACTOR SHALL ANSWER QUESTIONS, IN THE SHOP DRAWINGS, INDICATED TO THE 'CONTRACTOR' AND/OR 'APPROVER' OR SIMILAR DESIGNATION. KYZER AND TIMMERMAN WILL RESPOND TO CLOUDED QUESTIONS, IN THE SHOP DRAWINGS PROCESS, DIRECTED TO THE 'ENGINEER OF RECORD' OR SIMILAR DESIGNATION. IT IS RECOMMENDED THAT THE DETAILER USE APPROPRIATE DESIGNATIONS FOR THE ARCHITECT, CIVIL ENGINEER, MECHANICAL ENGINEER, ELECTRICAL ENGINEER, ETC. IT IS IMPORTANT FOR THE CONTRACTOR TO REVIEW THE SHOP DRAWINGS FROM HIS DETAILERS AND TO PROVIDE THE NECESSARY COORDINATION BETWEEN THE STEEL, JOISTS AND DECKING SHOP DRAWINGS PRIOR TO SUBMITTING TO THE DESIGN TEAM. SHOP DRAWINGS SUBMITTED TO THE DESIGN TEAM WITHOUT THE CONTRACTORS REVIEW ARE SUBJECT TO BE RESUBMITTED, REJECTED OR OTHER SIMILAR ACTION MAY BE TAKEN BY THE ARCHITECT AND/OR ENGINEER.
2. ALL STEEL NOTED OTHERWISE, STRUCTURAL STEEL GRADES FOR ALL STEEL SHALL BE AS INDICATED BELOW:
A. ANCHOR BOLTS A507
B. CONNECTION BOLTS OR A440
C. PLATES AND FLAT BARS A36
D. STEEL PIPE A53, TYPE E OR S, GRADE B, P1-35ksi
E. STRUCTURAL TUBES A500, GRADE B, P1-46 ksi
F. WIDE FLANGE SHAPES A992, GRADE 50
G. OTHER ROLLED SHAPES..... A36
H. MISCELLANEOUS SHAPES ... A36
3. THE CONTRACTOR SHALL SUBMIT DETAILED STRUCTURAL STEEL SHOP DRAWINGS TO INCLUDE (BUT NOT LIMITED TO) COLUMNS, BEAMS, JOISTS, BRIDGING, DECKING, STEEL STAIR LANDINGS AND ALL CONNECTIONS, AS PART OF THE SHOP DRAWINGS, THE CONTRACTOR SHALL SUPPLY EMBEDDED STEEL PLATE AND BRACKET LOCATION DRAWINGS, IN NO CIRCUMSTANCES SHALL THE STRUCTURAL DRAWINGS BE REPRODUCED FOR SHOP DRAWINGS (SECTION SHEETS, ERECTION PLANS, ETC.). THE CONTRACTOR SHALL SUBMIT AN AMPLIFIED NUMBER OF SETS OF SHOP DRAWINGS TO ALLOW FOR EACH DESIGN PROFESSIONAL TO RETAIN A SET FOR HIS/HER FILES. SHOP DRAWINGS SHALL BE REVIEWED AND APPROVED BY THE CONTRACTOR FOR (BUT NOT LIMITED TO) DIMENSIONS, ELEVATIONS AND ERECTION PROCEDURES PRIOR TO ARCHITECT & STRUCTURAL ENGINEER'S REVIEW. AMPLIFIED TIME, AS REQUIRED AND DETERMINED BY THE STRUCTURAL ENGINEER, SHALL BE ALLOTTED TO PERFORM HIS REVIEW OF SHOP DRAWINGS. THE CONTRACTOR IS ADVISED TO PROVIDE THE REQUIRED SHOP DRAWINGS AS SOON AS REASONABLY POSSIBLE TO ALLOW FOR ADEQUATE TIME FOR FABRICATION, SHIPPING ETC. THE MEMBERS OF THE DESIGN TEAM SHALL RECEIVE A FINAL SET OF SHOP DRAWINGS STAMPED 'FINAL SHOP DRAWINGS - FILE SET' WHICH INCORPORATES ANY COMMENTS MADE DURING THE SHOP DRAWING PROCESS AND SHOULD BE STAMPED BY A REGISTERED ENGINEER REGISTERED IN THE PROJECT STATE. THIS SET OF SHOP DRAWINGS SHALL ALSO CONTAIN THE SAME INFORMATION AS THE 'FIELD SET'. THE CONTRACTOR SHALL NOT CONSIDER THE SHOP DRAWING PROCESS COMPLETE UNTIL THE STRUCTURAL ENGINEER RECEIVES THE SHOP DRAWINGS STAMPED 'FINAL SHOP DRAWINGS - FILE SET'. THE CONTRACTOR SHOULD NOT FABRICATE STEEL UNTIL THE STRUCTURAL ENGINEER RECEIVES THE FINAL DRAWINGS CARRYING THIS NOTATION. THIS SET OF SHOP DRAWINGS IS TO ALLOW THE ENGINEER OF RECORD TO HAVE A FINAL SET FOR HIS USE PRIOR TO ERECTION. DUE TO UNFORESEEN CONDITIONS, THE CONTRACTOR MAY CONSIDER TO PROCEED (AT HIS OWN RISK) TO FABRICATE AND ERECT STEEL PRIOR TO COMPLETED SUBMITTALS.

STATEMENT OF SPECIAL INSPECTIONS (PER CHAPTER 17, 2015 IBC)

Table with 4 main columns: BUILDING SYSTEM OR COMPONENT, MATERIAL SUBMITTAL, TESTING, and INSPECTION (PER IBC). It details requirements for structural steel, high-strength bolting, and structural steel welding, including agency names and inspection frequencies.

DEFINITIONS:
- SPECIAL INSPECTOR: PER IBC "A QUALIFIED PERSON EMPLOYED OR RETAINED BY AN APPROVED AGENCY AND APPROVED BY THE BUILDING OFFICIAL AS HAVING THE COMPETENCE NECESSARY TO INSPECT A PARTICULAR TYPE OF CONSTRUCTION REQUIRING SPECIAL INSPECTION".
- PERIODIC SPECIAL INSPECTION: PER IBC "SPECIAL INSPECTION BY THE SPECIAL INSPECTOR WHO IS INTERMITTENTLY PRESENT WHERE THE WORK TO BE INSPECTED HAS BEEN OR IS BEING PERFORMED".
- CONTINUOUS SPECIAL INSPECTION: PER IBC "SPECIAL INSPECTION BY THE SPECIAL INSPECTOR WHO IS PRESENT WHEN AND WHERE THE WORK TO BE INSPECTED IS BEING PERFORMED". THIS IS INTENDED TO BE A CONTINUOUS INSPECTION.

METAL DECKING:



- 1. SHOP DRAWING NOTE: THIS NOTE IS DIRECTED TO THE CONTRACTOR, STEEL SUPPLIERS AND DETAILERS FOR STRUCTURAL AND MISCELLANEOUS STEEL, DECKING, JOISTS AND JOIST GIRDERS. THE DETAILERS/SUPPLIERS SHALL BE PROVIDED A FULL SET OF CONSTRUCTION DOCUMENTS (INCLUDING ADDENDUMS AND SPECIFICATIONS) BY THE CONTRACTOR FOR THEIR USE IN ORDER TO PROPERLY DETAIL THE PROJECT, DECK EDGES, DIMENSIONS, TOP OF STEEL, SLOPES, ARE CONTROLLED BY THE ARCHITECTURAL DRAWINGS. THE CONTRACTOR SHALL ANSWER QUESTIONS, IN THE SHOP DRAWINGS, INDICATED TO THE 'CONTRACTOR' AND/OR 'APPROVER' OR SIMILAR DESIGNATION. KYZER AND TIMMERMAN WILL RESPOND TO CLOUDED QUESTIONS, IN THE SHOP DRAWINGS PROCESS, DIRECTED TO THE 'ENGINEER OF RECORD' OR SIMILAR DESIGNATION. IT IS IMPORTANT FOR THE CONTRACTOR TO REVIEW THE SHOP DRAWINGS FROM HIS DETAILERS AND TO PROVIDE THE NECESSARY COORDINATION BETWEEN THE STEEL, JOISTS AND DECKING SHOP DRAWINGS PRIOR TO SUBMITTING TO THE DESIGN TEAM. SHOP DRAWINGS SUBMITTED TO THE DESIGN TEAM WITHOUT THE CONTRACTORS REVIEW ARE SUBJECT TO BE RESUBMITTED, REJECTED OR OTHER SIMILAR ACTION MAY BE TAKEN BY THE ARCHITECT AND/OR ENGINEER.
2. THE CONTRACTOR SHALL SUBMIT DETAILED SHOP DRAWINGS SHOWING BEAMS, JOISTS, BRIDGING, DECKING (INCLUDING TEMPORARY SHORING) AND ALL CONNECTIONS, THESE SHOP DRAWINGS SHALL BE SIGNED AND SEALED BY A REGISTERED ENGINEER IN THE PROJECT STATE. AS PART OF SHOP DRAWINGS, STEEL FABRICATOR SHALL SUPPLY EMBEDDED STEEL PLATE AND BRACKET LOCATION DRAWINGS. THE STRUCTURAL DRAWINGS ARE NOT TO BE REPRODUCED FOR SHOP DRAWINGS, SECTION SHEETS OR ERECTION PLANS. THE CONTRACTOR SHALL SUBMIT AN AMPLIFIED NUMBER OF SETS OF SHOP DRAWINGS TO ALLOW FOR EACH DESIGN PROFESSIONAL TO RETAIN A SET FOR THE FILE. SHOP DRAWINGS SHALL BE REVIEWED AND APPROVED BY THE CONTRACTOR FOR (BUT NOT LIMITED TO) DIMENSIONS, ELEVATIONS AND ERECTION PROCEDURES PRIOR TO ARCHITECT & STRUCTURAL ENGINEER'S REVIEW. AMPLIFIED TIME, AS DETERMINED BY THE STRUCTURAL ENGINEER, SHALL BE ALLOTTED FOR HIS REVIEW OF SHOP DRAWINGS. THE CONTRACTOR MAY ISSUE SHOP DRAWINGS EARLY TO ALLOW FOR ADDITIONAL FABRICATION TIME. THE MEMBERS OF THE DESIGN TEAM SHALL RECEIVE A FINAL SET OF SHOP DRAWINGS STAMPED 'FINAL SHOP DRAWINGS - FILE SET' WHICH INCORPORATES ANY COMMENTS MADE DURING THE SHOP DRAWING PROCESS AND SHOULD BE STAMPED BY A REGISTERED ENGINEER REGISTERED IN THE PROJECT STATE.
3. DECKING CONTRACTOR TO COORDINATE OPENING SIZES AND LOCATIONS FROM ARCHITECTURAL AND MECHANICAL DRAWINGS. METAL DECK SHALL CONFORM TO THE APPROPRIATE ASTM STANDARD A446 AND A525.
4. DO NOT HANG OR ATTACH MECHANICAL SYSTEMS, DUCTS, CONDUIT, PIPING, EQUIPMENT, CEILING, ETC. FROM METAL ROOF DECKING.
5. THE CONTRACTOR SHALL SUPPORT THE EDGE OF ALL ROOF AND FLOOR DECK WITH A STEEL ANGLE AND APPROPRIATE FASTENERS. A 5 X 3 X 1/4" ANGLE (LONG LEG VERTICAL) WITH 3/4" (4" EMBEDMENT) EXPANSION BOLTS AT 2'-0" ON CENTER SHALL BE USED AT ALL MASONRY AND CONCRETE WALLS (UNLESS OTHERWISE INDICATED IN THE CONSTRUCTION DOCUMENTS). A 5 X 5 X 5/16" ANGLE SHALL BE USED AT LOCATIONS IN WHICH THE DECK SUPPORT MUST SPAN BETWEEN STEEL JOISTS AND/OR BEAMS. IN THE EVENT THAT THE STEEL DECK CHANGES DIRECTION, STEEL TUBES MAY BE REQUIRED TO ACT AS SHIMS TO PROVIDE CONTINUOUS SUPPORT FOR THE DECK. THESE TUBES MAY OR MAY NOT BE INDICATED IN THE DETAILS FOR CLARITY.

COLD-FORMED STEEL FRAMING/ METAL STUDS:

- 1. THE METAL STUD FRAMING IS CONSIDERED AN ENGINEERED SYSTEM DESIGNED BY THE METAL STUD FRAMING DESIGN ENGINEER EMPLOYED BY THE CONTRACTOR OR HIS SUBCONTRACTOR. THE METAL STUDS AND RECOMMENDATIONS INDICATED IN THESE DRAWINGS ARE TO BE CONSIDERED AS THE MINIMUM ALLOWED BY THE ENGINEER OF RECORD FOR THE PROJECT. DUE TO VARYING MANUFACTURERS AND SUBCONTRACTOR PREFERENCE THE CONTRACTOR SHALL SUBMIT AN ENGINEERED DESIGN FOR THE METAL STUD SYSTEM TO BE USED FOR THIS PROJECT. THE STRUCTURAL DESIGN SHALL INCLUDE COMPLETED DETAILS AND DESIGN REGARDING THE STUDS, CLIPS, TRACKS, BRACING, ANCHORS, LINTELS, SCREENS AND SO ON. SHORING REQUIREMENTS RELATED TO THE METAL STUD FRAMING FOR ALL PHASES OF THE WORK SHALL BE INCLUDED AS PART OF THE METAL STUD DESIGN. THE FINAL DESIGN SHALL BE STAMPED BY A REGISTERED ENGINEER REGISTERED IN THE PROJECT STATE.
2. THE CONTRACTOR SHALL SUBMIT DETAILED SHOP DRAWINGS SHOWING BEAMS, JOISTS, BRIDGING, DECKING AND ALL CONNECTIONS INCLUDING SPLICES. THESE SHOP DRAWINGS SHALL BE SIGNED AND SEALED BY A REGISTERED ENGINEER IN THE PROJECT STATE TO CERTIFY COMPLIANCE WITH THE CODE REQUIRED LOADS OR AS SPECIFIED IN THE DRAWINGS (WHICH EVER IS HIGHER). THE SPECIFIC DESIGN OF THE BAR JOISTS AND GIRDERS SHALL TAKE INTO CONSIDERATION ALL ASPECTS OF DESIGN INCLUDING VIBRATION. AS PART OF SHOP DRAWINGS, STEEL FABRICATOR SHALL SUPPLY EMBEDDED STEEL PLATE AND BRACKET LOCATION DRAWINGS. THE STRUCTURAL DRAWINGS ARE NOT TO BE REPRODUCED FOR SHOP DRAWINGS, SECTION SHEETS OR ERECTION PLANS. THE STRUCTURAL DRAWINGS ARE NOT TO BE REPRODUCED FOR SHOP DRAWINGS, SECTION SHEETS OR ERECTION PLANS. SUBMIT AN AMPLIFIED NUMBER OF SETS OF SHOP DRAWINGS TO ALLOW FOR EACH DESIGN PROFESSIONAL TO RETAIN A SET FOR THE FILE. SHOP DRAWINGS SHALL BE REVIEWED AND APPROVED BY THE CONTRACTOR FOR (BUT NOT LIMITED TO) DIMENSIONS, ELEVATIONS AND ERECTION PROCEDURES PRIOR TO ARCHITECT & STRUCTURAL ENGINEER'S REVIEW. AMPLIFIED TIME, AS DETERMINED BY THE STRUCTURAL ENGINEER, SHALL BE ALLOTTED FOR HIS REVIEW OF SHOP DRAWINGS. THE CONTRACTOR MAY ISSUE SHOP DRAWINGS EARLY TO ALLOW FOR ADDITIONAL FABRICATION TIME. THE MEMBERS OF THE DESIGN TEAM SHALL RECEIVE A FINAL SET OF SHOP DRAWINGS STAMPED 'FINAL SHOP DRAWINGS - FILE SET' WHICH INCORPORATES ANY COMMENTS MADE DURING THE SHOP DRAWING PROCESS AND SHOULD BE STAMPED BY A REGISTERED ENGINEER REGISTERED IN THE PROJECT STATE.
3. JOISTS AND JOIST GIRDERS TO BE MANUFACTURED AND INSTALLED ACCORDING TO THE STANDARDS AND SPECIFICATIONS SET FORTH BY THE STEEL JOIST INSTITUTE. JOIST DESIGNER/SUPPLIER SHALL DETERMINE AND/OR VERIFY THE LOCATIONS AND HEIGHTS OF ALL MECHANICAL EQUIPMENT PRIOR TO SHOP DRAWING SUBMITTAL AND JOIST FABRICATION. IN MANY CASES THE CONTRACTOR, ARCHITECT AND/OR OWNER MAY SUBSTITUTE A MECHANICAL SYSTEM IN THE BID PROCESS-THEREBY CHANGING THE LOCATIONS AND HEIGHTS OF THE MECHANICAL UNITS. THE CONTRACTOR SHALL OBTAIN AND KEEP ON FILE THE JOIST CALCULATIONS RELATING TO THE DESIGN OF STEEL JOIST AND GIRDERS INCLUDING 'SPECIAL JOISTS'. IN SOME INSTANCES MULTIPLE JOISTS MAY BE SHOWN ON THE STRUCTURAL DRAWINGS AT MECHANICAL UNIT LOCATIONS, TO SUPPORT MECHANICAL UNITS AND OTHER ROOF LOADS THE JOIST DESIGNER/SUPPLIER MAY USE MULTIPLE JOISTS OR SPECIAL JOISTS TO CARRY THE LOADS.
4. ALL STEEL DETAILS AND CONNECTIONS SHALL BE IN ACCORDANCE WITH THE REQUIREMENTS OF THE LATEST EDITION OF A.I.S.C. SPECIFICATIONS.
5. DECKING CONTRACTOR TO COORDINATE OPENING SIZES AND LOCATIONS FROM ARCHITECTURAL AND MECHANICAL DRAWINGS. METAL DECK SHALL CONFORM TO THE APPROPRIATE ASTM STANDARD.
6. ALL STEEL JOISTS SUPPORTING ROOF DECK SHALL BE DESIGNED TO RESIST UPLIFT LOADS, DUE TO WIND, PER THE LATEST EDITION OF THE APPLICABLE BUILDING CODE. UPLIFT BRIDGING SHALL BE DESIGNED BY THE BAR JOIST GIRDER ENGINEER AND INDICATED IN THE SHOP DRAWINGS. NO LOADS SHALL BE APPLIED TO THE JOIST UNTIL ALL BRIDGING IS INSTALLED AND JOIST BEARING ENDS HAVE BEEN SECURED. BRIDGING TO BE DESIGNED AND INSTALLED IN ACCORDANCE WITH THE STEEL JOIST INSTITUTE STANDARDS.
7. ALL STEEL JOISTS SHALL BEAR A MINIMUM OF 2-1/2" ON STEEL BEAMS. STEEL JOISTS BEARING ON BOTH SIDES OF STEEL BEAMS WITH FLANGES LESS THAN 5' SHALL BE STAGGERED TO ALLOW THE REQUIRED BEARINGS REGARDLESS OF FRAMING PLANS AND SECTIONS.
8. STEEL JOIST DETAILERS TO VERIFY JOIST AND BEAM BEARING ELEVATIONS WITH THE ARCHITECTURAL DRAWINGS TO ENSURE PROPER ROOF SLOPES FOR DRAINAGE AND CORRECT JOIST ELEVATIONS. SEE ARCHITECTURAL DRAWINGS FOR FLASHING AND ROOF RELATED DETAILS NOT SHOWN ON STRUCTURAL DRAWINGS.

LOAD TABLE

Table with columns for LIVE LOADS, ROOF LOADS, PARTITIONS, DEAD LOADS, SNOW LOADS, WIND LOADS, SEISMIC CLASS, and SEISMIC IMPORTANCE FACTOR. It lists various load values and coefficients according to building codes.

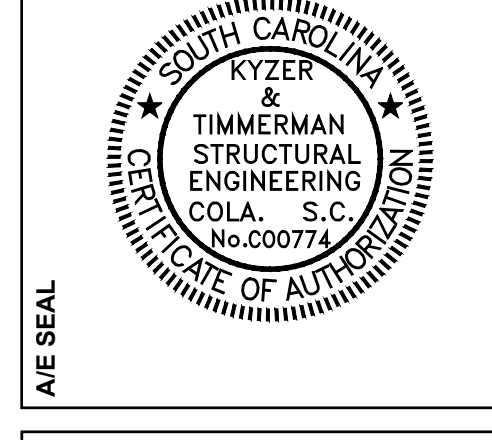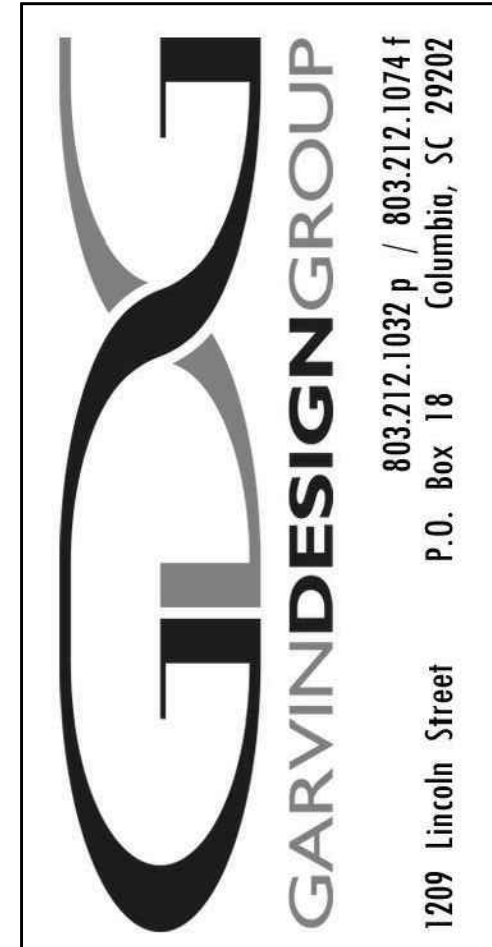


UNIVERSITY OF SOUTH CAROLINA
FOUNDERS PARK PLAYER'S LOUNGE
RENOVATION AND MEDIA ROOM ADDITION
431 WILLIAM STREET
COLUMBIA, SOUTH CAROLINA 29201

Table with columns for PROJECT TITLE, DATE, and REVISIONS. It includes a drawing title 'GENERAL NOTES, SPECIAL INSPECTIONS AND LOAD TABLE' and a drawing number 'S1.0'.

Project information including drawing title 'GENERAL NOTES, SPECIAL INSPECTIONS AND LOAD TABLE', drawing number 'S1.0', and project name 'UNIVERSITY OF SOUTH CAROLINA FOUNDERS PARK PLAYER'S LOUNGE RENOVATION AND MEDIA ROOM ADDITION'.



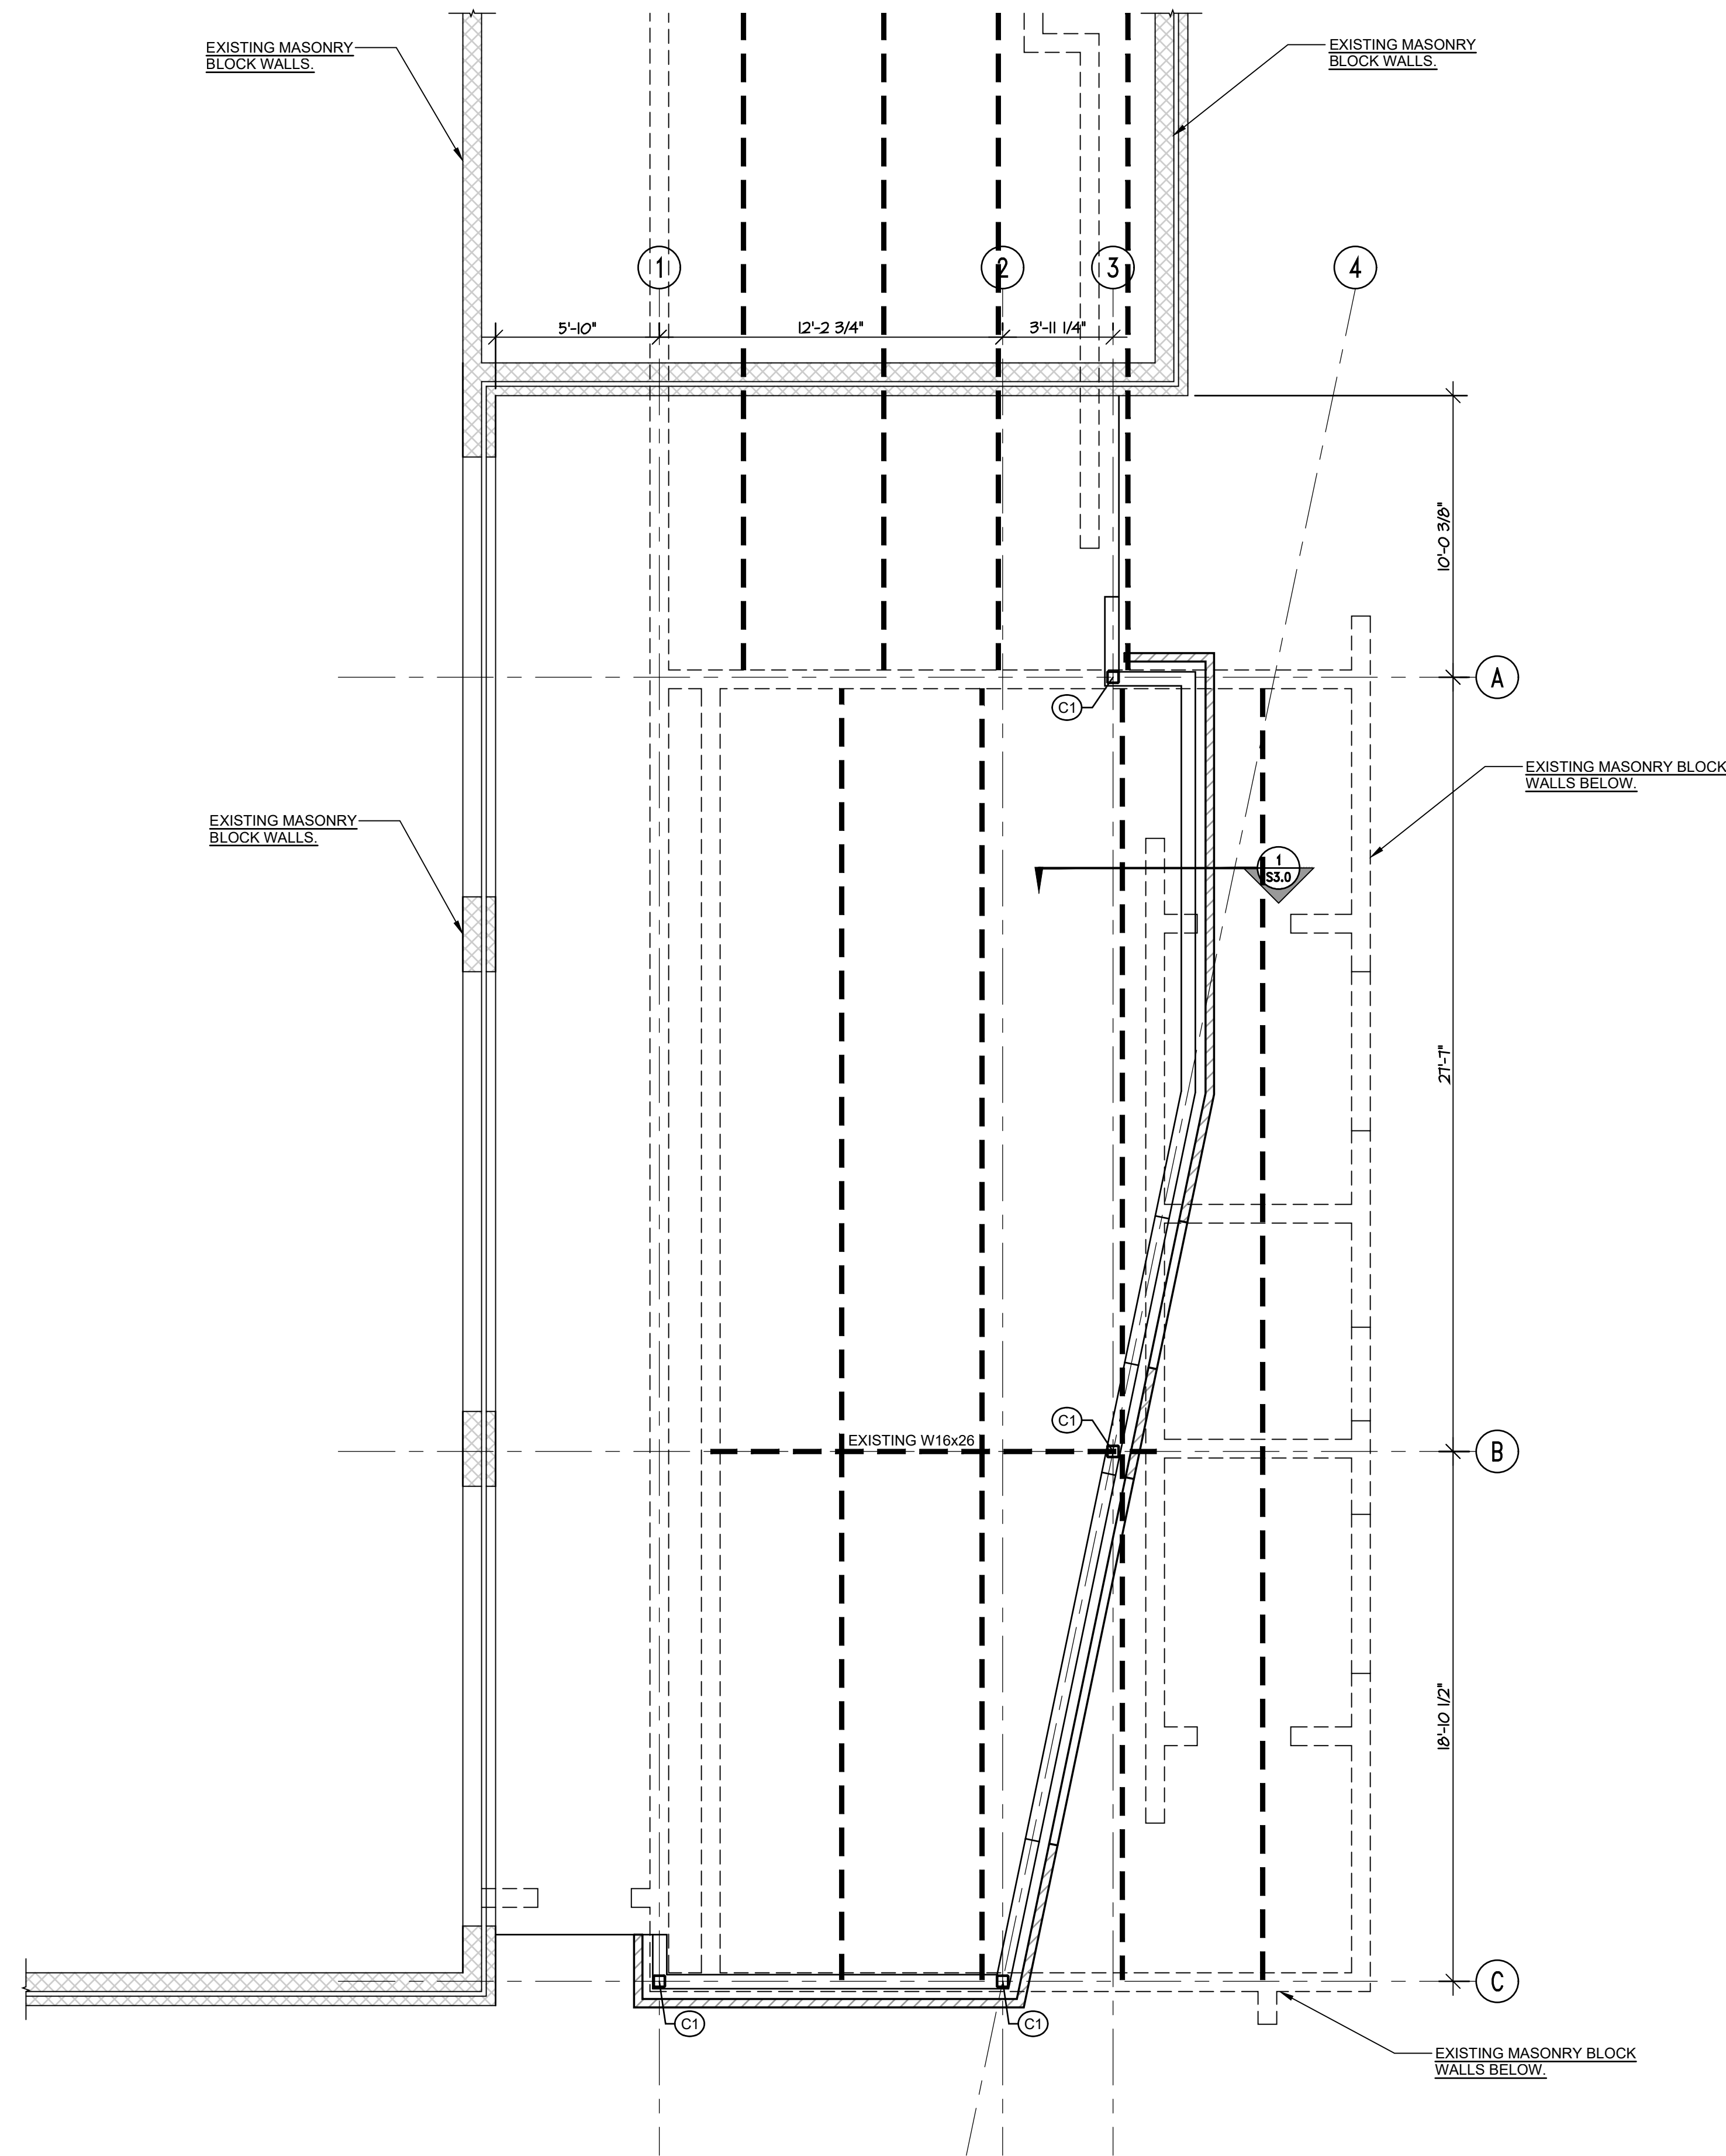


NEW MEDIA ROOM FLOOR FRAMING PLAN
SCALE: 1/4" = 1'-0"

PLAN NOTES:


- (C) HSS5"x5"x1/4" STEEL COLUMN W/ 3/4" THICK x 11" SQUARE BASE PLATE W/ (4) 3/4" DIA. x 4" LONG EMBED EPOXY BOLTS.
- ▽ DENOTES MECHANICAL UNIT. VERIFY WEIGHT & LOCATION W/ MECHANICAL DRAWINGS.
- (BK) L4x4x1/4" WEB CONNECTION ANGLE W/ (2) 3/4" DIA. x 6" LONG EMBED EPOXY BOLTS INTO EXISTING MASONRY WALLS.

SYMBOL LEGEND

- (?) COLUMN CENTER-LINE DESIGNATION - SEE PLAN SHEETS.
- (C?) STEEL &/OR CMU COLUMN DESIGNATION - SEE PLAN SHEET FOR COLUMN SCHEDULE.
- ══ DENOTES NEW EXTERIOR MTL. STUD & BRICK VENER WALL.
- ══ DENOTES EXISTING MASONRY & BRICK VENER WALL.
- (BK?) DENOTES BRACKET - SEE PLAN FOR ADDITIONAL INFO. AND LOCATION.
- ▽ SHEET NOTE NUMBER - SEE NOTE LEGEND ON PLAN SHEETS.

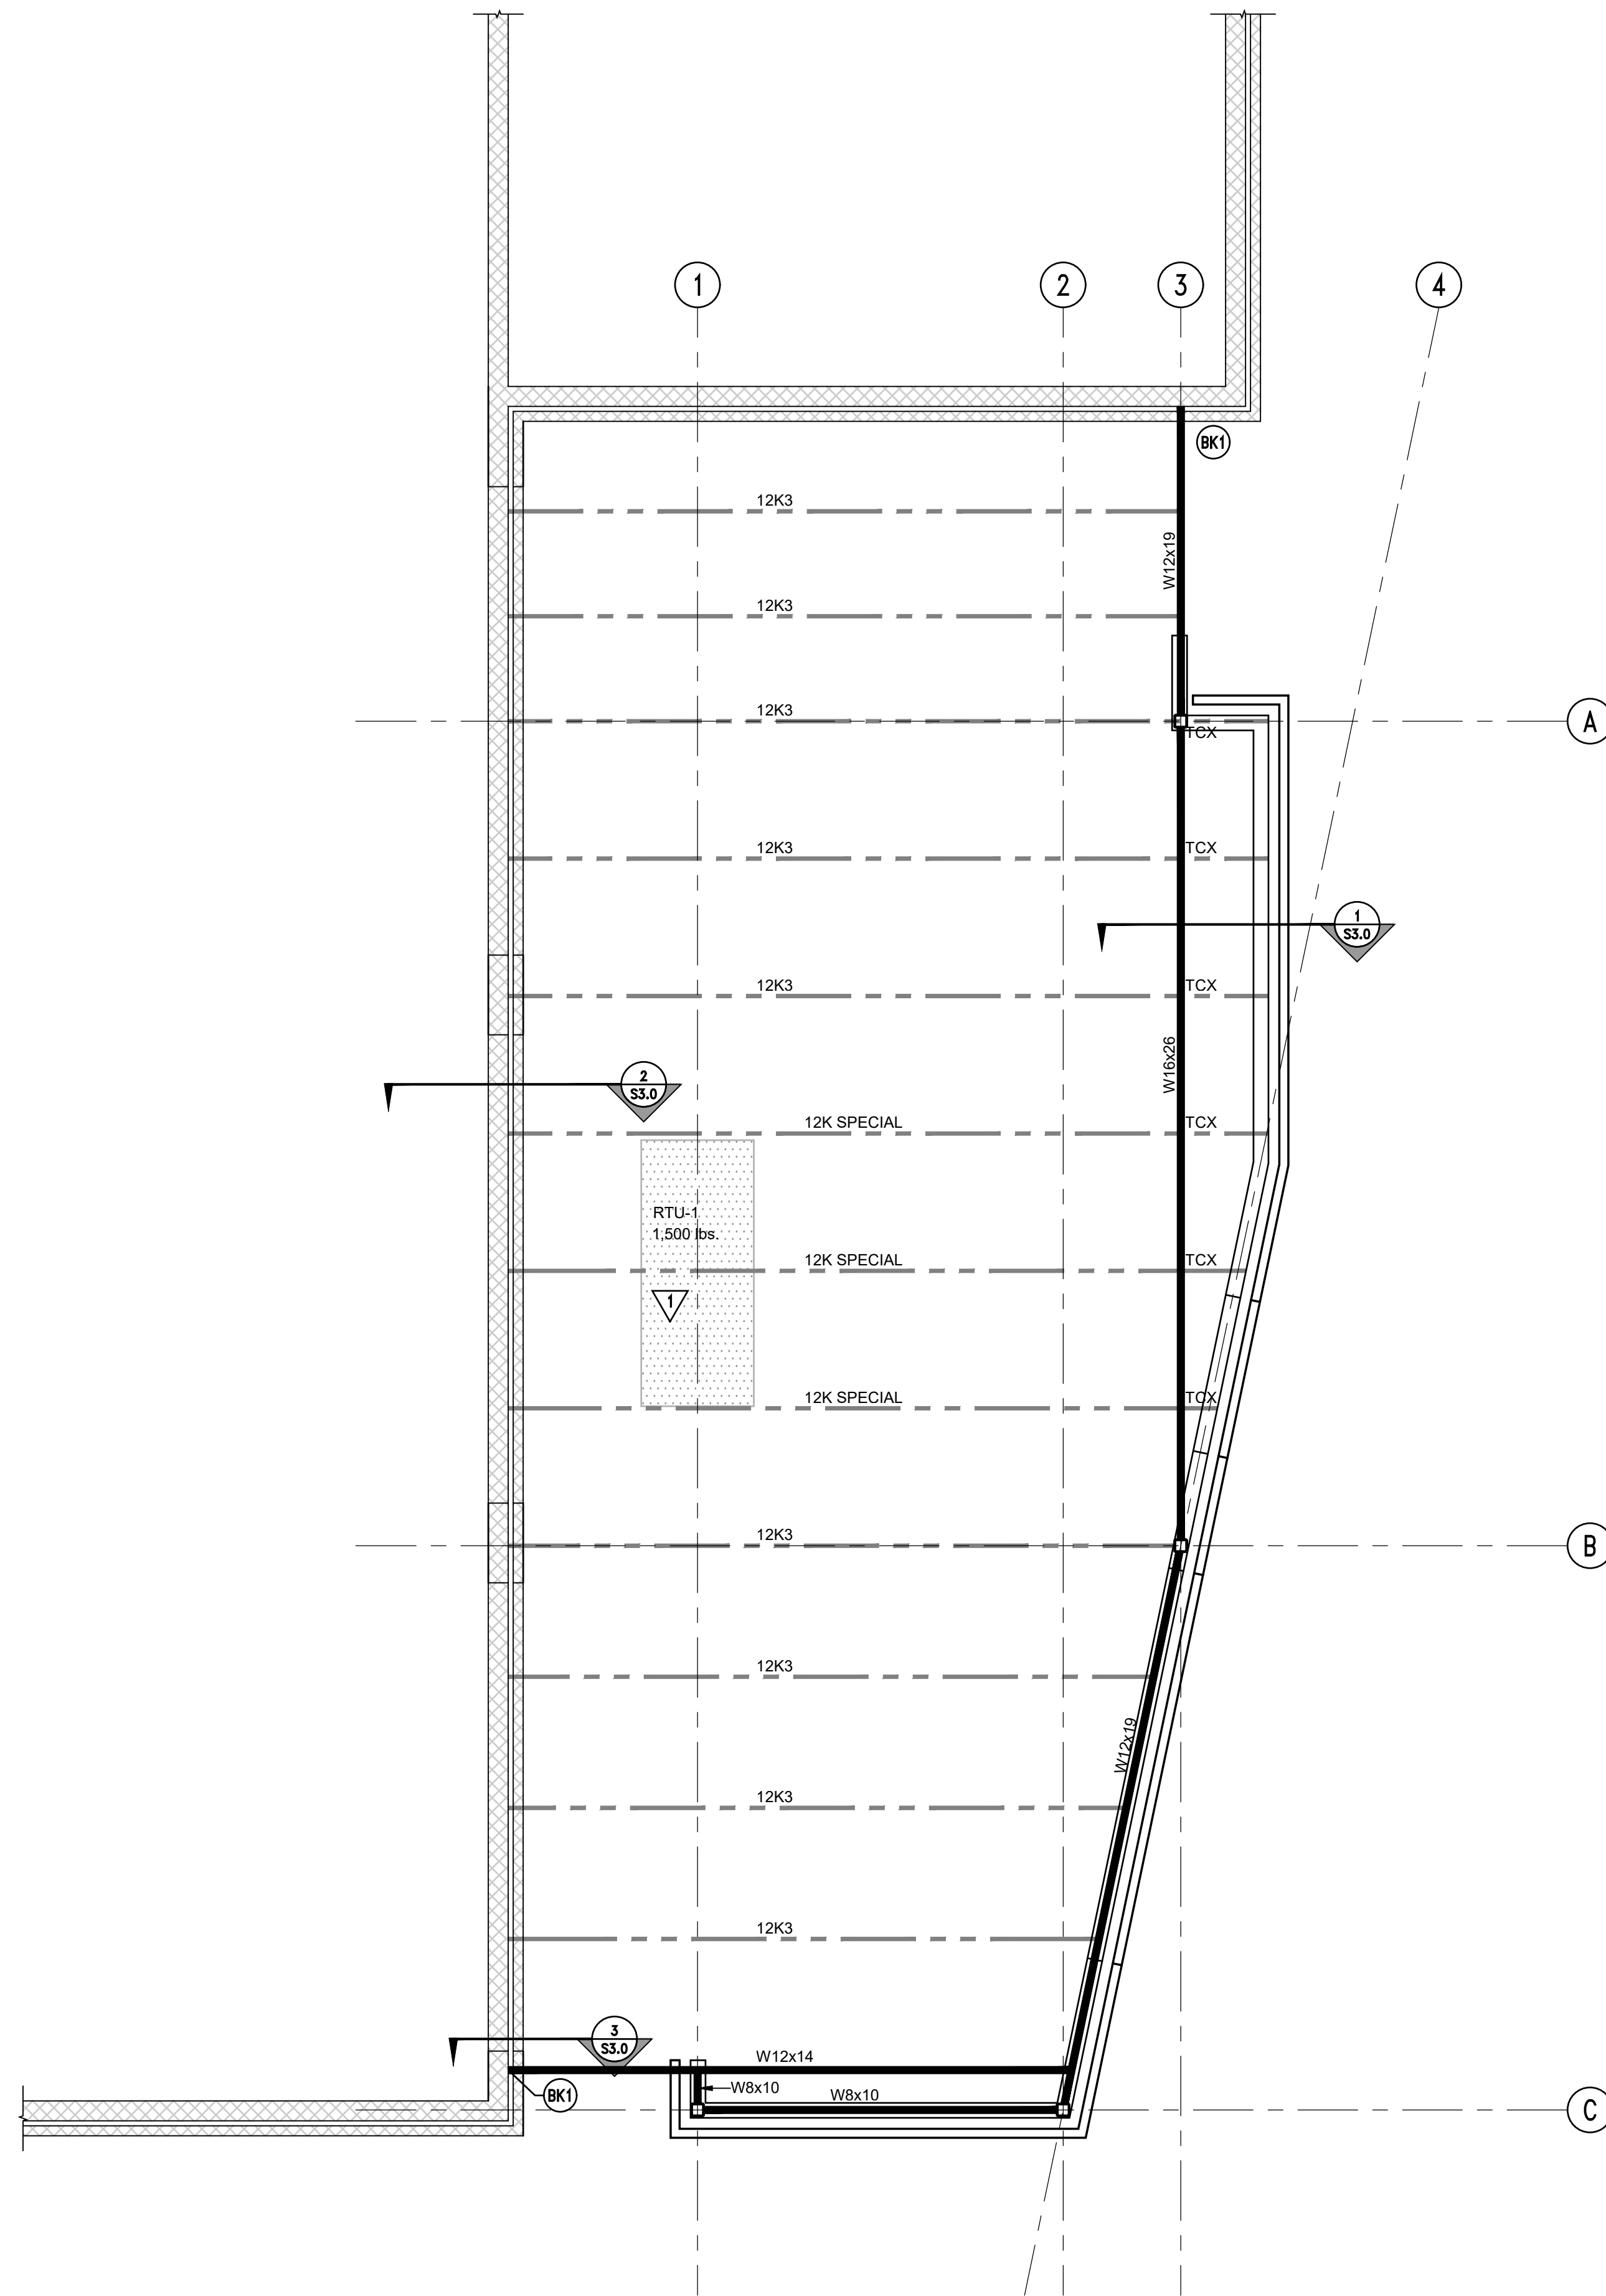

NEW MEDIA ROOM ROOF FRAMING PLAN
SCALE: 1/4" = 1'-0"

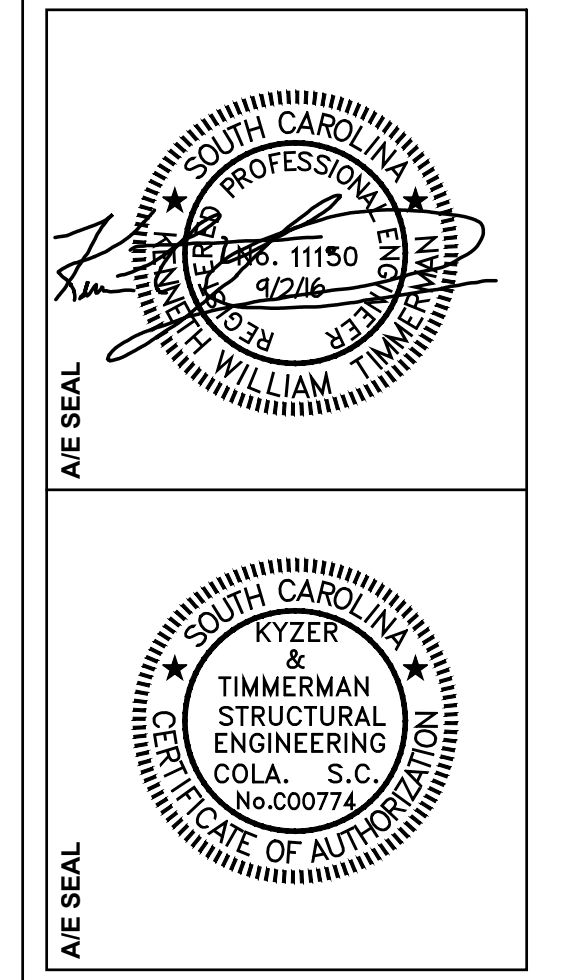


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431 WILLIAMS STREET
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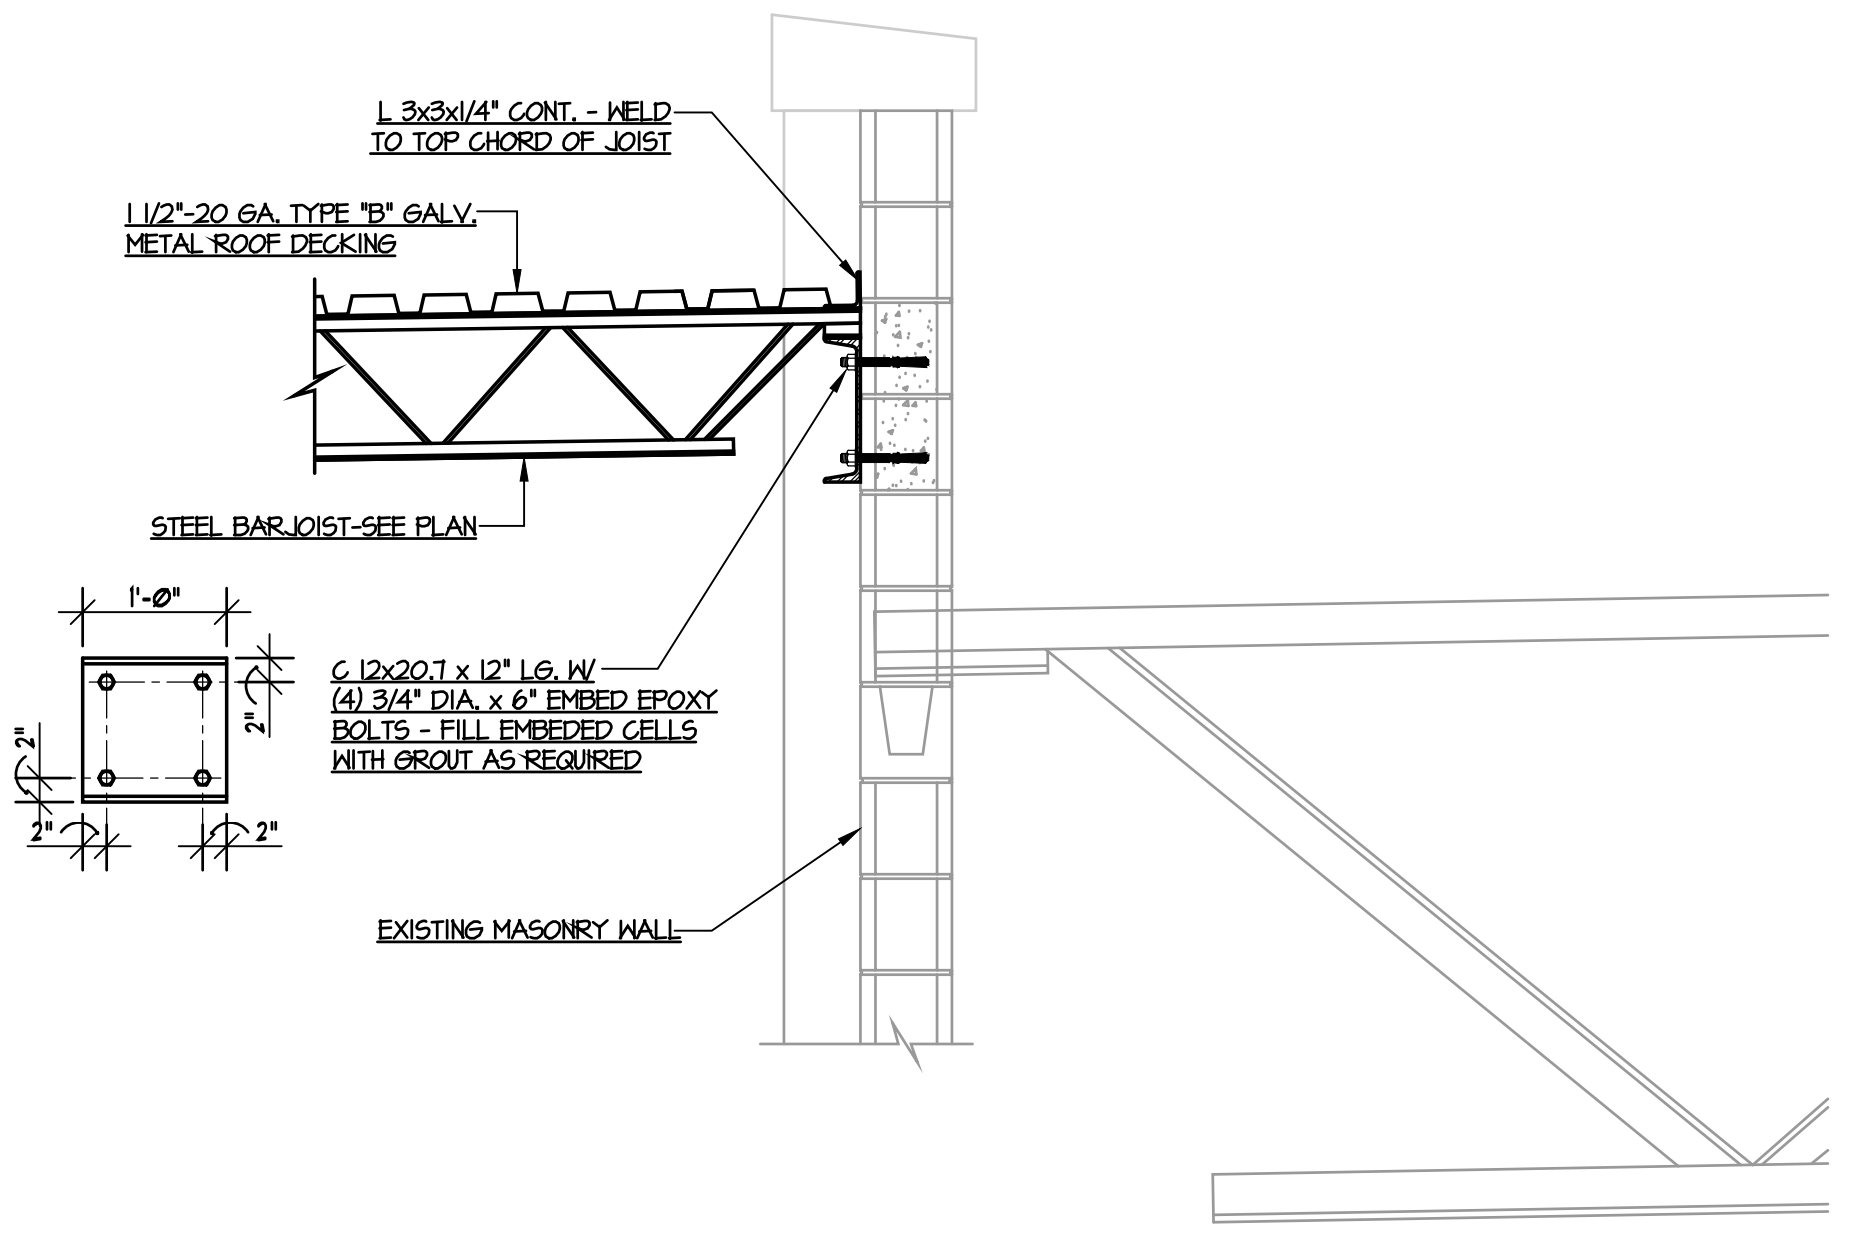
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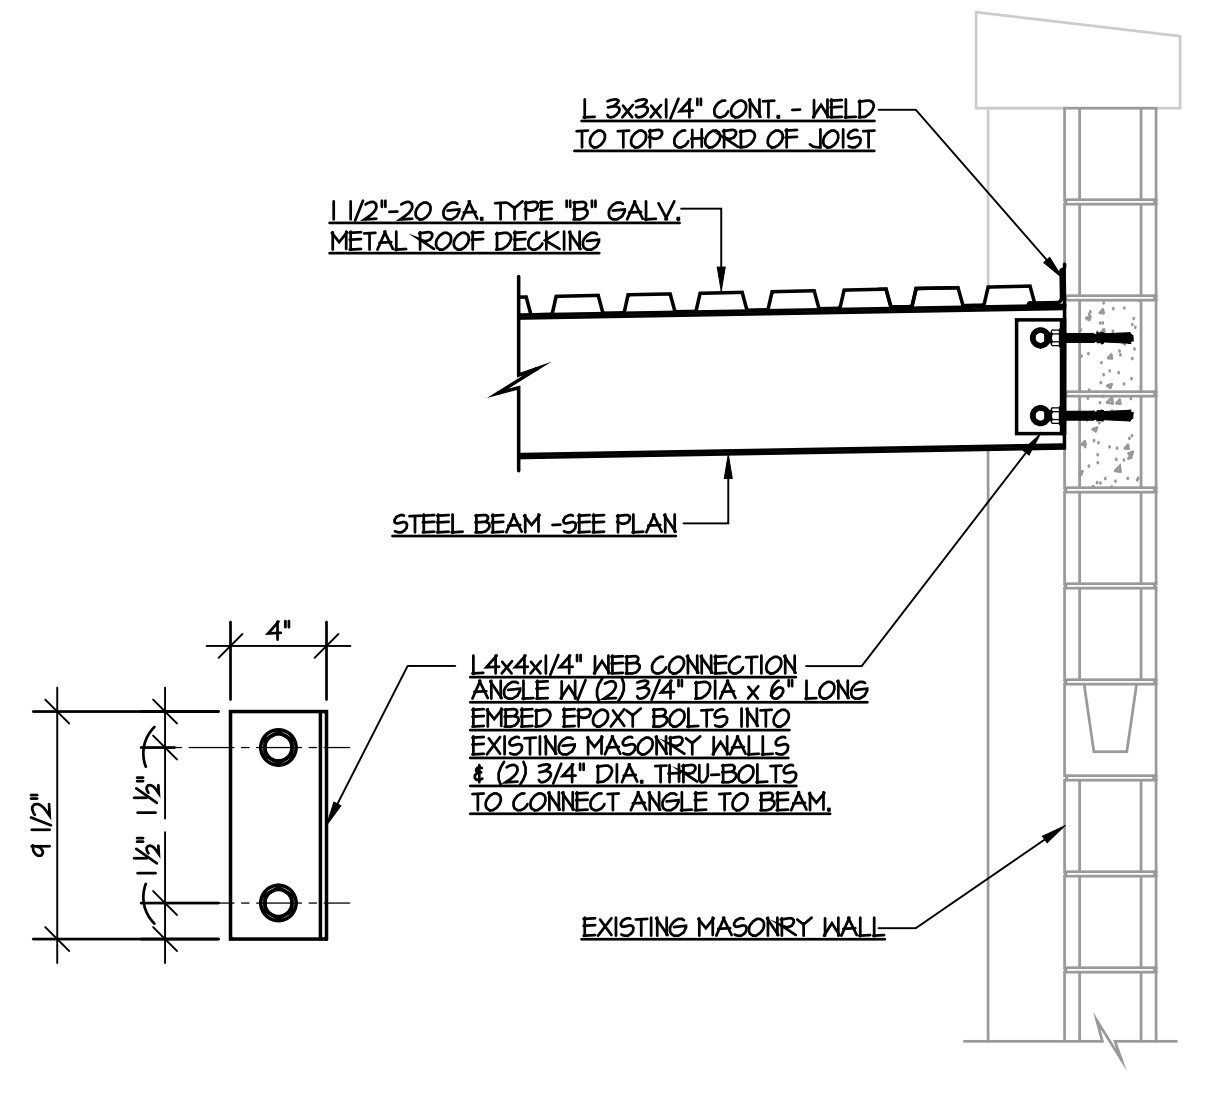
**NEW MEDIA ROOM
FLOOR FRAMING & ROOF
FRAMING PLAN**



SECTION 1
SCALE: 3/4" = 1'-0"

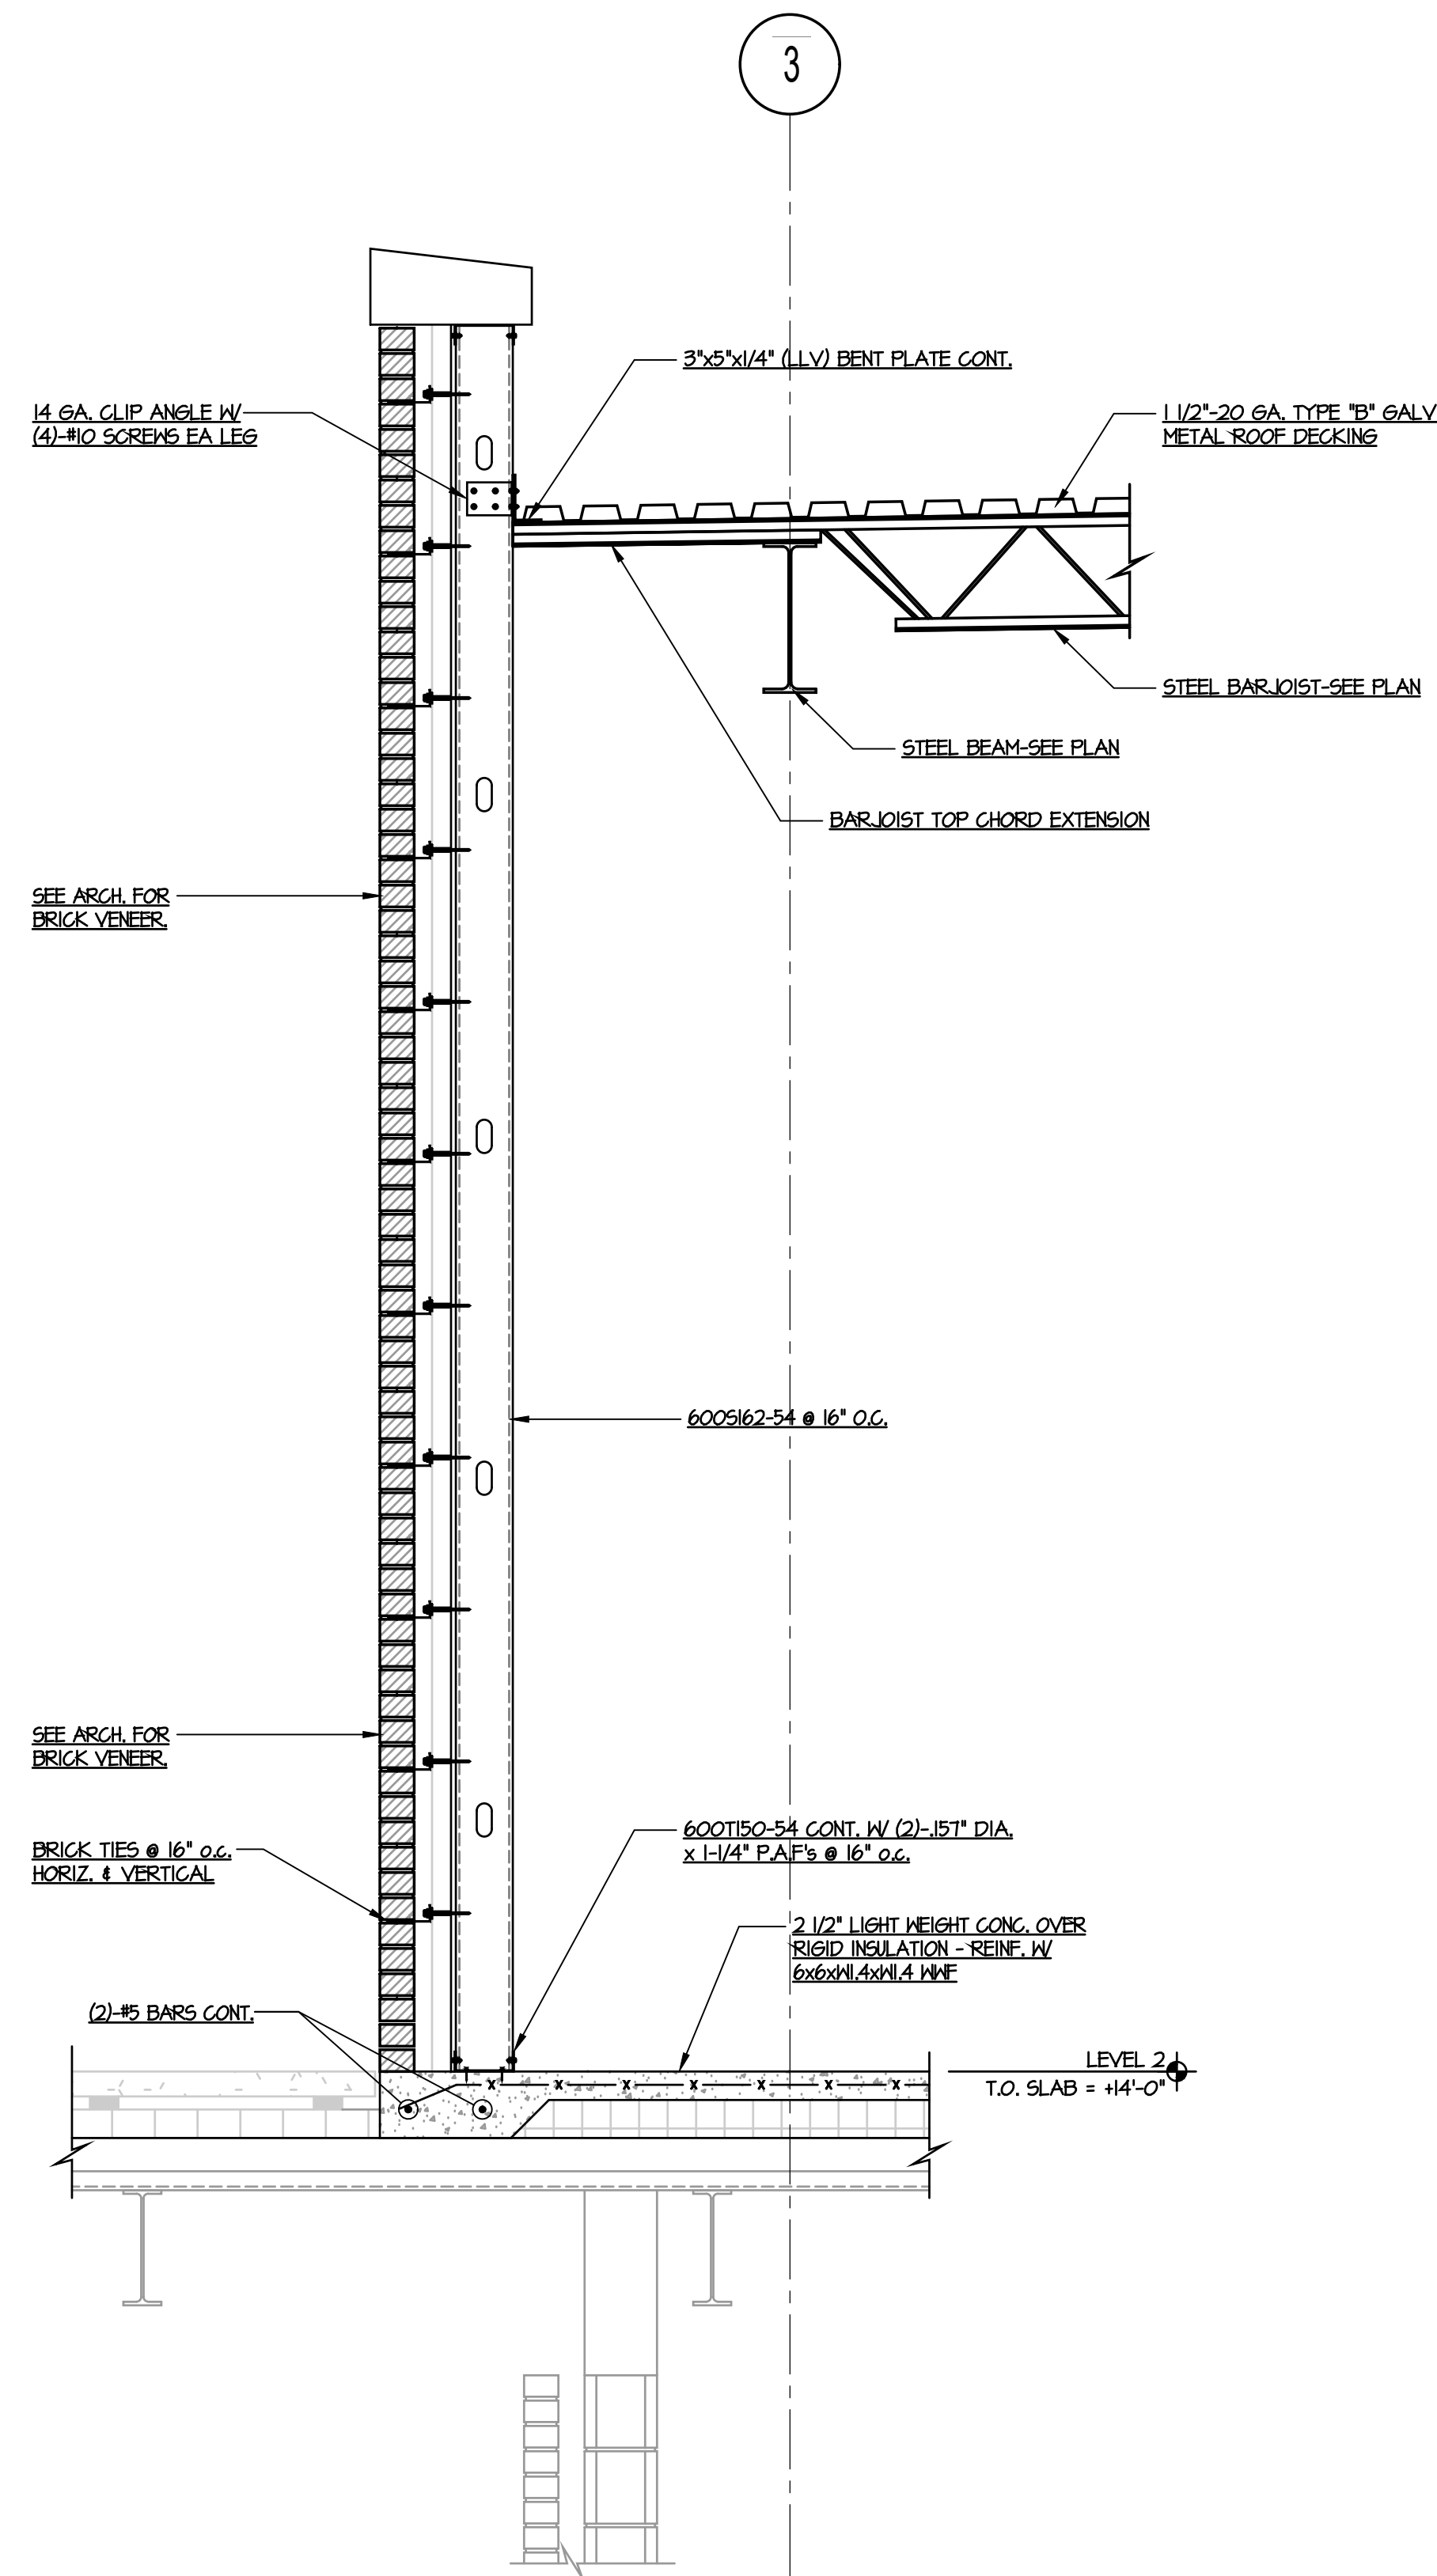


SECTION 2
SCALE: 3/4" = 1'-0"





SECTION 3
SCALE: 3/4" = 1'-0"

- PROCEDURE**
1. REMOVE MORTAR JOINT AT DESIRED ELEVATION TO RECEIVE NEW ANGLE (ONE SIDE ONLY)
 2. INSTALL NEW ANGLE (ONE SIDE OF NEW OPENING) - BEAR ANGLE 8" EACH SIDE OF OPENING
 3. REMOVE MORTAR JOINT ON OPPOSITE SIDE AND INSTALL 2ND ANGLE
 4. SAW CUT MASONRY WALL BELOW ANGLES & REMOVE FOR OPENING.
 5. WELD CLOSURE PLATE TO BOTTOM OF ANGLES.
 6. CONTRACTOR TO REPAIR ANY HAIRLINE CRACKS THAT MAY OCCUR.

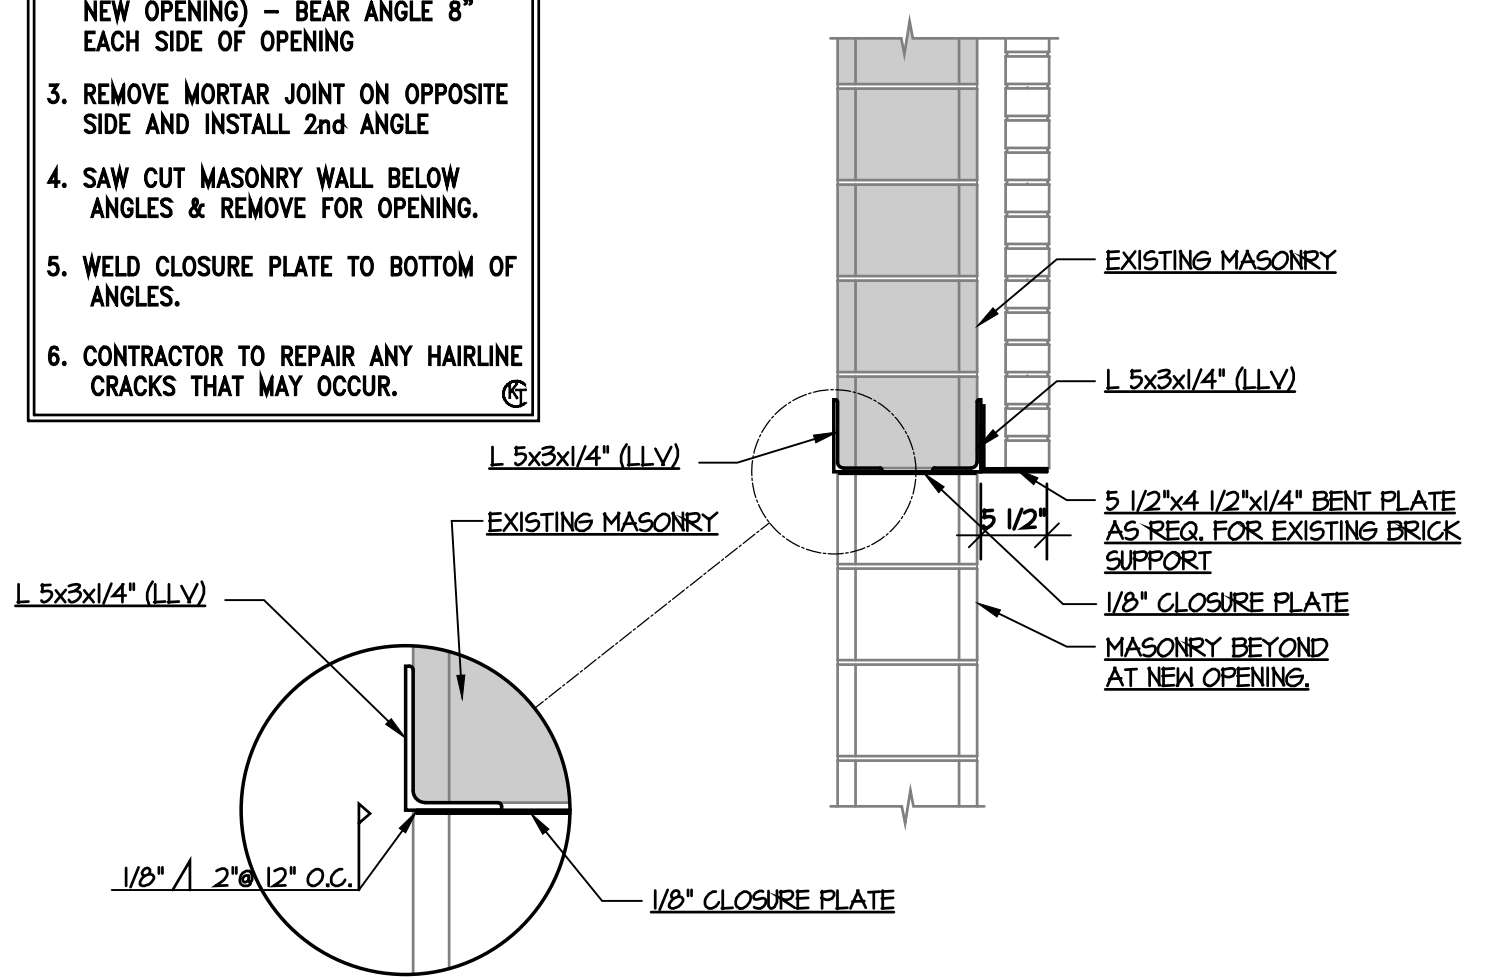


NEW OPENING DETAILS IN EXISTING WALL (PLAYERS LOUNGE)
SEE ARCH DRAWINGS FOR LOCATIONS

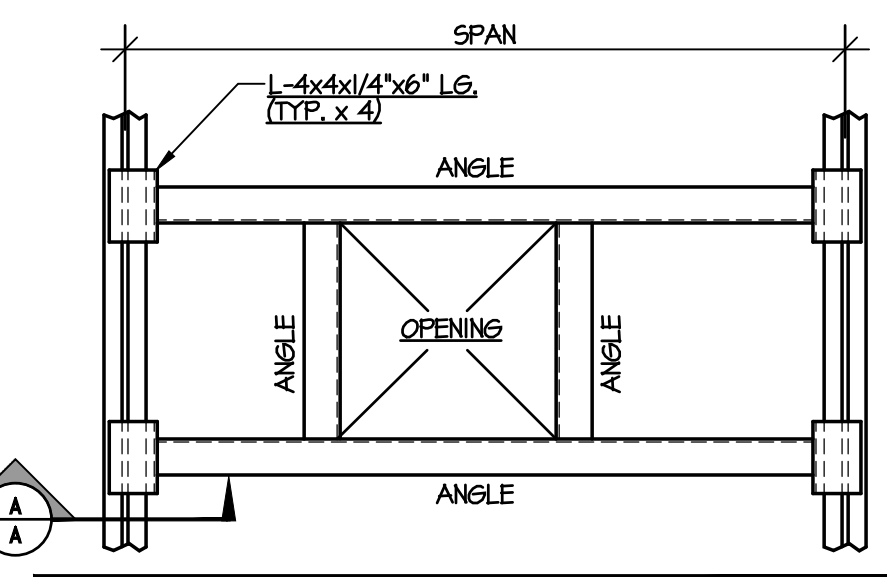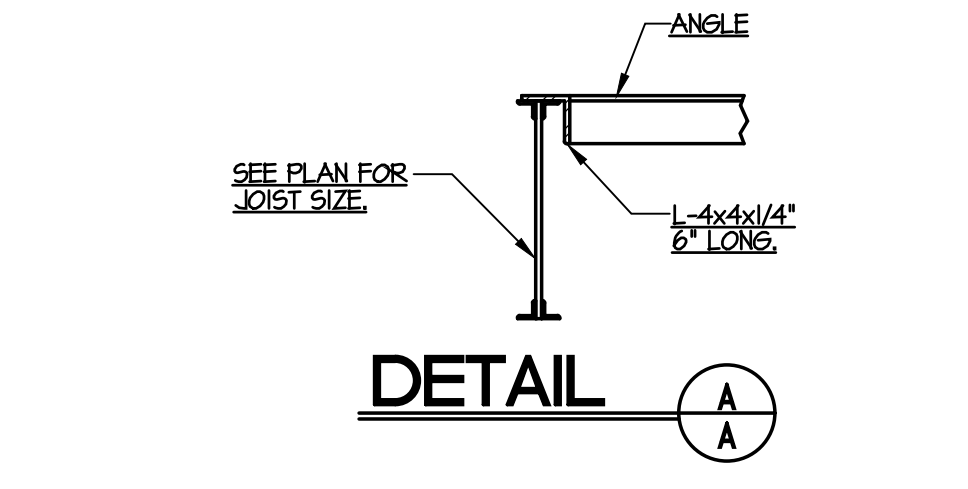

ANGLE SIZE	ALLOWABLE EQUIPMENT LOAD (TOTAL LOAD ON FRAME)	
	SPAN = 4'-0"	SPAN = 5'-0"
L 2"x2"x1/4"	80 lbs	60 lbs
L 3"x3"x1/4"	120 lbs	100 lbs
L 4"x4"x1/4"	160 lbs	133 lbs
L 4"x4"x5/16"	260 lbs	200 lbs
L 4"x4"x3/8"	400 lbs	300 lbs

TYP. ROOF PENETRATION FRAMING

NOTE: CONTRACTOR SHALL INSTALL A 1/4" THICK PLATE FOR FULL WIDTH OF THE SUPPORTING BARJOIST(S) AND BEAM(S) AS NEEDED TO PROVIDE CONTINUOUS BEARING FOR SUPPORT CURBS. FRAMING NOT REQUIRED FOR PENETRATIONS 12"x12" OR 12" DIAMETER AND SMALLER.

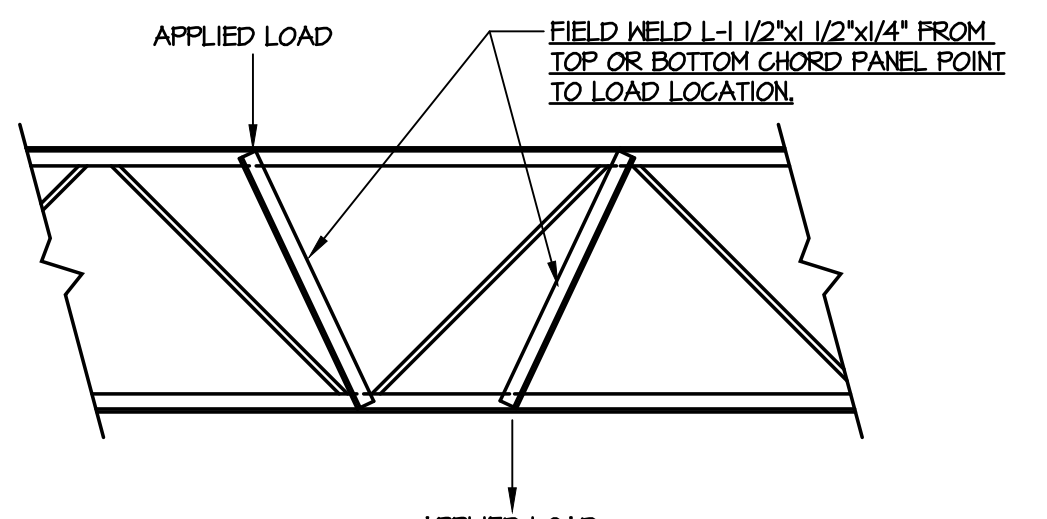

NOTE: TYPICAL FOR ALL JOIST SUPPORTING ANY LOAD FROM TOP OR BOTTOM CHORD BETWEEN PANEL POINTS. VERIFY LOCATION AND LOADS W/ MECHANICAL, ARCHITECTURAL, AND ELECTRICAL DRAWINGS.

TYPICAL JOIST MODIFICATION AT CONCENTRATED LOAD DETAIL

1 1/2"-20 GA. ROOF DECK

TYPE	GAUGE	FINISH
S	20	GALVANIZED (G60)
Sp	S _n	l _p In F _y min.
0.227 in ²	0.238 in ²	0.205 in ⁴ 0.213 in ⁴ 33 ksi

SUPPORT ATTACHMENT

ATTACH DECK TO ALL SUPPORTS WITH HILTI X-EP-19 L15 PINS OR APPROVED EQUAL USING PATTERNS / SPACING INDICATED:

INTERMEDIATE: 36/5
ENDS / END LAPS: 36/5
PERIMETER: 12" o.c.



ATTACH PARTIAL SHEETS IN ALL FLUTES

SIDE LAP ATTACHMENT

SIDE LAPS TO BE ATTACHED BETWEEN SUPPORTS WITH (5) #10 SELF DRILLING SCREWS PER SPAN

CONTRACTOR'S NOTE:
IN ORDER TO PREVENT FIELD FIT-UP AND PLACEMENT ISSUES THE STRUCTURAL STEEL SHOP DRAWINGS SHALL BE CAREFULLY COORDINATED WITH ANY OTHER COMPONENT DRAWINGS, INCLUDING BARJOIST AND DECKING SHOP DRAWINGS. THIS DETAILED COORDINATION IS TO BE PERFORMED BY THE STRUCTURAL STEEL SHOP DRAWING PROVIDER. THE PROVIDERS OF BARJOIST AND DECKING SHOP DRAWINGS (AND OTHER COMPONENTS) SHALL BACK CHECK THE STRUCTURAL STEEL SHOP DRAWINGS AS A SECONDARY VERIFICATION. THE GENERAL CONTRACTOR SHALL PROVIDE HIS OWN CHECK PRIOR TO COMPLETION OF THE SHOP DRAWING PROCESS.

END LAP DETAIL
LAP END LAPS. END LAPS ARE TO OCCUR AT SUPPORTS ONLY.

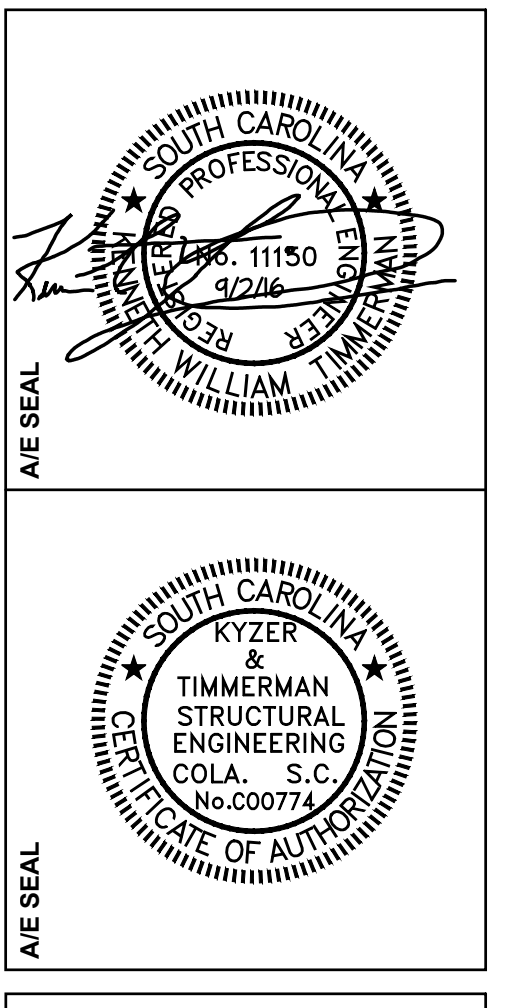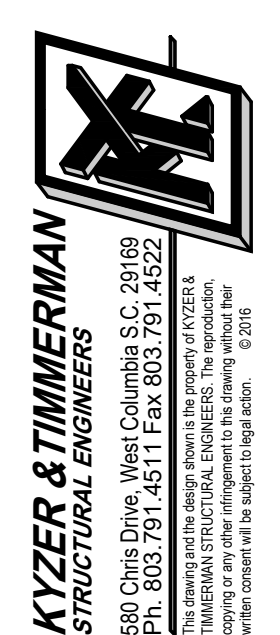


UNIVERSITY OF SOUTH CAROLINA
FOUNDERS PARK PLAYER'S LOUNGE
RENOVATION AND MEDIA ROOM ADDITION
431 WILLIAMS STREET
COLUMBIA, SOUTH CAROLINA 29201

NO.	DATE	REVISIONS

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CHECKED BY: _____


SECTIONS AND DETAILS

C:\Revit Local Files\16-00 Baseball Lounge-Media Room Mechanical v17.ed.rvt

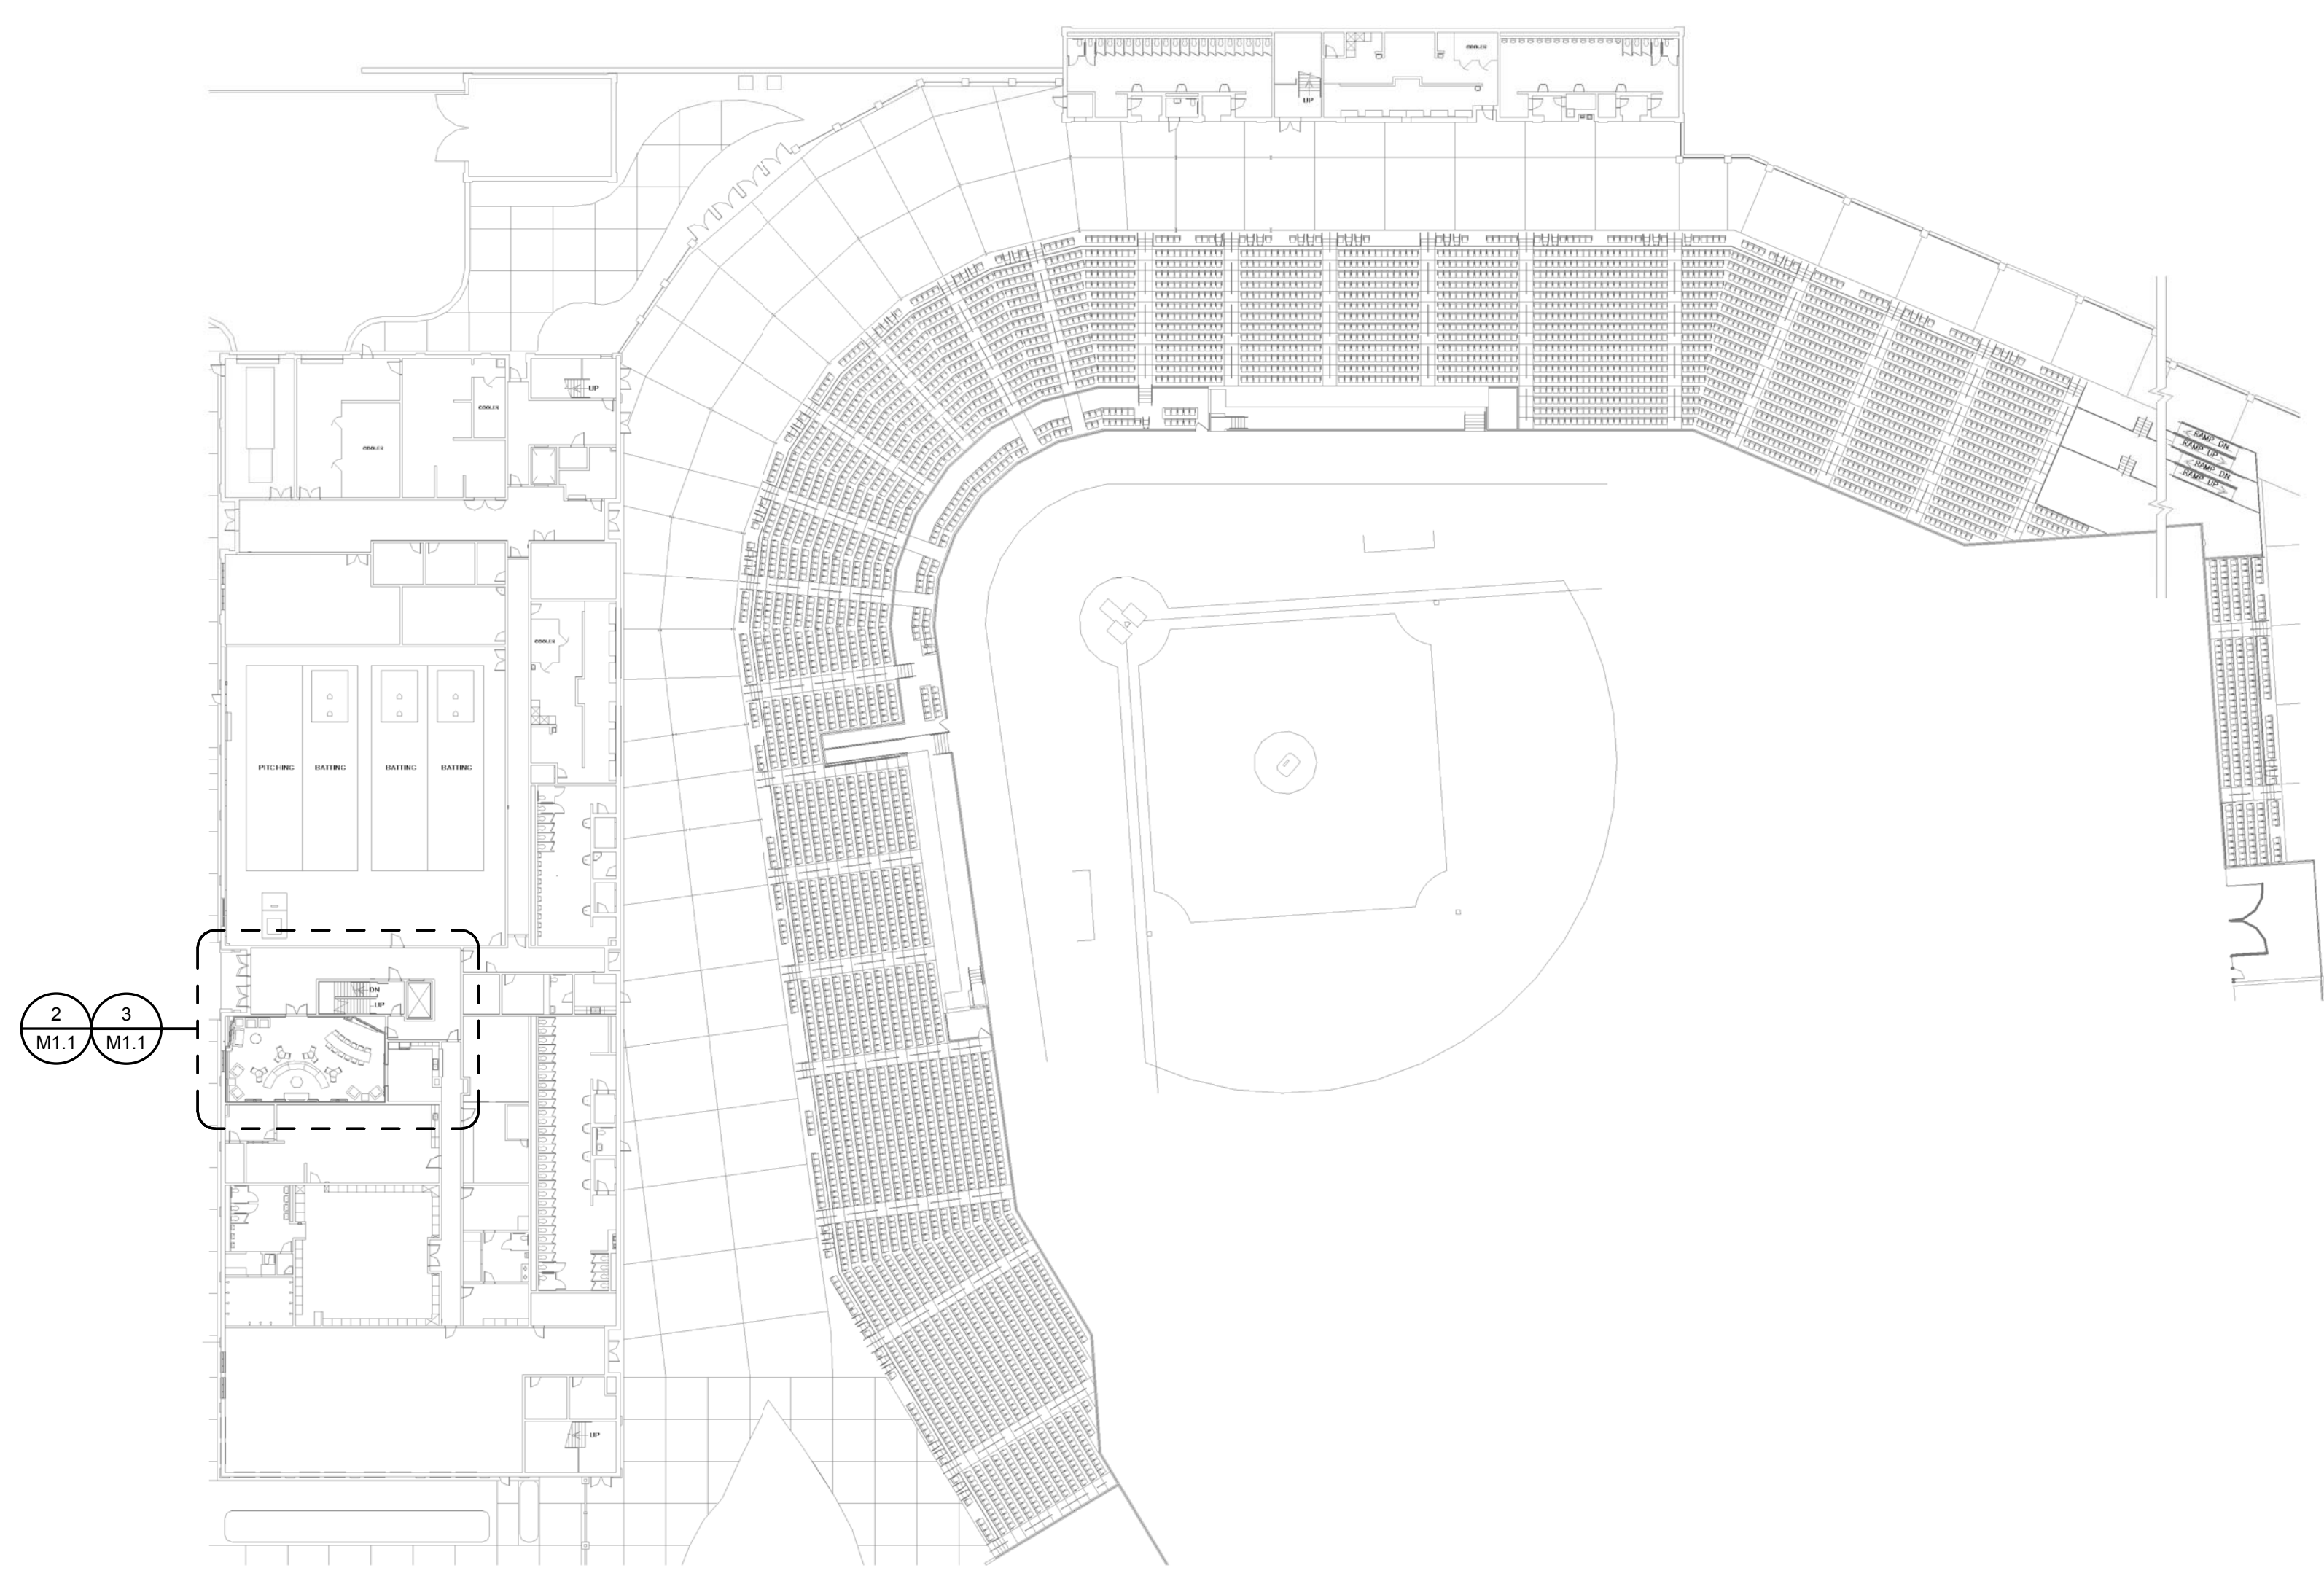


1 FLOOR PLAN - ENTRY LEVEL
M1.1 1" = 40'-0"

- DEMOLITION NOTES**
- 1 SALVAGE EXISTING ZONE SENSOR FOR REINSTALLATION/RELOCATION PER RENOVATION PLAN.
 - 2 REMOVE PLENUM RETURN GRILLE.
 - 3 REMOVE SUPPLY DIFFUSER AND FLEXIBLE RUNOUT DUCT.

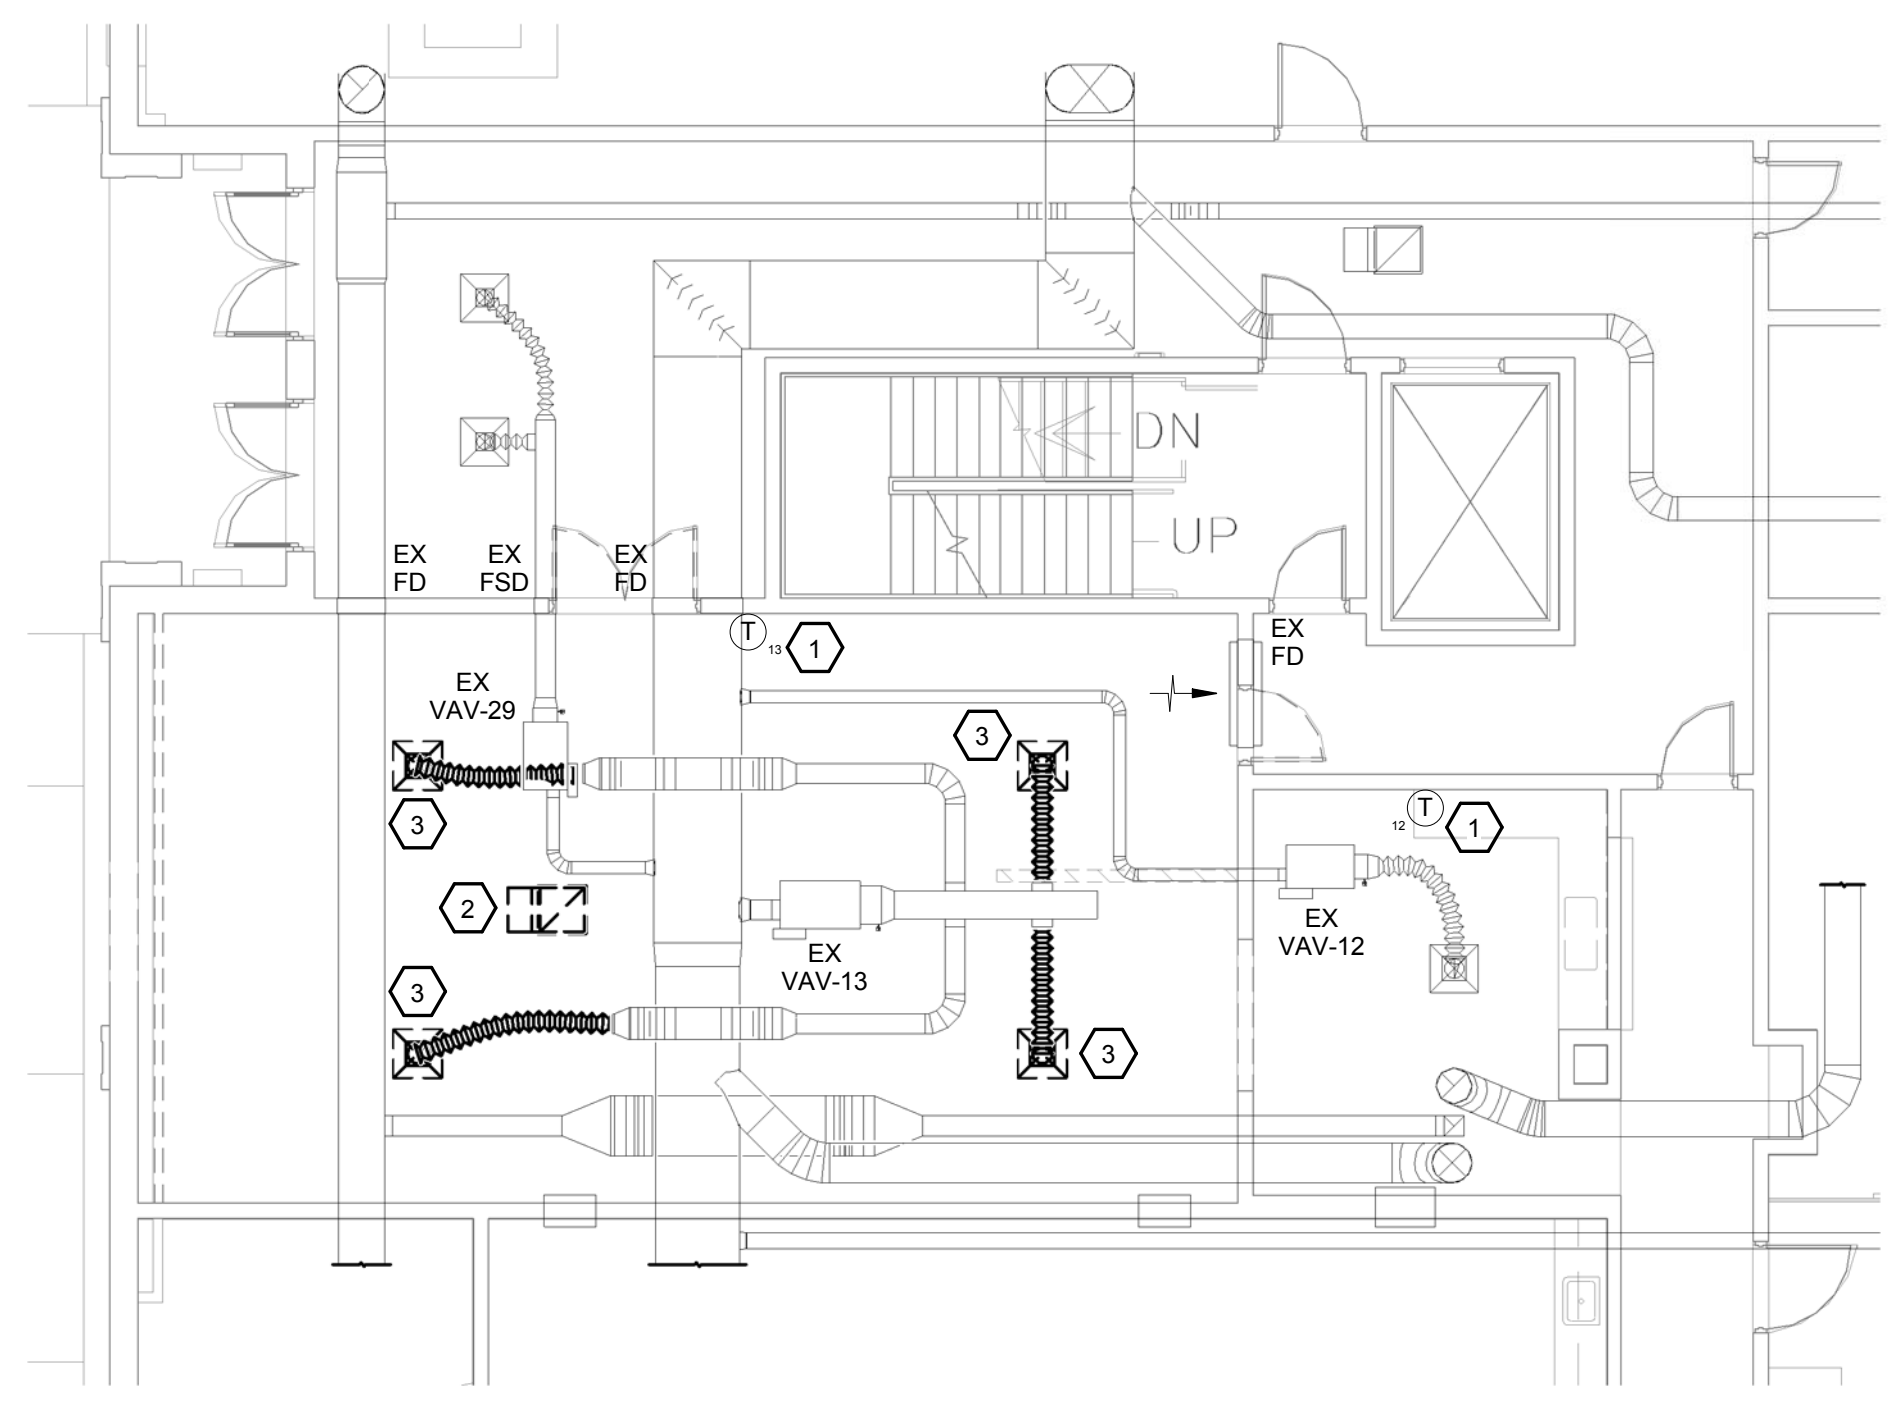


2 DEMOLITION PLAN - PLAYERS LOUNGE
M1.1 1/8" = 1'-0"

- RENOVATION NOTES**
- 1 RELOCATED EX VAV BOX ZONE SENSOR.

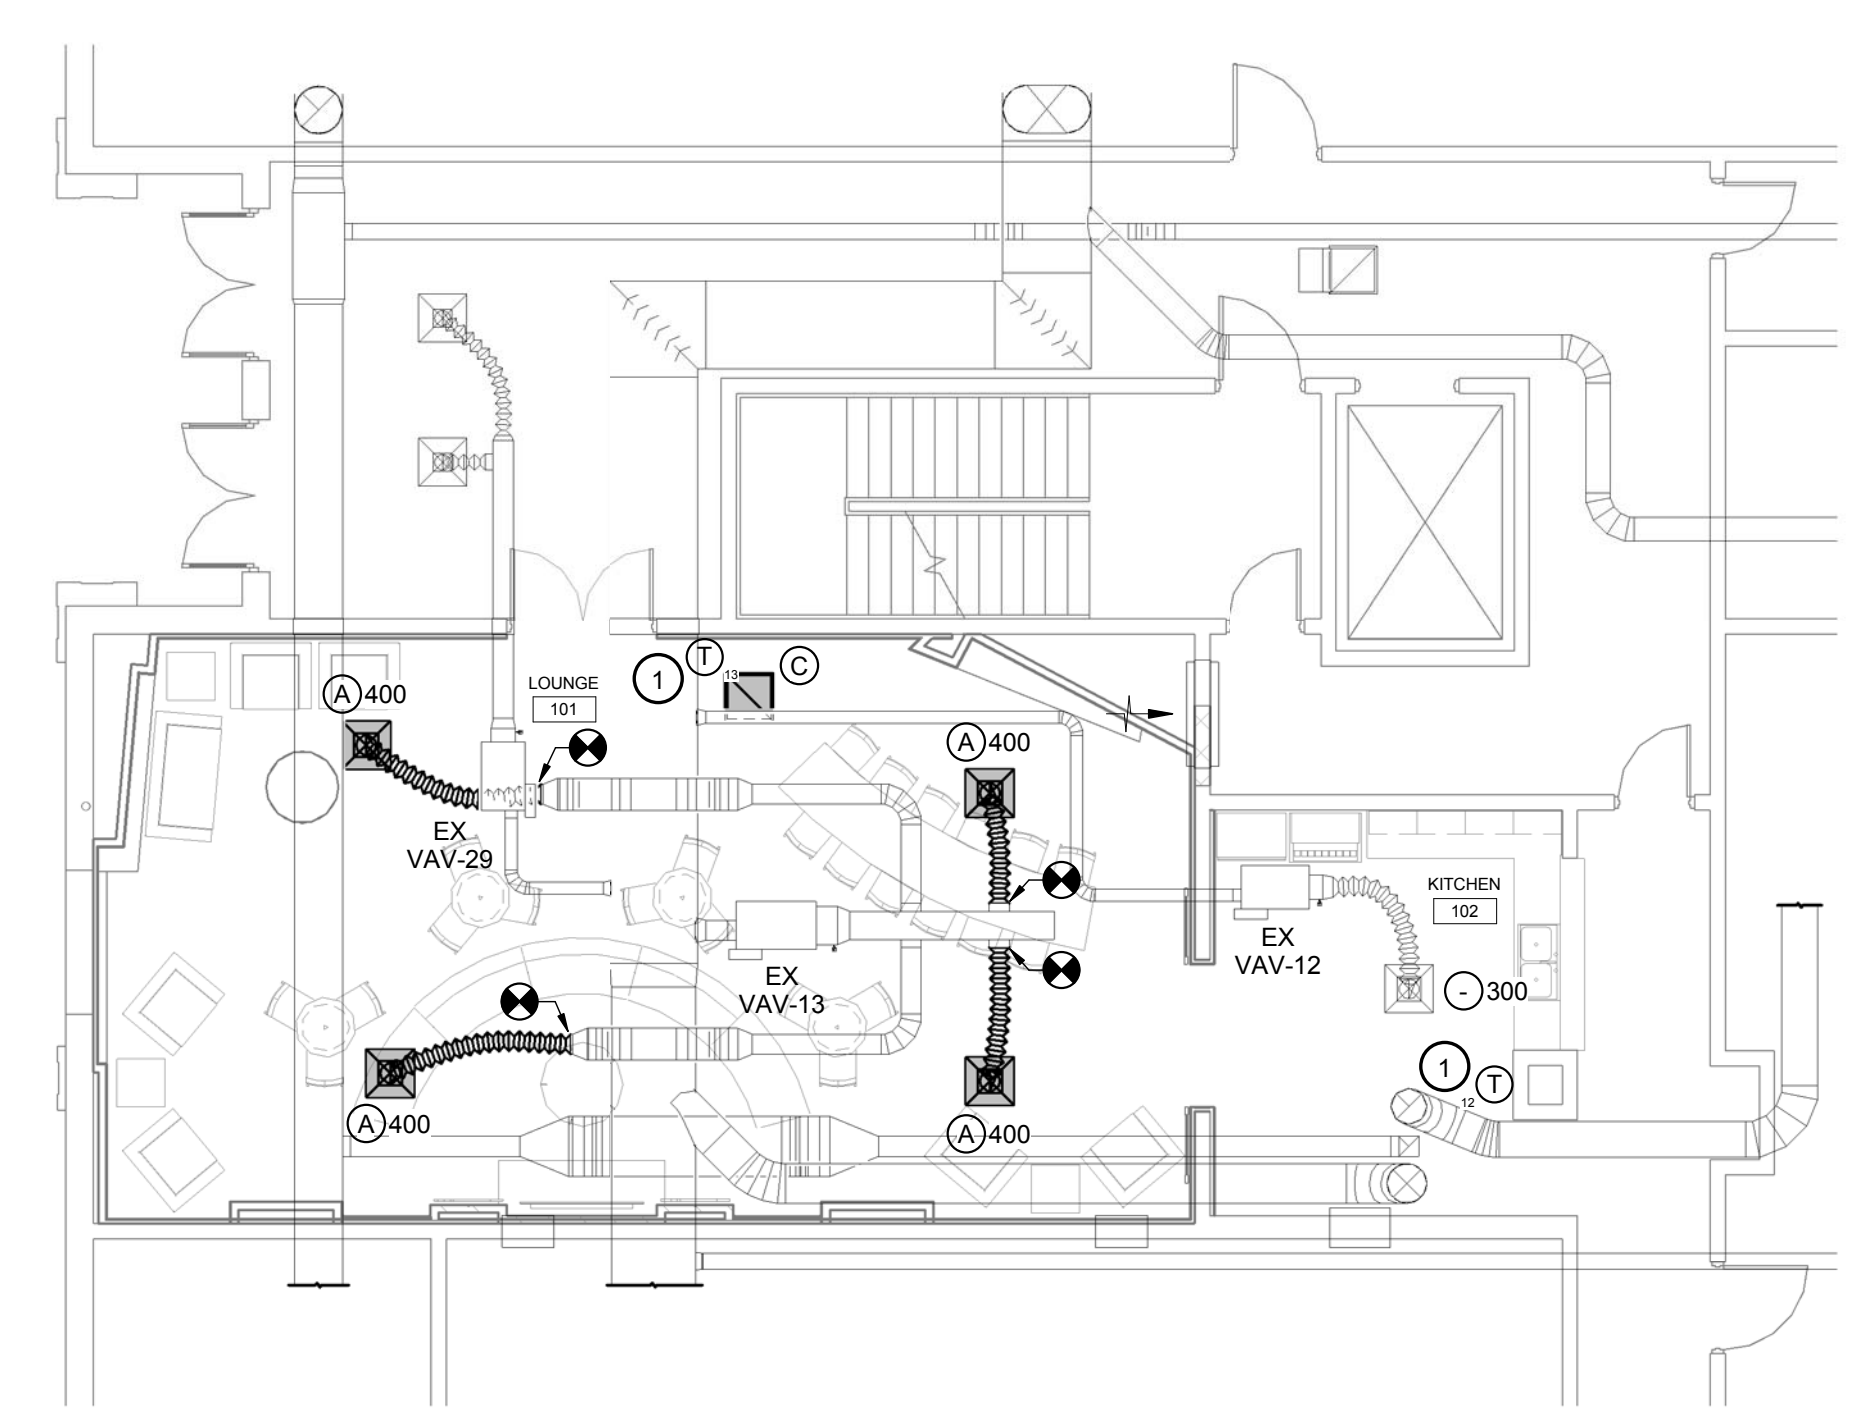

3 RENOVATION PLAN - PLAYERS LOUNGE
M1.1 1/8" = 1'-0"

Swygart & Associates
CONSULTING ENGINEERS
DBA: Swygart & Assoc., Ltd. Telephone: (803) 791-0200
Post Office Box 11666 Facsimile: (803) 791-0830
Columbia, S.C. 29211 mail@swygart-associates.com

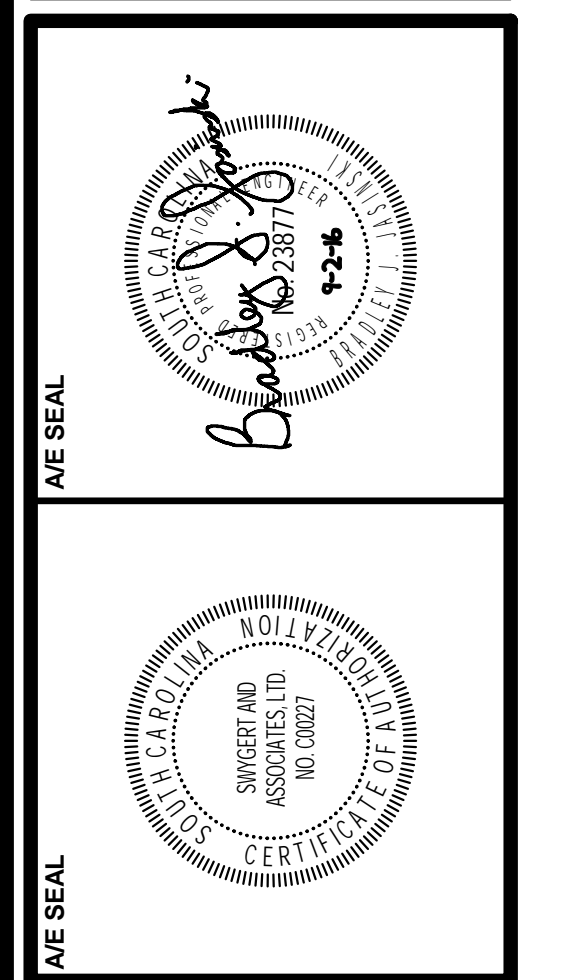

PROJECT TITLE
FOUNDERS PARK PLAYER'S LOUNGE
RENOVATION AND MEDIA ROOM
ADDITION
431 WILLIAMS STREET
COLUMBIA, SC 29201


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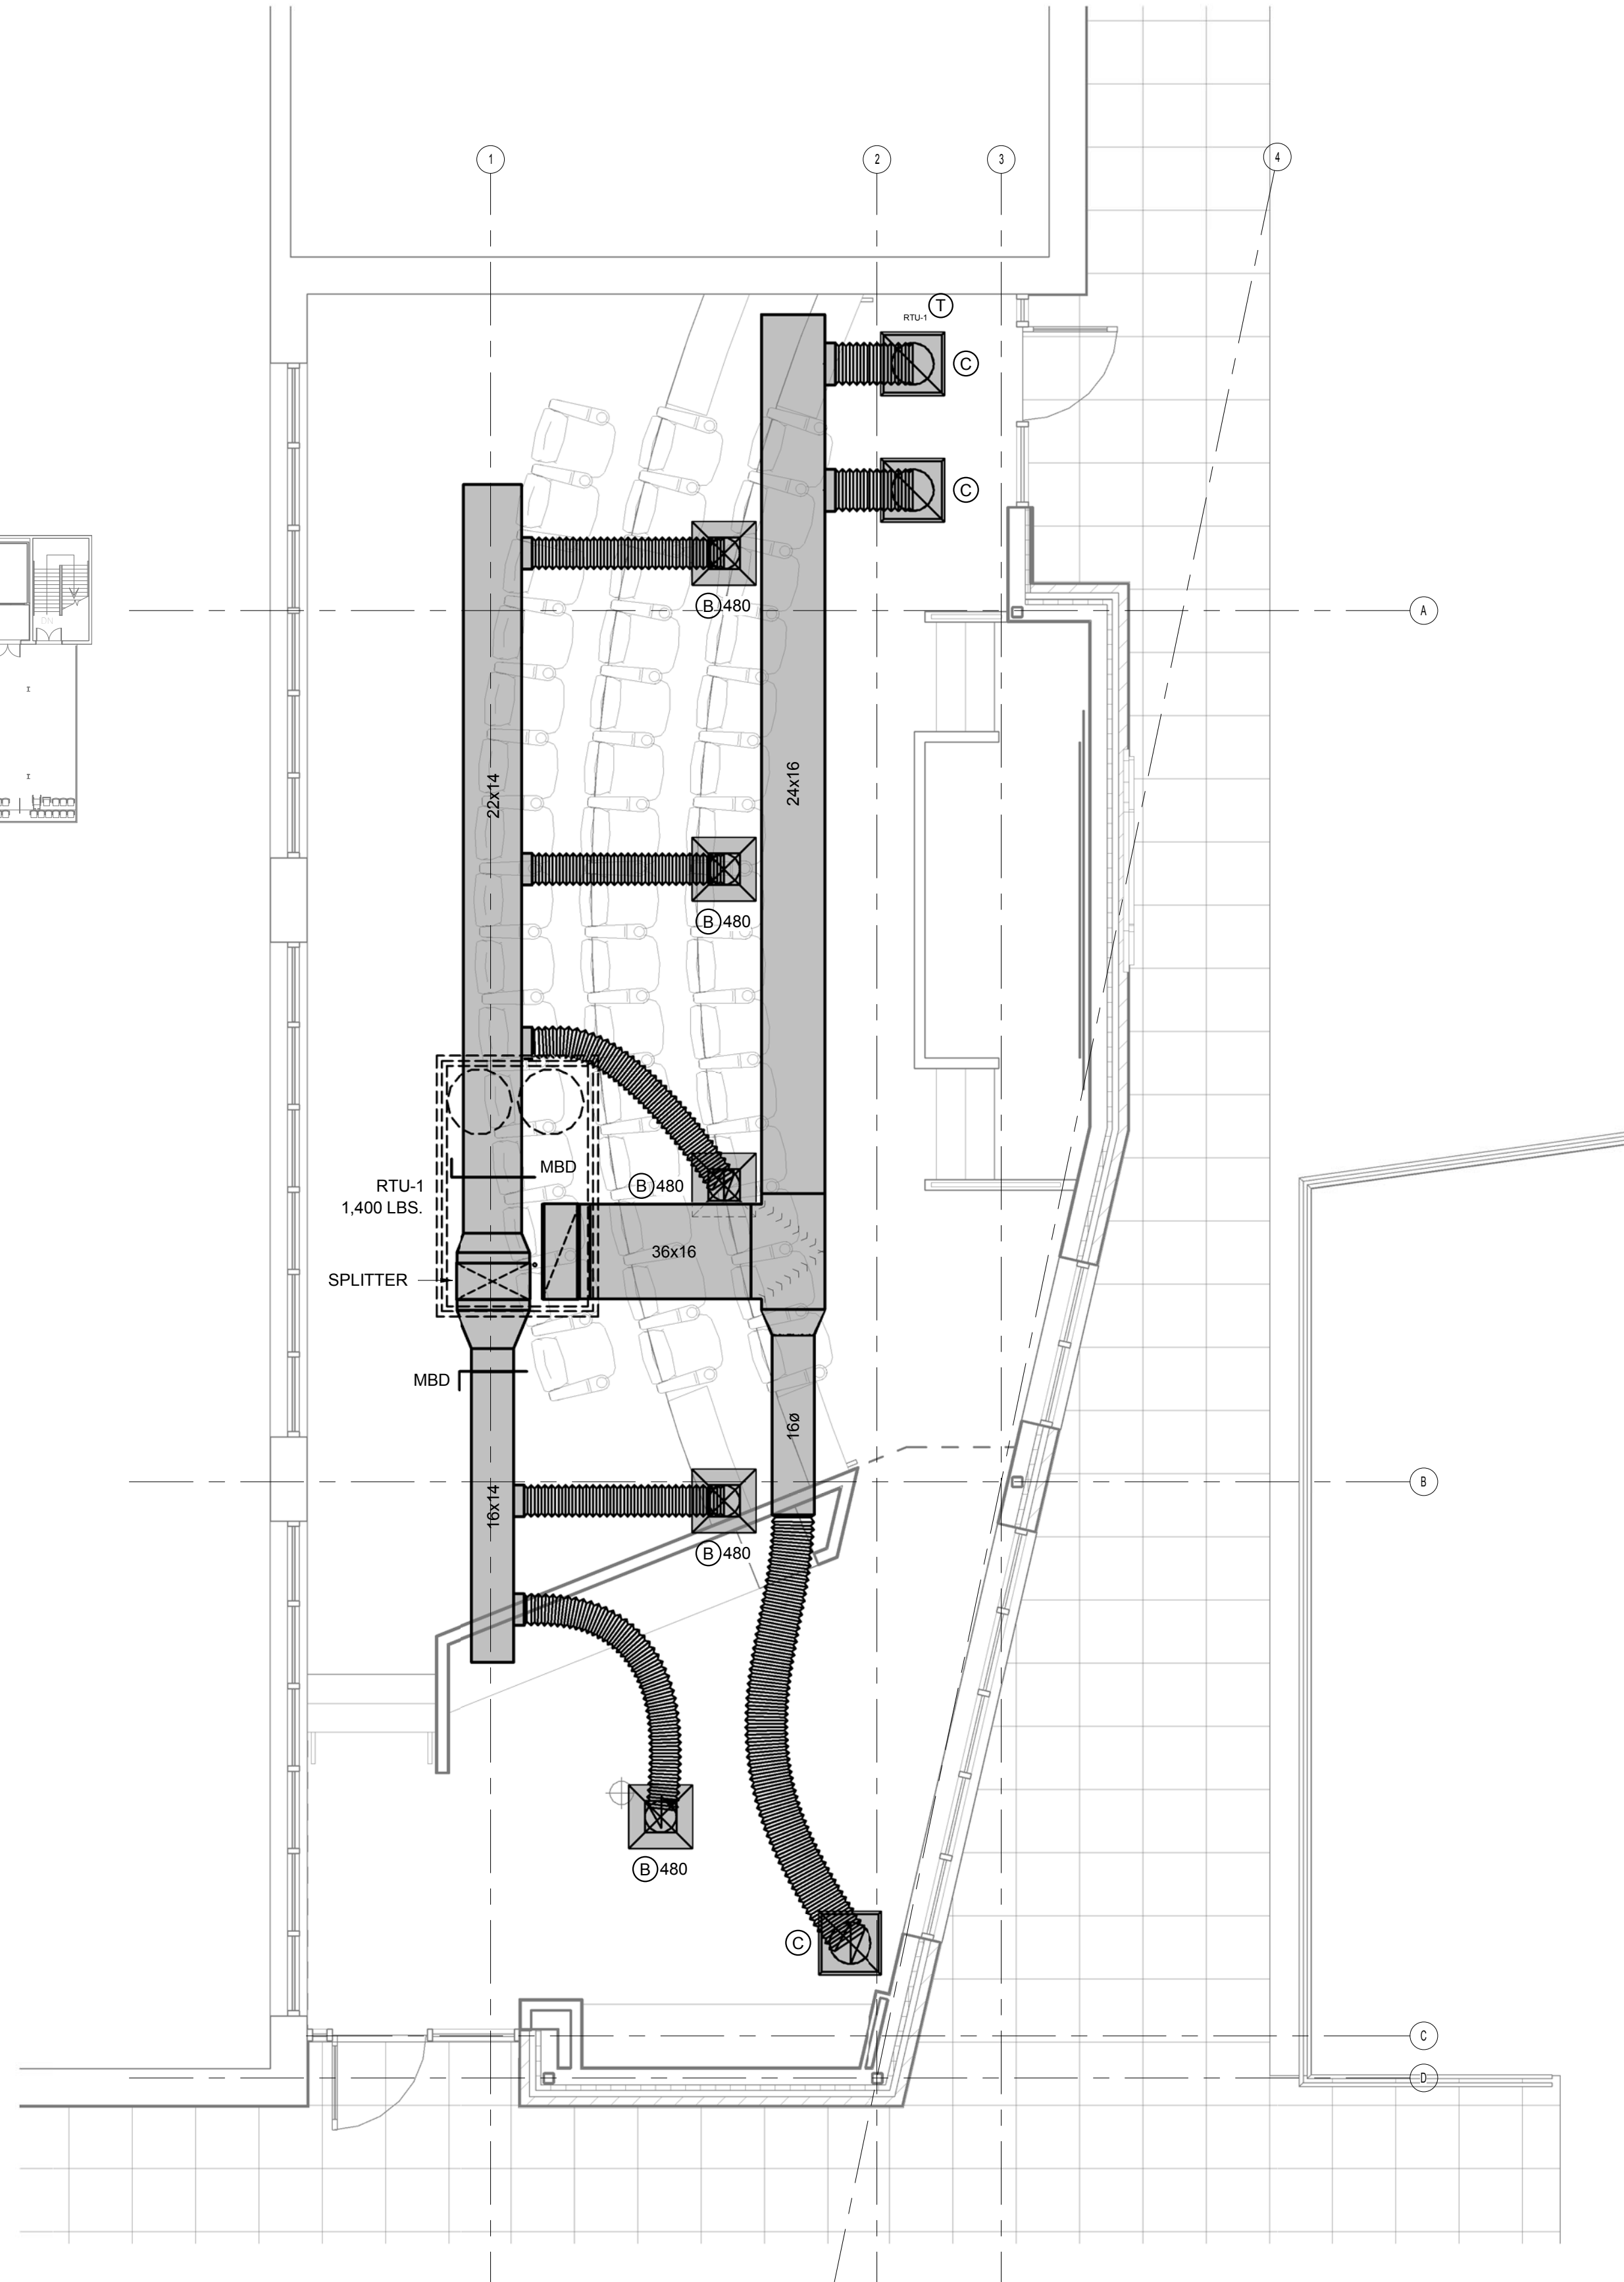
DRAWING TITLE
ENTRY LEVEL FLOOR PLAN,
PLAYER'S LOUNGE DEMOLITION
AND RENOVATION PLANS

PROJECT NO.: U42516
DATE: 02/16
DRAWING NO.: M1.1


C:\Revit Local Files\16430 Baseball Lounge-Media Room Mechanical v17.edr.rvt



1 FLOOR PLAN - CLUB LEVEL
M1.2 1" = 30'-0"

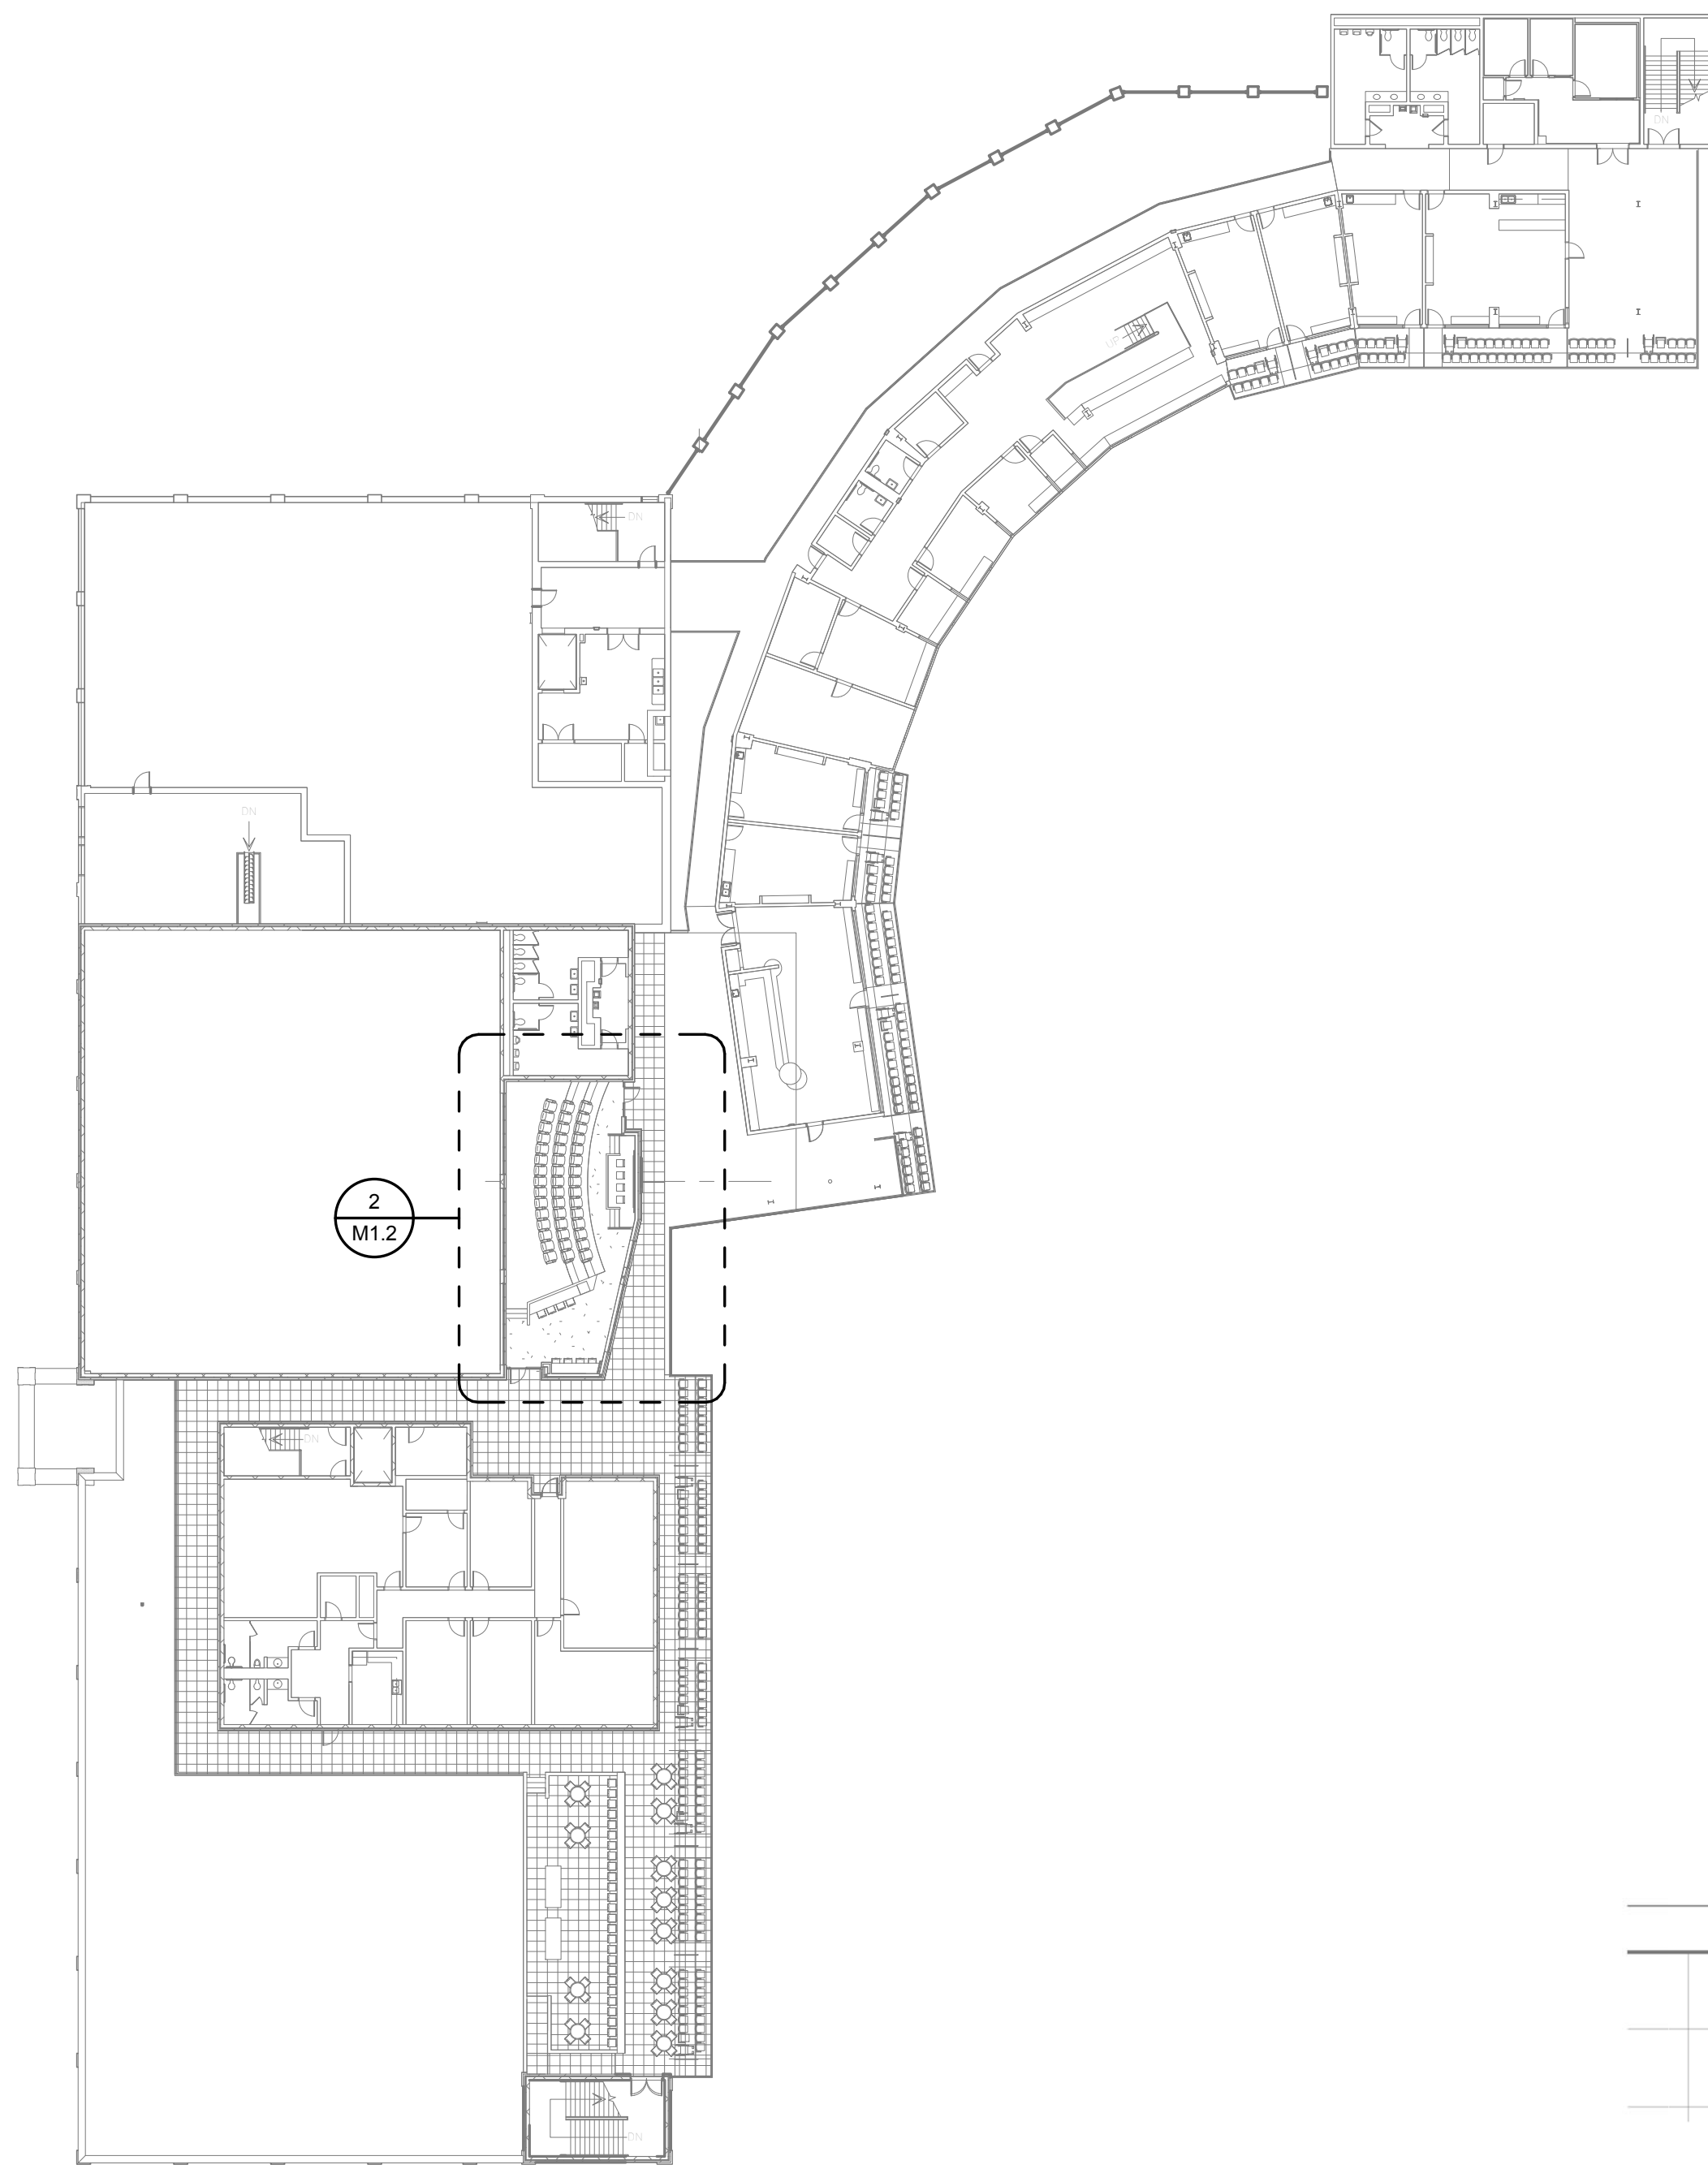

2 ENLARGED PLAN - MEDIA ROOM
M1.2 1/4" = 1'-0"

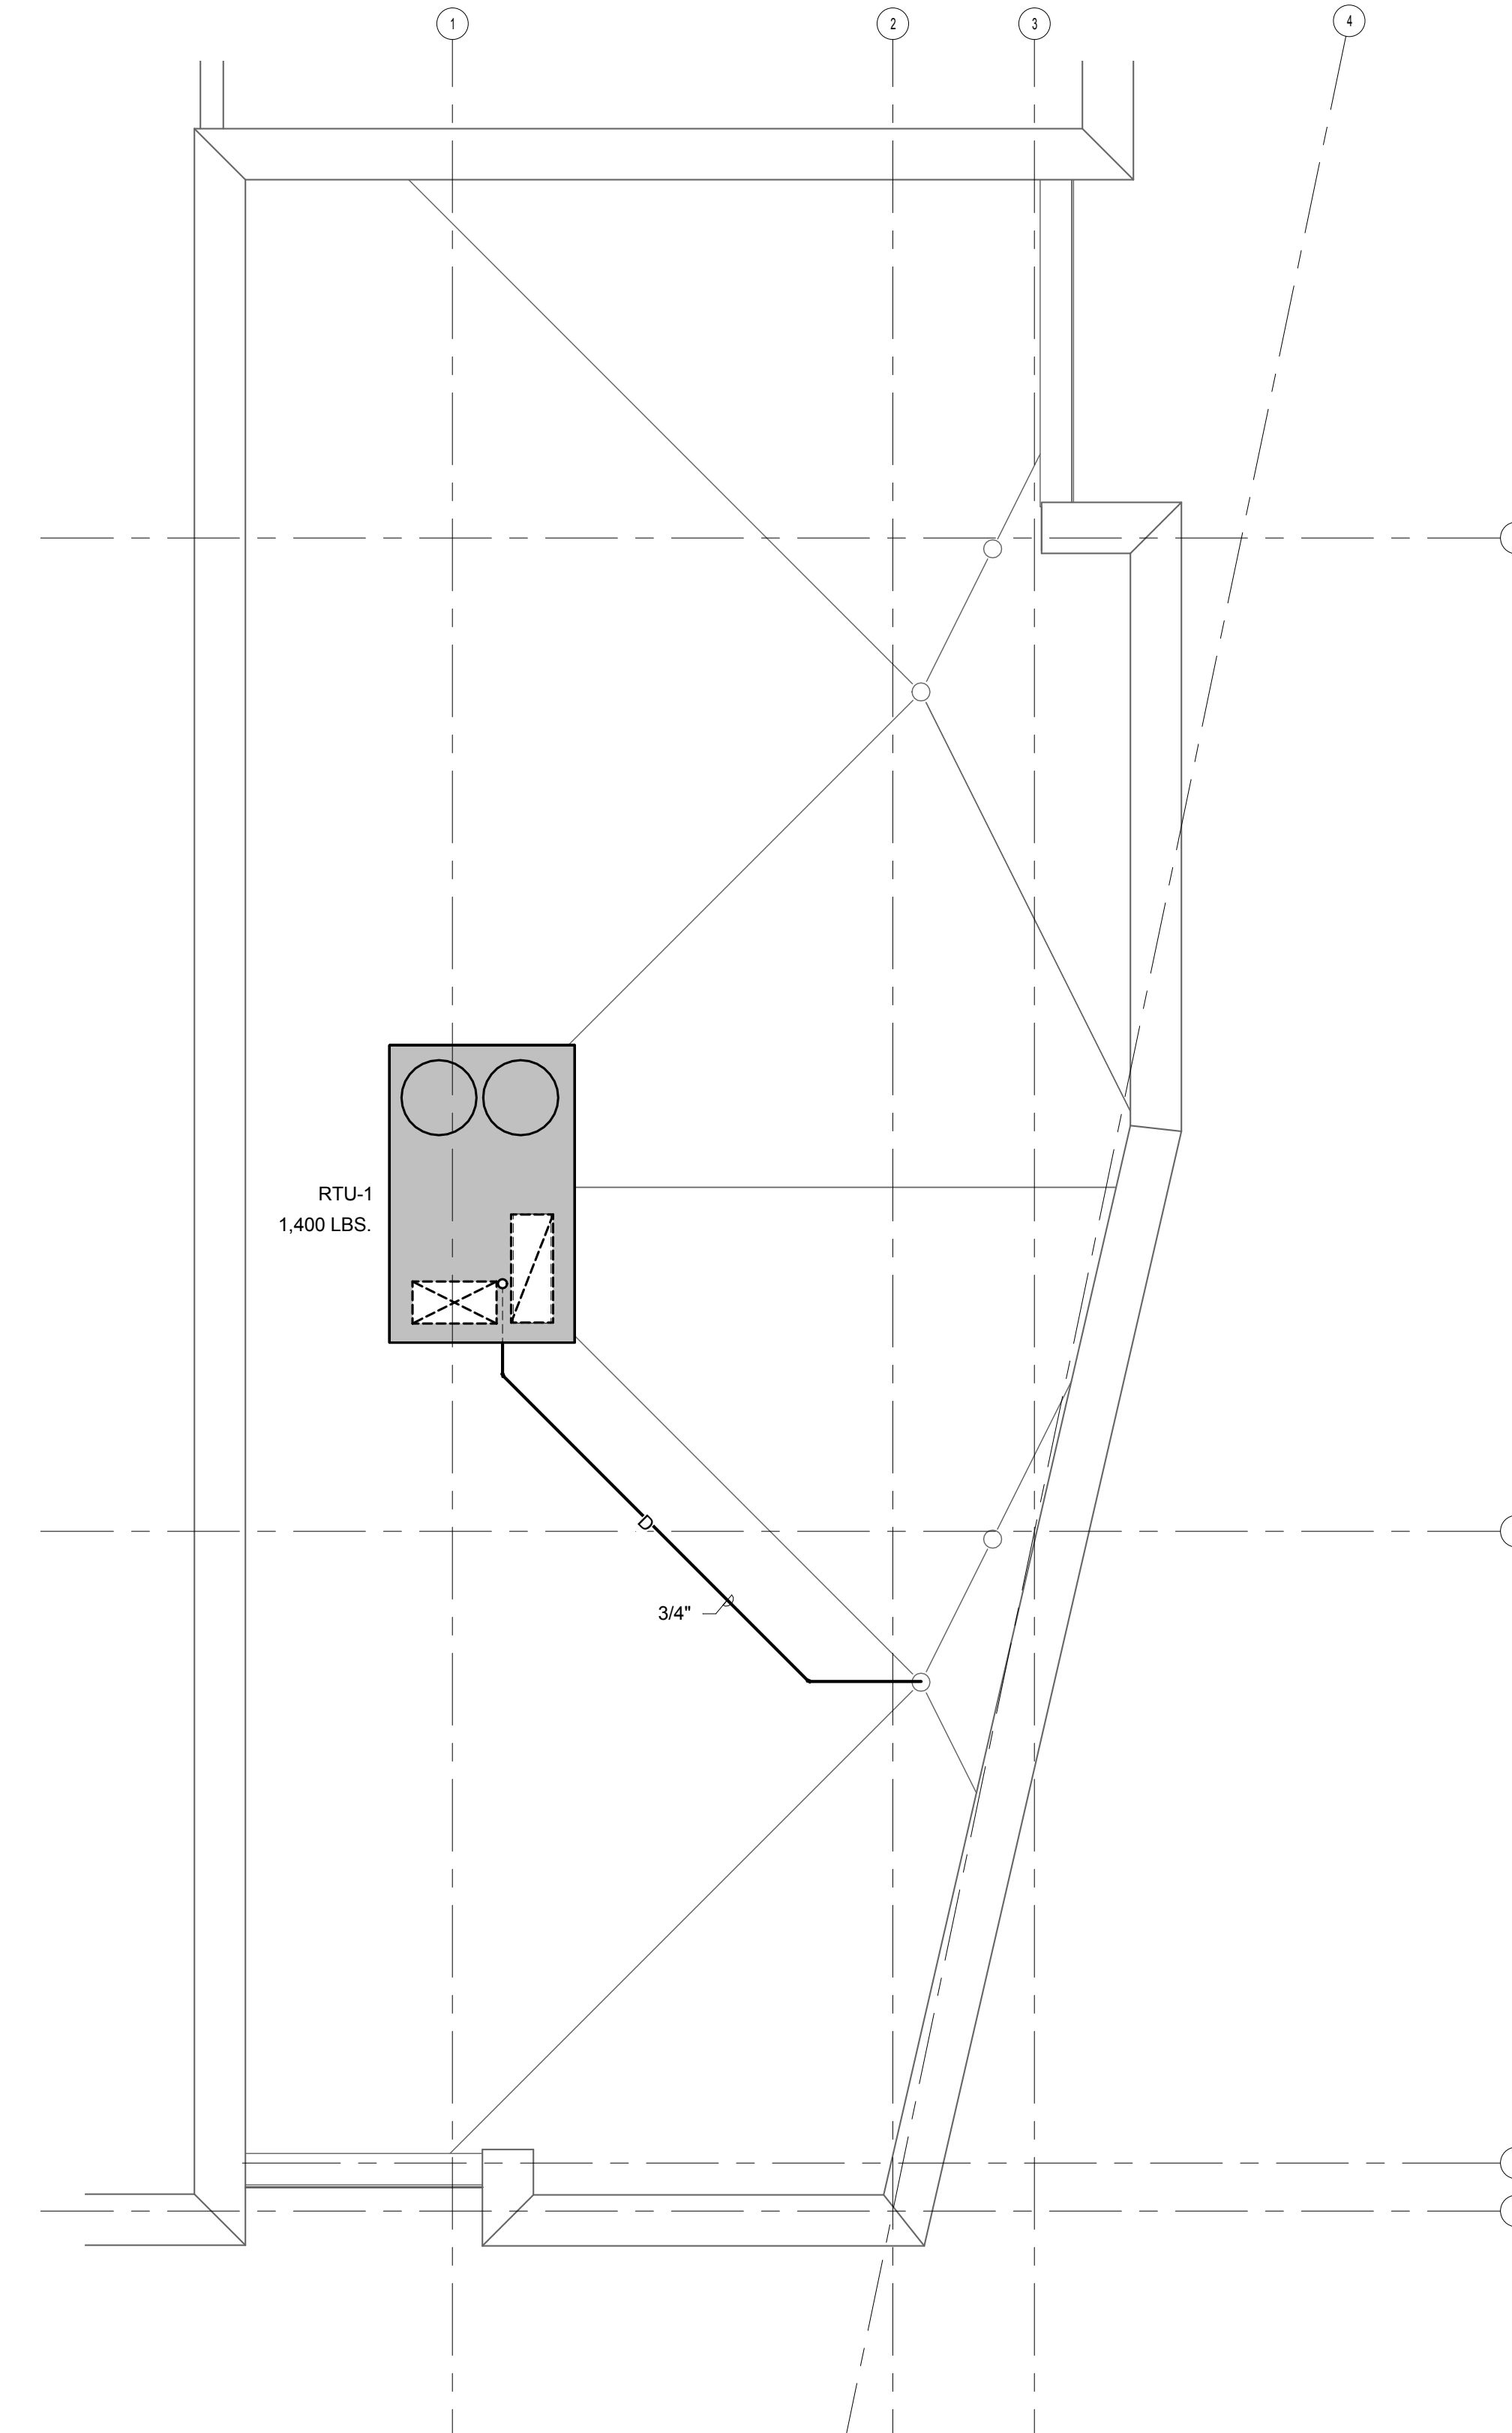

3 ROOF PLAN
M1.2 1/4" = 1'-0"

Swygart & Associates
CONSULTING ENGINEERS
DBA: Swygart & Assoc., Ltd. Telephone: (803) 791-0200
Post Office Box 11466 Facsimile: (803) 791-0830
Columbia, S.C. 29211 mail@swygart-associates.com



PROJECT NO. U42516
DATE 08/02/16
DRAWING NO. M1.2

DRAWING TITLE
CLUB LEVEL FLOOR PLAN,
ENLARGED MEDIA ROOM PLAN

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NO.	REVISIONS	NAME	DATE

PROJECT TITLE
FOUNDERS PARK PLAYER'S LOUNGE
RENOVATION AND MEDIA ROOM
ADDITION
431 WILLIAMS STREET
COLUMBIA, SC 29201

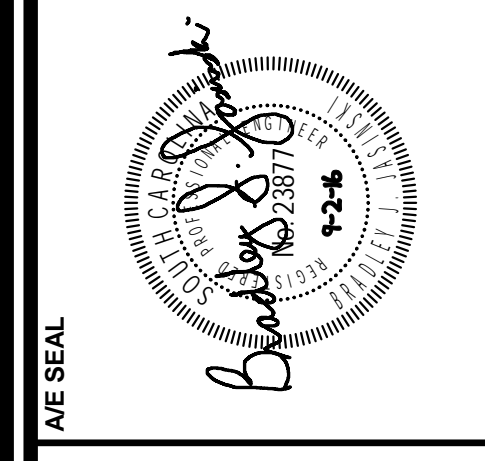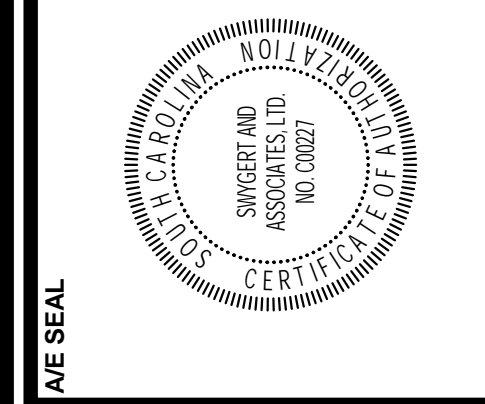

ROOFTOP HEAT PUMP SCHEDULE										
TAG	DAIKIN MODEL	COOLING CAP. MBH @ 80/67/95 TOTAL/SENSIBLE	HTG. CAP. MBH @ 47°F	AUX. HT. KW	AIRFLOW CFM	OUTDOOR AIR CFM MIN/MAX	ESP IN.W.G	INDOOR FAN H.P.	EER/ COP	REMARKS
RTU-1	DCH090	81.0/57.5	81.0	15	2,400	100/400	0.4	1.5	11.5/3.4	1,2,3,4

- PROVIDE WITH CERTIFIED SEISMIC/WIND RATED ROOF CURB.
- PROVIDE WITH 100% ECONOMIZER, BAROMETRIC RELIEF DAMPER, THROUGH THE BASE ELECTRICAL CONNECTION, FACTORY NON-FUSED, DISCONNECT SWITCH, HAIL GUARDS, POWERED CONVENIENCE OUTLET, AND HINGED ACCESS PANELS.
- PROVIDE TWO STAGES OF COOLING WITH DUAL COMPRESSORS AND TWO-SPEED INDOOR FAN. DURING FIRST STAGE OF COOLING THE INDOOR FAN SHALL OPERATE AT LOW SPEED (66% FULL SPEED) AND ON A CALL FOR THE SECOND STAGE OF COOLING THE INDOOR FAN SHALL OPERATE AT FULL SPEED.
- WALL MOUNTED CO₂ SENSOR BY CONTROLS CONTRACTOR.

AIR DISTRIBUTION SCHEDULE									
TAG	DESCRIPTION	MANUFACTURER	MODEL	FRAME	CFM	NECK SIZE	FACE SIZE	MAX NC	REMARKS
(A)	SQ. PLAQUE SUPPLY	PRICE	SPD AS	LAY-IN	226-400	10"ø	24"×24"	35	1,2
(B)	SQ. PLAQUE SUPPLY	PRICE	SPD AS	LAY-IN	401-600	12"ø	24"×24"	35	1,2
(C)	PERFORATED RETURN	PRICE	AFDR	LAY-IN	0-1,000	22"×22"	24"×24"	35	1,2


- PROVIDE WITH STANDARD WHITE FINISH.
- PROVIDE ALUMINUM OR ALUMINIZED STEEL CONSTRUCTION.

ISOLATION AND SEISMIC SCHEDULE				
RISK CATEGORY = II			SEISMIC DESIGN CATEGORY = D	
EQUIPMENT TYPE/TAG	COMPONENT I _p	ISOLATION SPECIFICATION	SEISMIC RESTRAINT SPECIFICATION	ISOLATION DEFLECTION
RTU-1	1.0	N/A	SPEC X NOTES 1 & 2	N/A
AIR DISTRIBUTION > 20 LBS	1.0	NONE	TWO 12 GA. WIRE TO STRUCTURE	N/A
AIR DISTRIBUTION ≤ 20 LBS	1.0	NONE	NOTE 3	N/A


- ANCHOR BOLTS FOR NON-ISOLATED AND INTERNALLY ISOLATED EQUIPMENT SHALL BE SIZED BY THE SEISMIC RESTRAINT SUPPLIER.
- ROOF CURBS MUST BE CERTIFIED BY A PROFESSIONAL ENGINEER FOR THE REQUIRED SEISMIC AND WIND LOADS.
- DIFFUSERS WEIGHING LESS THAN 20 LBS. MUST BE MECHANICALLY ATTACHED TO CEILING GRID, BUT REQUIRE NO ADDITIONAL RESTRAINT.

DESIGN CONDITIONS		
SEASON	OUTSIDE	INSIDE
SUMMER	97° FDB / 78° FWB	75° FDB / 50% - 60% RH
WINTER	22° FDB	70° FDB


- ### GENERAL NOTES
- DO NOT SCALE DRAWINGS. SEE ARCHITECTURAL DRAWINGS AND REFLECTED CEILING PLANS FOR EXACT LOCATIONS OF DOORS, WINDOWS, AIR DISTRIBUTION, ETC. THIS CONTRACTOR SHALL VERIFY ALL EXISTING ITEMS AND LOCATIONS IN THE FIELD.
 - ALL PIPING AND DUCTWORK LOCATIONS SHALL BE COORDINATED WITH WORK UNDER OTHER DIVISIONS OF THE SPECIFICATIONS TO AVOID INTERFERENCE.
 - THIS CONTRACTOR SHALL COORDINATE STEEL OPENINGS AND EQUIPMENT SUPPORT WITH STEEL SHOP DRAWINGS TO CONFIRM DIMENSIONS MATCH WITH EQUIPMENT SUPPLIED.
 - EXISTING PIPE, DUCTWORK, CONDUIT, ETC. THAT INTERFERES WITH THE ROUTING OF NEW SYSTEMS SHALL BE RELOCATED. THIS CONTRACTOR SHALL INCLUDE THE COST OF SUCH IN HIS BID UNLESS NOTED OTHERWISE.
 - ALL PIPING AND DUCTWORK INSULATION SHALL BE RUN CONTINUOUSLY THROUGH FLOORS, ROOFS AND PARTITIONS.
 - ALL MECHANICAL ITEMS EXTENDING THROUGH WALLS AND ROOF SHALL BE FLASHED AND COUNTERFLASHED. COORDINATE WITH ROOFING CONTRACTOR.
 - EXTEND ALL DRAIN LINES TO NEAREST ROOF DRAIN OR AS INDICATED - SO ROUTED AS TO AVOID INTERFERENCE WITH PASSAGEWAYS AND MAINTENANCE. DRAINS FROM AIR CONDITIONING UNITS SHALL BE TRAPPED PER STATIC PRESSURE REQUIREMENTS.
 - ALL DUCTWORK SPECIFIED TO BE LINED SHALL BE INCREASED IN SIZE TO ALLOW FOR LINER.
 - WHERE TRUNK DUCTS ARE ROUTED ABOVE INACCESSIBLE CEILINGS PROVIDE CABLE OPERATED REMOTE CONTROLLED VOLUME DAMPERS AT BRANCH TAKEOFFS. DAMPERS SHALL BE METROPOLITAN AIR TECHNOLOGY MODEL RT-150 OR APPROVED EQUAL.
 - SPACE ABOVE CEILING TO BE USED AS RETURN AIR PLENUM WHERE DUCT IS NOT INDICATED ABOVE RETURN AIR GRILLES.
 - ALL OPEN END DUCTS SHALL HAVE 1/4-INCH MESH GALVANIZED SCREEN IN REMOVABLE FRAME.
 - WHERE 2X2" LAY IN GRILLES ARE SPECIFIED IN HARD CEILINGS, A PLASTER FRAME SHALL BE PROVIDED SO THE GRILLE CAN LAY IN THE CEILING.
 - PROVIDE FOR ACCESS TO ALL EQUIPMENT REQUIRING CLEANING OR ADJUSTMENT PER MANUFACTURER'S INSTRUCTIONS. PROVIDE FULL SPACE FOR COIL REMOVAL AND REPLACEMENT FOR ALL HOT WATER AND CHILLED WATER AIR HANDLING UNITS.
 - THIS CONTRACTOR SHALL PROVIDE ALL ITEMS OF MISCELLANEOUS STEEL AS REQUIRED FOR INSTALLATION OF ALL MECHANICAL ITEMS.
 - THIS CONTRACTOR SHALL DO ALL CONTROL WIRING. DIVISION 26 WILL DO ALL POWER WIRING. ALL WIRING SHALL BE IN ACCORDANCE WITH NATIONAL ELECTRIC CODE. CONTROL WIRING SHALL BE CONCEALED WITHIN WALL AND ALL CONTROL WIRING SHALL BE ROUTED IN EMT CONDUIT.
 - LOCATE ALL SPACE CONTROL INSTRUMENTS 4'-0" ABOVE FINISHED FLOOR IN ACCORDANCE WITH ADA. COORDINATE LOCATIONS WITH ARCHITECTURAL ELEVATIONS TO AVOID ITEMS INCLUDING BUT NOT LIMITED TO CUSTOM FINISHES, FIXED CASEWORK, FURNITURE, AND DOOR SWINGS. IN THE EVENT OF CONFLICTS IN THE FIELD, THE CONTRACTOR SHALL BRING THIS TO THE ATTENTION OF THE A/E FOR FINAL APPROVAL OF LOCATION.
 - INSTRUMENT TEST HOLES SHALL BE LOCATED IN EACH SUPPLY DUCT OR ZONE DUCT, IN EACH RETURN AIR DUCT AND EACH OUTSIDE AIR DUCT.
 - CORRECT SETTINGS ON ALL BALANCING FITTINGS SHALL BE PERMANENTLY MARKED. PROVIDE ORANGE FLAGGING RIBBON ON EACH DAMPER HANDLE FOR EASY IDENTIFICATION.
 - ITEMS REMOVED UNDER THIS CONTRACT SHALL BECOME THE PROPERTY OF THE CONTRACTOR AND SHALL BE DISPOSED OF PROPERLY.
 - THE HVAC SYSTEMS SHALL NOT BE OPERATED DURING HEAVY CONSTRUCTION OPERATIONS INCLUDING MASONRY, GYPSUM BOARD SANDING, HEAVY CLEANUP ACTIVITIES, OR OTHER ACTIVITIES THAT CREATE AIRBORNE PARTICLES OR DEBRIS. ALL SYSTEMS SHALL BE CLEAN OF CONSTRUCTION DEBRIS, DUST AND DIRT AT FINAL COMPLETION. DUCT CLEANING AND UNIT/COIL CLEANING SHALL BE PERFORMED AS REQUIRED.

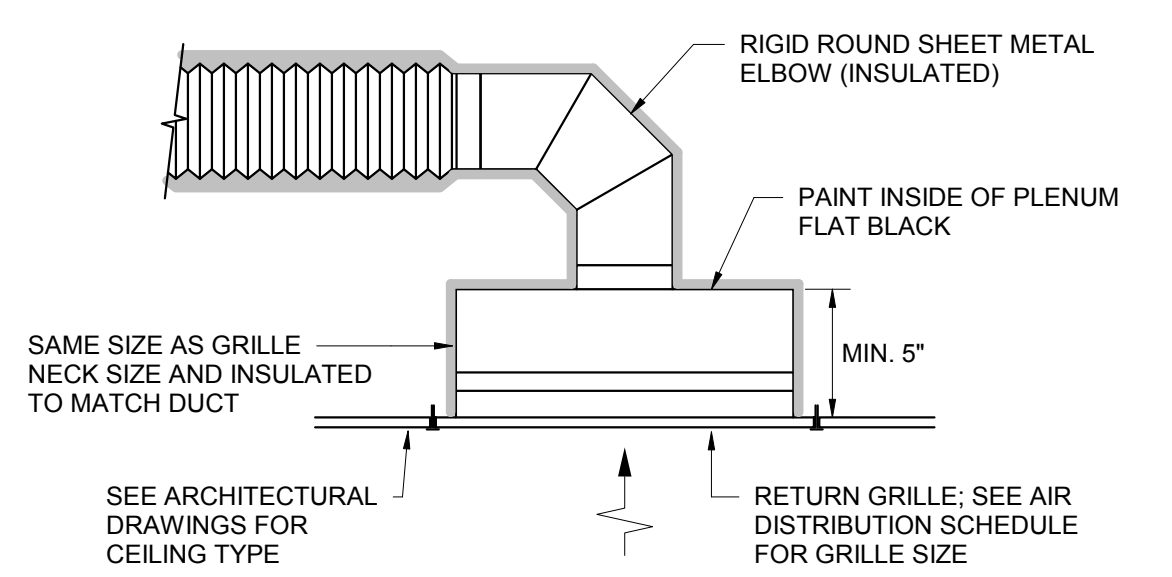


5 DUCTED RETURN GRILLE DETAIL
M2.1 NO SCALE

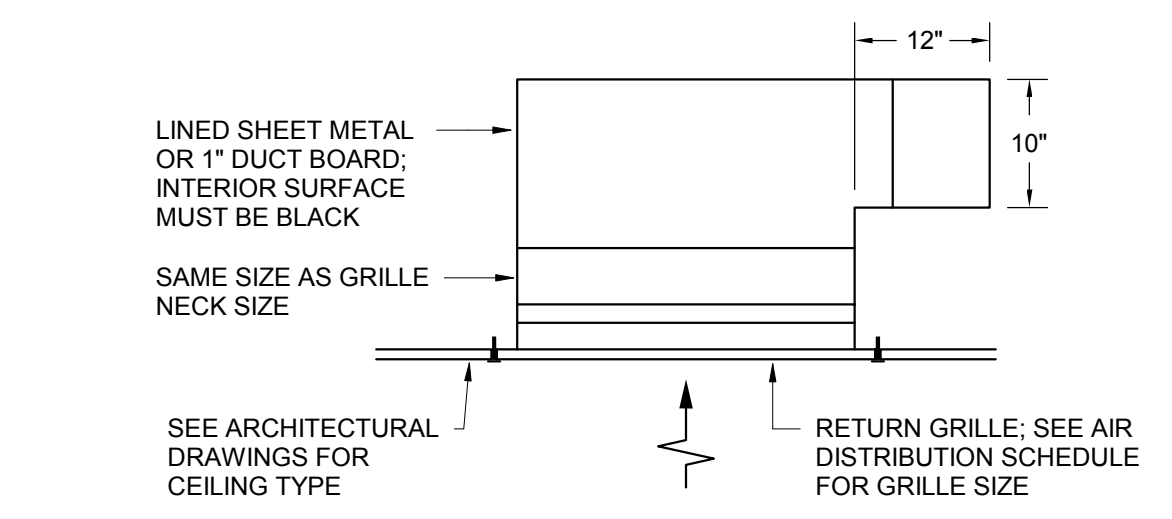


3 PLENUM RETURN GRILLE DETAIL
M2.1 NO SCALE

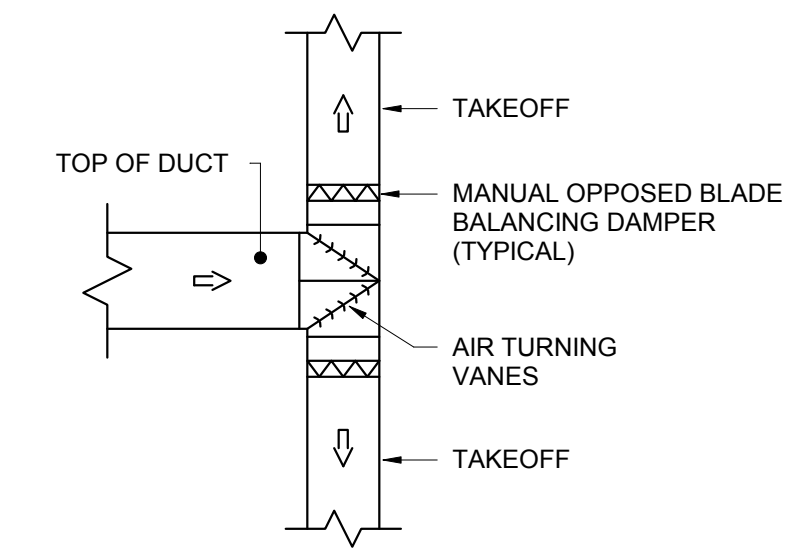

4 SPLITTER DETAIL
M2.1 NO SCALE


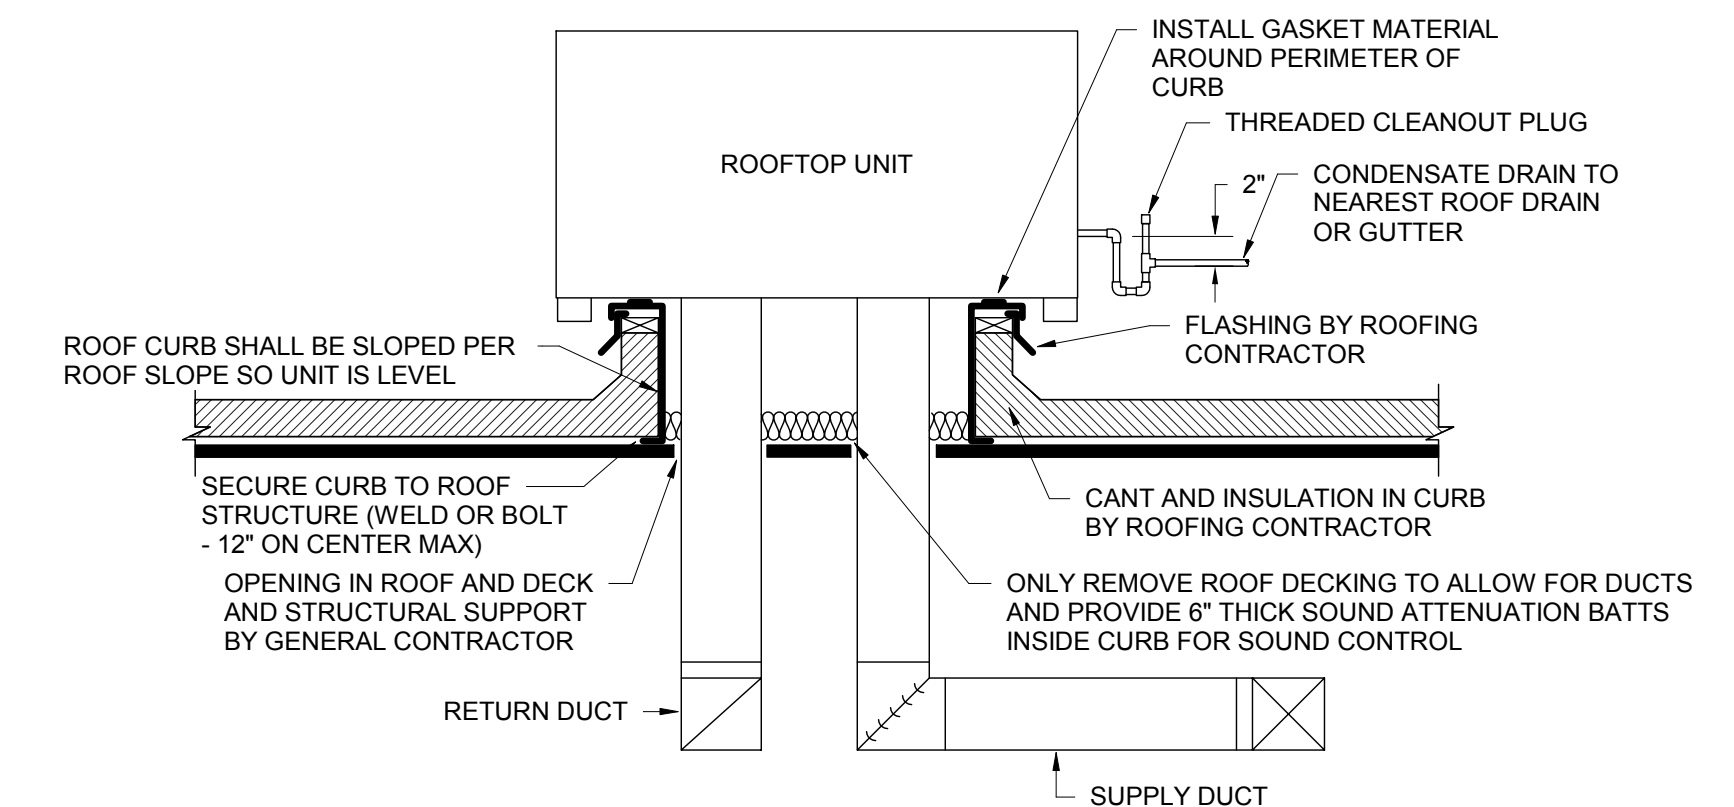


1 ROOFTOP UNIT DETAIL
M2.1 NO SCALE

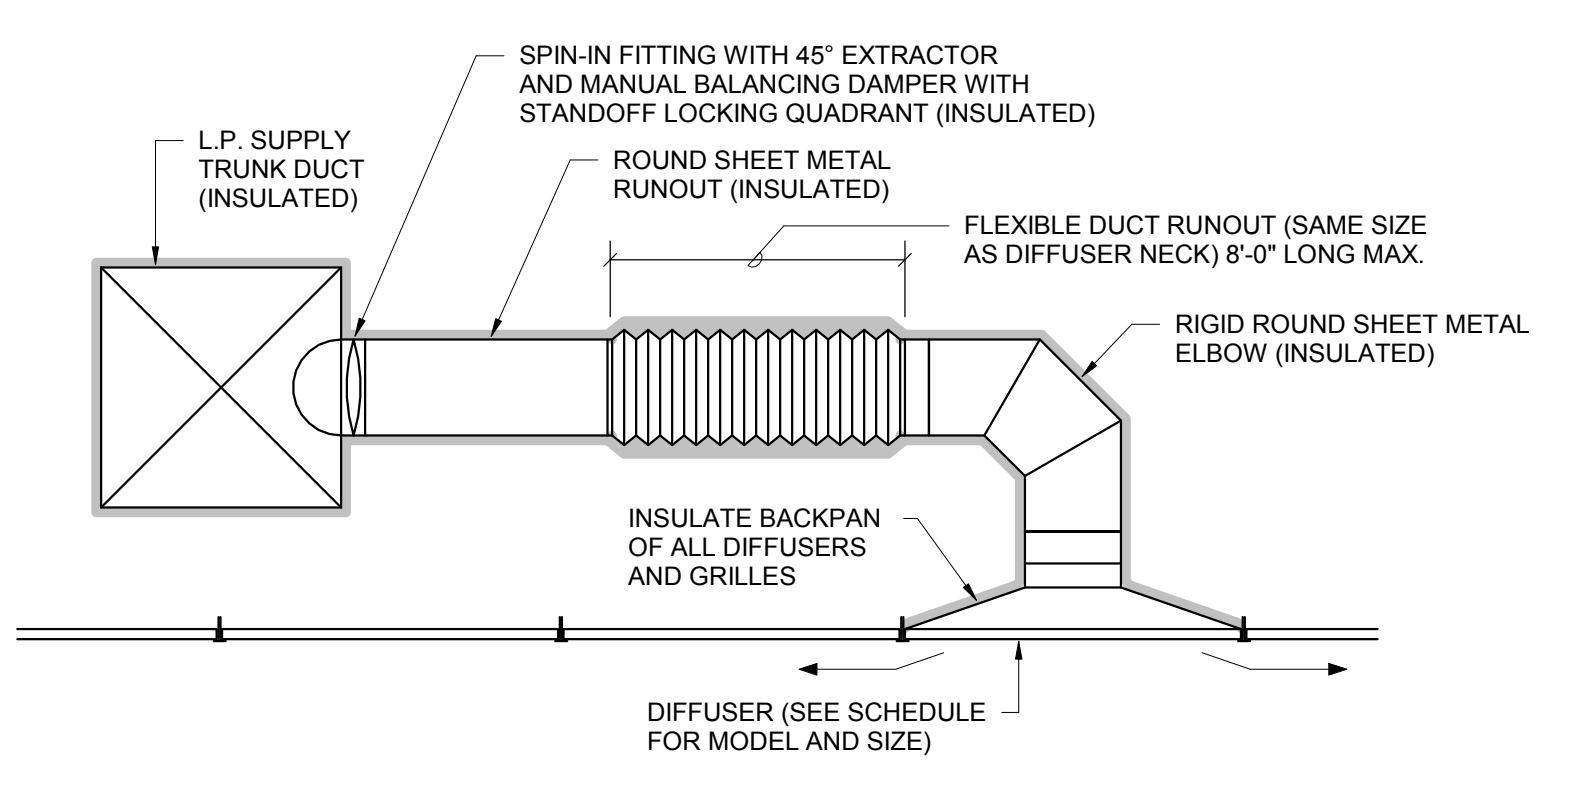

2 CEILING DIFFUSER DETAIL
M2.1 NO SCALE

LEGEND	
SYMBOL	DESCRIPTION
	DRAIN LINE
	PIPE TURNS TO, AWAY
	TYPE "A" DIFFUSER, 100 CFM
	EXISTING/RELOCATED DIFFUSER, 100 CFM
	TEMPERATURE SENSOR
	FIRE DAMPER
	COMBINATION FIRE/SMOKE DAMPER W/ 120V ACTUATOR
	MANUAL OPPOSED BLADE BALANCING DAMPER
	RECTANGULAR SUPPLY DUCTWORK
	OVAL SUPPLY DUCTWORK
	RETURN, EXHAUST, FRESH AIR DUCTWORK
	48x24 RECTANGULAR DUCT
	48x24 OVAL DUCT
	1" DOOR UNDERCUT BY GENERAL CONTRACTOR
	ABOVE FINISHED FLOOR
	CONNECTION POINT OF NEW TO EXISTING

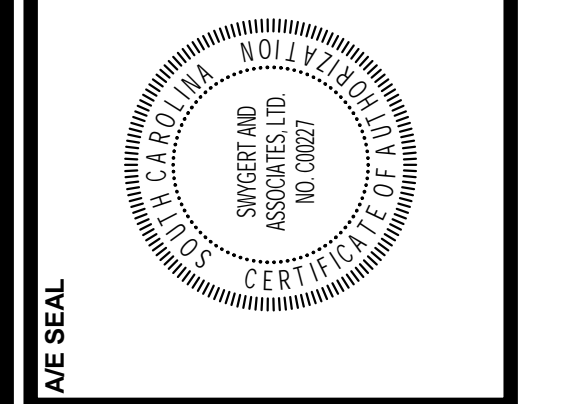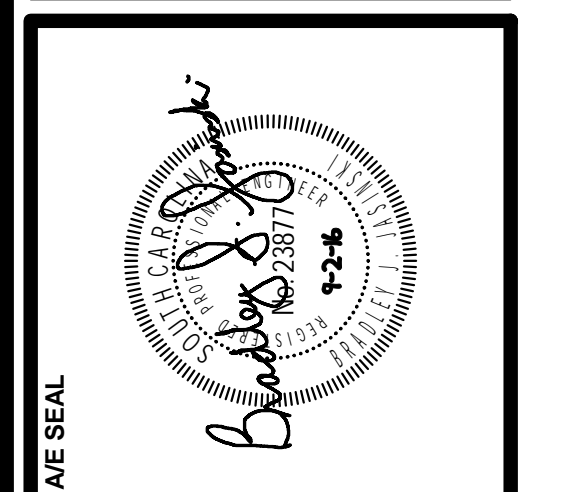

FOUNDERS PARK PLAYER'S LOUNGE RENOVATION AND MEDIA ROOM ADDITION
431 WILLIAMS STREET
COLUMBIA, SC 29201

NO.	REVISIONS	DATE
	NAME	


DRAWN BY:	ELJ
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DETAILS, NOTES, SCHEDULES, AND LEGEND


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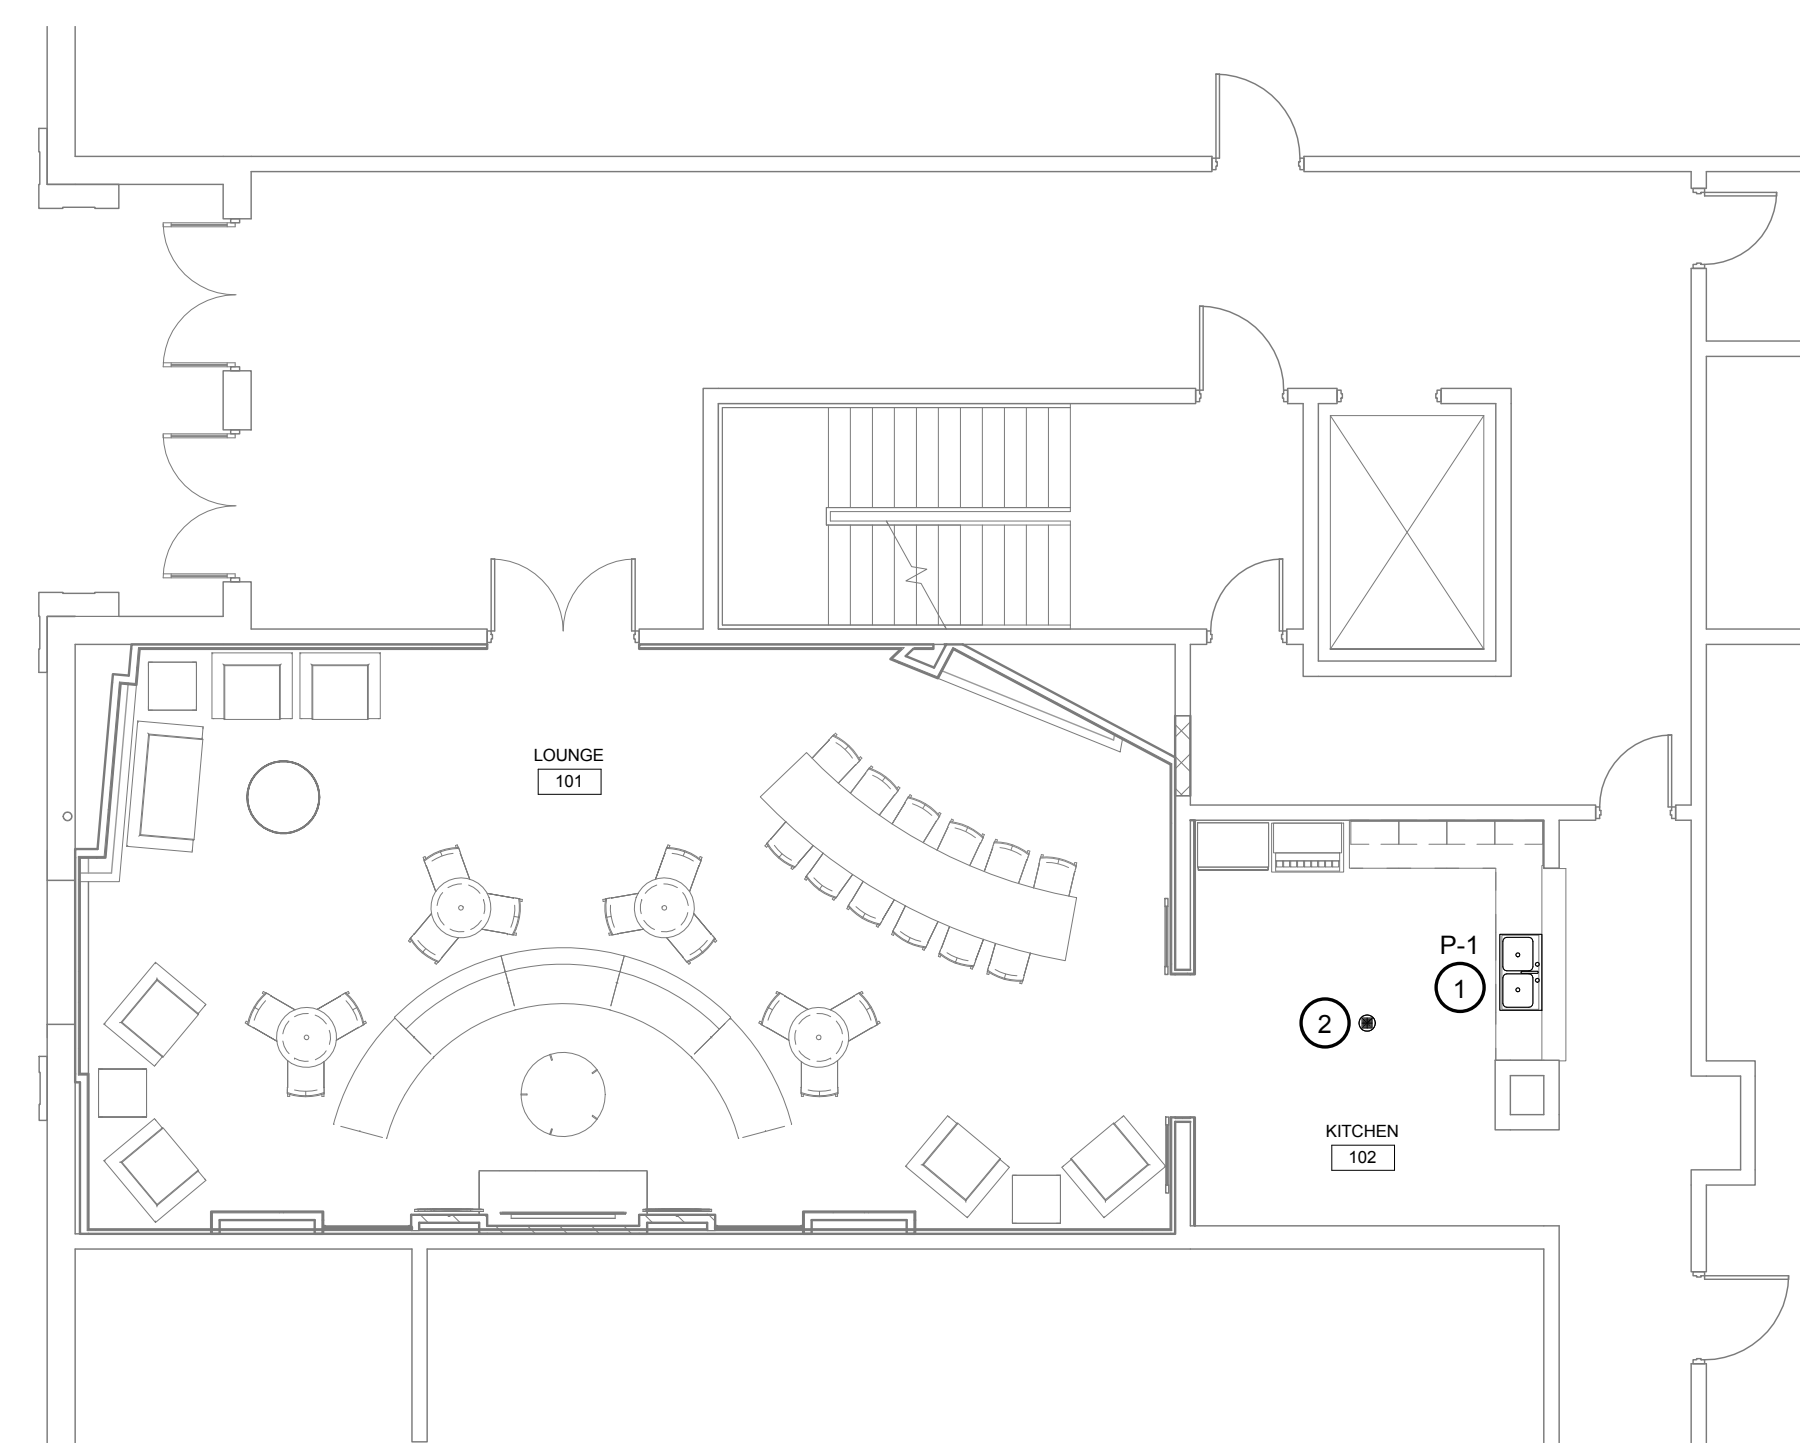
PROJECT NO. U42516
DATE 08/02/16
DRAWING NO. **M2.1**



1 PLUMBING FLOOR PLAN - ENTRY LEVEL
P1.1 1" = 40'-0"

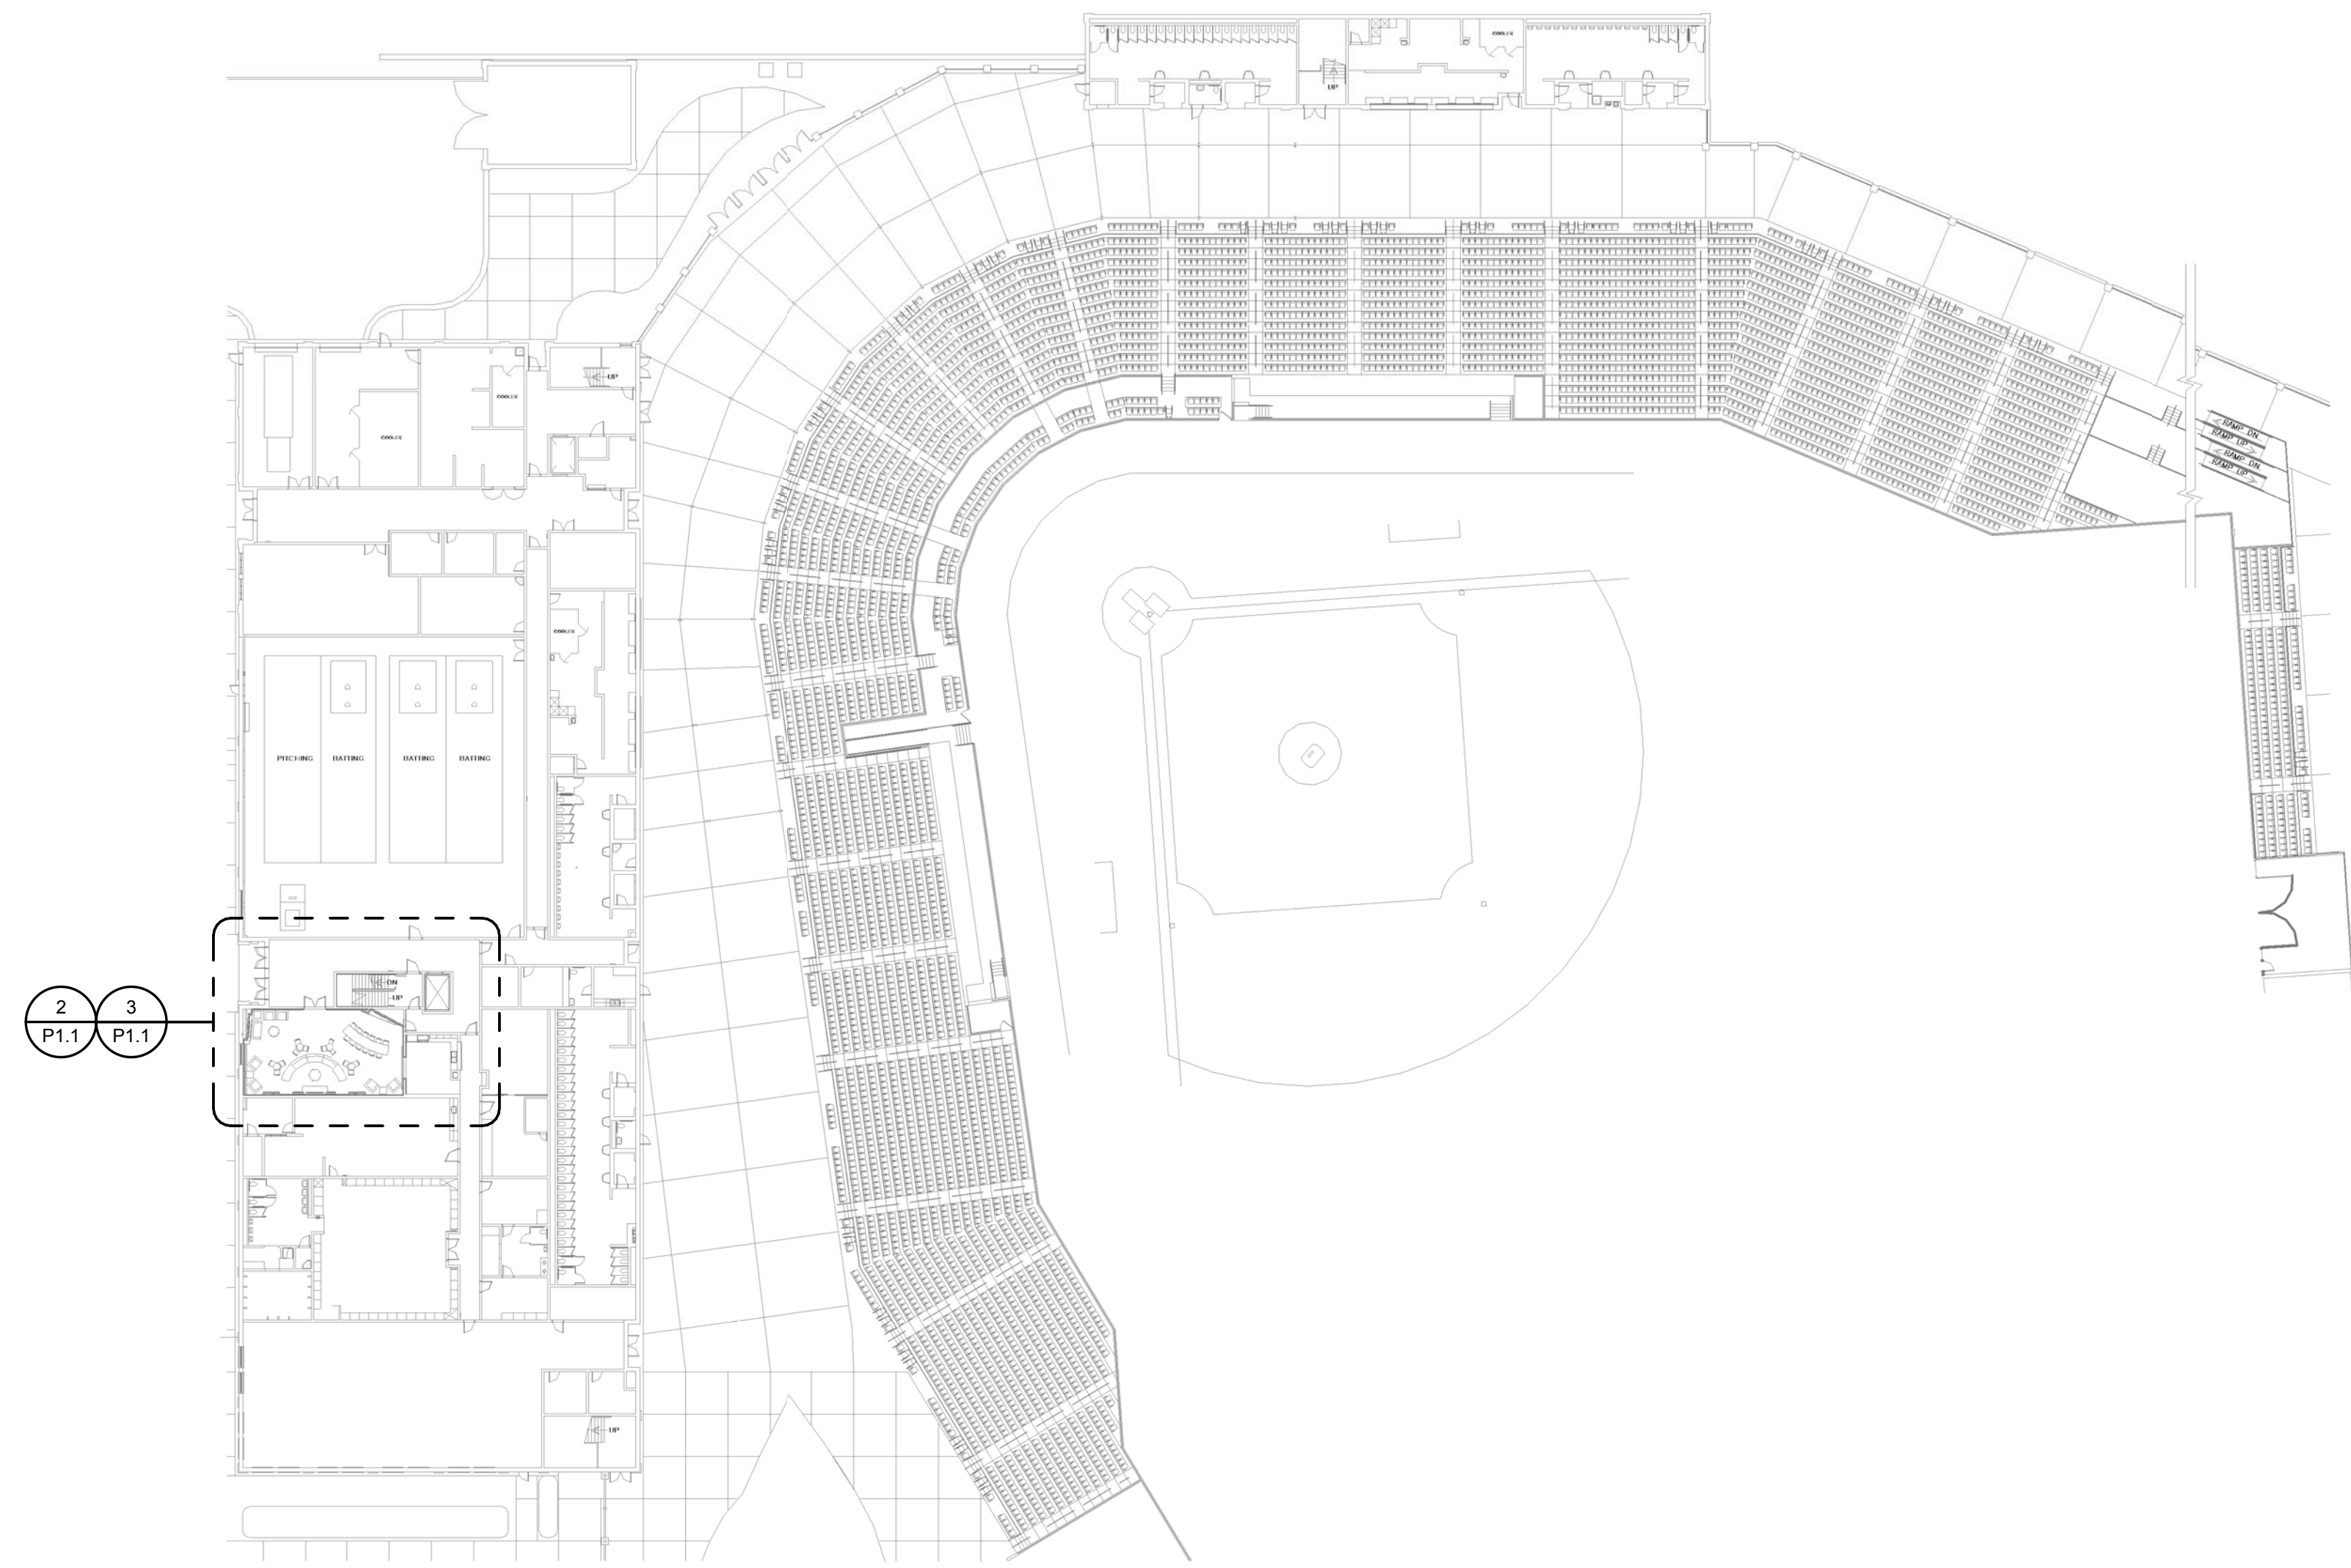

2 PLUMBING DEMOLITION PLAN - PLAYERS LOUNGE
P1.1 1/8" = 1'-0"

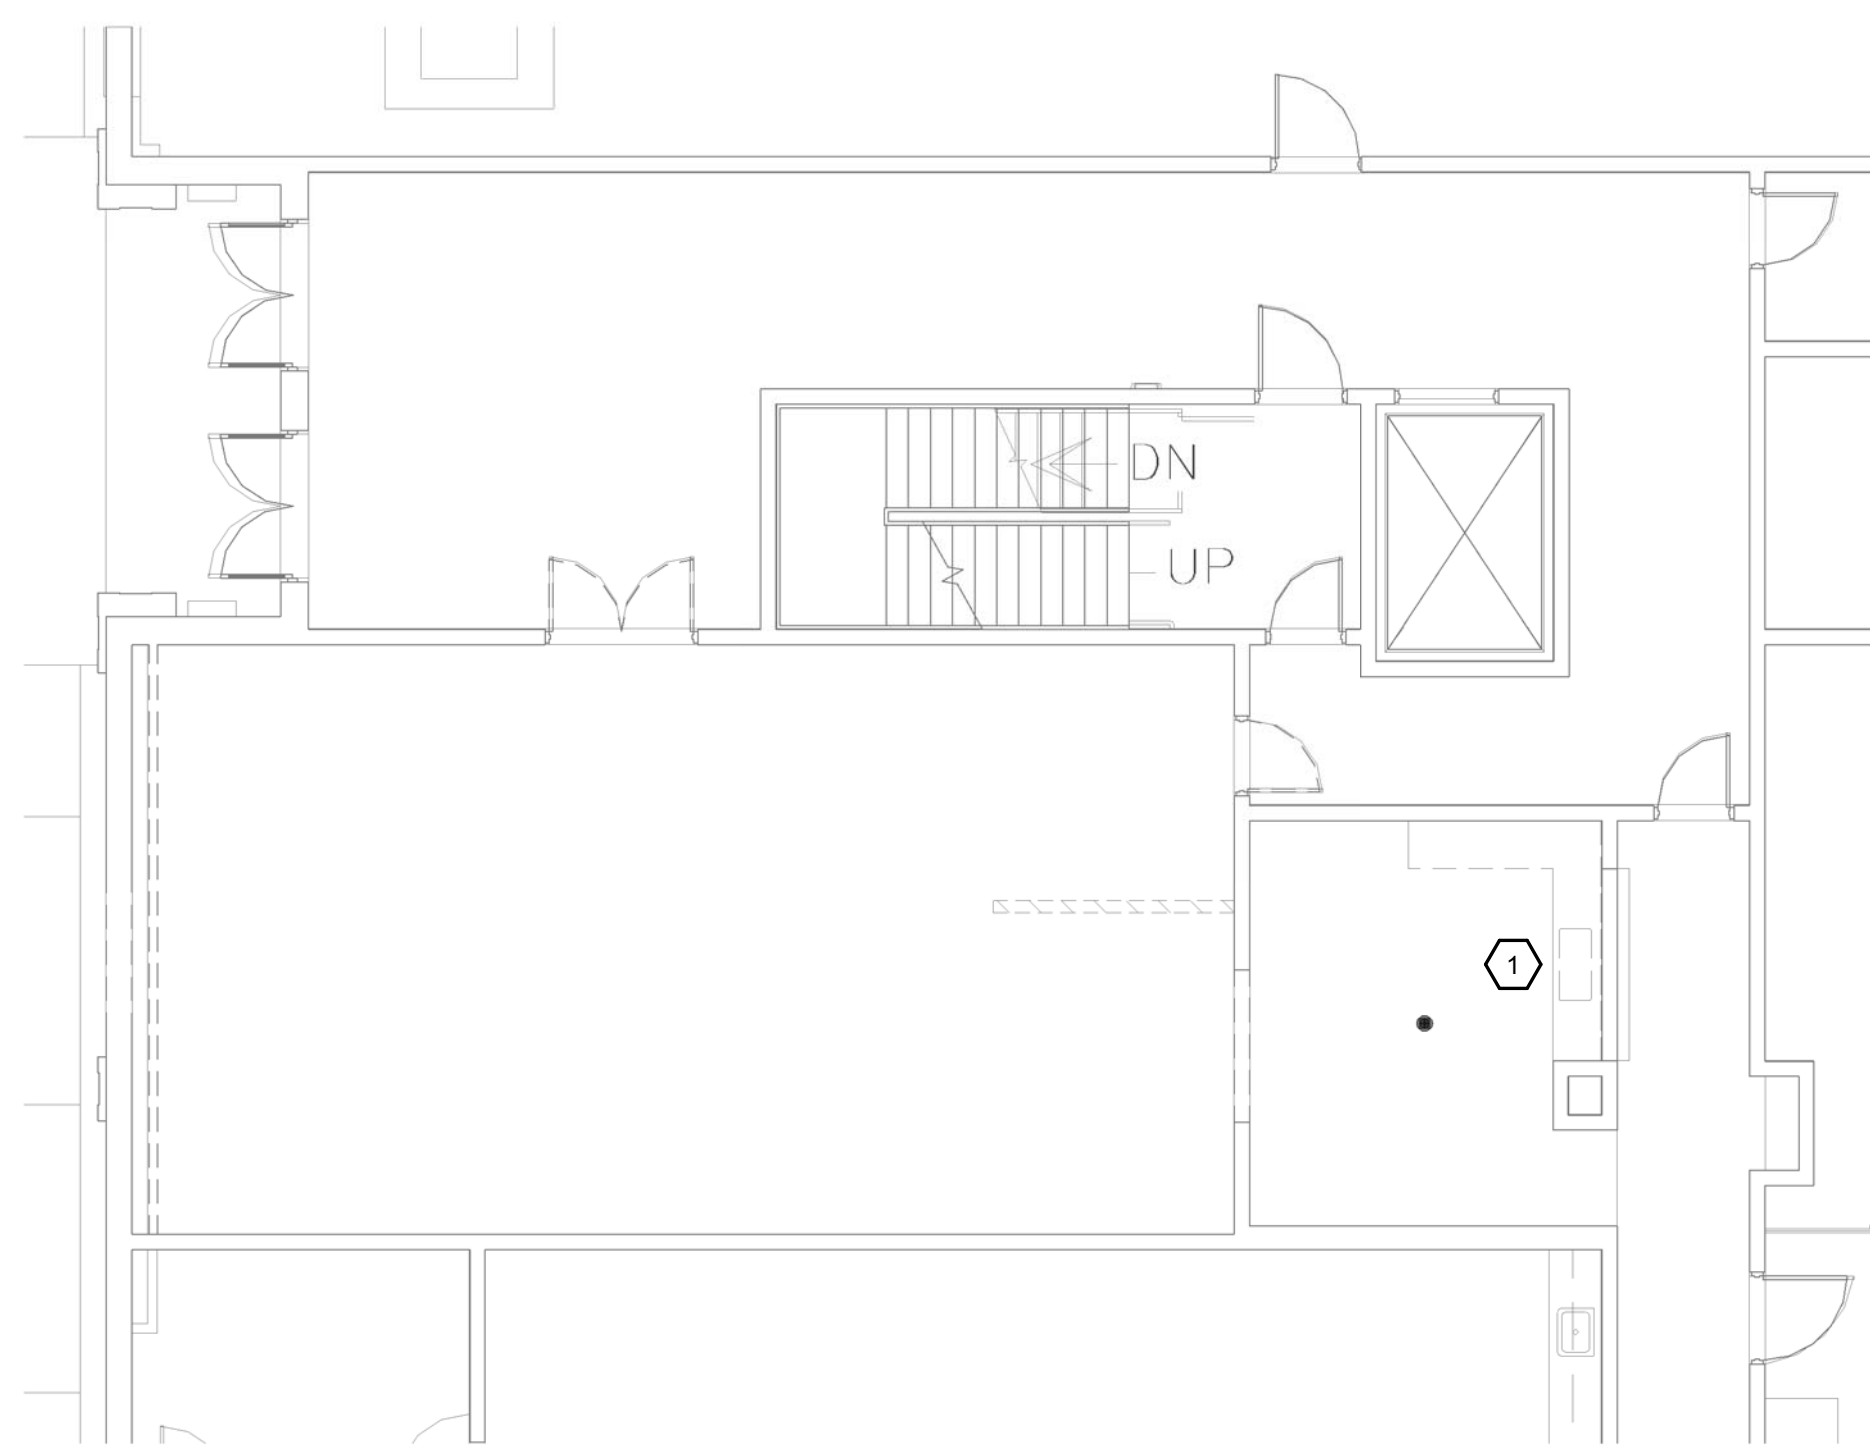



3 ENLARGED PLUMBING PLAN - PLAYERS LOUNGE
P1.1 1/8" = 1'-0"

DEMOLITION NOTES

- 1 EXISTING DOUBLE COMPARTMENT SINK, FAUCET, ETC. TO BE REMOVED COMPLETELY. EXISTING WASTE, VENT, AND SUPPLY PIPING TO BE REUSED FOR NEW SINK IN SAME LOCATION AS SHOWN ON RENOVATION PLANS. EXISTING GARBAGE DISPOSER TO BE REUSED.

NOTES TO SHEET

- 1 CONNECT NEW SINK, FAUCET, P-TRAP, AND SUPPLIES TO EXISTING WASTE, VENT AND SUPPLY PIPING THAT SERVED REMOVED SINK. REINSTALL EXISTING GARBAGE DISPOSER.
- 2 EXISTING FLOOR DRAIN SHALL BE REMOVED AND REINSTALLED WITH NEW FLOORING. RAISE FLOOR DRAIN UP TO BE LEVEL WITH FLOOR. INSTALL TRAP GUARD BY PROSET, OR EQUAL, IN FLOOR DRAIN.

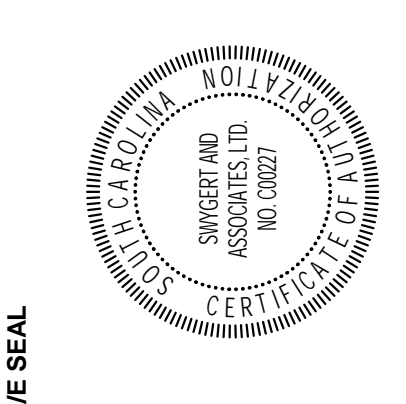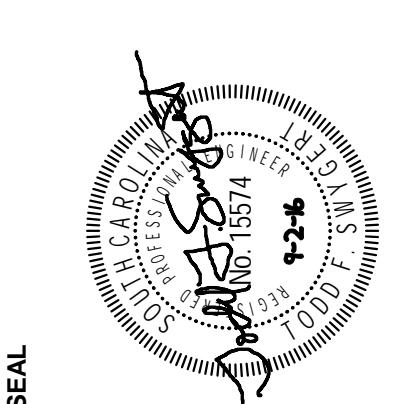

PROJECT TITLE
**FOUNDERS PARK PLAYER'S LOUNGE
 RENOVATION AND MEDIA ROOM
 ADDITION**
 431 WILLIAMS STREET
 COLUMBIA, SC 29201

NO.	REVISIONS NAME	DATE


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DRAWING TITLE
**ENTRY LEVEL FLOOR PLAN,
 DEMOLITION PLAN, ENLARGED
 PLAYERS LOUNGE PLANS**


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 DRAWING NO.
P1.1


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1 PLUMBING FLOOR PLAN - CLUB LEVEL
P1.2 1" = 30'-0"



2 ENLARGED PLUMBING PLAN - MEDIA ROOM
P1.2 1/8" = 1'-0"

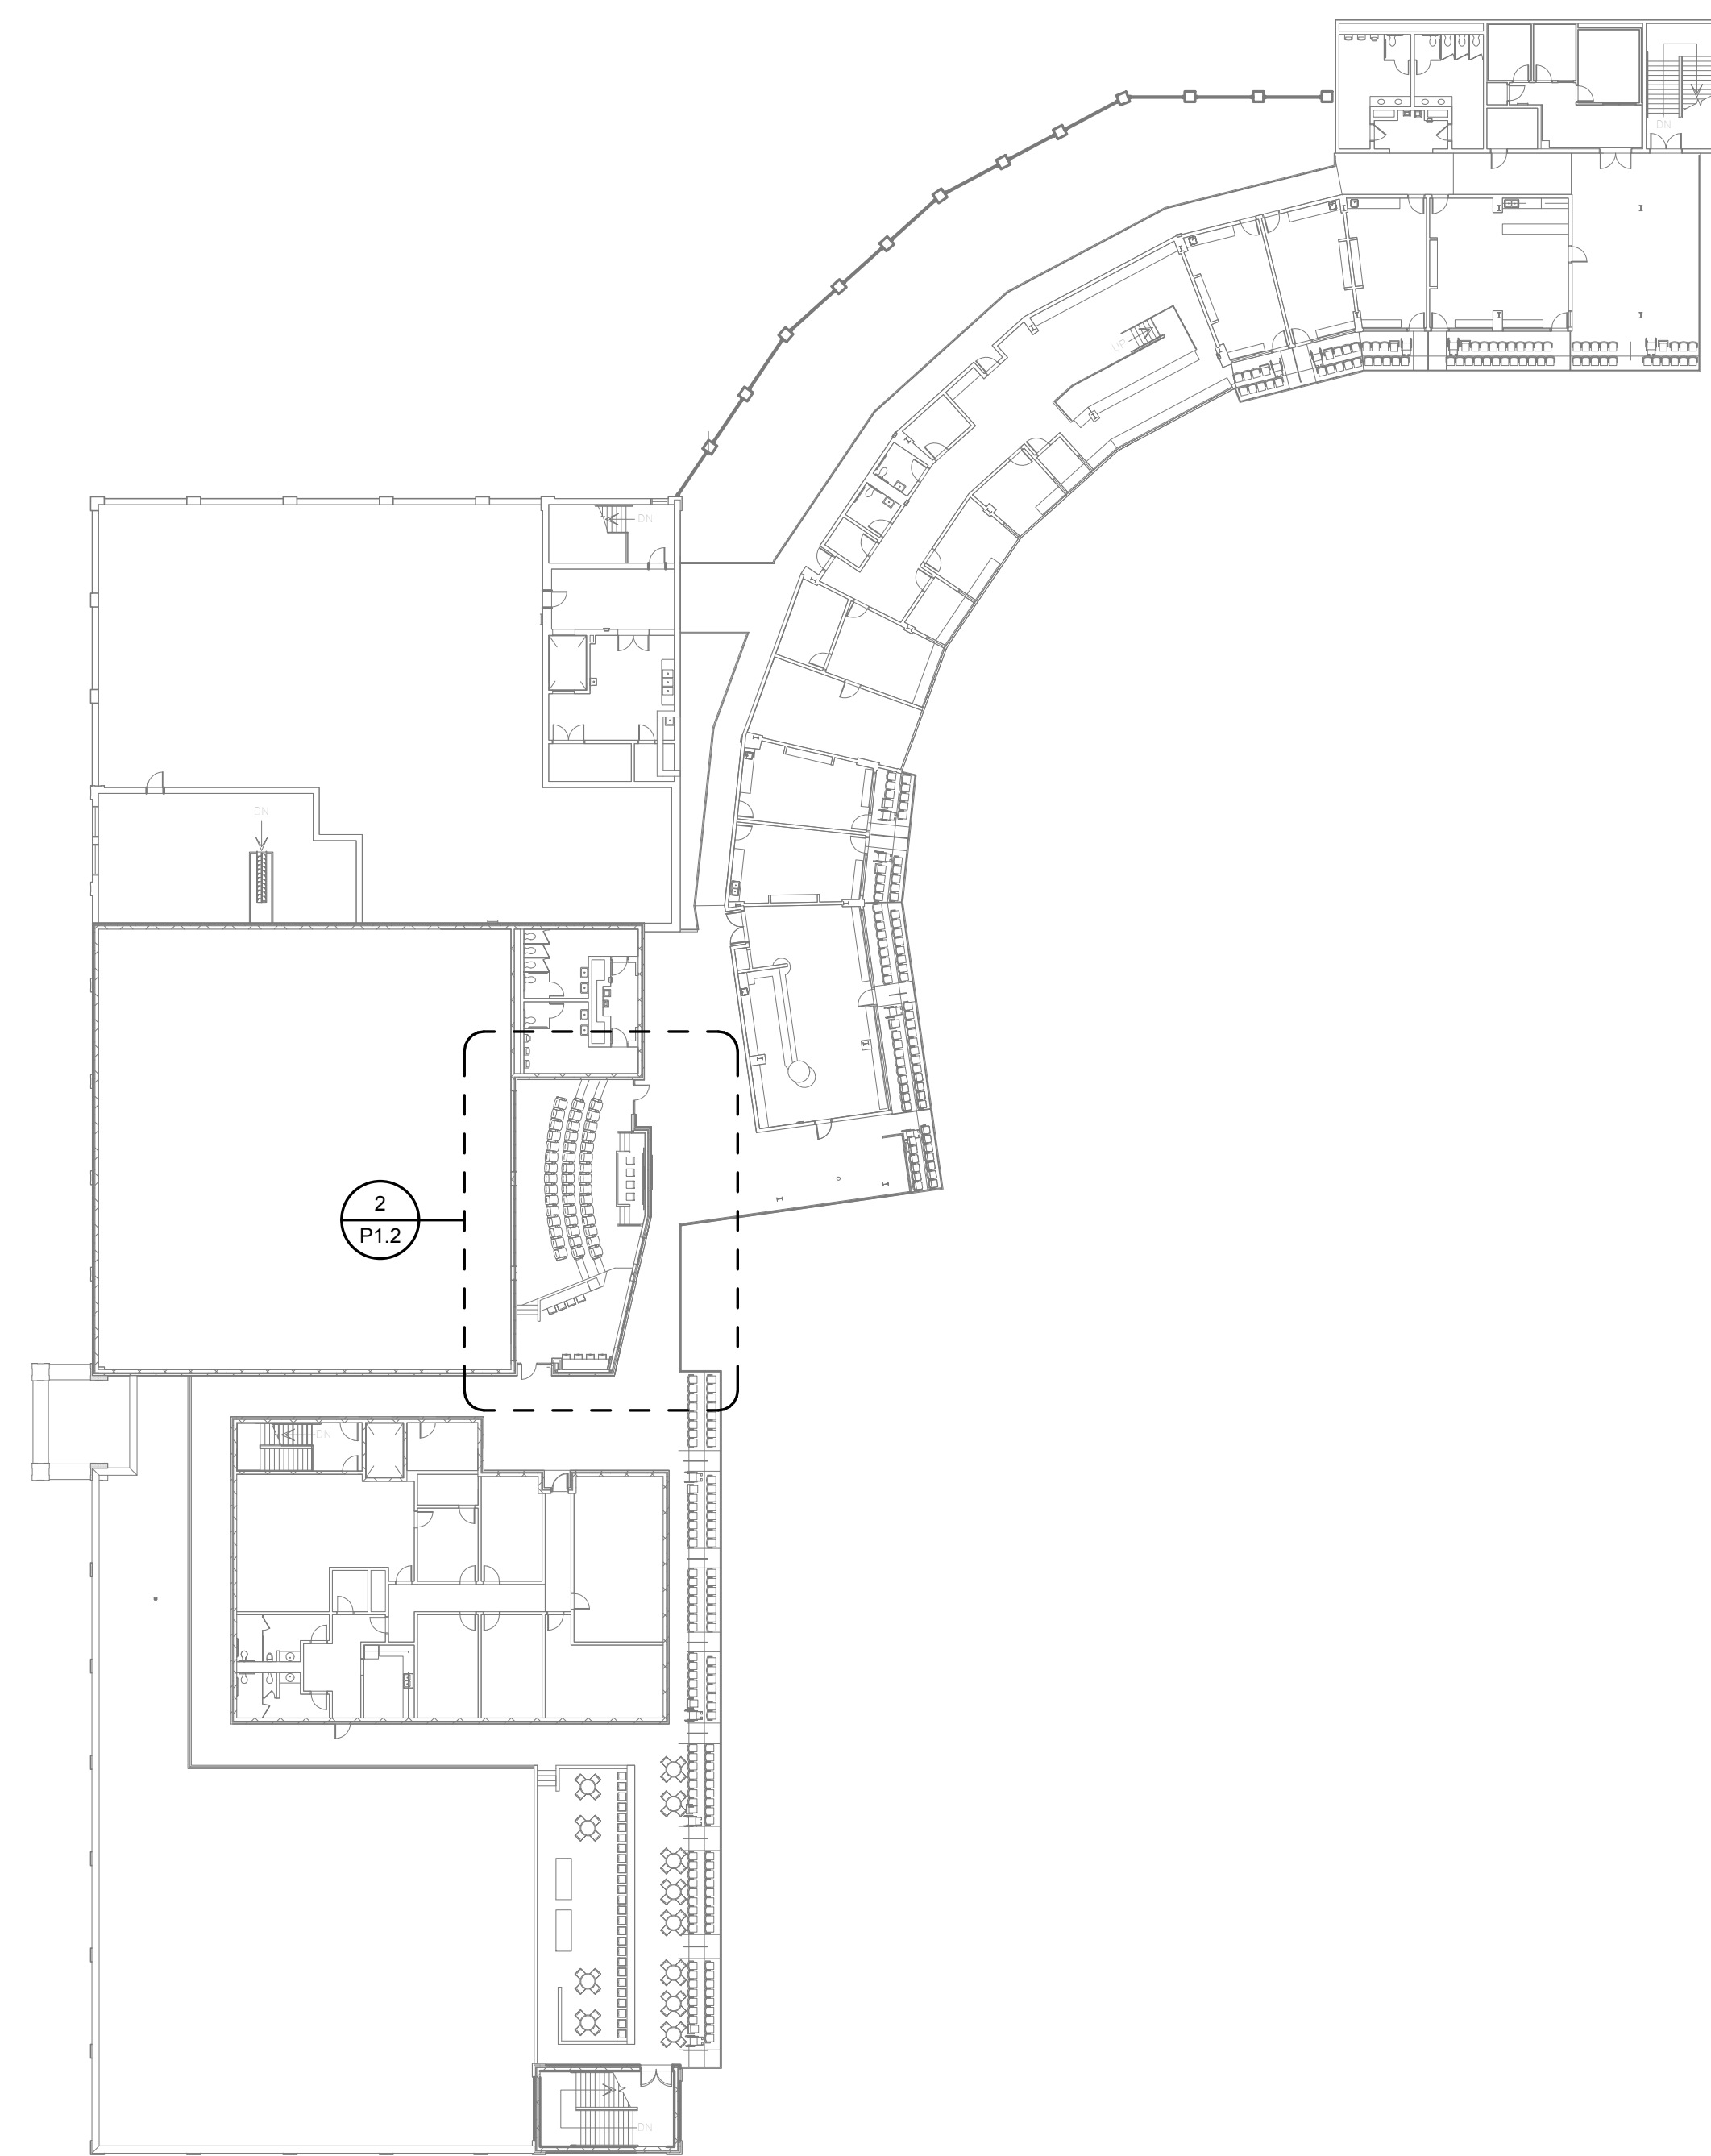

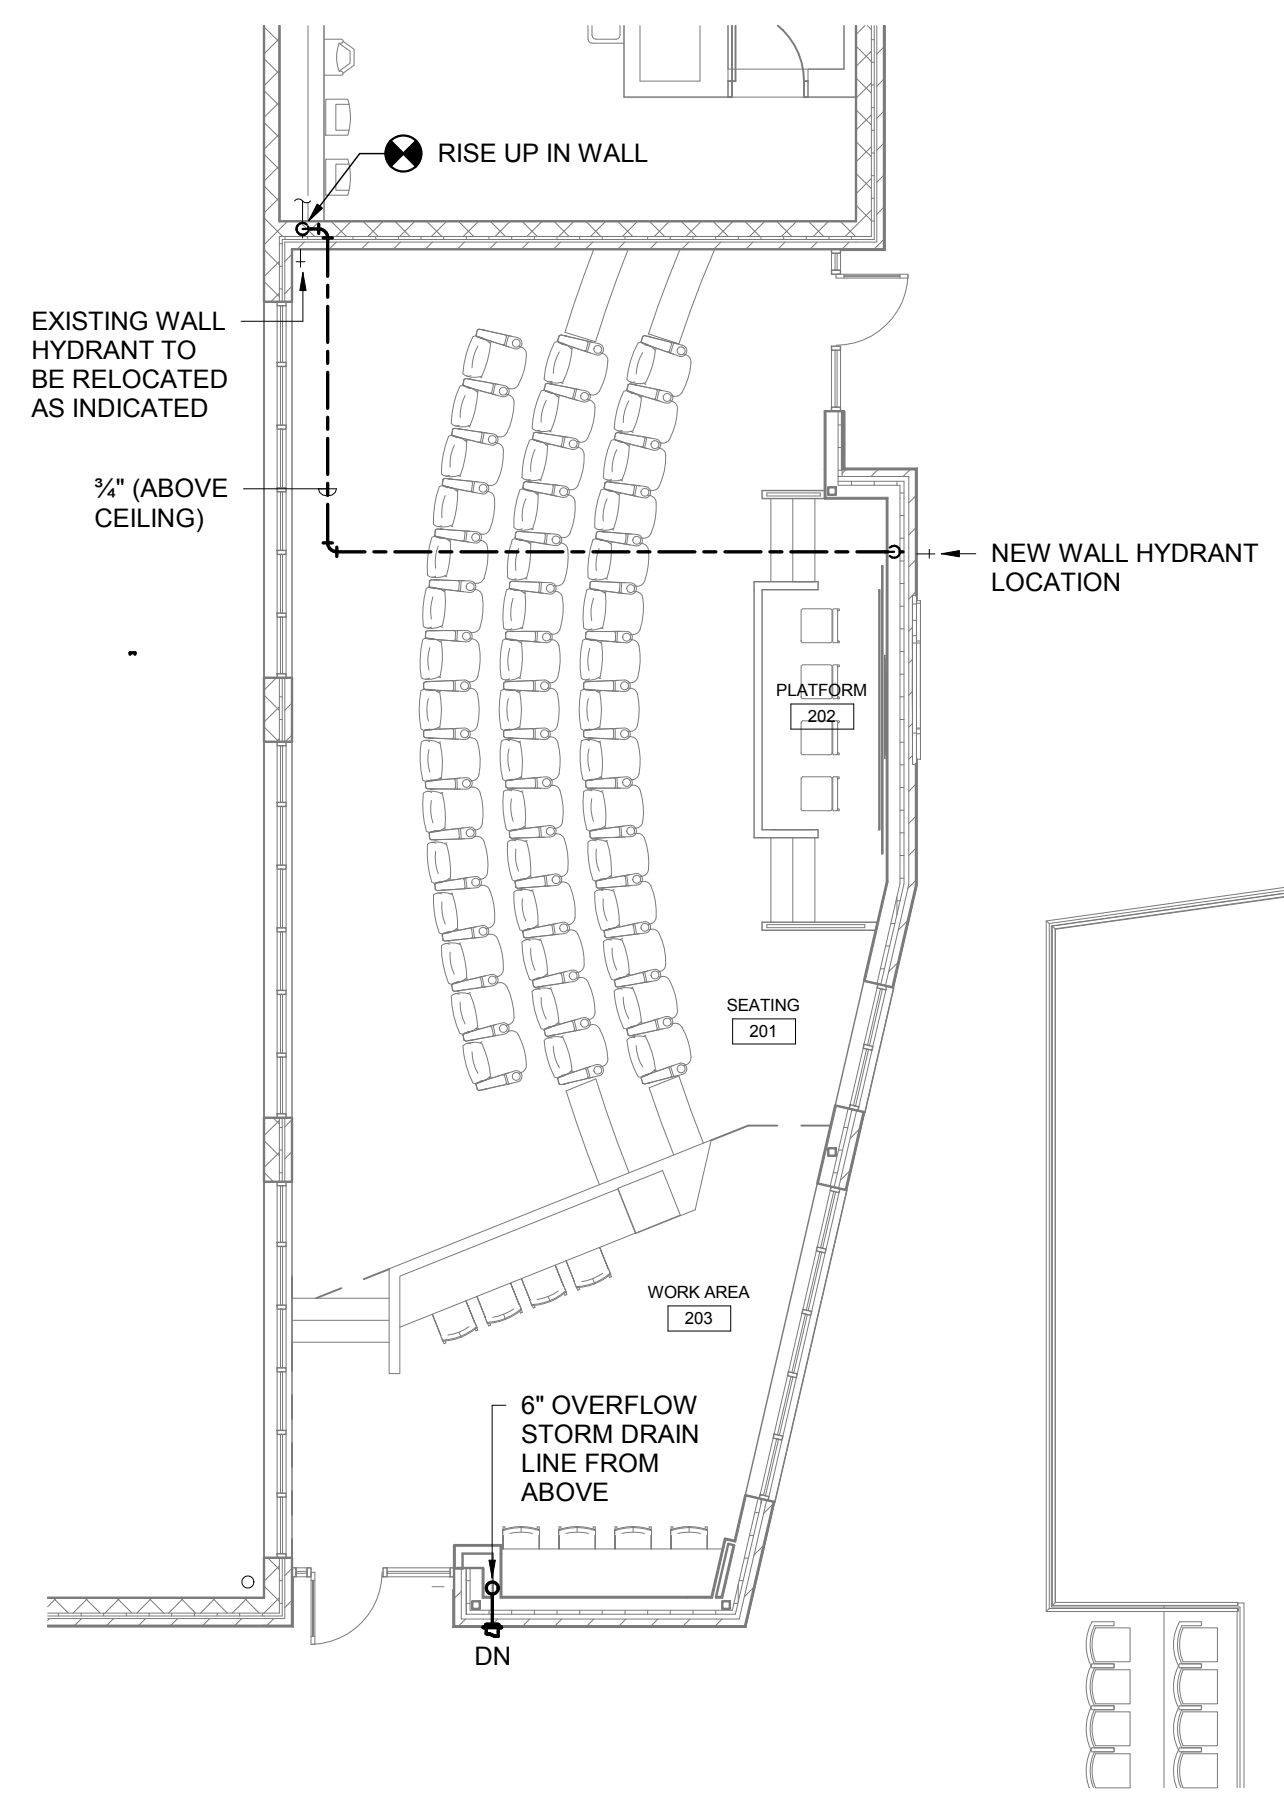3 MEDIA ROOM ROOF PLAN
P1.2 1/8" = 1'-0"


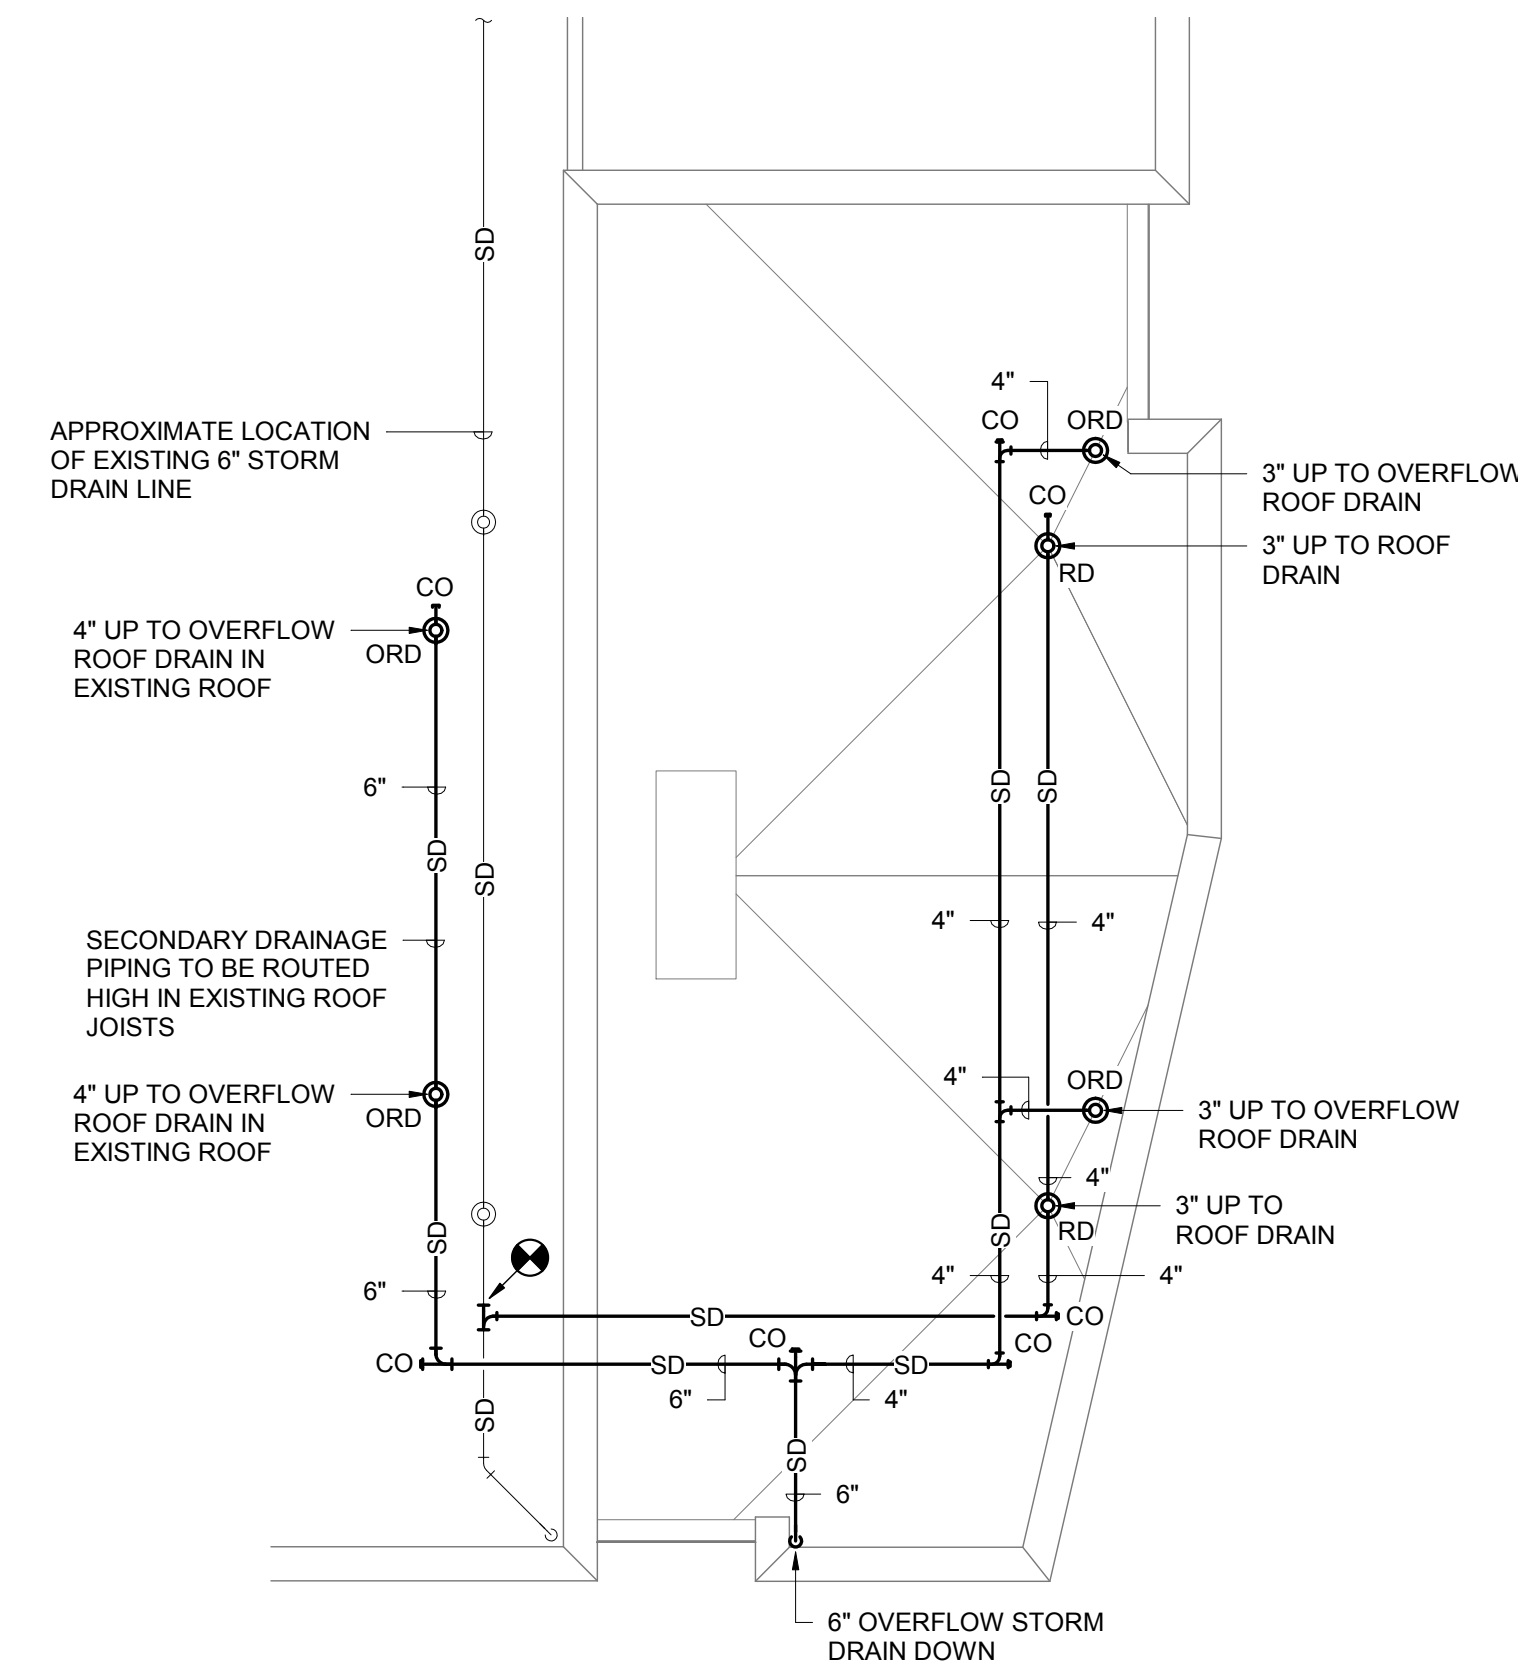
PLUMBING FIXTURE SCHEDULE								
P. NO.	FIXTURE	MFR.	NAME	MFRS. NO.	SIZE	MIN. SUPPLY		REMARKS
						CW	HW	
P-1	SINK	ELKAY	LUSTERTONE	LRAD-3321-65	33"x21 1/4"	1/2"	1/2"	WITH DELTA MODEL 400L-HDF FAUCET WITH SPRAY HOSE, LKPP1 STRAINERS, CONTINUOUS WASTE, MCGUIRE H2187 1/2" CAST BRASS SUPPLIES WITH STOPS, AND MCGUIRE 8912 1-1/2" P-TRAP.
RD	ROOF DRAIN	ZURN	---	Z-121-C	---	--	--	WITH 12" DIAMETER CAST IRON DOME AND UNDERDECK CLAMP.
ORD	OVERFLOW ROOF DRAIN	ZURN	---	Z-121-89-C	---	--	--	WITH 12" DIAMETER CAST IRON DOME, 2" HIGH WATER DAM, AND UNDERDECK CLAMP.
DN	DOWNSPOUT NOZZLE	ZURN	---	ZARB-199	---	--	--	WITH PLAIN BRONZE BODY MOUNTED SO THAT BOTTOM OF NOZZLE IS APPROXIMATELY 8" ABOVE FINISHED SLAB.

GENERAL NOTES

- ALL WORK SHALL BE PERFORMED ACCORDING TO ALL LOCAL, STATE, NATIONAL CODES, AND THE 2015 INTERNATIONAL PLUMBING CODE.
- DO NOT SCALE DRAWINGS. SEE ARCHITECTURAL DRAWINGS FOR EXACT DIMENSIONS, FIXTURE LOCATIONS, ETC.
- EXCEPT WHERE PIPE SPACE IS PROVIDED OR UNLESS NOTED OTHERWISE, ALL SUPPLY, WASTE AND VENT RISERS SHALL BE RUN IN WALLS AND PARTITIONS.
- COORDINATE CLOSELY WITH ALL WORK DONE UNDER OTHER DIVISIONS OF THE SPECIFICATIONS TO AVOID INTERFERENCE AND CONFLICT.
- ALL PIPING INSULATION SHALL BE RUN CONTINUOUSLY.
- STORM DRAINAGE PIPING SHALL PITCH A MINIMUM OF 1/8-INCH PER FOOT.
- THIS CONTRACTOR SHALL MAKE ALL CONNECTIONS TO ROOF DRAINS AND OVERFLOW ROOF DRAINS INSTALLED BY GENERAL CONTRACTOR. PLUMBING CONTRACTOR SHALL FURNISH ROOF DRAINS AND OVERFLOW ROOF DRAINS TO GENERAL CONTRACTOR FOR INSTALLATION BY OTHERS.
- EXISTING INFORMATION TAKEN FROM OWNERS RECORD SET OF DRAWINGS DATED JUNE 2009.

LEGEND

SYMBOL	DESCRIPTION
	DOMESTIC COLD WATER LINE
	STORM DRAIN LINE
	PIPE TURNS TO, AWAY
	CLEANOUT (ABOVE CEILING OF FLOOR BELOW)
	CONNECTION POINT OF NEW TO EXISTING

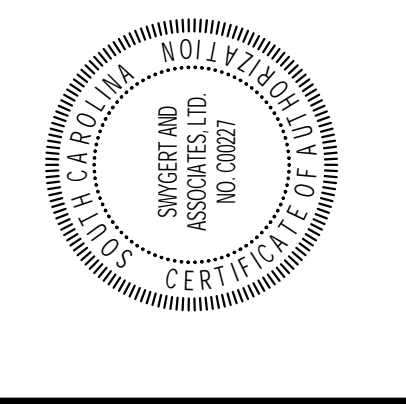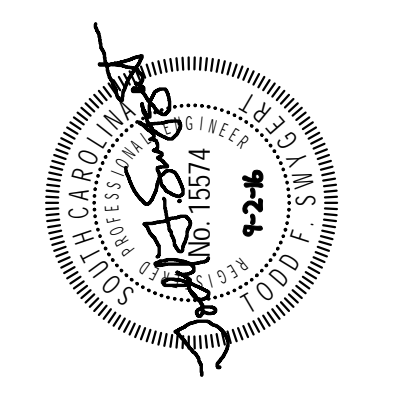

PROJECT TITLE
**FOUNDERS PARK PLAYER'S LOUNGE
 RENOVATION AND MEDIA ROOM
 ADDITION**
 431 WILLIAMS STREET
 COLUMBIA, SC 29201


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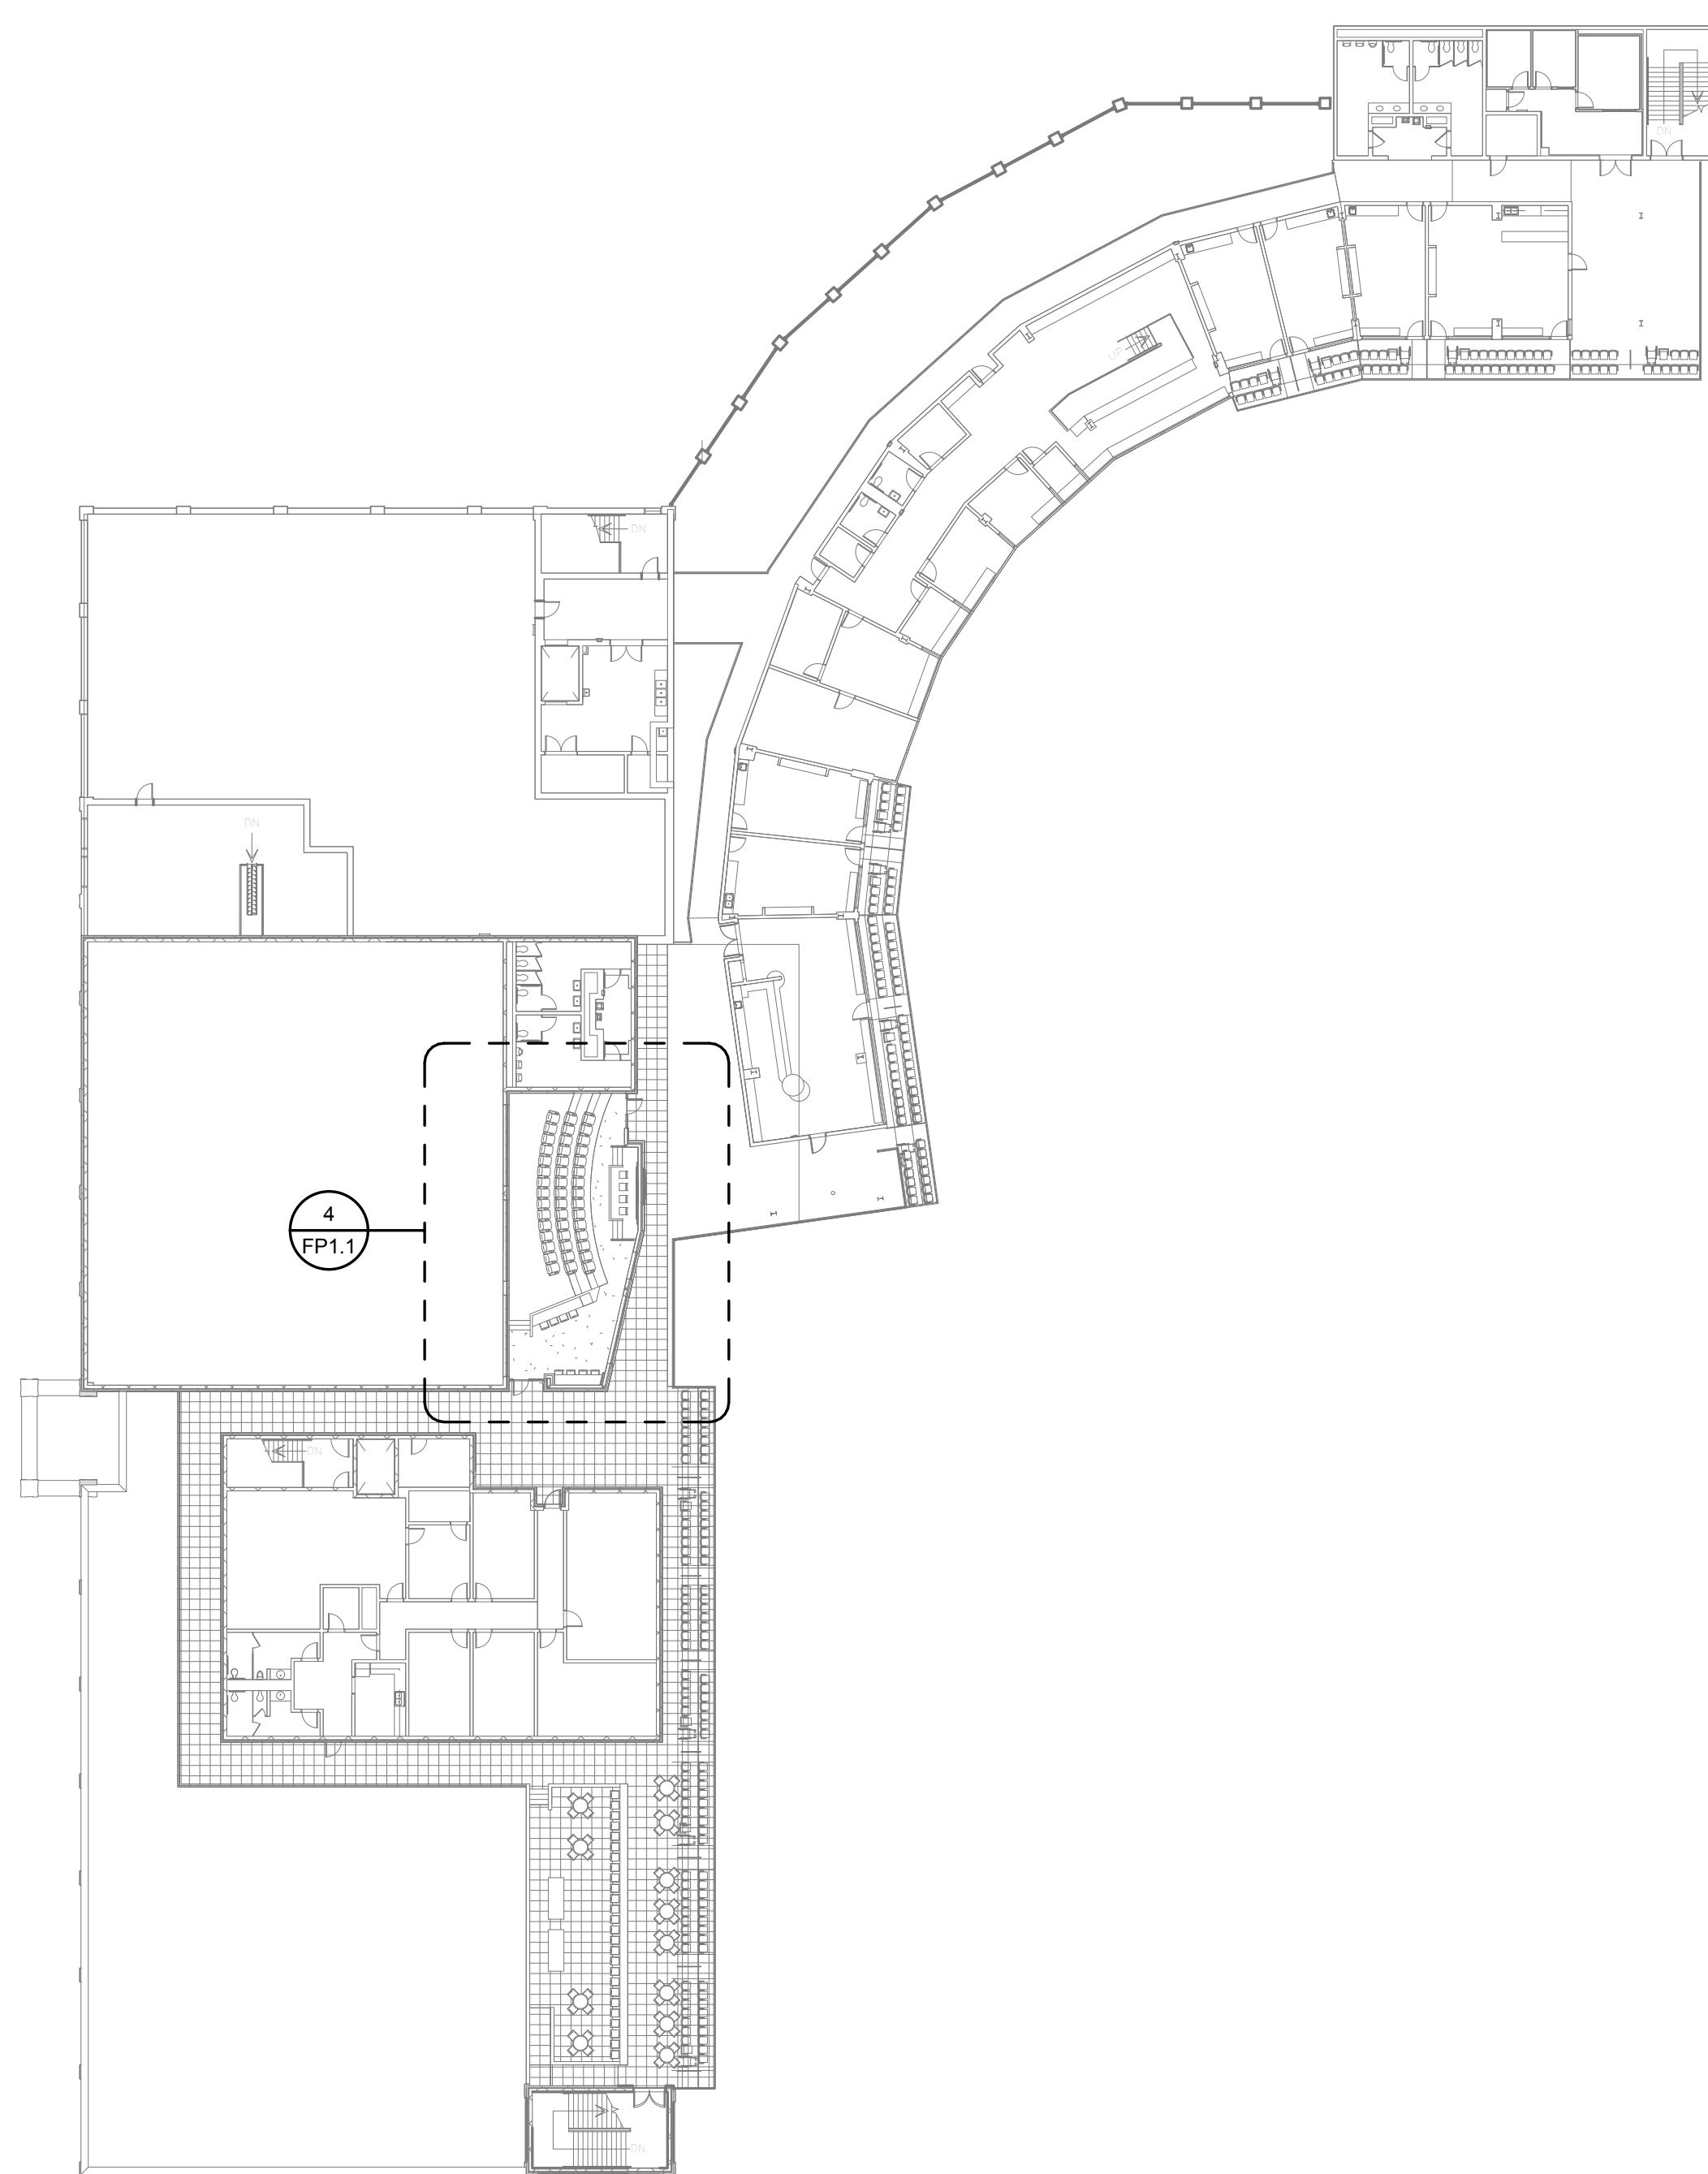
DRAWING TITLE
**CLUB LEVEL FLOOR PLAN,
 ENLARGED MEDIA ROOM PLAN,
 ROOF PLAN, GENERAL NOTES,
 SCHEDULE, AND LEGEND**

PROJECT NO.: U42516
 DATE: 08/02/16
 DRAWING NO.: **P1.2**


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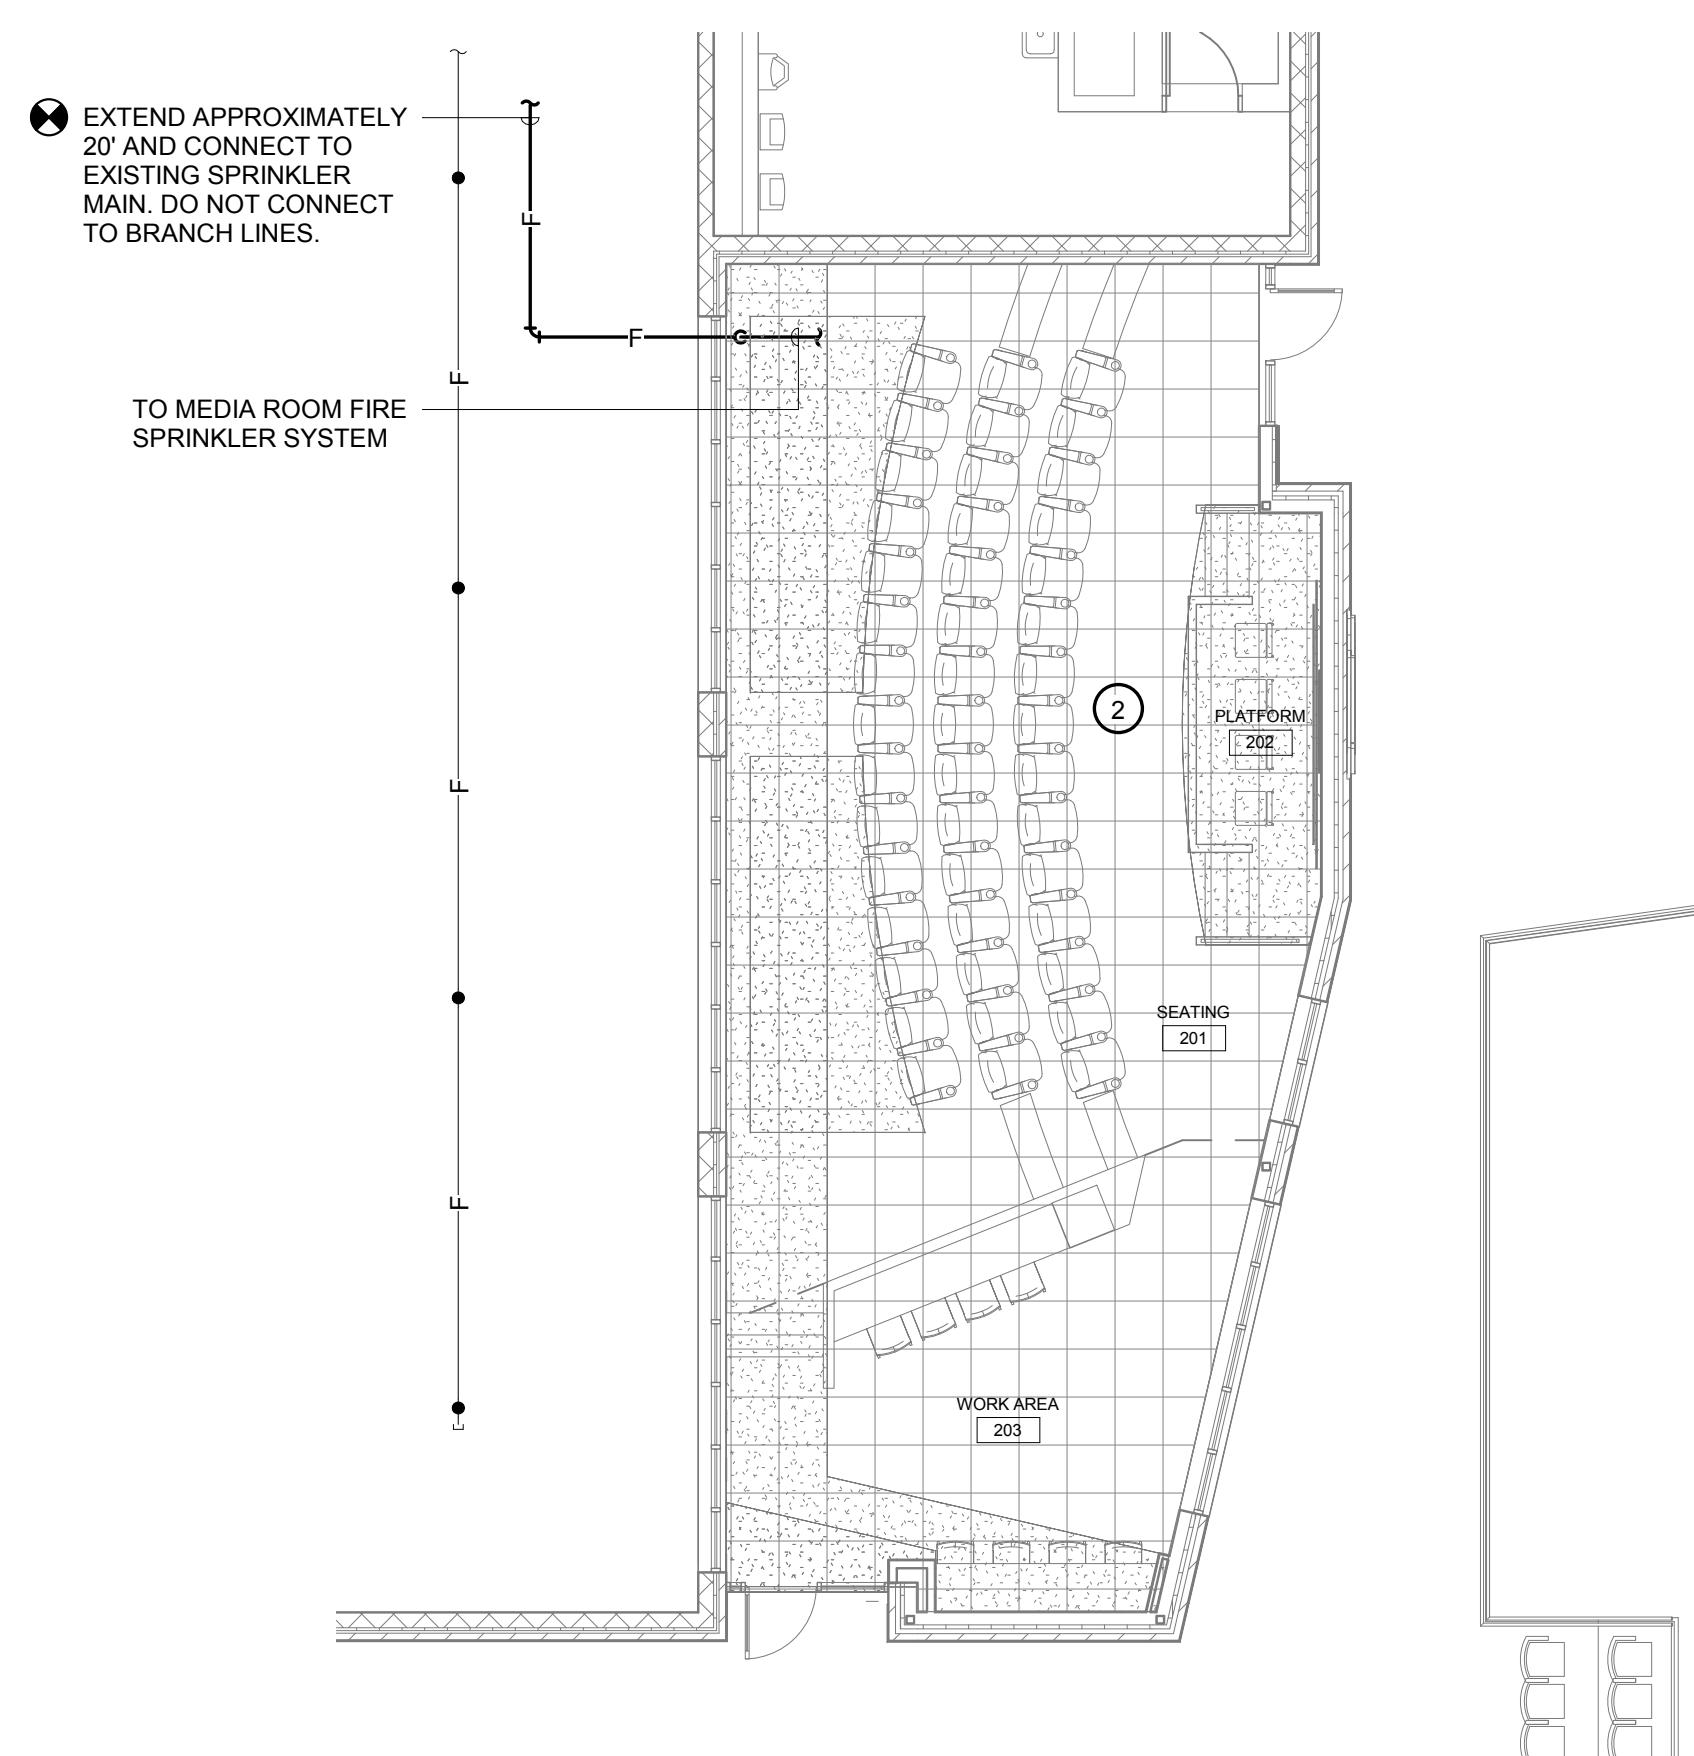
1 FIRE PROTECTION FLOOR PLAN - ENTRY LEVEL
FP1.1 1" = 40'-0"



3 FIRE PROTECTION FLOOR PLAN - CLUB LEVEL
FP1.1 1" = 30'-0"

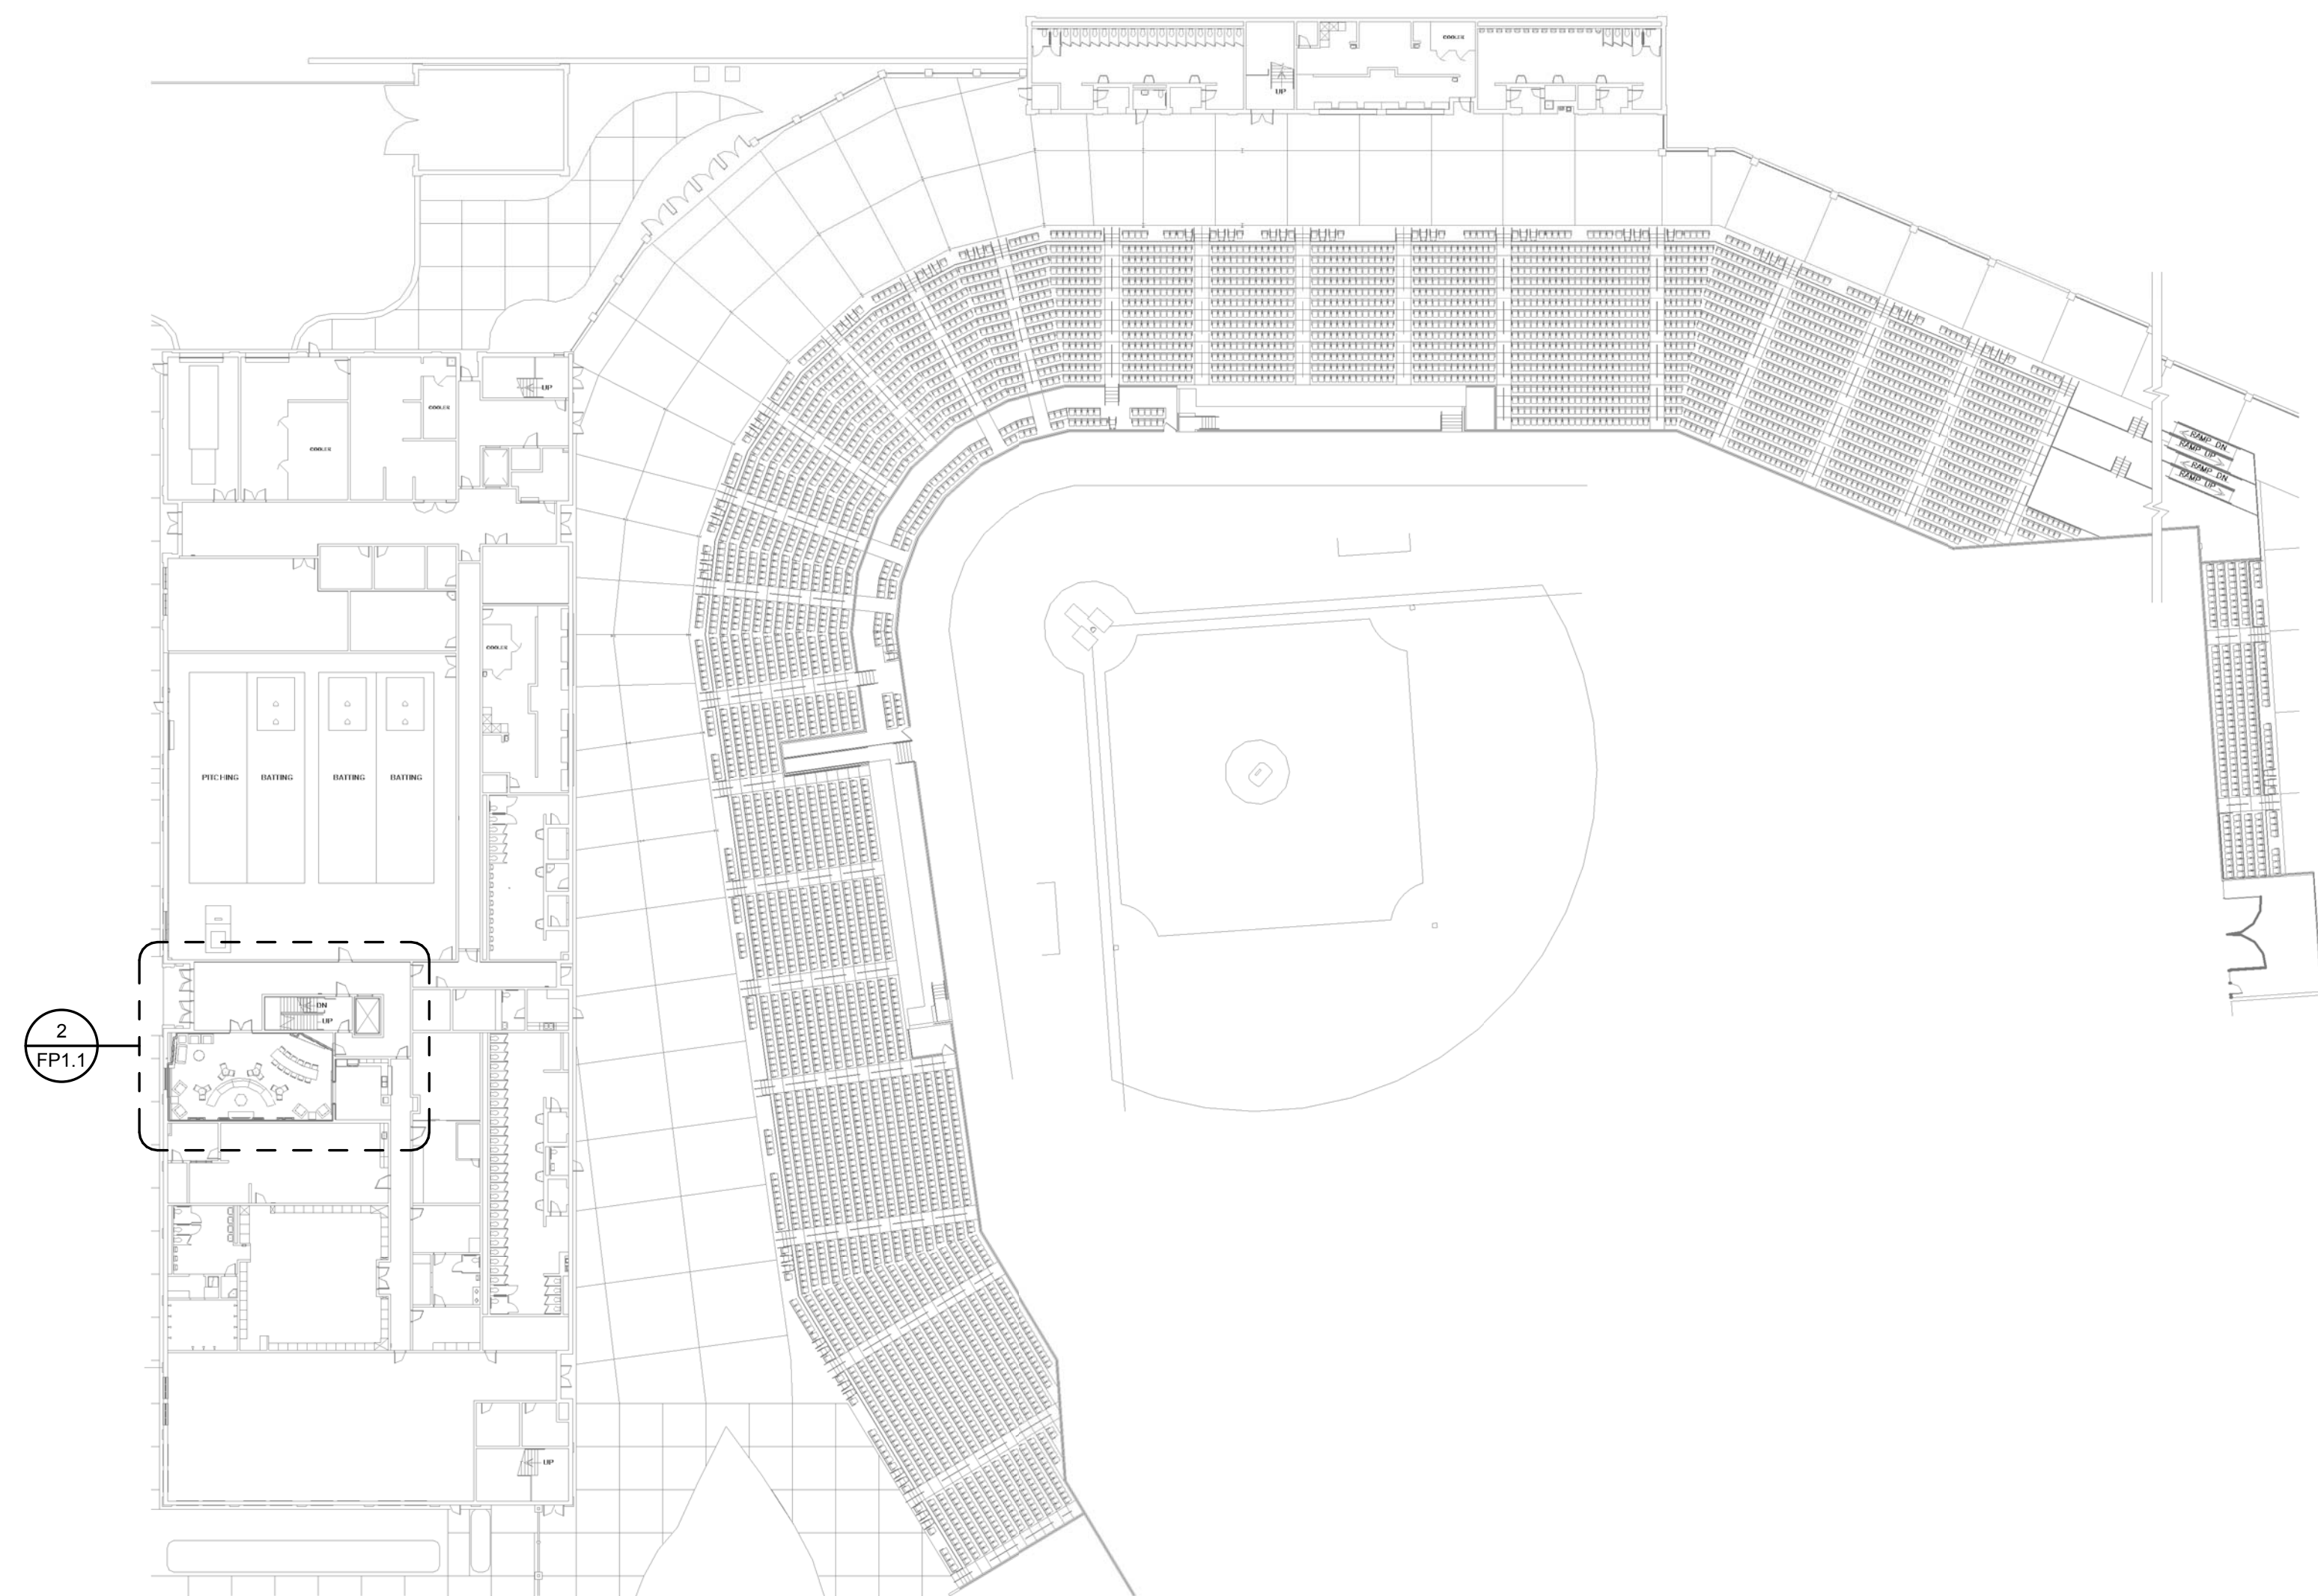

2 ENLARGED FIRE PROTECTION PLAN - PLAYERS LOUNGE
FP1.1 1/8" = 1'-0"

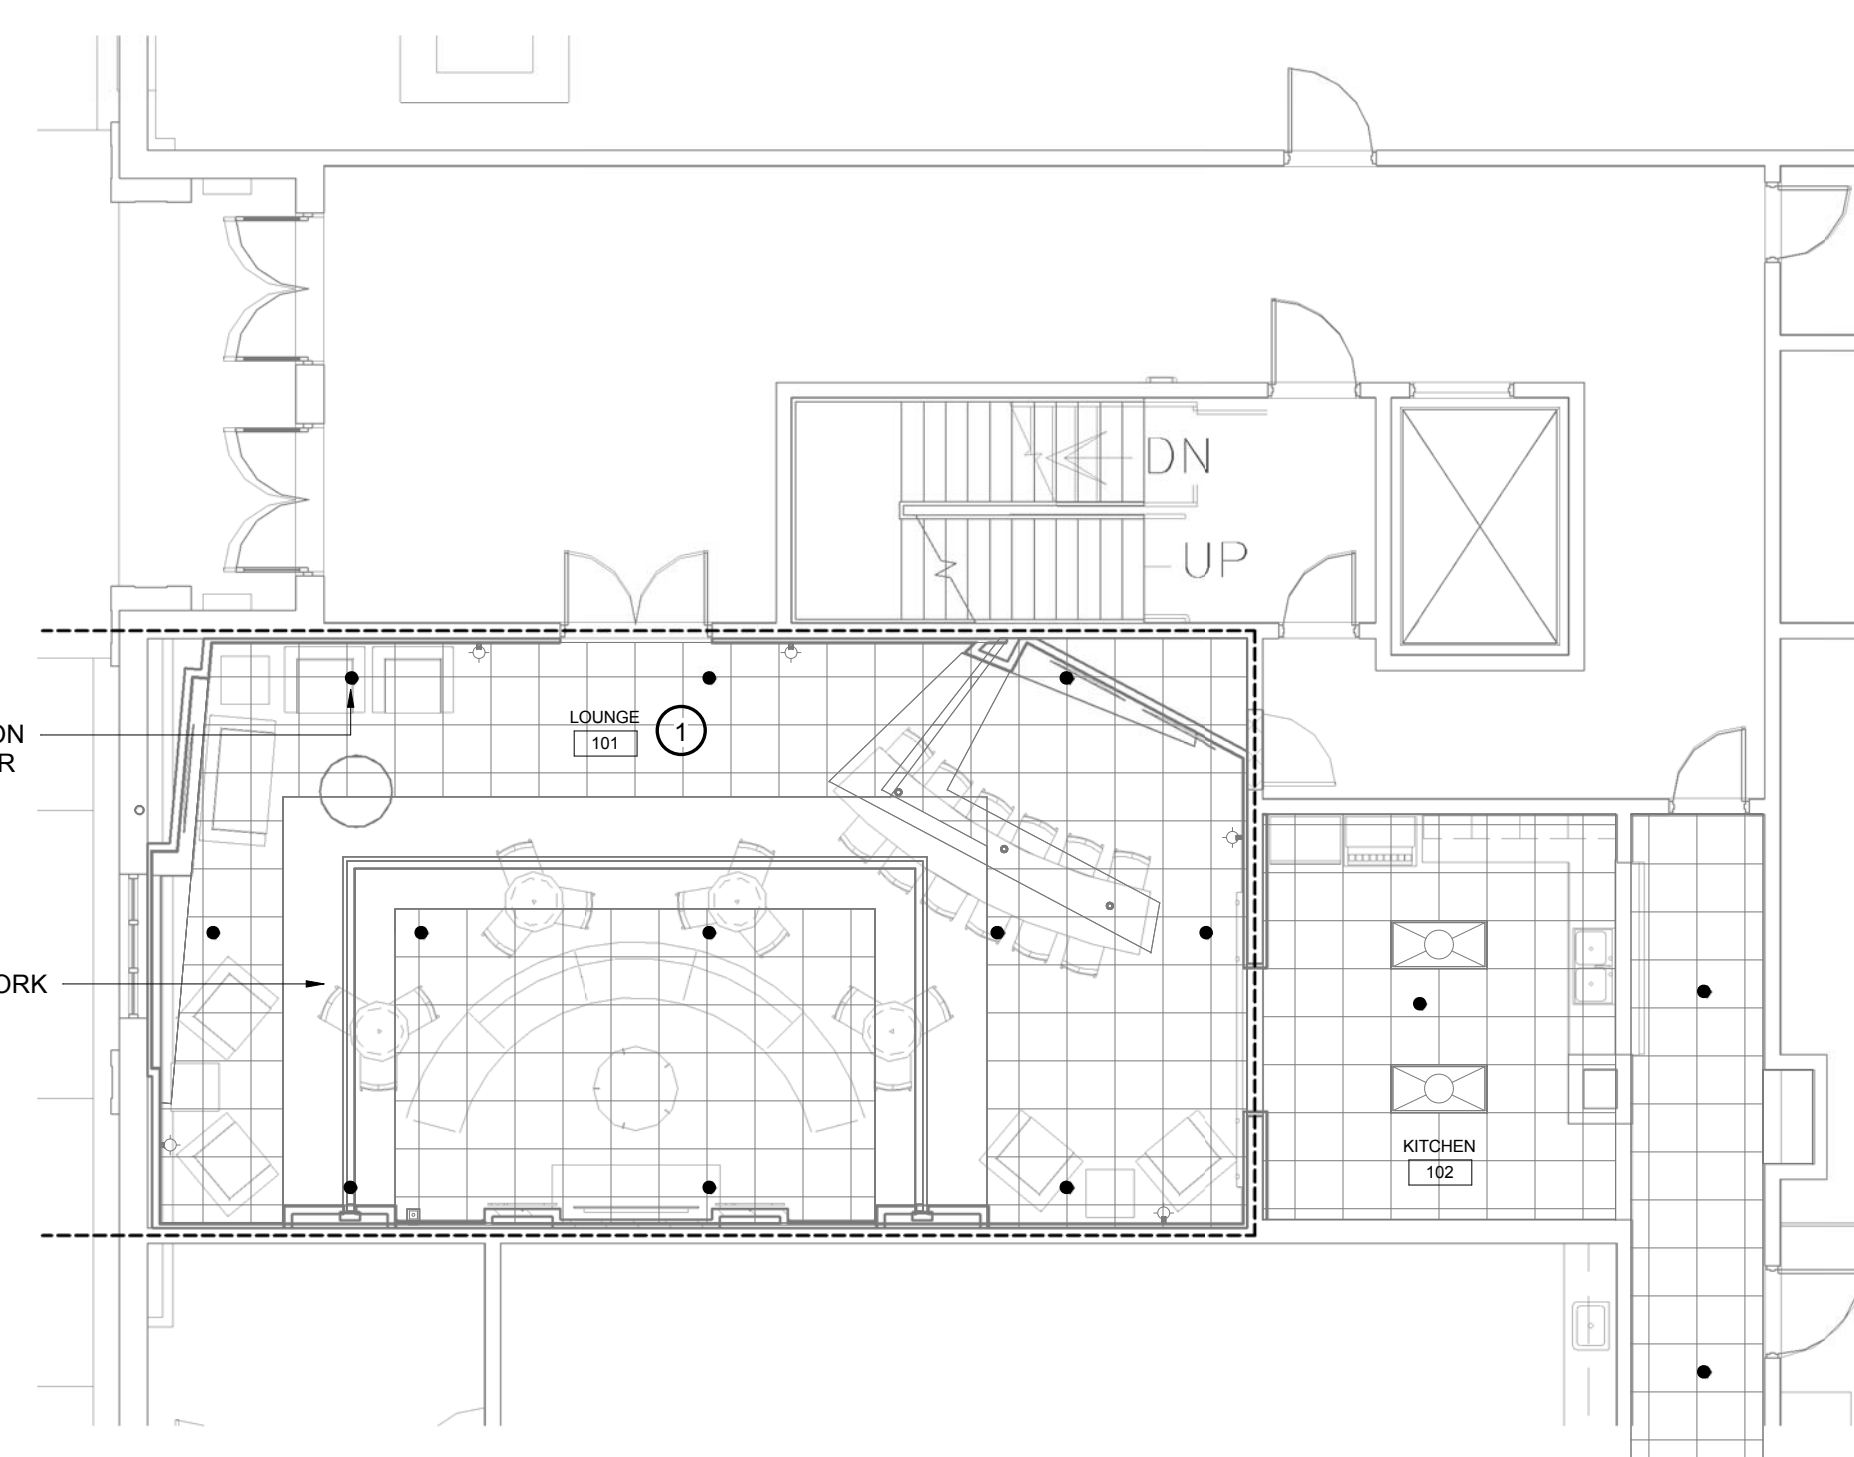


4 ENLARGED FIRE PROTECTION PLAN - MEDIA ROOM
FP1.1 1/8" = 1'-0"

NOTES TO SHEET

- 1 FIRE SPRINKLER CONTRACTOR SHALL ADJUST EXISTING FIRE SPRINKLER SYSTEM TO ACCOMMODATE NEW CEILING HEIGHTS, WALLS, ETC. FOR A FULLY COMPLIANT SYSTEM PER NFPA 13 - 2013 EDITION AND INTERNATIONAL FIRE CODES, 2015 EDITION. WHERE THE PRESENCE OF CEILING CLOUDS RESULTS IN AN ADDITIONAL LAYER OF PROTECTION, THIS CONTRACTOR SHALL ADD HEADS AS REQUIRED. NO HEADS SHALL BE INSTALLED IN CEILING MONOGRAM. SEE ARCHITECTURAL PLANS FOR REFLECTED CEILING PLANS.
- 2 PROVIDE NEW FIRE SPRINKLER SYSTEM IN NEW MEDIA ROOM PER THE REQUIREMENTS OF NFPA 13 - 2013 EDITION AND INTERNATIONAL FIRE CODES, 2015 EDITION.

GENERAL NOTES

1. SUBMIT DRAWINGS INDICATING EXACT LOCATION OF ALL SPRINKLER HEADS FOR ARCHITECTS REVIEW AND BRING ALL FIELD CONFLICTS AND REQUIRED ADJUSTMENTS TO THE ARCHITECTS ATTENTION FOR VERIFICATION OF FINAL LOCATION OF ALL SPRINKLER HEADS.
2. SPRINKLER DRAWINGS PROVIDED ARE TO ASSIST THE CONTRACTOR. SUCCESSFUL CONTRACTOR IS RESPONSIBLE FOR THE DESIGN AND INSTALLATION OF A COMPLETE SYSTEM PER THESE PLANS AND SPECIFICATIONS AND IN COMPLIANCE WITH ALL APPLICABLE CODES. CONTRACTOR SHALL BE RESPONSIBLE FOR SUBMISSION TO THE OFFICE OF THE STATE FIRE MARSHAL.
3. THE DESIGN TEAM, TO INSURE COMPATIBILITY WITH THE BUILDING DESIGN INTENT, WILL CAREFULLY REVIEW SPRINKLER PLANS. CORRECTIONS WILL BE MADE BY THE CONTRACTOR AT NO ADDITIONAL EXPENSE TO THE OWNER.
4. SYSTEM DRAINS SHALL BE INSTALLED AS REQUIRED PER NFPA. DRAINS SHALL BE EXTENDED OUTSIDE THE BUILDING. DRAIN LOCATIONS SHALL BE APPROVED BY THE A/E TEAM AND SHALL BE INDICATED ON THE SHOP DRAWINGS.
5. SPRINKLER HEADS SHALL BE LOCATED A MINIMUM OF 6" AWAY FROM CEILING GRID IN ALL ACOUSTICAL CEILING TILES.
6. SPRINKLER PIPING SHALL BE INSTALLED TO MEET SEISMIC REQUIREMENTS WITH LATERAL SWAY BRACING, LONGITUDINAL SWAY BRACING, AND FOUR-WAY BRACING AS REQUIRED BY NFPA AND THE INTERNATIONAL BUILDING CODES.
7. ALL PIPING 2-1/2" AND LARGER SHALL BE SCHEDULE 10 STEEL PIPING AND ALL PIPING SMALLER THAN 2-1/2" SHALL BE SCHEDULE 40 STEEL PIPING.

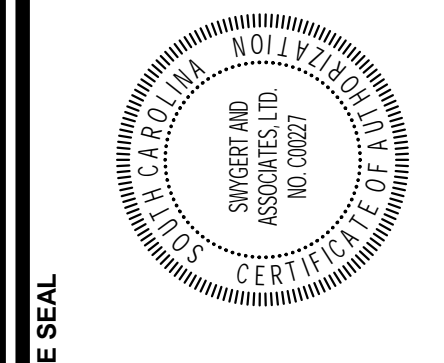

PROJECT TITLE
**FOUNDERS PARK PLAYER'S LOUNGE
 RENOVATION AND MEDIA ROOM
 ADDITION**
 431 WILLIAMS STREET
 COLUMBIA, SC 29201

NO.	REVISIONS	DATE
	NAME	

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 CHECKED BY: TFS
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DRAWING TITLE
**ENTRY LEVEL FLOOR PLAN, CLUB
 LEVEL FLOOR PLAN, ENLARGED
 PLAYERS LOUNGE PLAN,
 ENLARGED MEDIA ROOM PLAN,
 AND NOTES**

PROJECT NO. U42516
 DATE 09/22/16
 DRAWING NO.
FP1.1

Swygart & Associates
 CONSULTING ENGINEERS
DBA: Swygart & Assoc., Ltd. Telephone: (803) 791-0200
 Post Office Box 11466 Facsimile: (803) 791-0830
 Columbia, S.C. 29211 mail@swygart-associates.com

EXISTING PANELBOARD: 2H1-F		DISTRIBUTION: 480/277 Wye								A.I.C. RATING: EXISTING			
SUPPLIED FROM:		PHASES: 3								MAINS RATING: 100 A			
MOUNTING: SURFACE		WIRES: 4								MCB RATING: MAIN LUGS ONLY			
WIRE SIZE	CKT	DESCRIPTION	BKR	P	A	B	C	P	BKR	DESCRIPTION	CKT	WIRE SIZE	
---	1	EXISTING LOAD	---	---	0.0	0.0			---	---	2	---	
1-#12, 1-#10, 1-#12	3	LIGHTING - LOUNGE/KITCHEN	20	1		1.4	0.0		---	---	4	---	
---	5	EXISTING LOAD	---	---			0.0	0.0	---	---	6	---	
---	7	EXISTING LOAD	---	---	0.0	0.0			---	---	8	---	
---	9	EXISTING LOAD	---	---		0.0	0.0		---	---	10	---	
---	11	EXISTING LOAD	---	---			0.0	0.0	---	---	12	---	
---	13	EXISTING LOAD	---	---	0.0	0.0			---	---	14	---	
---	15	EXISTING LOAD	---	---		0.0	0.0		---	---	16	---	
---	17	EXISTING LOAD	---	---			0.0	0.0	---	---	18	---	
---	19	EXISTING LOAD	---	---	0.0	0.0			---	---	20	---	
---	21	EXISTING LOAD	---	---		0.0	0.0		---	---	22	---	
---	23	EXISTING LOAD	---	---			0.0	0.0	---	---	24	---	
---	25	EXISTING LOAD	---	---	0.0	0.0			---	---	26	---	
---	27	EXISTING LOAD	---	---		0.0	0.0		---	---	28	---	
---	29	EXISTING LOAD	---	---			0.0	0.0	---	---	30	---	
---	31	EXISTING LOAD	---	---	0.0	0.0			---	---	32	---	
---	33	EXISTING LOAD	---	---		0.0	0.0		---	---	34	---	
---	35	EXISTING LOAD	---	---			0.0	0.0	---	---	36	---	
---	37	EXISTING LOAD	---	---	0.0	0.0			---	---	38	---	
---	39	EXISTING LOAD	---	---			0.0	0.0	---	---	40	---	
---	41	EXISTING LOAD	---	---			0.0	0.0	---	---	42	---	
TOTAL PER PHASE KVA:					0.0	1.4	0.0		ADD. CONNECTED KVA:				1.4
TOTAL PER PHASE AMPACITY:					0	5	0		ADD. CONNECTED AMPS:				2

NOTES:
* GFCI TYPE BREAKER



EXISTING PANELBOARD: 2L3-F		DISTRIBUTION: 120/208 Wye								A.I.C. RATING: EXISTING			
SUPPLIED FROM:		PHASES: 3								MAINS RATING: 100 A			
MOUNTING: SURFACE		WIRES: 4								MCB RATING: MAIN LUGS ONLY			
WIRE SIZE	CKT	DESCRIPTION	BKR	P	A	B	C	P	BKR	DESCRIPTION	CKT	WIRE SIZE	
---	1	EXISTING LOAD	---	---	0.0	0.0			---	---	2	---	
---	3	EXISTING LOAD	---	---		0.0	0.0		---	---	4	---	
---	5	EXISTING LOAD	---	---			0.0	0.0	---	---	6	---	
---	7	EXISTING LOAD	---	---	0.0	0.9			1	20	RECEPTACLES - LOUNGE	8	1-#12, 1-#10, 1-#12
---	9	EXISTING LOAD	---	---		0.0	0.7		1	20	RECEPTACLES - LOUNGE TVS	10	1-#12, 1-#10, 1-#12
---	11	EXISTING LOAD	---	---			0.0	0.4	1	20	RECEPTACLES - LOUNGE	12	1-#12, 1-#10, 1-#12
---	13	EXISTING LOAD	---	---	0.0	0.0			---	---	14	---	
---	15	EXISTING LOAD	---	---		0.0	0.0		---	---	16	---	
---	17	EXISTING LOAD	---	---			0.0	0.4	1	20	RECEPTACLES - LOUNGE	18	1-#12, 1-#10, 1-#12
---	19	EXISTING LOAD	---	---	0.0	0.0			---	---	20	---	
---	21	EXISTING LOAD	---	---		0.0	0.0		---	---	22	---	
1-#12, 1-#10, 1-#12	23	* BEVERAGE DISPENSER	20	1			0.2	0.0	---	---	24	---	
1-#12, 1-#10, 1-#12	25	* POP FOUNTAIN	20	1	0.2	0.0			---	---	26	---	
1-#12, 1-#10, 1-#12	27	RECEPTACLES - KITCHEN	20	1		0.4	0.0		---	---	28	---	
1-#12, 1-#10, 1-#12	29	RECEPTACLES - KITCHEN	20	1			0.4	0.0	---	---	30	---	
1-#12, 1-#10, 1-#12	31	RECEPTACLES - KITCHEN	20	1	0.4	0.0			---	---	32	---	
1-#12, 1-#10, 1-#12	33	MOTORIZED SHADES - LOUNGE	20	1		0.2	0.0		---	---	34	---	
---	35	EXISTING LOAD	---	---			0.0	0.0	---	---	36	---	
---	37	EXISTING LOAD	---	---	0.0	0.0			---	---	38	---	
---	39	EXISTING LOAD	---	---			0.0	0.0	---	---	40	---	
---	41	EXISTING LOAD	---	---			0.0	0.0	---	---	42	---	
TOTAL PER PHASE KVA:					1.4	1.3	1.3		ADD. CONNECTED KVA:				4.0
TOTAL PER PHASE AMPACITY:					12	11	11		ADD. CONNECTED AMPS:				11

NOTES:
* GFCI TYPE BREAKER

EXISTING PANELBOARD: 2EH1-F		DISTRIBUTION: 480/277 Wye								A.I.C. RATING: EXISTING			
SUPPLIED FROM:		PHASES: 3								MAINS RATING: 100 A			
MOUNTING: SURFACE		WIRES: 4								MCB RATING: MAIN LUGS ONLY			
WIRE SIZE	CKT	DESCRIPTION	BKR	P	A	B	C	P	BKR	DESCRIPTION	CKT	WIRE SIZE	
---	1	EXISTING LOAD	---	---	0.0	0.0			---	---	2	---	
---	3	EXISTING LOAD	---	---			0.0	0.0	---	---	4	---	
---	5	EXISTING LOAD	---	---				0.0	0.0	---	---	6	---
---	7	EXISTING LOAD	---	---	0.0	0.0			---	---	8	---	
---	9	EXISTING LOAD	---	---		0.0	0.0		---	---	10	---	
1-#12, 1-#10, 1-#12	11	LIGHTING - LOUNGE/KITCHEN	20	1				0.1	0.0	---	---	12	---
---	13	EXISTING LOAD	---	---	0.0	0.0			---	---	14	---	
---	15	EXISTING LOAD	---	---		0.0	0.0		---	---	16	---	
---	17	EXISTING LOAD	---	---			0.0	0.0	---	---	18	---	
---	19	EXISTING LOAD	---	---	0.0	0.0			---	---	20	---	
---	21	EXISTING LOAD	---	---		0.0	0.0		---	---	22	---	
---	23	EXISTING LOAD	---	---			0.0	0.0	---	---	24	---	
---	25	EXISTING LOAD	---	---	0.0	0.0			---	---	26	---	
---	27	EXISTING LOAD	---	---		0.0	0.0		---	---	28	---	
---	29	EXISTING LOAD	---	---			0.0	0.0	---	---	30	---	
---	31	EXISTING LOAD	---	---	0.0	0.0			---	---	32	---	
---	33	EXISTING LOAD	---	---		0.0	0.0		---	---	34	---	
---	35	EXISTING LOAD	---	---			0.0	0.0	---	---	36	---	
---	37	EXISTING LOAD	---	---	0.0	0.0			---	---	38	---	
---	39	EXISTING LOAD	---	---			0.0	0.0	---	---	40	---	
---	41	EXISTING LOAD	---	---			0.0	0.0	---	---	42	---	
TOTAL PER PHASE KVA:					0.0	0.0	0.1		ADD. CONNECTED KVA:				0.1
TOTAL PER PHASE AMPACITY:					0	0	1		ADD. CONNECTED AMPS:				0

NOTES:
* GFCI TYPE BREAKER

- GENERAL PANEL SCHEDULE NOTES**
- FIELD VERIFY EXISTING LOAD SERVED BY EACH BRANCH AND CLEARLY LABEL IN PANELBOARD SCHEDULES.
 - CIRCUITS INDICATED TO FEED NEW LIGHTING AND ELECTRICAL DEVICES ARE DIAGRAMMATIC IN NATURE. CONTRACTOR SHALL BE RESPONSIBLE FOR MOVING EXISTING BREAKERS WHERE ADDITIONAL SPACE IS NEEDED BUT AVAILABLE.
 - EXISTING BREAKERS SHOWN IN PANEL SCHEDULES ARE FOR REFERENCE ONLY.
 - ALL BRANCH CIRCUITS SHALL BE IN 3/4" CONDUIT UNLESS NOTED OTHERWISE.

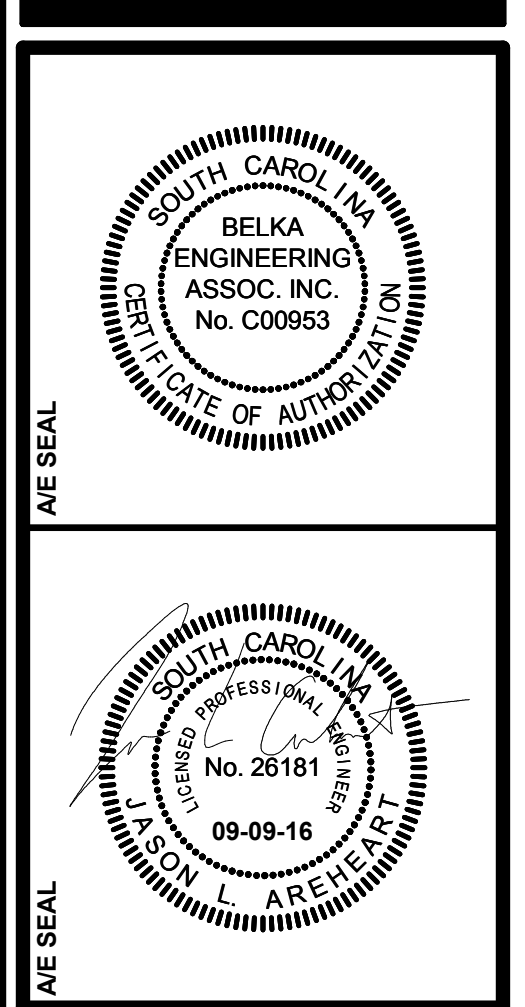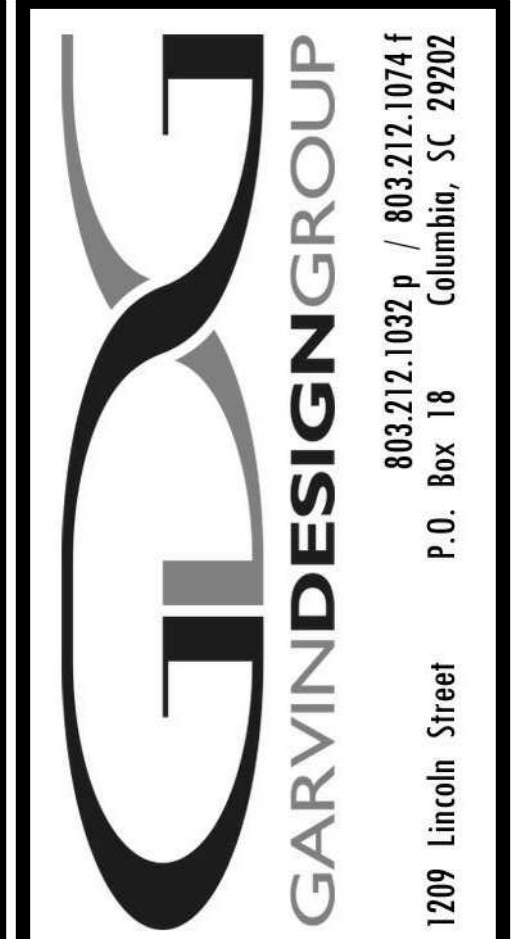

PROJECT TITLE
FOUNDERS PARK PLAYER'S LOUNGE RENOVATION AND MEDIA ROOM ADDITION
431 WILLIAMS STREET
COLUMBIA, SC 29201


NO.	NAME	DATE

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CHECKED BY: CES


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ELECTRICAL PANEL SCHEDULES

PROJECT NO.: 140216
DATE: 08/08/16
DRAWING NO.: **E0.2**


GA21607
BEA BELKA ENGINEERING ASSOCIATES, INC.
7 CLUSTERS COURT, SUITE 201
COLUMBIA, SOUTH CAROLINA 29210
(803) 731-0650 fax (803) 731-2880
Cliff Stringfield
EMAIL: C.EStringfield@belsouth.net

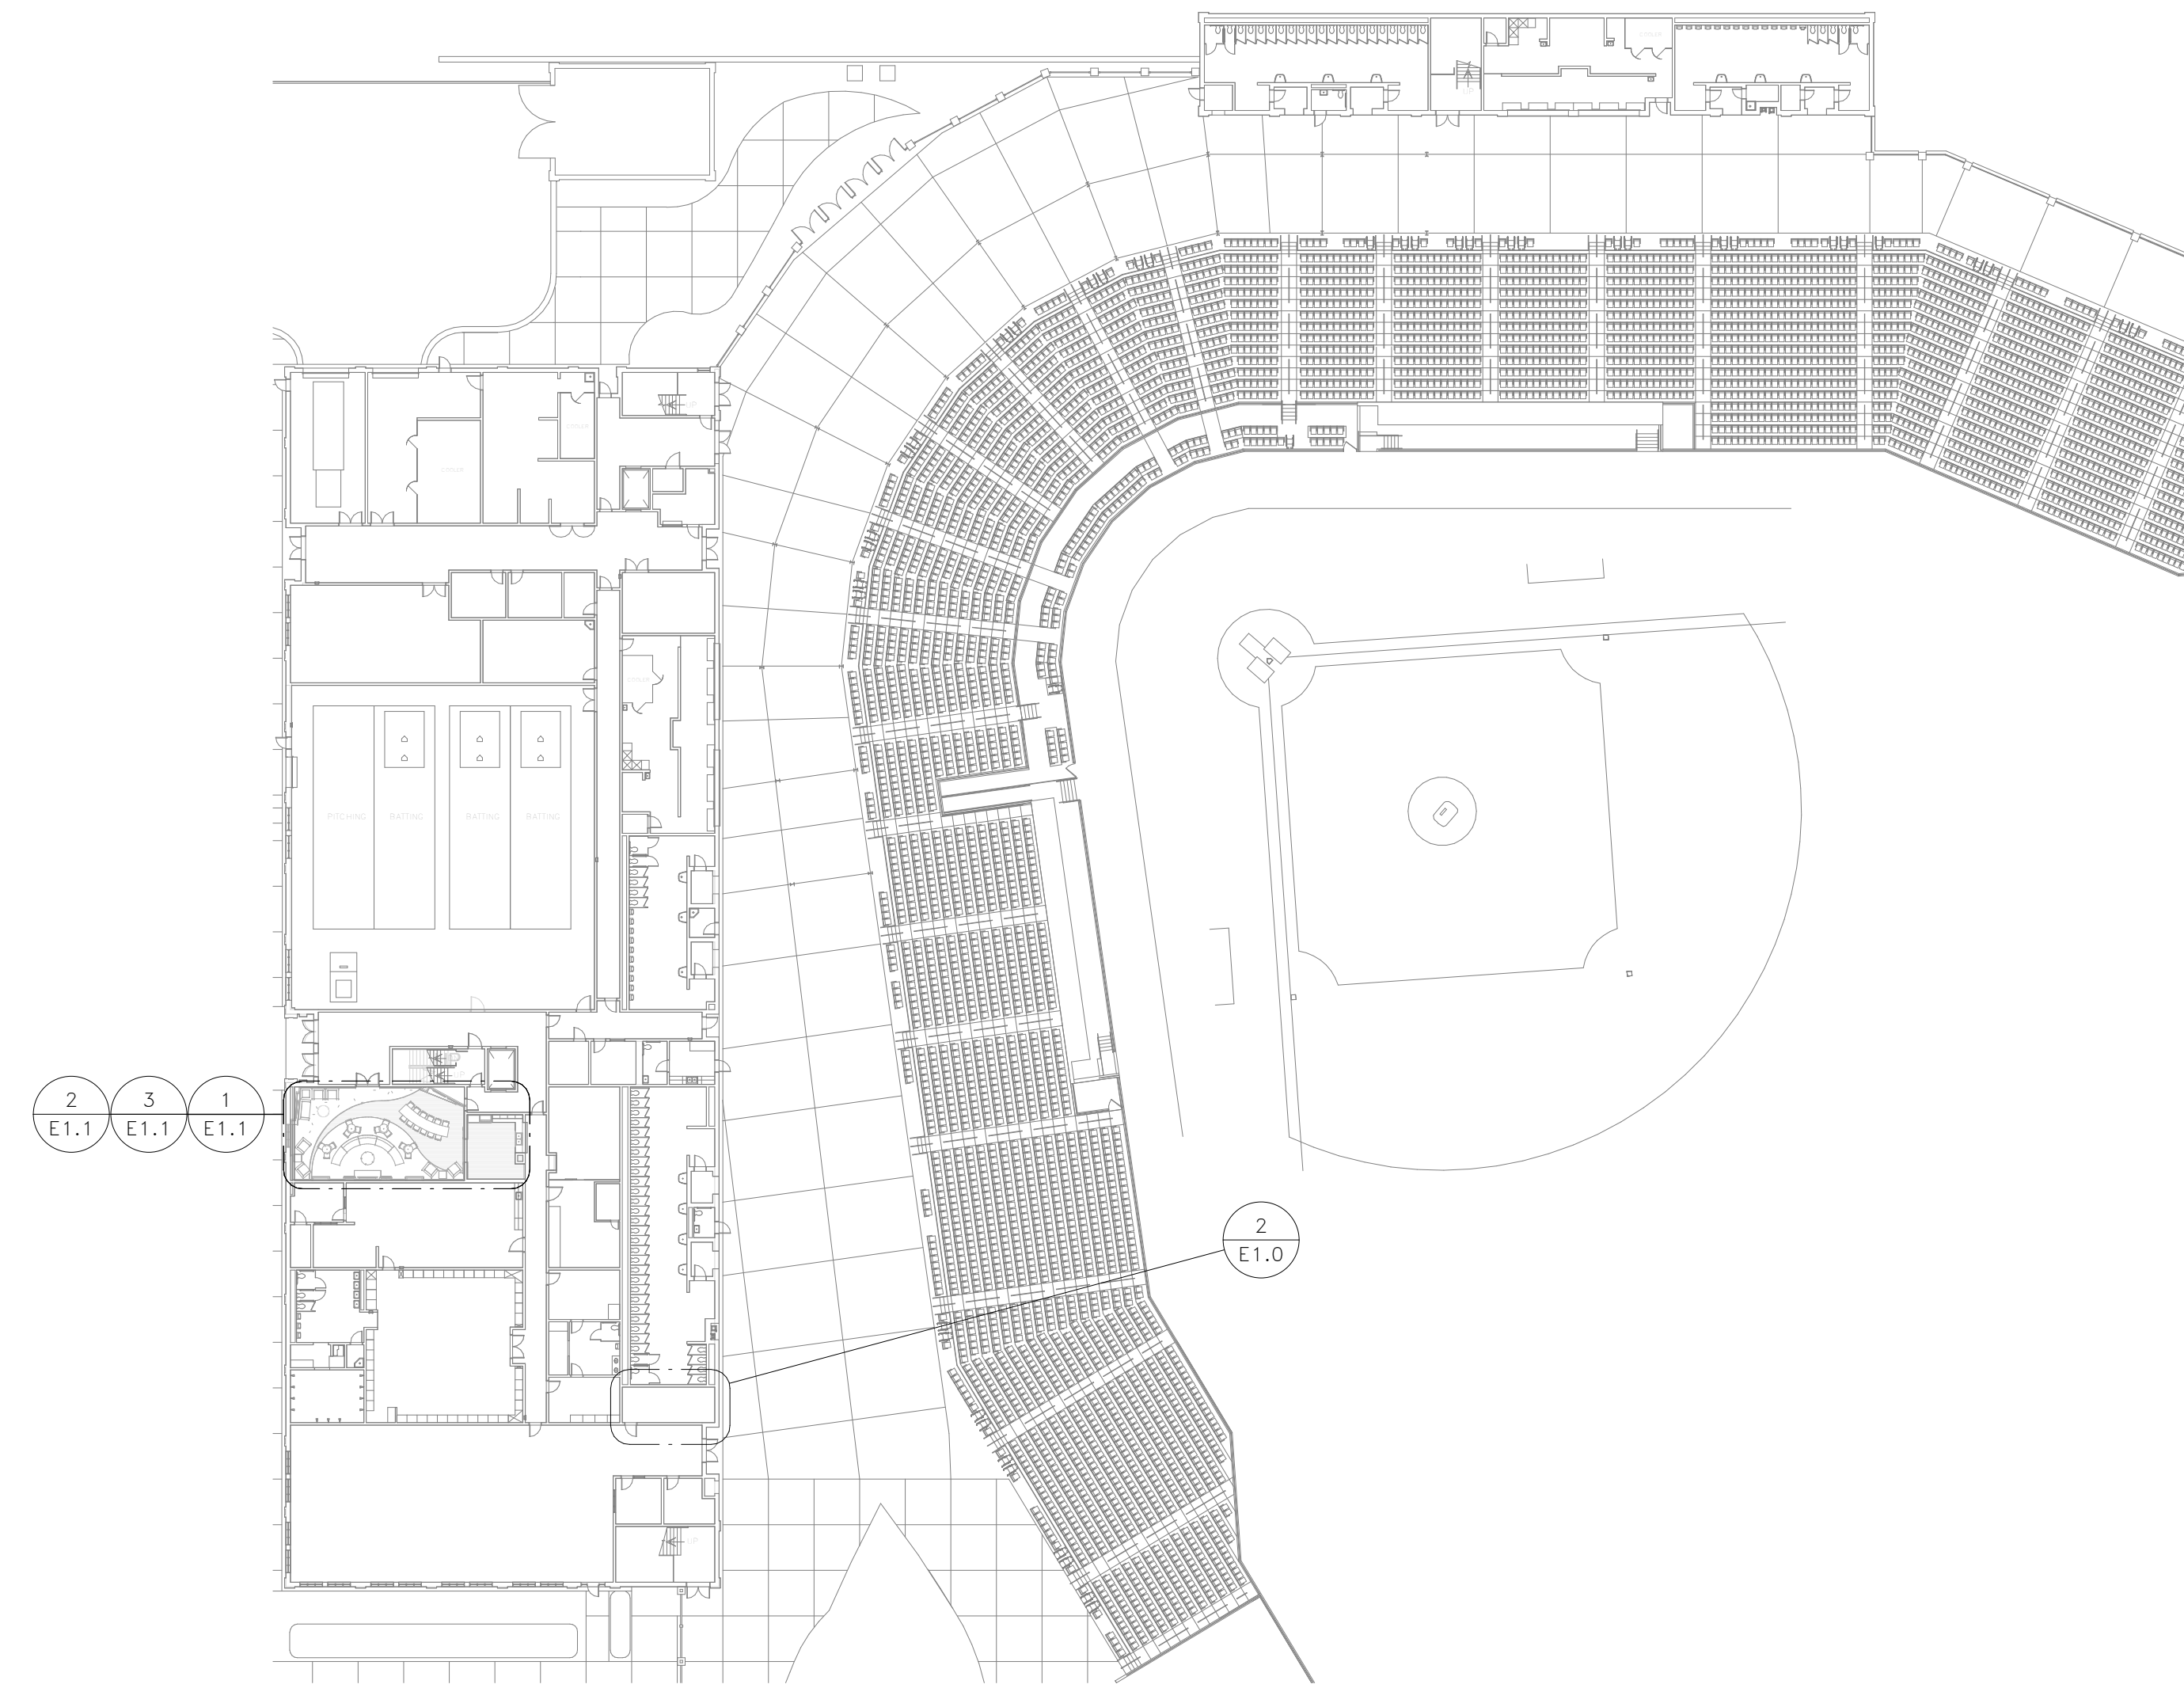


1 ENTRY LEVEL OVERALL PLAN
E1.0 SCALE: 1" = 40'-0"

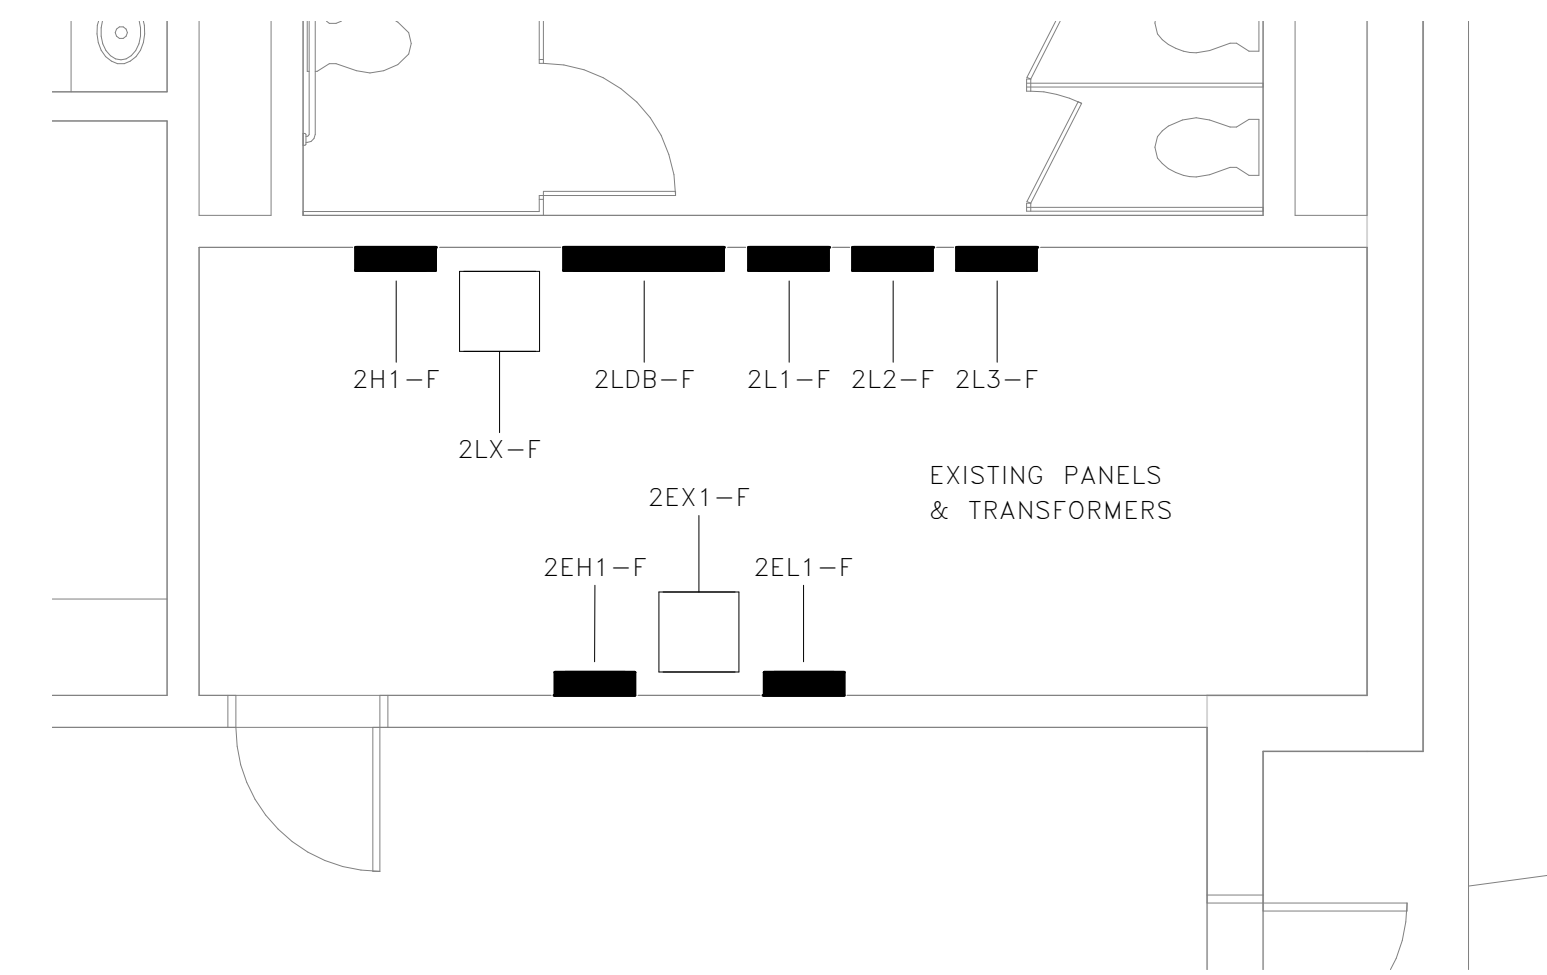



2 ENTRY LEVEL — ENLARGED ELECTRICAL ROOM PLAN
E1.0 SCALE: 1/4" = 1'-0"

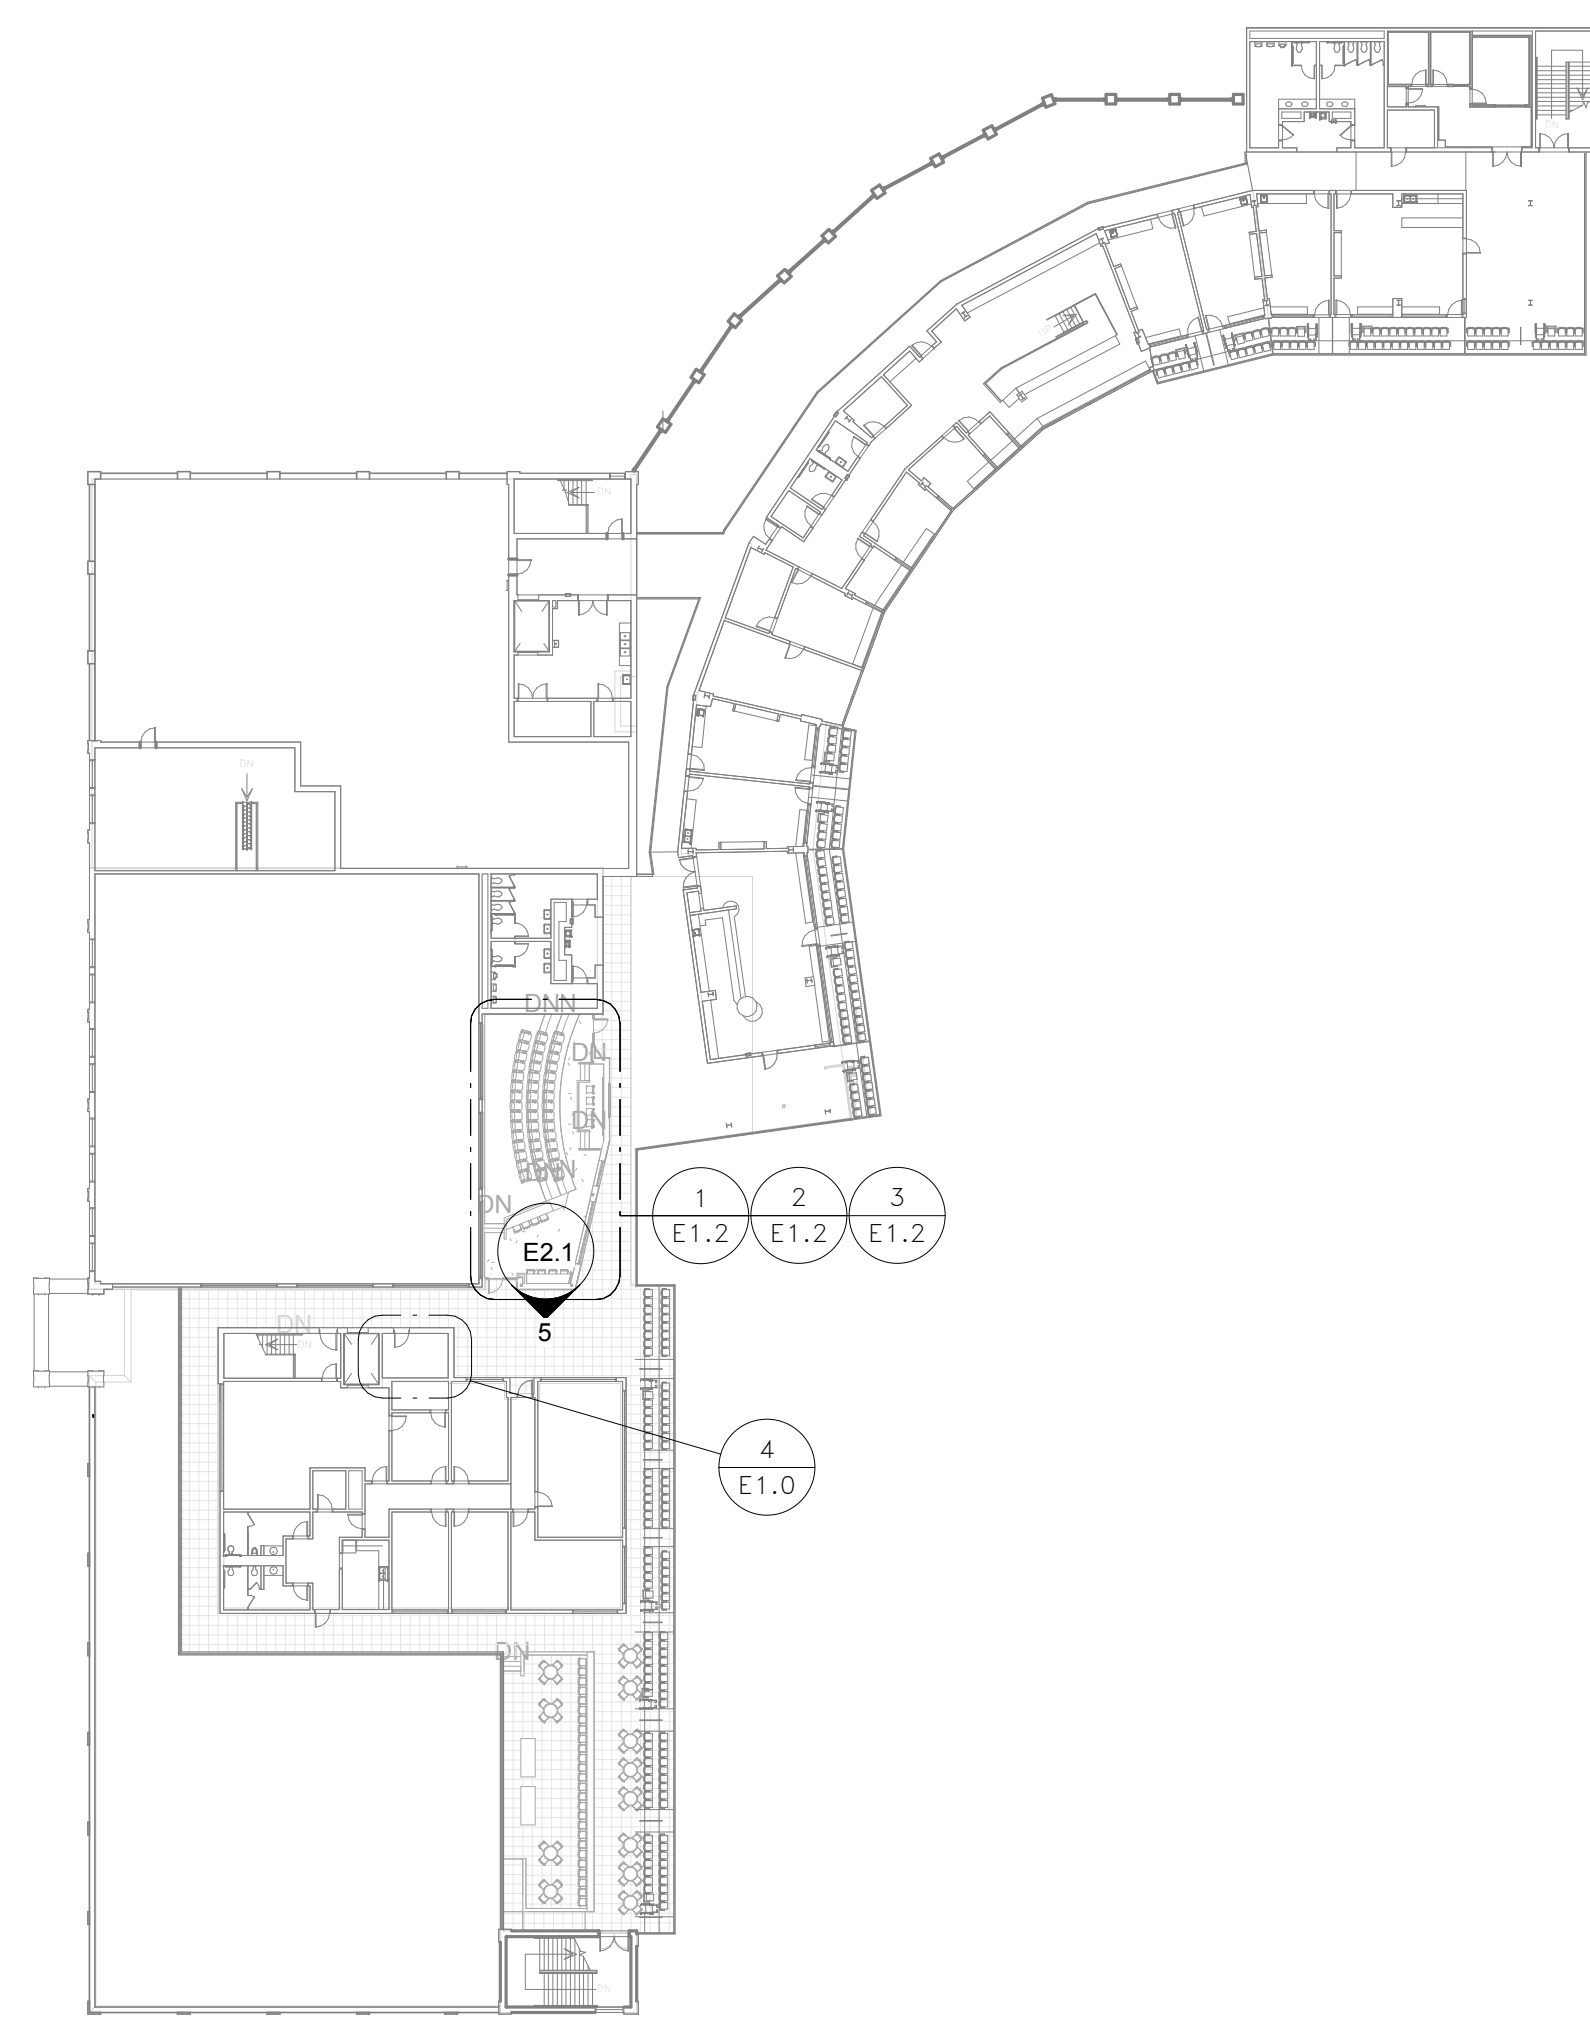

3 CLUB LEVEL OVERALL PLAN
E1.0 SCALE: 1" = 40'-0"



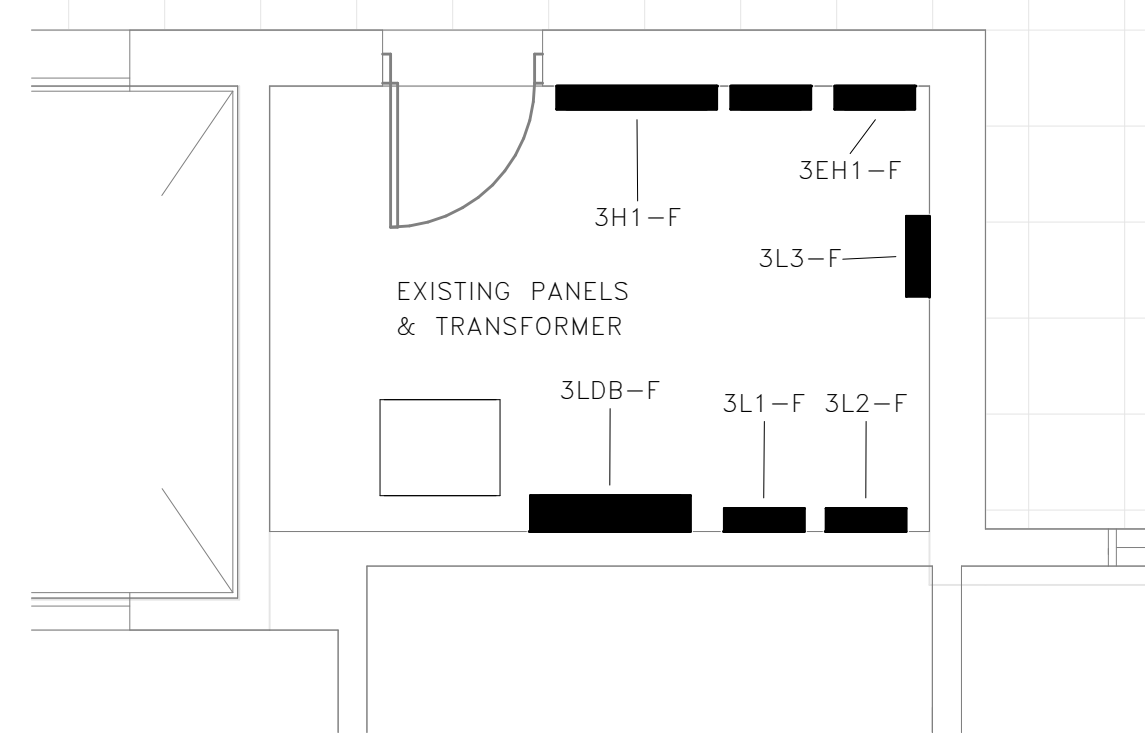


4 CLUB LEVEL — ENLARGED ELECTRICAL ROOM PLAN
E1.0 SCALE: 1/4" = 1'-0"

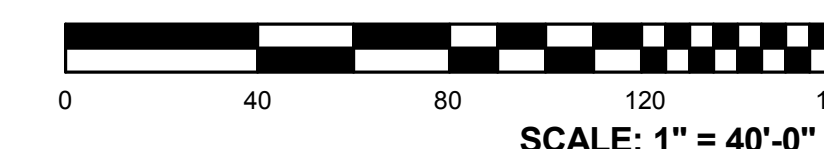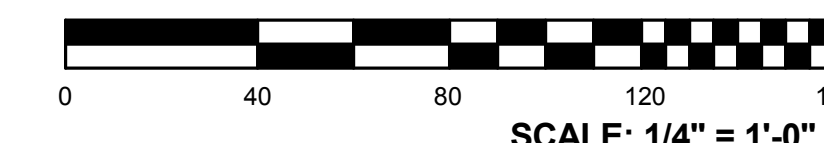

KEY NOTES

GENERAL NOTES

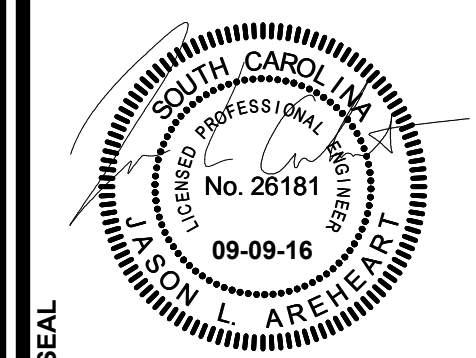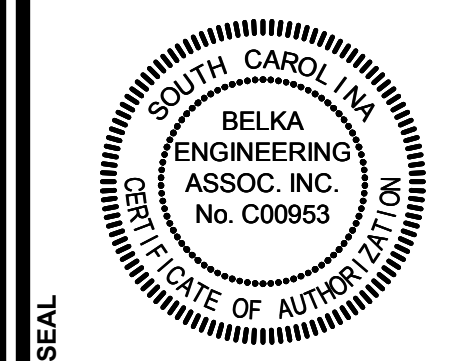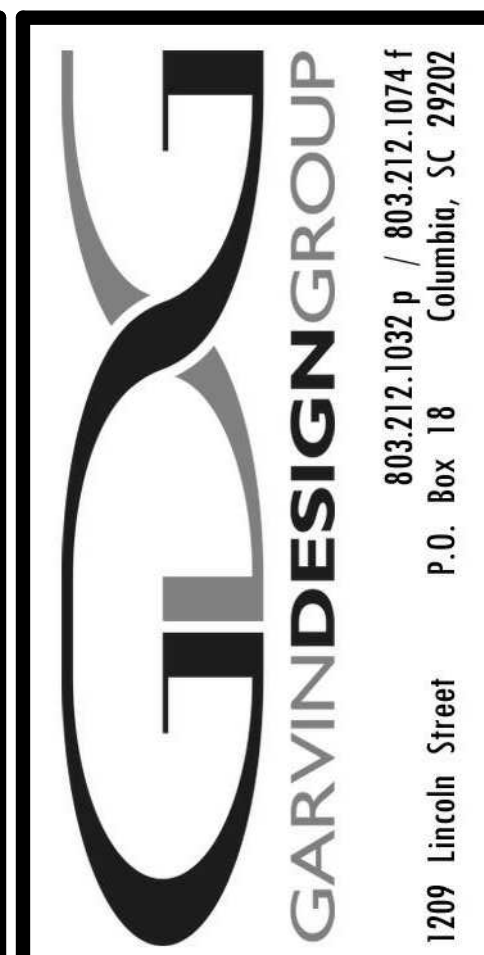

PROJECT TITLE
**FOUNDERS PARK PLAYER'S LOUNGE
RENOVATION AND MEDIA ROOM
ADDITION**
431 WILLIAMS STREET
COLUMBIA, SC 29201

NO.	NAME	DATE


DRAWN BY:	JJS
CHECKED BY:	CES

DRAWING TITLE
OVERALL PLANS


GA21607
BEA BELKA ENGINEERING ASSOCIATES, INC.
7 CLUSTERS COURT, SUITE 201
COLUMBIA, SOUTH CAROLINA 29210
(803) 731-0650 fax (803) 731-2880
Cliff Stringfield
EMAIL: C.EStringfield@belsouth.net

PROJECT NO.	DATE	DRAWING NO.
		E1.0


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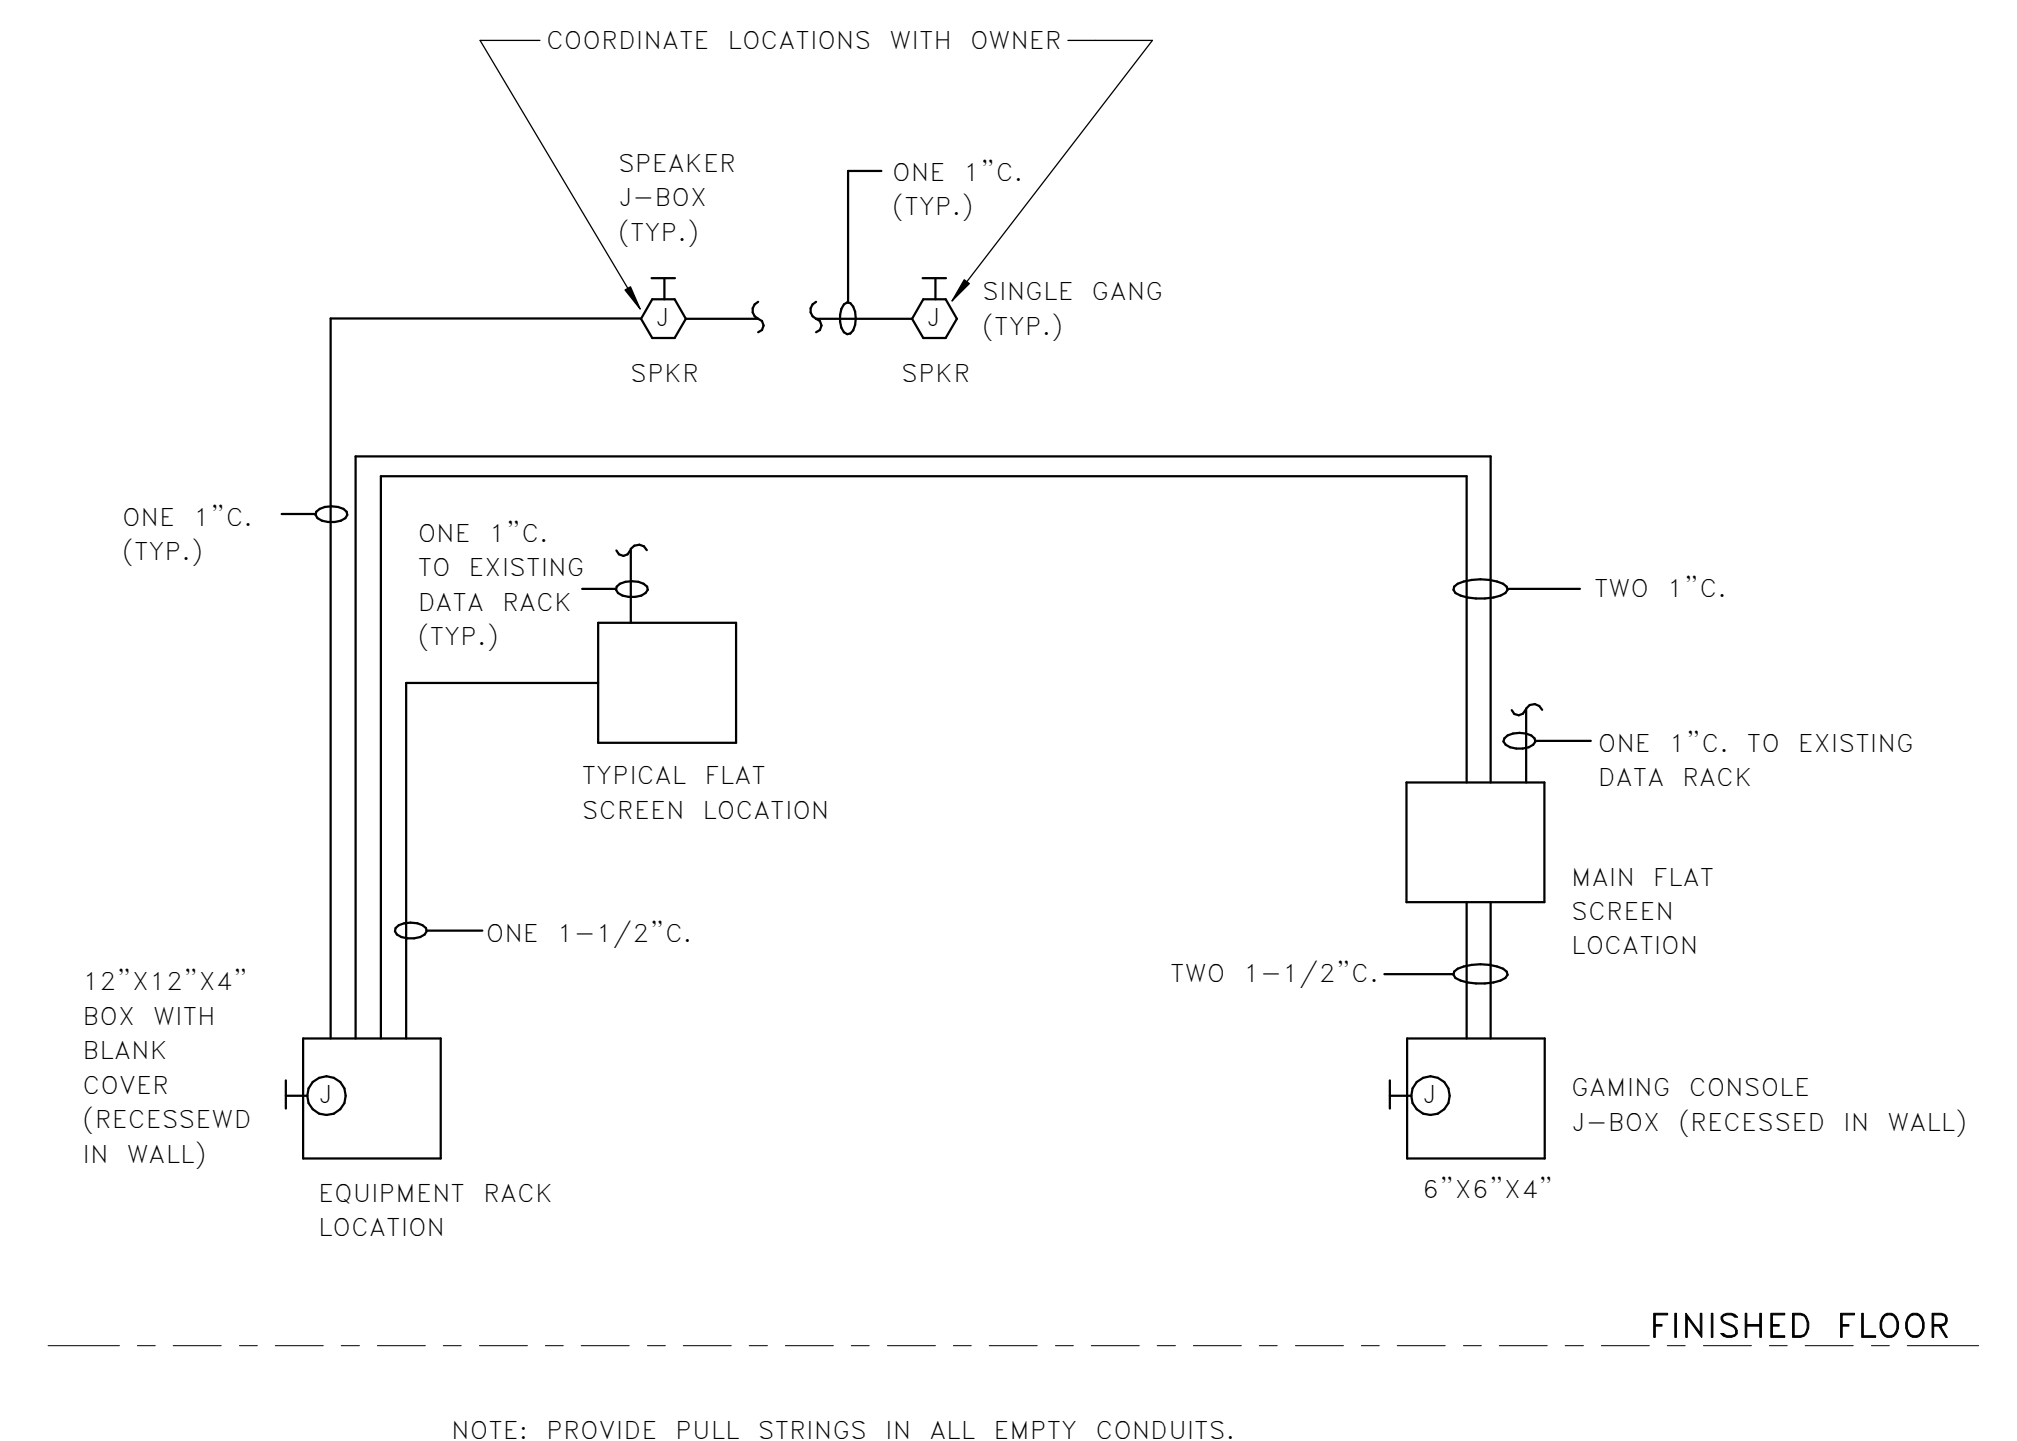
1 PLAYERS LOUNGE ELECTRICAL DEMOLITION PLAN
E1.1 SCALE: 1/4" = 1'-0"

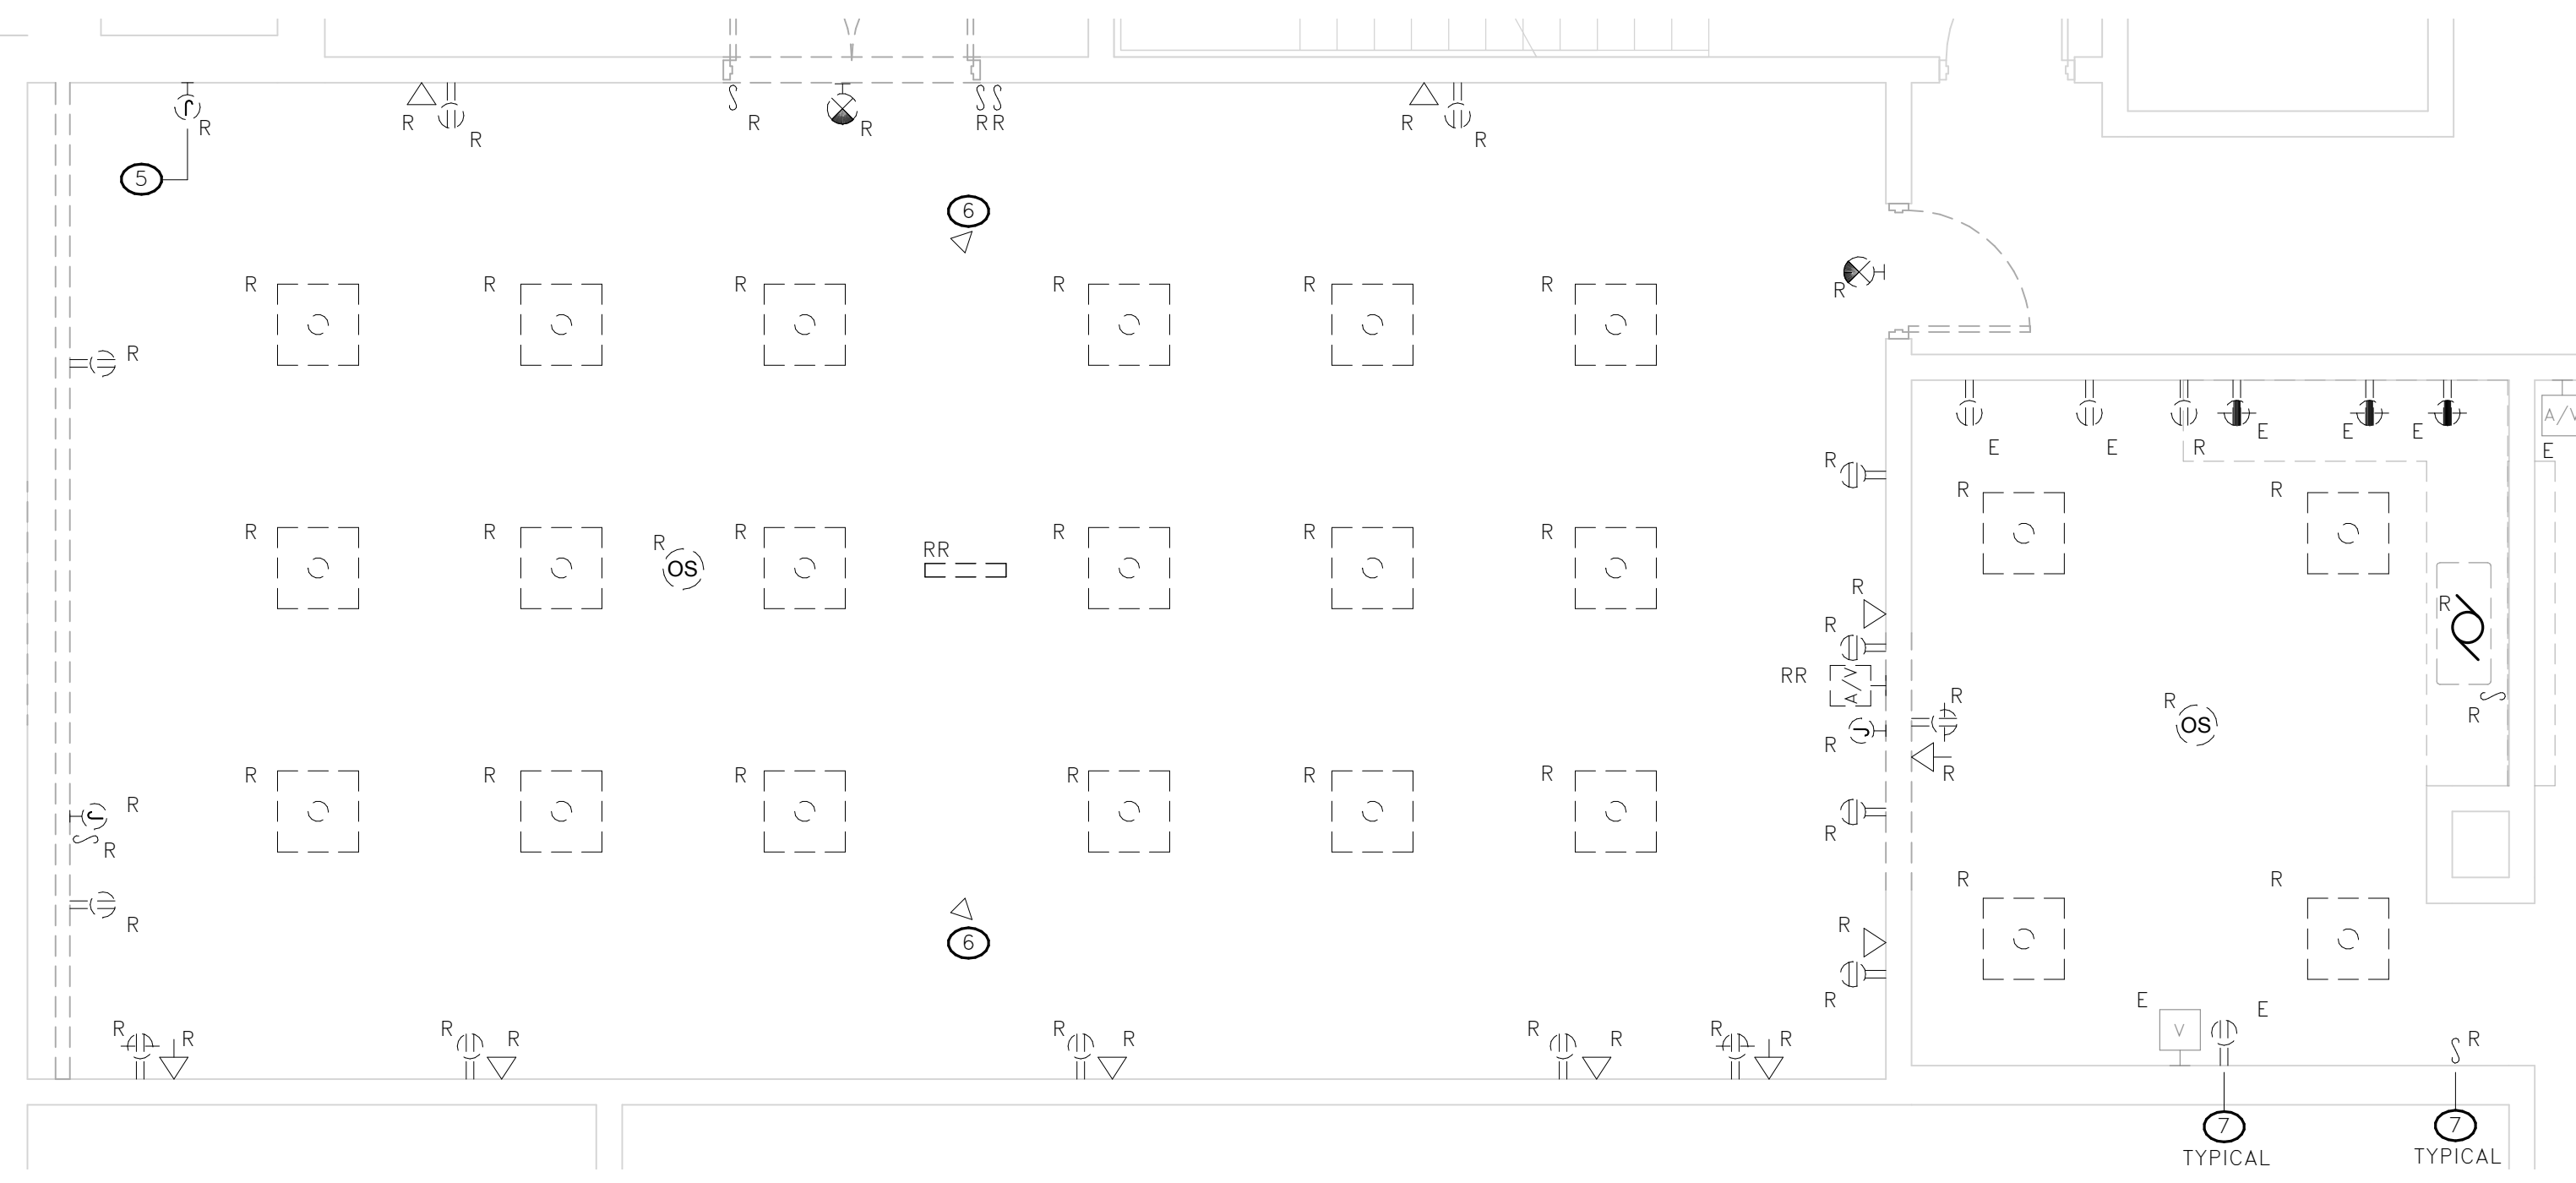

2 PLAYERS LOUNGE LIGHTING RENOVATION PLAN
E1.1 SCALE: 1/4" = 1'-0"

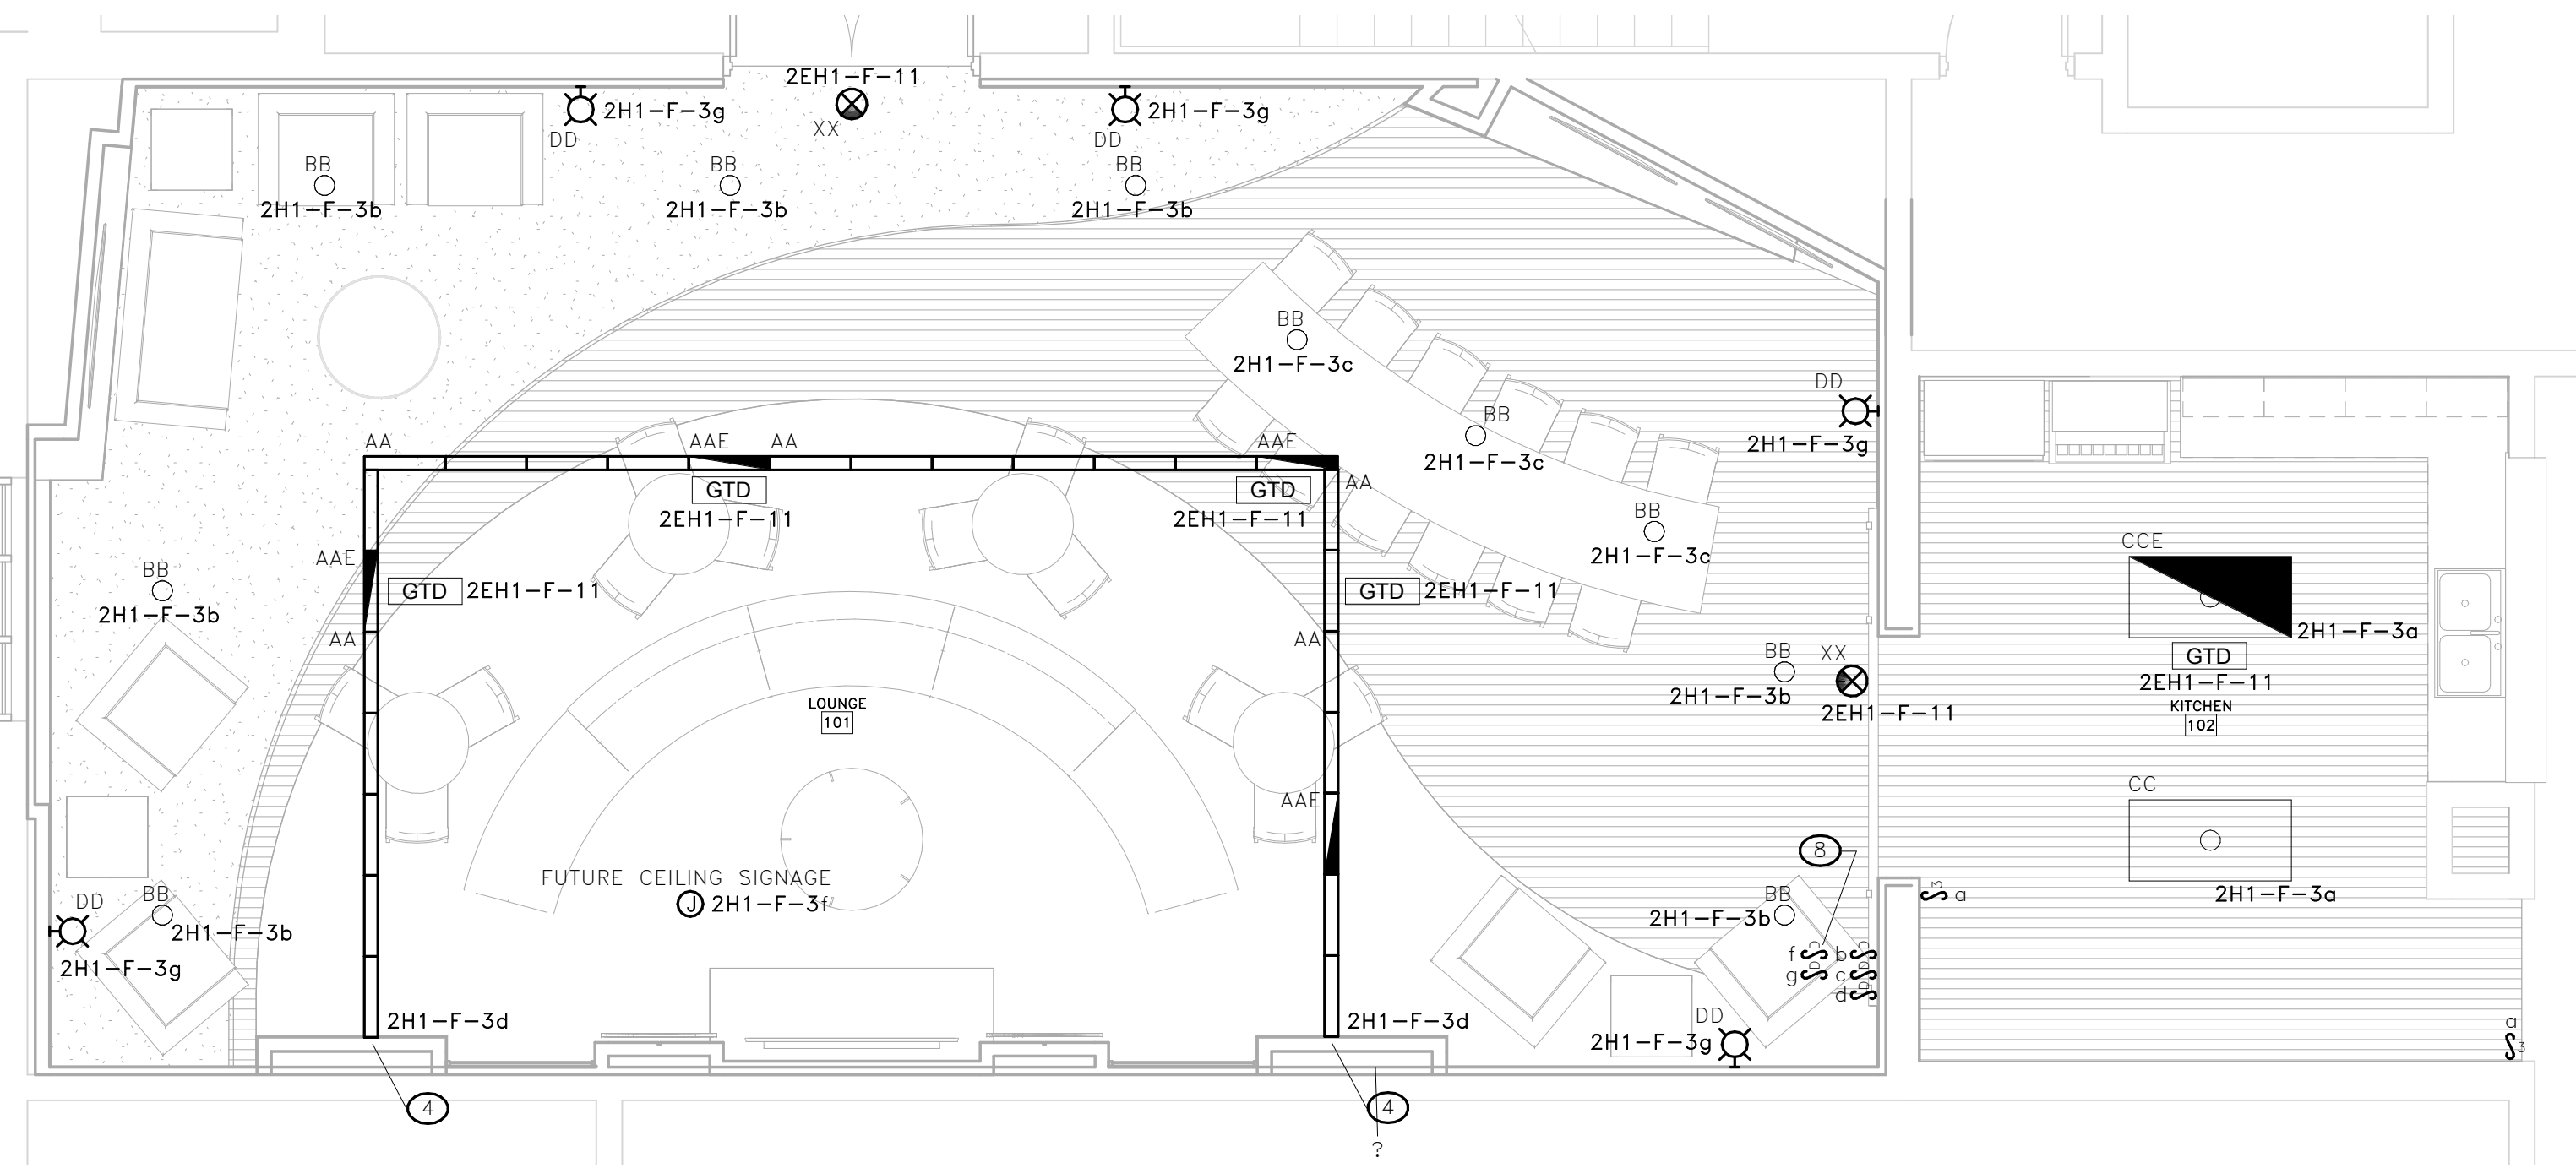

3 PLAYERS LOUNGE POWER/SYSTEMS RENOVATION PLAN
E1.1 SCALE: 1/4" = 1'-0"

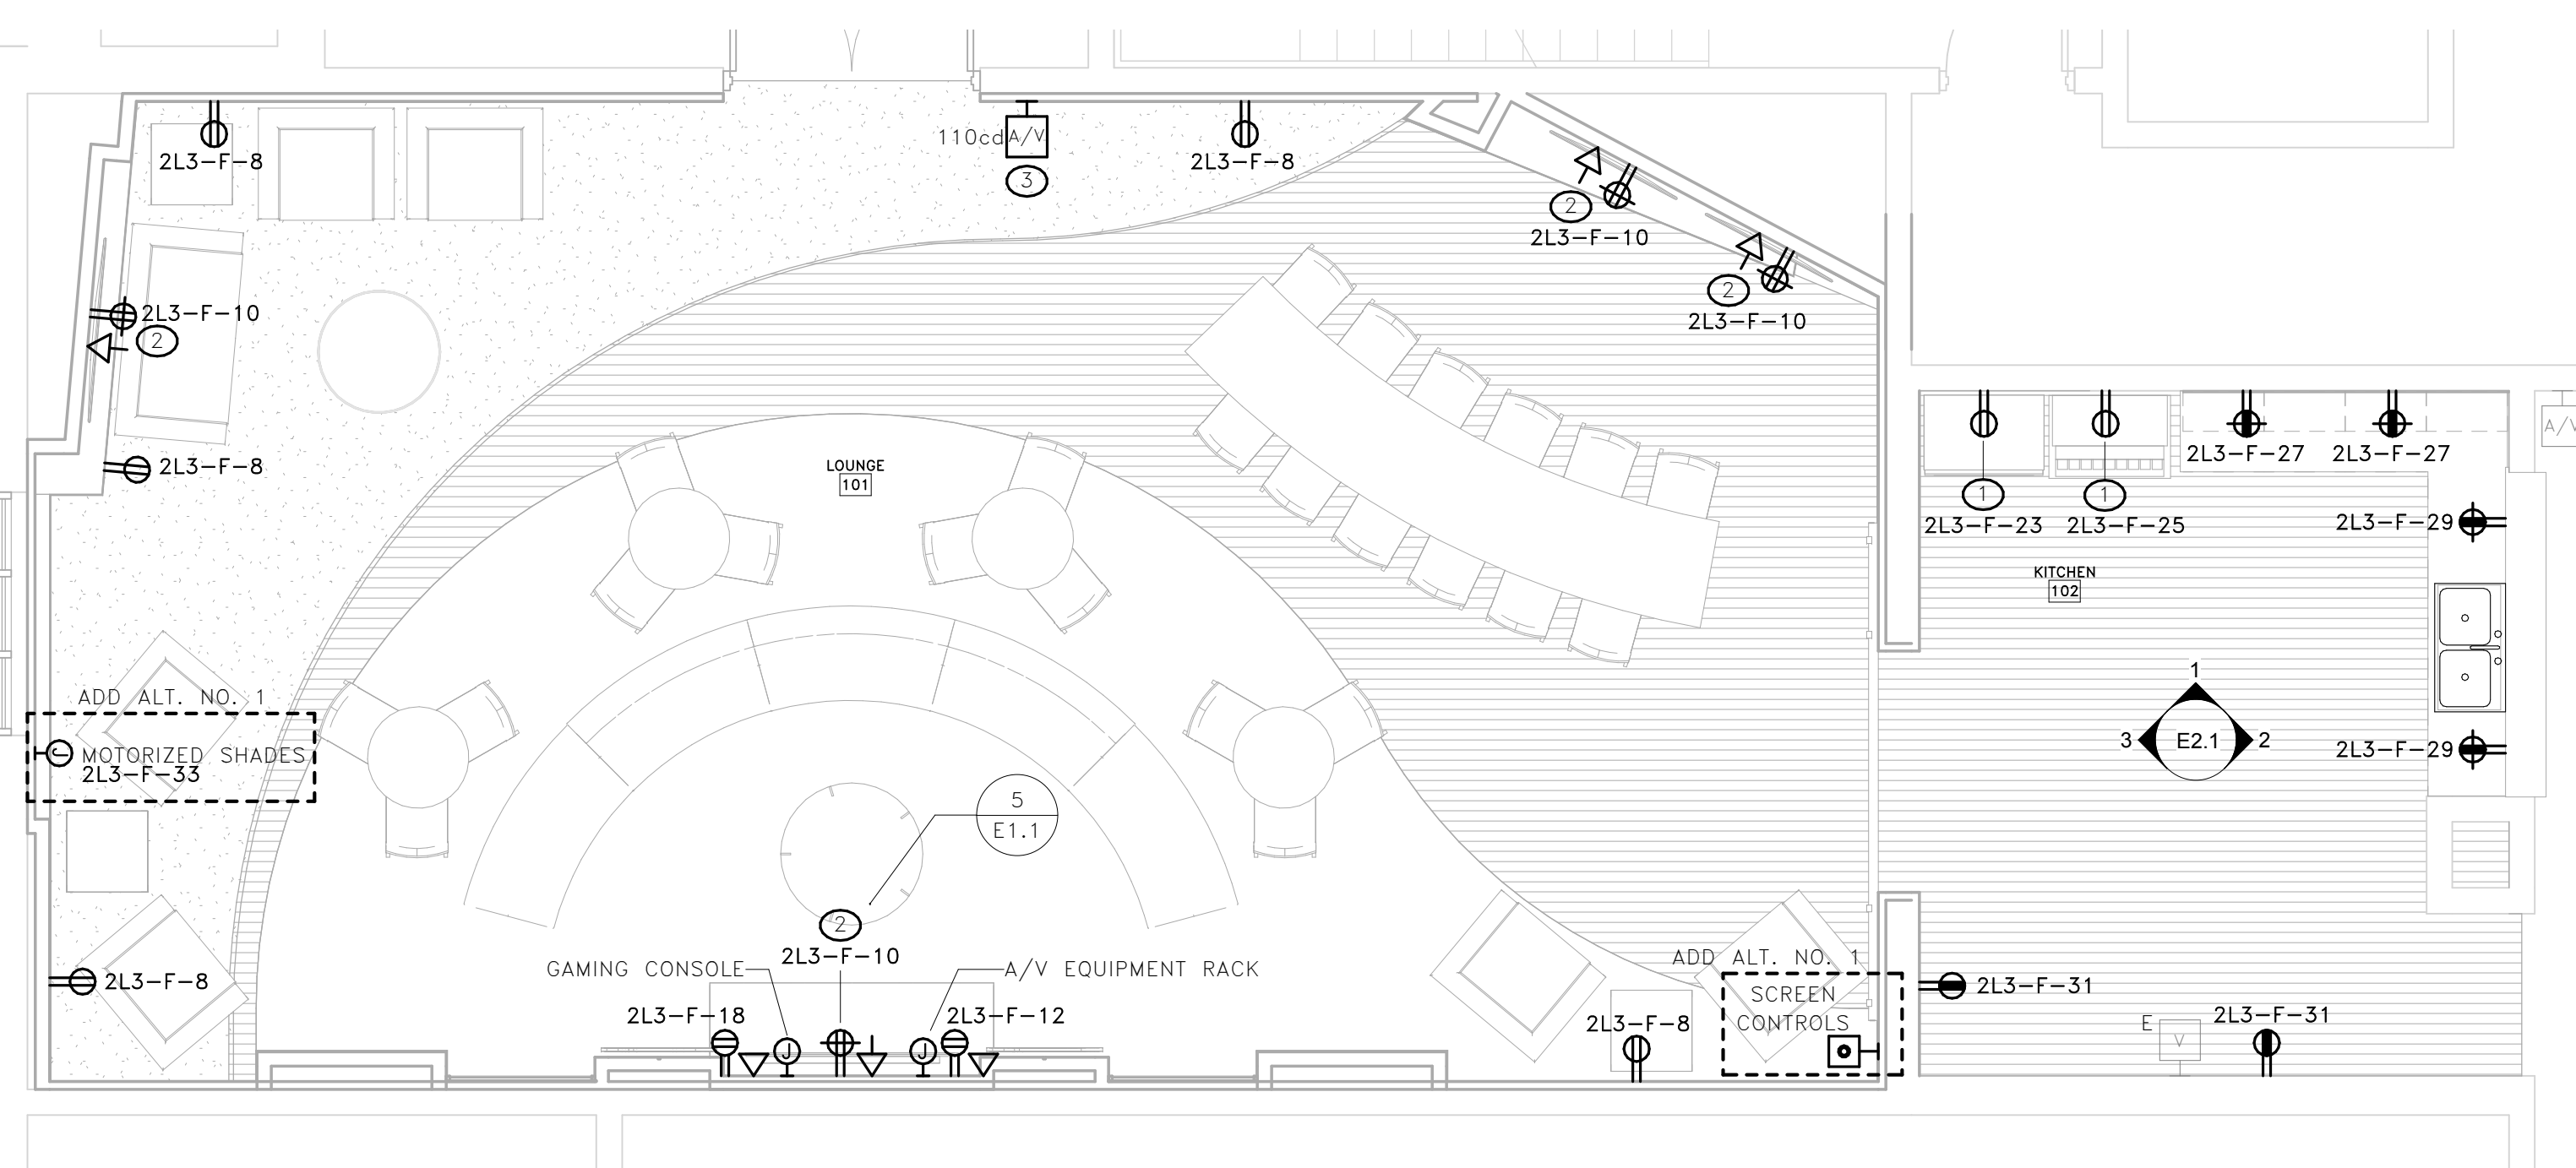


5 A/V INFRASTRUCTURE DIAGRAM
E1.1 SCALE: NOT TO SCALE

KEY NOTES

- THIS RECEPTACLE SHALL BE SERVED BY A GFCI TYPE CIRCUIT BREAKER.
- PROVIDE TV BACKBOX (CHIEF# PAC526 OR APPROVED EQUAL) WITH ONE 20 AMP DUPLEX RECEPTACLE AND ONE DATA OUTLET INTEGRAL TO TV BACKBOX. SEE DETAIL 5/E1.1.
- EXISTING FIRE ALARM DEVICE SHALL BE REINSTALLED IN THIS LOCATION.
- TYPE AA LIGHTING FIXTURE SHALL TURN DOWN WALL AND EXTEND CONTINUOUS 3'0" DOWN WALL.
- REMOVE SURFACE BOX/RACEWAY.
- REMOVE EXISTING TELEVISION LIGHTING AND TURN OVER TO OWNER. REMOVE ASSOCIATED DUPLEX RECEPTABLES.
- PROVIDE NEW DEVICES IN EXISTING BOXES IN THIS SPACE THAT ARE INDICATED TO REMAIN (DENOTED WITH "E"). (TYPICAL).
- PROVIDE DIMMER SWITCHES COMPATIBLE WITH LIGHTING FIXTURE TYPE. PROVIDE 0-10V DIMMER SWITCH FOR FUTURE LIGHTING (SWITCHLEG "f").

GENERAL NOTES

- CIRCUIT NUMBERS ARE DIAGRAMMATICAL ONLY AND CONTRACTOR SHALL FIELD VERIFY AVAILABLE CIRCUITS. SEE SHEET E1.0 FOR PANEL LOCATION.
- ELECTRICAL CONTRACTOR SHALL PROVIDE GENERATOR-TRANSFER DEVICES (GTDs) FOR ALL EMERGENCY FIXTURES SHOWN ON THIS PLAN.

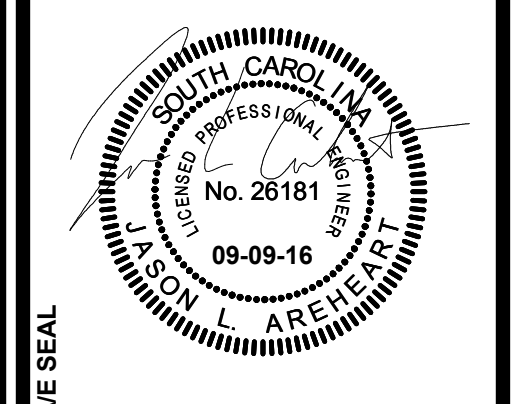

PROJECT TITLE
**FOUNDERS PARK PLAYER'S LOUNGE
RENOVATION AND MEDIA ROOM
ADDITION**
431 WILLIAMS STREET
COLUMBIA, SC 29201


NO.	NAME	DATE

DRAWN BY: JJS
CHECKED BY: CES


DRAWING TITLE
ENTRY LEVEL ELECTRICAL PLANS

PROJECT NO. 142E18
DATE 08/08/18
DRAWING NO. **E1.1**


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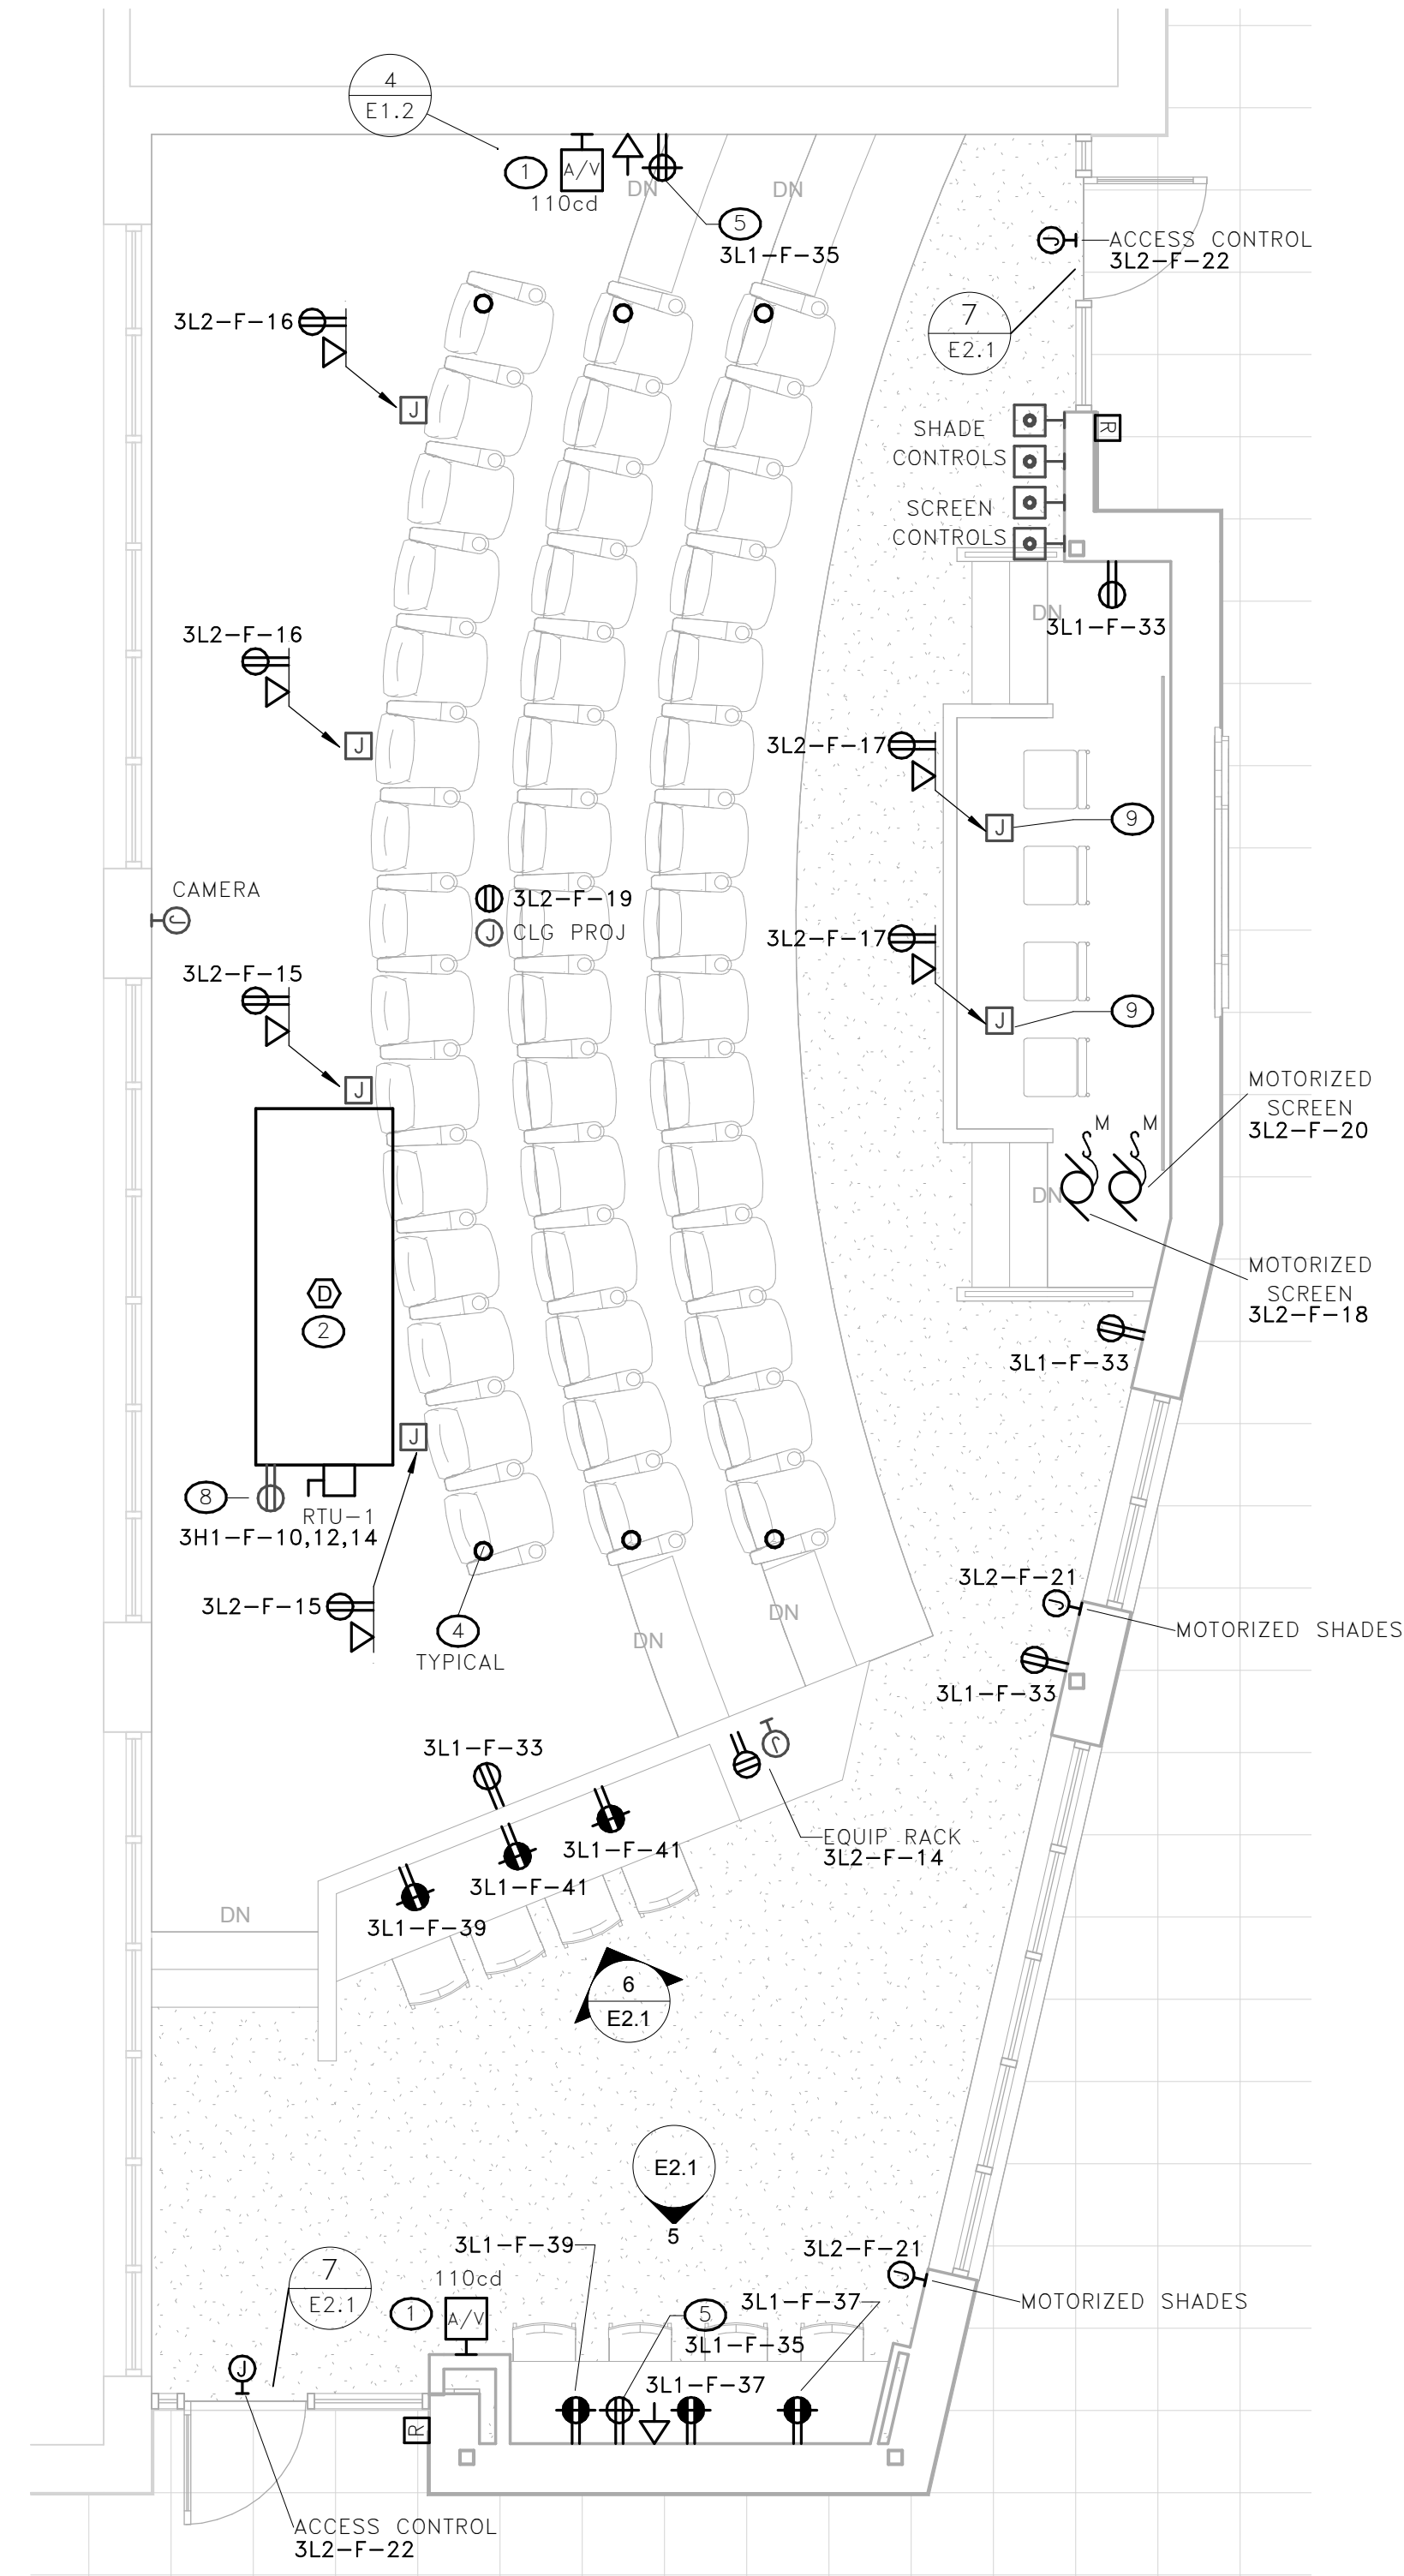
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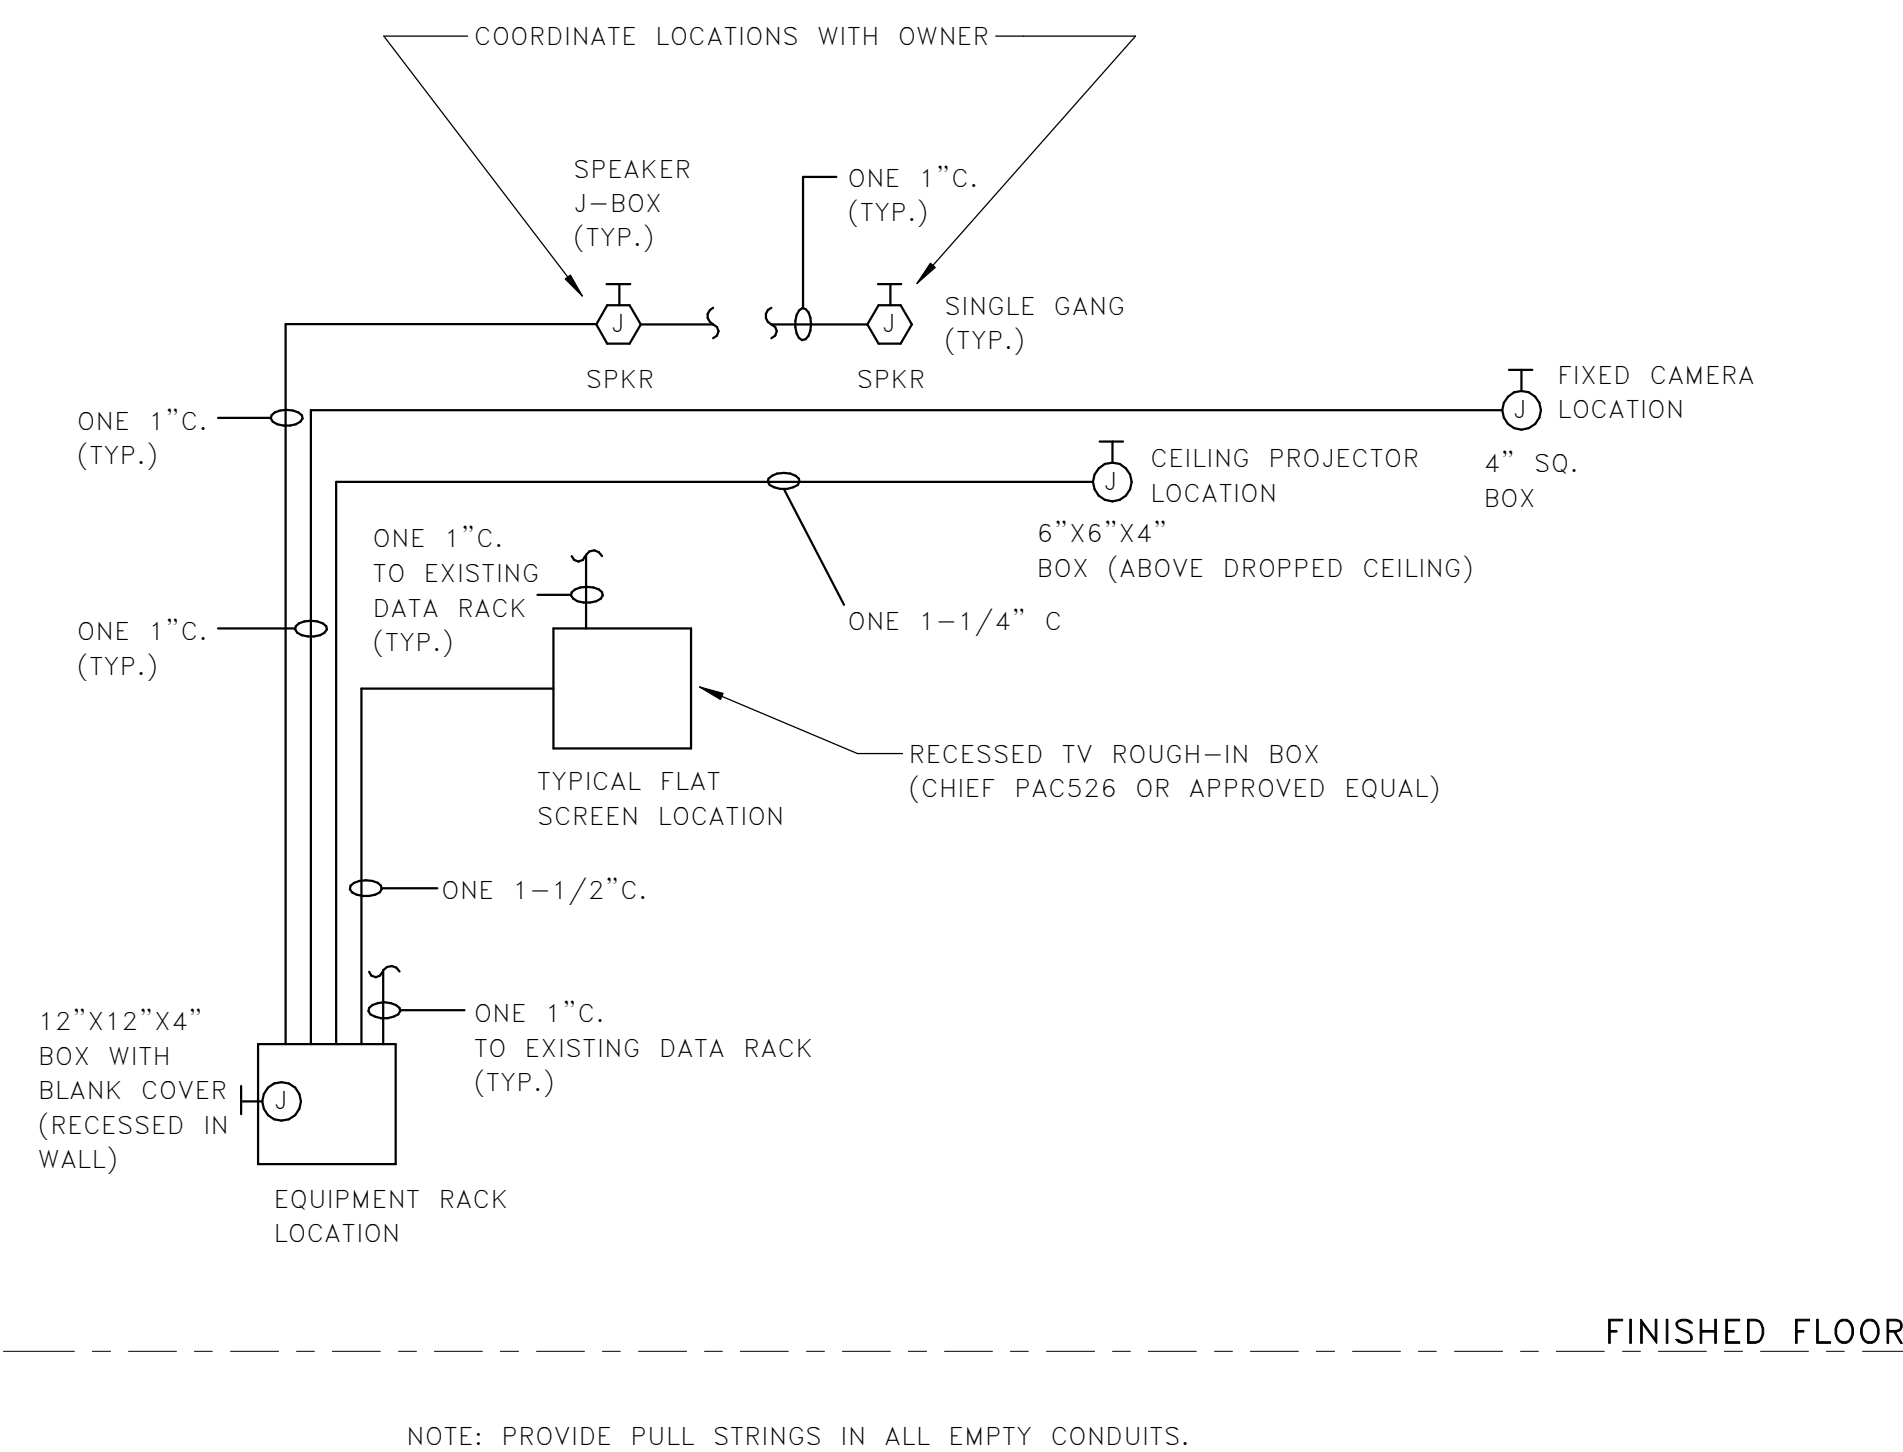
1 MEDIA ROOM ELECTRICAL DEMOLITION PLAN
E1.2 SCALE: 1/4" = 1'-0"

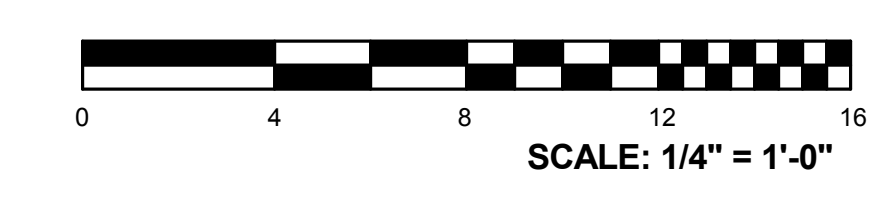

2 MEDIA ROOM LIGHTING RENOVATION PLAN
E1.2 SCALE: 1/4" = 1'-0"

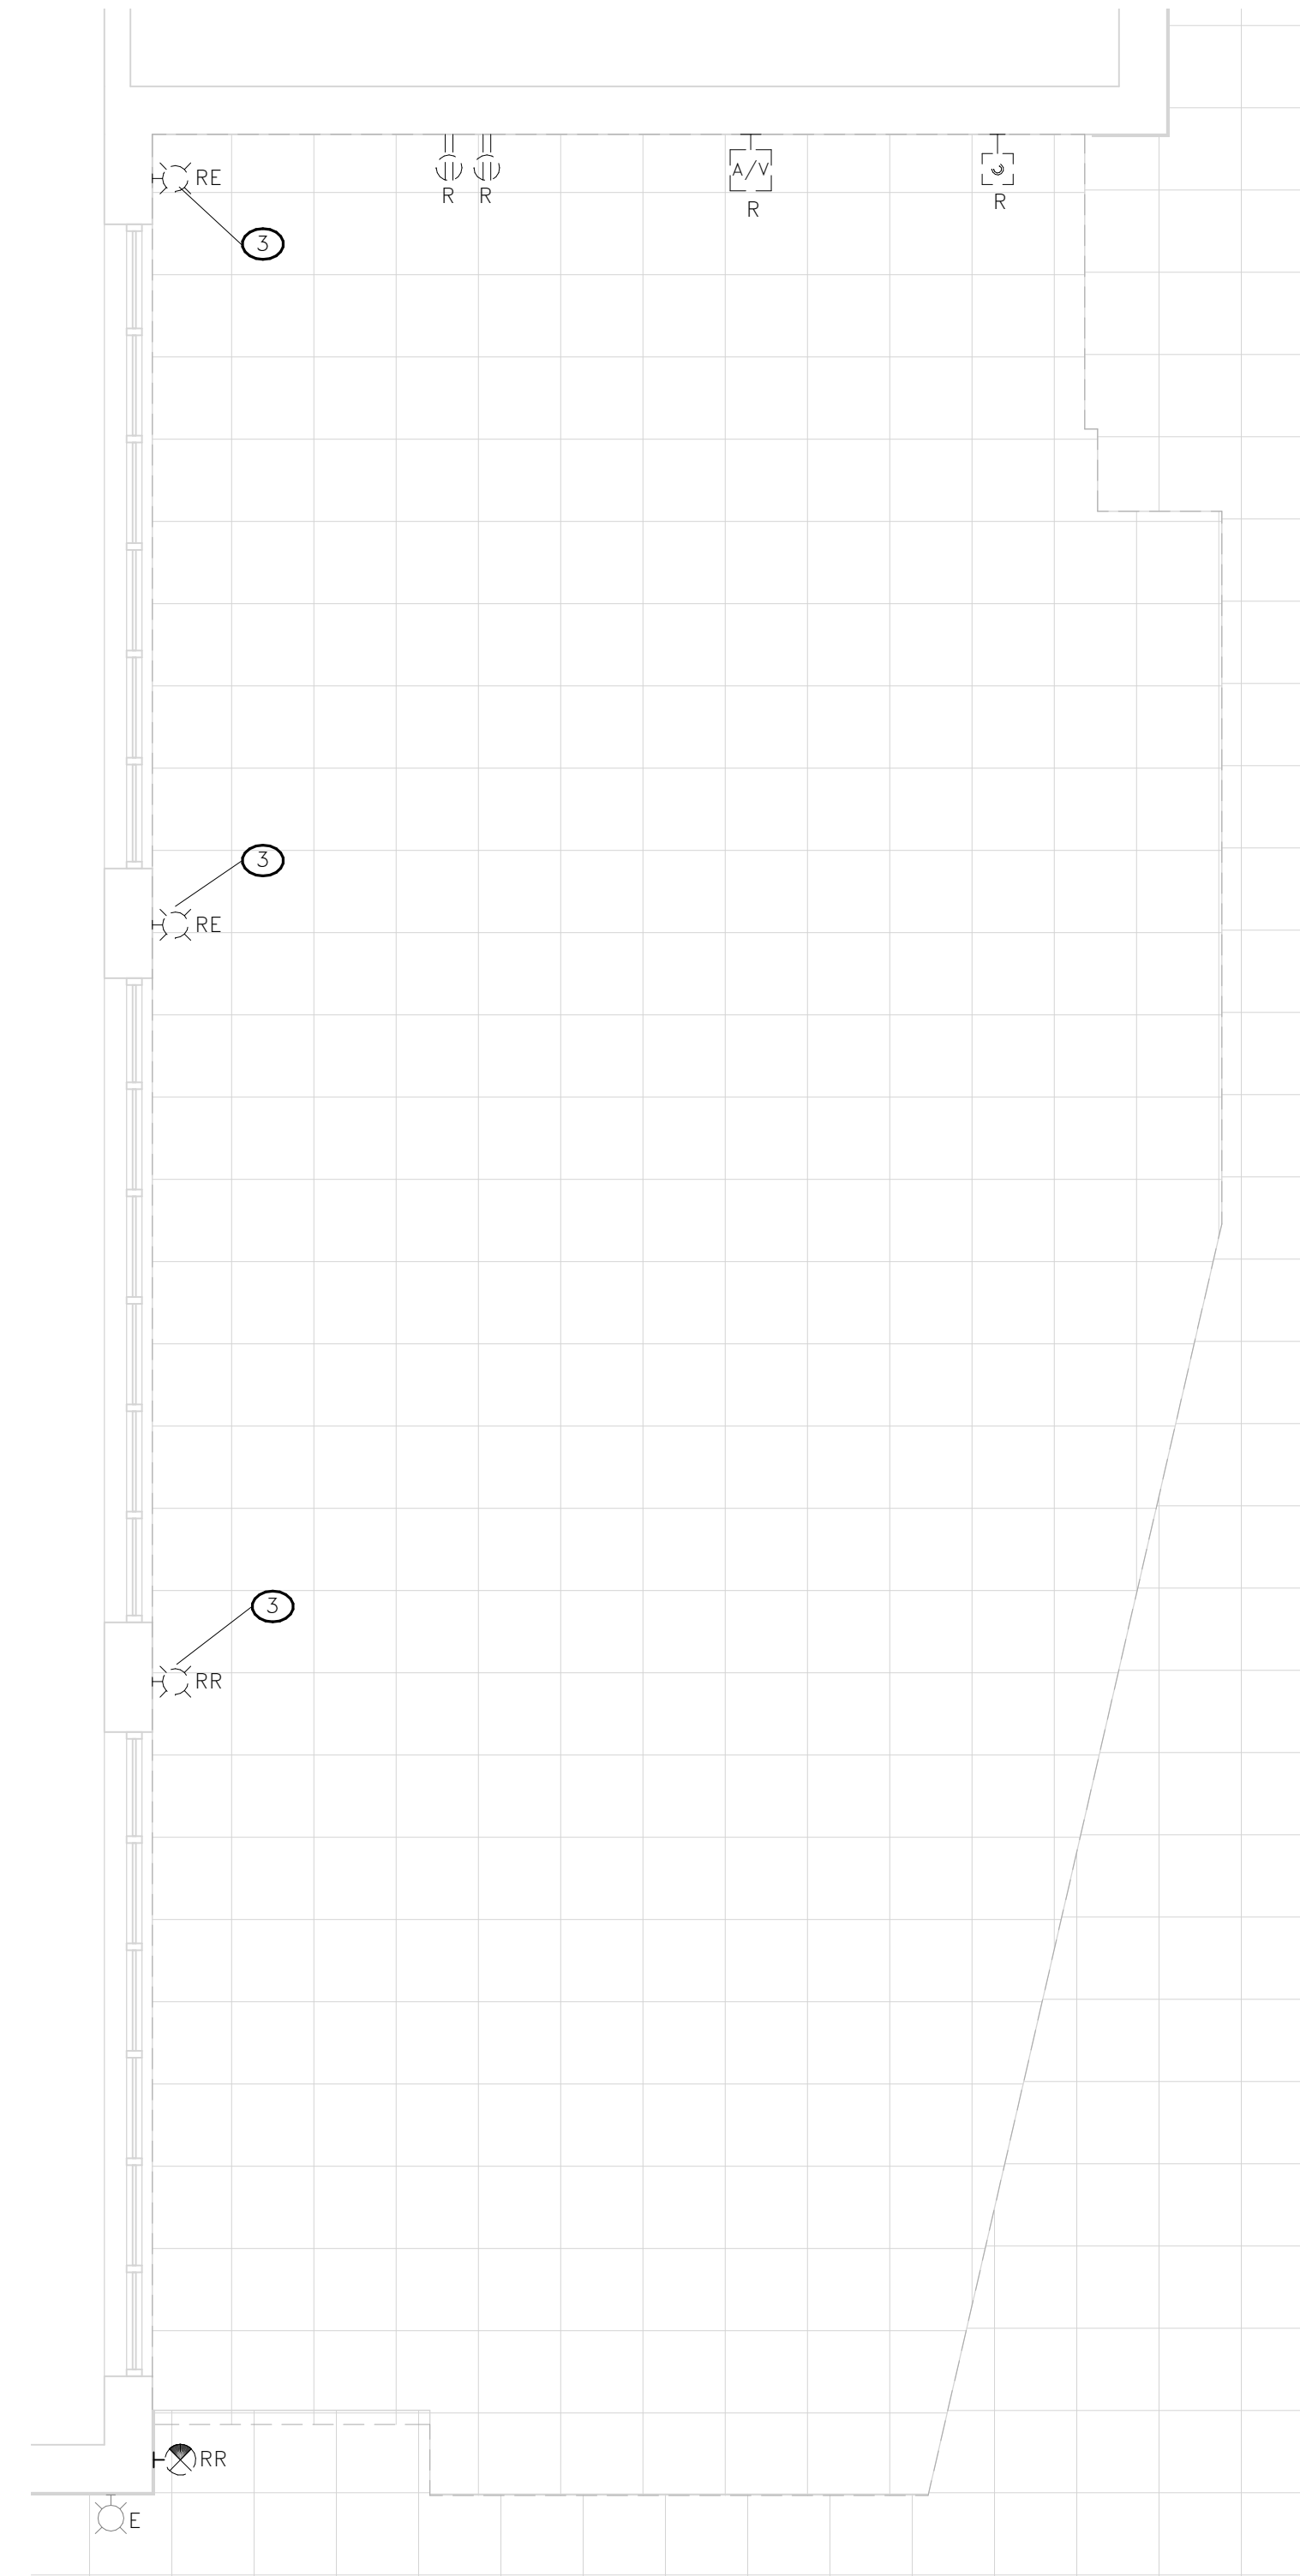

3 MEDIA ROOM POWER/SYSTEMS RENOVATION PLAN
E1.2 SCALE: 1/4" = 1'-0"

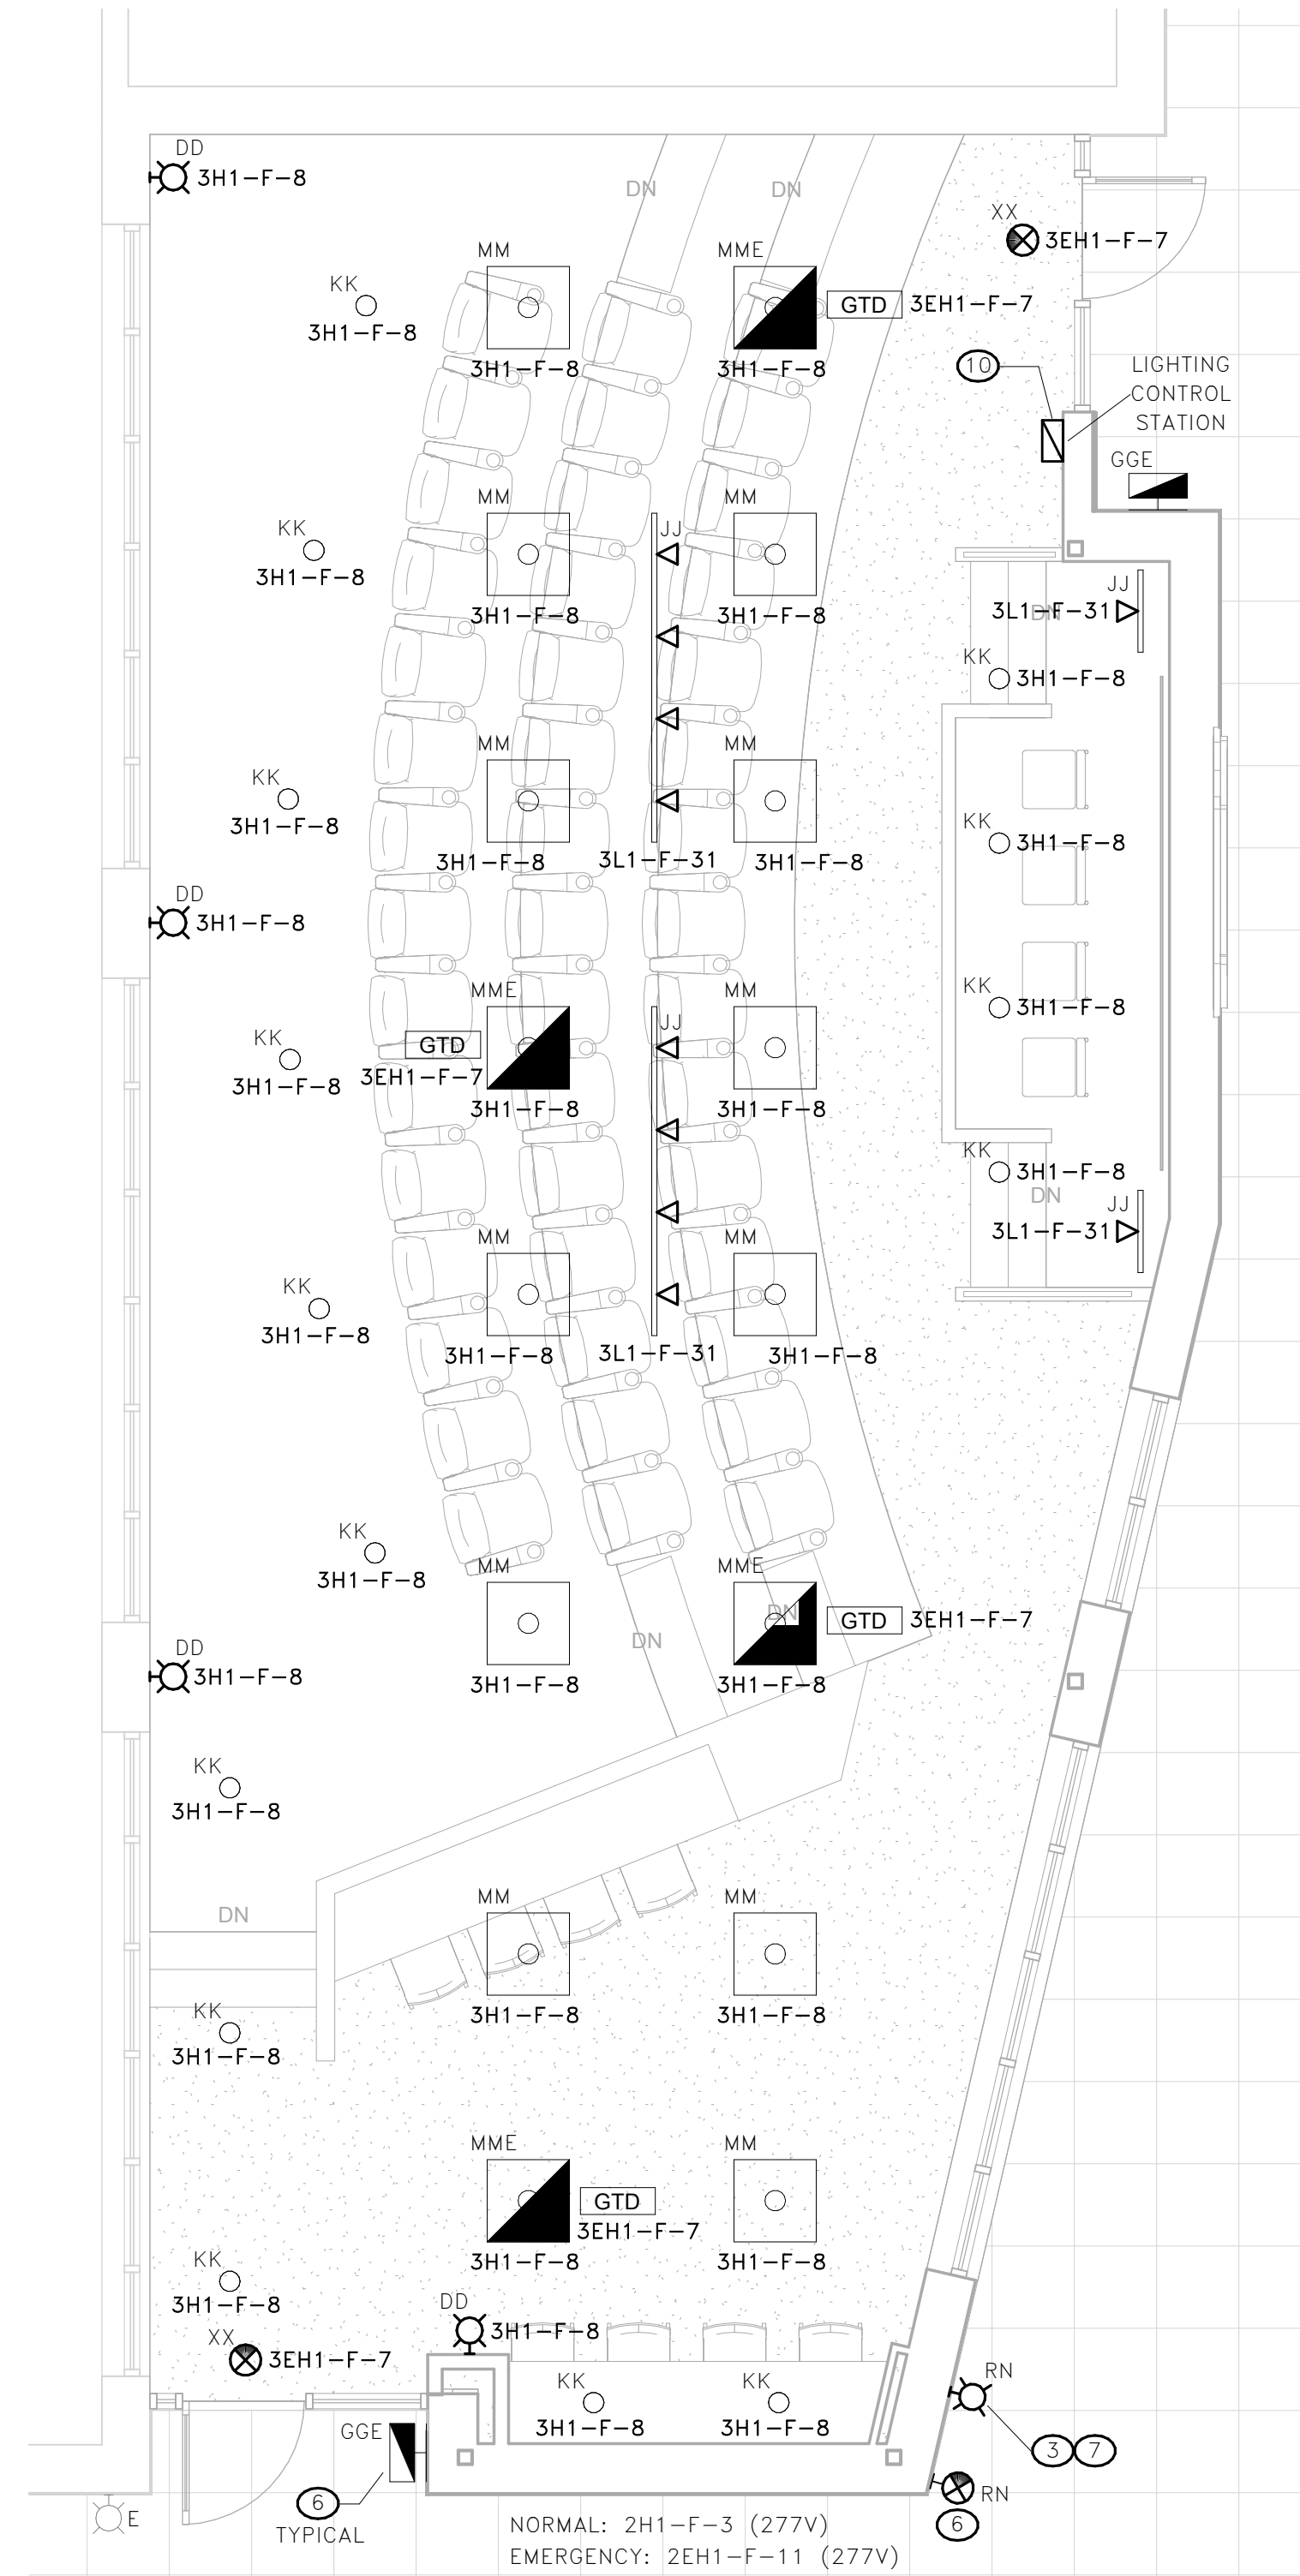

4 ONE-LINE DIAGRAM
E1.2 SCALE: 12" = 1'-0"

UNIT I.D.	ELECTRICAL					NOTES
	VOLTS	# OF POLES	AMPS	NEMA	LOAD (VA)	
MOTORIZED SCREEN	120 V	1			1600	3
MOTORIZED SCREEN	120 V	1			1600	3
RTU-1	480 V	3	60 A	M	34917	1, 2


- EQUIPMENT CONNECTION SCHEDULE NOTES**
- ALL SWITCHES SHALL BE GENERAL DUTY TYPE, FUSIBLE UNLESS NOTED WITH "NF" (NON-FUSIBLE).
 - "M" DENOTES DISCONNECT SWITCH INTEGRAL WITH MECHANICAL EQUIPMENT.
 - MOTOR RATED SNAP SWITCH.

KEY NOTES

- PROVIDE NEW FIRE ALARM AUDIO/VISUAL DEVICE (110cd) IN THIS LOCATION. CONNECT TO EXISTING FIRE ALARM SYSTEM.
- PROVIDE NEW DUCT DETECTOR IN RTU-1. COORDINATE EXACT LOCATION OF DETECTOR AND CORRESPONDING TEST STATION WITH MECHANICAL. CONNECT TO EXISTING FIRE ALARM SYSTEM.
- REMOVE THREE (3) EXISTING EXTERIOR LIGHT FIXTURES. ONE (1) SHALL BE RELOCATED AND TWO (2) SHALL BE TURNED OVER TO OWNER.
- PROVIDE CONDUIT STUB UPS FOR SEATING POWER RECEPTACLES. COORDINATE WITH SEATING SHOP DRAWINGS AND ARCHITECT BEFORE ROUGH-IN.
- PROVIDE TV BACKBOX (CHIEF# PACS26 OR APPROVED EQUAL) WITH ONE 20 AMP DUPLEX RECEPTACLE AND ONE DATA OUTLET. (SAME AS E1.1)
- EXTEND EXISTING EXTERIOR LIGHTING CIRCUIT TO SERVE NOTED LIGHTING FIXTURES. EXISTING PLANS INDICATE THIS CIRCUIT TO BE 3EH1-F-5. CONTRACTOR SHALL FIELD VERIFY. NEED EMERGENCY (GEN-BACKED) CIRCUIT WITH GTD TOO.
- EXTEND EXISTING EXTERIOR LIGHTING CIRCUIT TO SERVE NOTED LIGHTING FIXTURES. EXISTING PLANS INDICATED THIS CIRCUIT TO BE 3EH1-F-7. CONTRACTOR SHALL FIELD VERIFY.
- CONVENIENCE OUTLET INTEGRAL WITH AND POWERED BY MECHANICAL UNIT.
- PROVIDE MULTI-SOURCE FLOORBOX (WIREMOLD EFB45 OR APPROVED EQUAL.)
- LIGHTING CONTROL SYSTEM AS FOLLOWS: PLATFORM DOWNLIGHT, PLATFORM FRONT SPOTLIGHTS, PLATFORM REAR SPOTLIGHTS, 2X2 FIXTURES, GENERAL DOWNLIGHTS.

GENERAL NOTES

- CIRCUIT NUMBERS ARE DIAGRAMMATICAL ONLY AND CONTRACTOR SHALL FIELD VERIFY AVAILABLE CIRCUITS. SEE SHEET E1.0 FOR PANEL LOCATION.
- ELECTRICAL CONTRACTOR SHALL PROVIDE GENERATOR-TRANSFER DEVICES (GTDs) FOR ALL EMERGENCY FIXTURES SHOWN ON THIS PLAN.

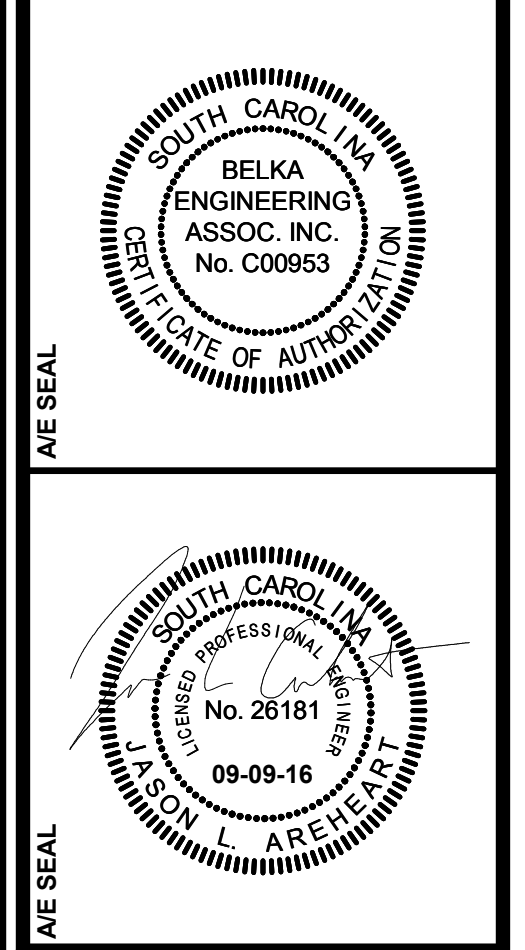

FOUNDERS PARK PLAYER'S LOUNGE RENOVATION AND MEDIA ROOM ADDITION
431 WILLIAMS STREET
COLUMBIA, SC 29201


NO.	NAME	DATE

JUS
CES
DRAWN BY:
CHECKED BY:


CLUB LEVEL ELECTRICAL PLANS

PROJECT NO. 142E18
DATE 08/08/18
DRAWING NO. **E1.2**


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(803) 731-0650 fax (803) 731-2880
Cliff Stringfield
EMAIL: C.EStringfield@belksouth.net

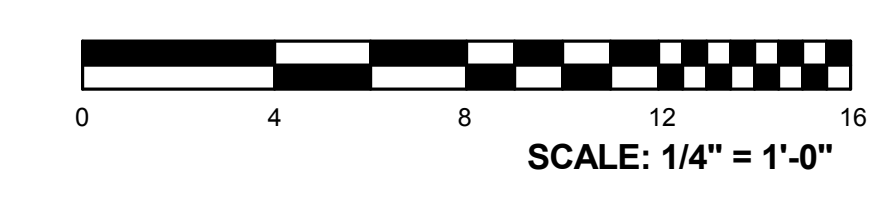


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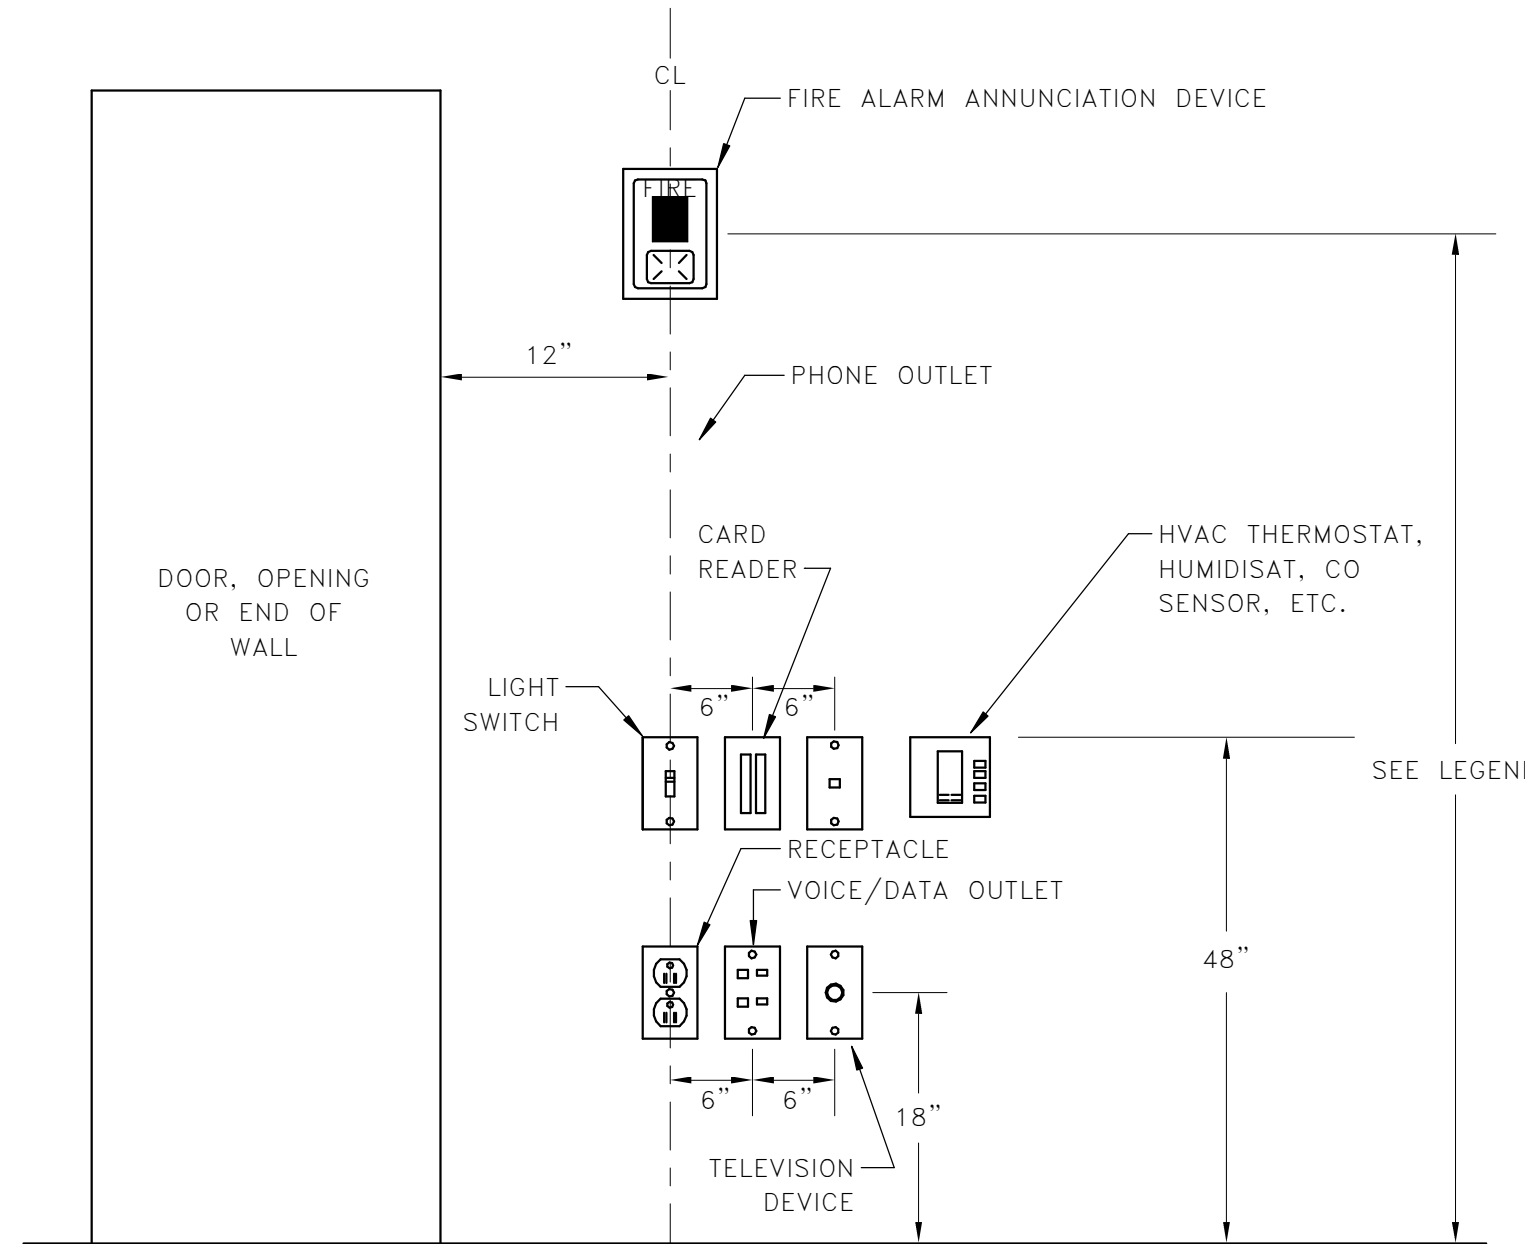
1 KITCHEN ELEVATION - NORTH
E2.1 SCALE: 1/2" = 1'-0"

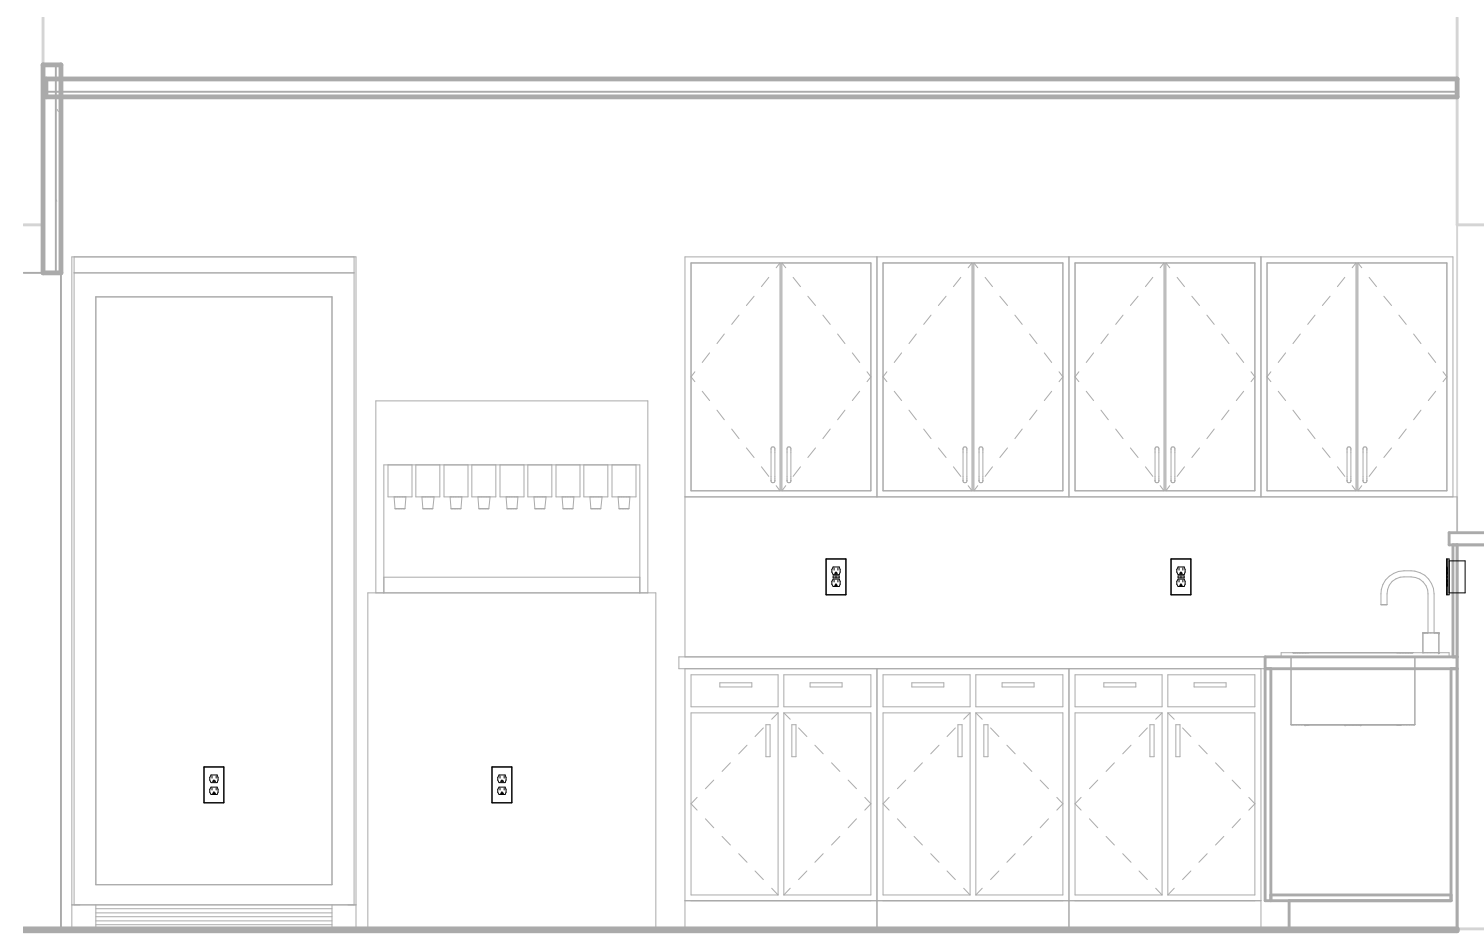

2 KITCHEN ELEVATION - EAST
E2.1 SCALE: 1/2" = 1'-0"

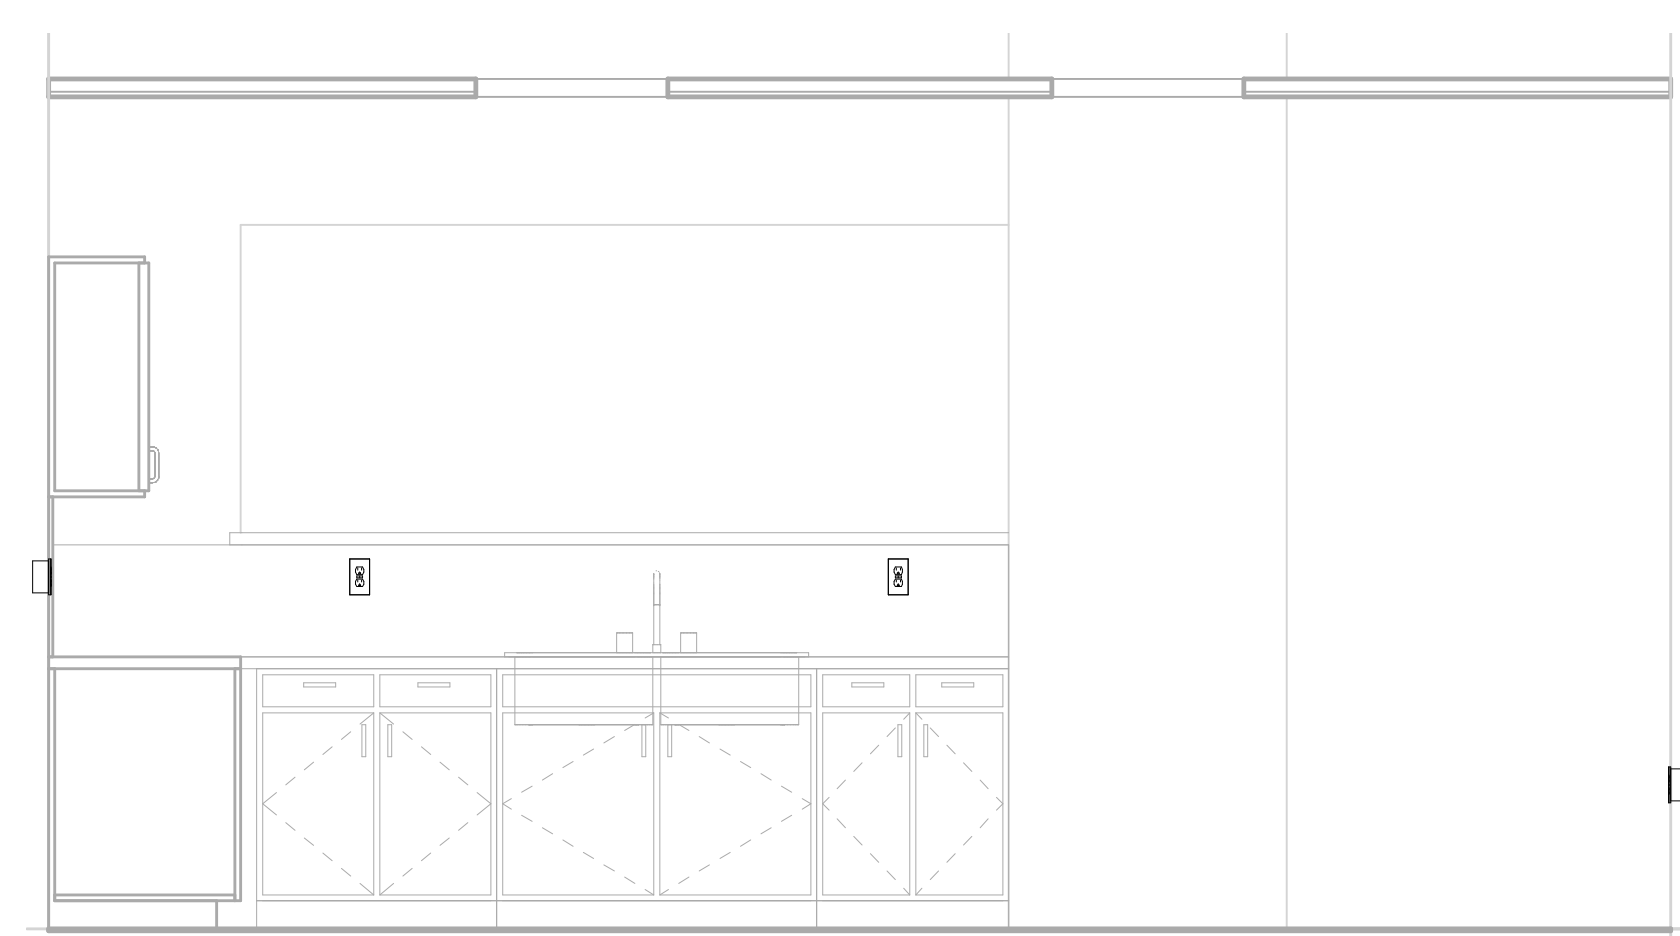


3 KITCHEN ELEVATION - WEST
E2.1 SCALE: 1/2" = 1'-0"

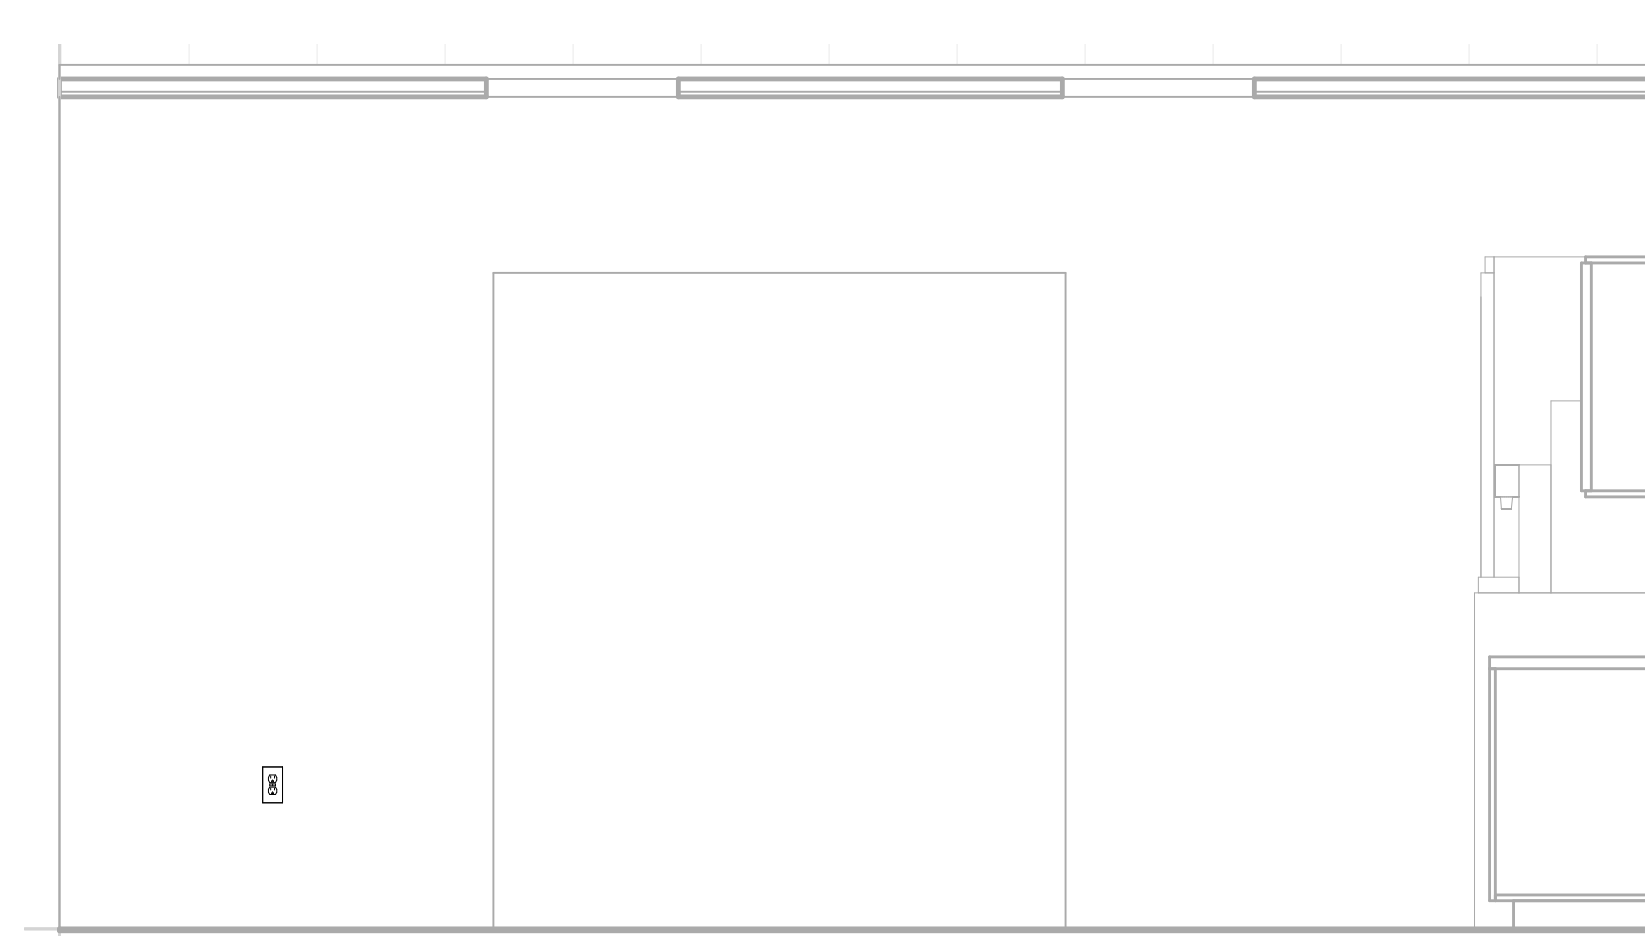

NOTE: DEVICES SHOWN WITHIN 48" OF EACH OTHER ON ALL ELECTRICAL PLANS SHALL BE ALIGNED PER THIS DETAIL. IF DEVICES ARE SHOWN IN MIDDLE OF WALL, THEN CENTER DEVICES ON WALL.

4 DEVICE ALIGNMENT DETAIL
E2.1 SCALE: 12" = 1'-0"

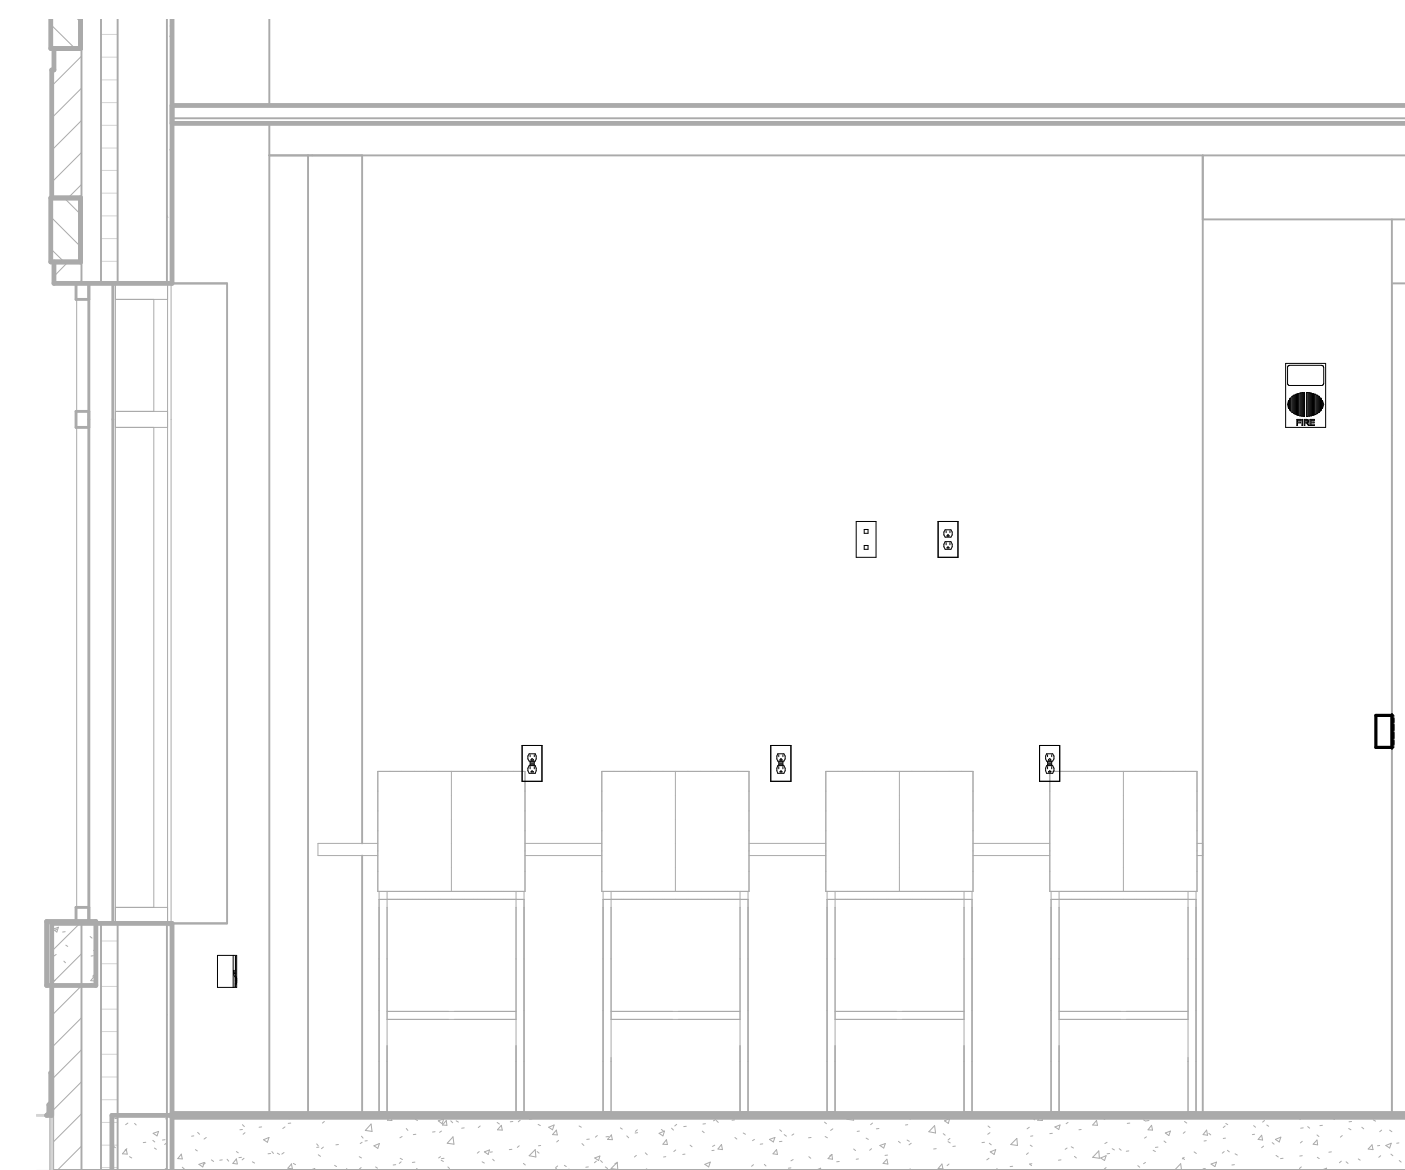


5 MEDIA ELEVATION - SOUTH
E2.1 SCALE: 1/2" = 1'-0"



6 MEDIA ELEVATION - NORTH
E2.1 SCALE: 1/2" = 1'-0"

DOOR DETAIL SYMBOLOGY	
DEVICES	
①	20 AMP SINGLE POLE TOGGLE SWITCH.
②	FIRE ALARM ADDRESSABLE INTERFACE UNIT/CONTROL RELAY.
③	DOOR LOCK POWER SUPPLY, FURNISHED BY DOOR HARDWARE SUPPLIER.
④	12" X 12" X 6" NEMA1 JUNCTION BOX WITH A 3/4" INTERIOR GRADE A FIRE RETARDANT BACKBOARD, SEE DETAIL 4 ON THIS SHEET.
⑤	ELECTRIC LOCK TRIM, FURNISHED BY HARDWARE SUPPLIER.
⑥	ACCESS CONTROL CARD READER MOUNTED ON UNSECURE SIDE OF DOOR/GATE. FIELD VERIFY LOCATION WITH ARCHITECT. READER PROVIDED BY SECURITY CONTRACTOR.
⑦	DOOR MOUNTED ELECTRIC POWER TRANSFER DEVICE, FURNISHED BY DOOR HARDWARE SUPPLIER.
⑧	MAGNETIC DOOR POSITION SWITCH, FURNISHED BY DOOR HARDWARE SUPPLIER.
⑨	ELECTRIC STRIKE, FURNISHED BY DOOR HARDWARE SUPPLIER.
⑩	EGRESS HARDWARE WITH INTEGRAL ELECTRIC LATCH RETRACTION AND REX SWITCH, FURNISHED BY DOOR HARDWARE SUPPLIER.
⑪	INFRARED SENSOR, FURNISHED BY DOOR HARDWARE SUPPLIER.
⑫	PINNED FLUSH BOLTED NORMALLY NON-ACTIVE DOOR. FIELD VERIFY LOCATION WITH ARCHITECT.
⑬	JUNCTION BOX WITH GENETEC INTERFACE MODULE.
CONDUIT/CABLE	
⬠	120 VAC: 1/2" EMT WITH THREE #12 AWG THHN/THWN WIRES TO ACCESS CONTROL BACKBOARD/PANEL.
⬠	FIRE ALARM CONTROL: 1/2" EMT RUN TO FIRE ALARM SIGNALING LINE AND POWER CIRCUITS.
⬠	CABINET INTERCONNECTION: 1" EMT RUN BETWEEN ACCESS CONTROL CABINETS AND LOCAL JUNCTION BOX.
⬠	FIRE ALARM INTERFACE: 1/2" EMT.
⬠	CARD READER: 1" EMT RUN WITH ONE ALPHA #5198 CABLE.
⬠	DOOR LOCK POWER AND REX SWITCH COMBINED: 3/4" EMT.
⬠	DOOR POSITION SWITCH: 1/2" EMT.
⬠	GENETEC INTERFACE MODULE: 3/4" EMT. SWITCH BY SECURITY CONTRACTOR.

ACCESS CONTROL NOTES	
1.	DOOR LOCK POWER SUPPLIES FOR DOOR HARDWARE SHALL BE FURNISHED BY THE DOOR HARDWARE SUPPLIER. ELECTRICAL CONTRACTOR SHALL BE RESPONSIBLE FOR MOUNTING AND WIRING EACH POWER SUPPLY UNIT. FIELD VERIFY LOCATIONS.
2.	ELECTRIC LATCHES, LOCKS AND POWER TRANSFER HINGES SHALL BE FURNISHED BY THE DOOR HARDWARE SUPPLIER. ELECTRICAL CONTRACTOR SHALL BE RESPONSIBLE FOR PROVIDING WIRING FROM THE JUNCTION BOX ABOVE THE DOOR, THROUGH THE POWER TRANSFER HINGE, TO THE ELECTRIC LATCH. ELECTRICAL CONTRACTOR SHALL PROVIDE ALL DRILLING REQUIRED TO INSTALL WIRING IN FRAMES AND DOORS. ELECTRICAL CONTRACTOR SHALL BE RESPONSIBLE FOR REMOVING AND RE-INSTALLING HARDWARE AND DOOR COMPONENTS AS REQUIRED TO INSTALL WIRING AND MAKE REQUIRED ADJUSTMENTS.
3.	COORDINATE WITH DOOR HARDWARE AND DOOR FRAME MANUFACTURERS TO ENSURE THAT PROPERLY SIZED ELECTRICAL BACKBOXES ARE PROVIDED FOR EACH POWER TRANSFER HINGE AND EACH MAGNETIC DOOR POSITION SWITCH.
4.	ALL ACCESS CONTROL SYSTEM WIRES AND CABLES SHALL BE INSTALLED IN RACEWAY. LABEL ALL WIRES AND CABLES AT EACH END.
5.	ACCESS CONTROL SYSTEM RACEWAYS SHALL BE CONCEALED IN WALLS AND ABOVE ACOUSTICAL DROP CEILING. RACEWAYS MAY BE INSTALLED EXPOSED IN EQUIPMENT ROOMS. LABEL ALL RACEWAYS AT EACH END.
6.	EDGE PROTECTION: ELECTRICAL CONTRACTOR SHALL BE RESPONSIBLE FOR PROVIDING EDGE PROTECTION FOR DOORS, DOOR FRAMES, DOOR HARDWARE, AND RACEWAYS ASSOCIATED WITH ACCESS CONTROL SYSTEM WIRING. RUBBER GROMMETS AND/OR FOAM-IN-PLACE TYPE PROTECTION SHALL BE PROVIDED. EDGE PROTECTION METHODS SHALL NOT INHIBIT FUTURE REPLACEMENT OF WIRING. CABLES WITH DAMAGED INSULATION AND/OR OUTER JACKETS SHALL BE COMPLETELY REPLACED AT THE ELECTRICAL CONTRACTOR'S EXPENSE; ELECTRICAL SHALL NOT ATTEMPT TO REPAIR DAMAGED CABLES.
7.	SPLICES IN ACCESS CONTROL WIRING SHALL BE KEPT TO A MINIMUM. WHERE SPLICES ARE REQUIRED TO CONNECT PIGTAIL WIRING TO FIELD CABLES, ELECTRICAL CONTRACTOR SHALL USE THE COMBINATION OF AN INSULATED BUTT-SPLICE CONNECTOR AND HEAT-SHRINKABLE TUBING FOR EACH SPLICE. EACH SPLICED CIRCUIT SHALL BE PROPERLY TESTED FOR CONTINUITY.
8.	FIRE ALARM SYSTEM: PROVIDE PROGRAMMING FOR FIRE ALARM CONTROL PANEL AS REQUIRED TO CAUSE ACCESS CONTROLLED DOORS TO BE RELEASED (UNLOCKED) WHEN A GENERAL FIRE ALARM OCCURS.
9.	INDIVIDUAL DOOR DETAILS DEPICT DOORS AS SEEN FROM SECURE SIDE OF DOOR. VERIFY ALL DOOR CONFIGURATIONS PRIOR TO ROUGH-IN TO ENSURE BACKBOXES AND CONDUITS ARE PLACED FOR ALL DEVICES NECESSARY FOR A FULLY FUNCTIONAL SYSTEM.
10.	SEE PLAN NOTES. SOME OF THE ELECTRIC STRIKE LOCATIONS ARE GROUPED ON A COMMON POWER SUPPLY.

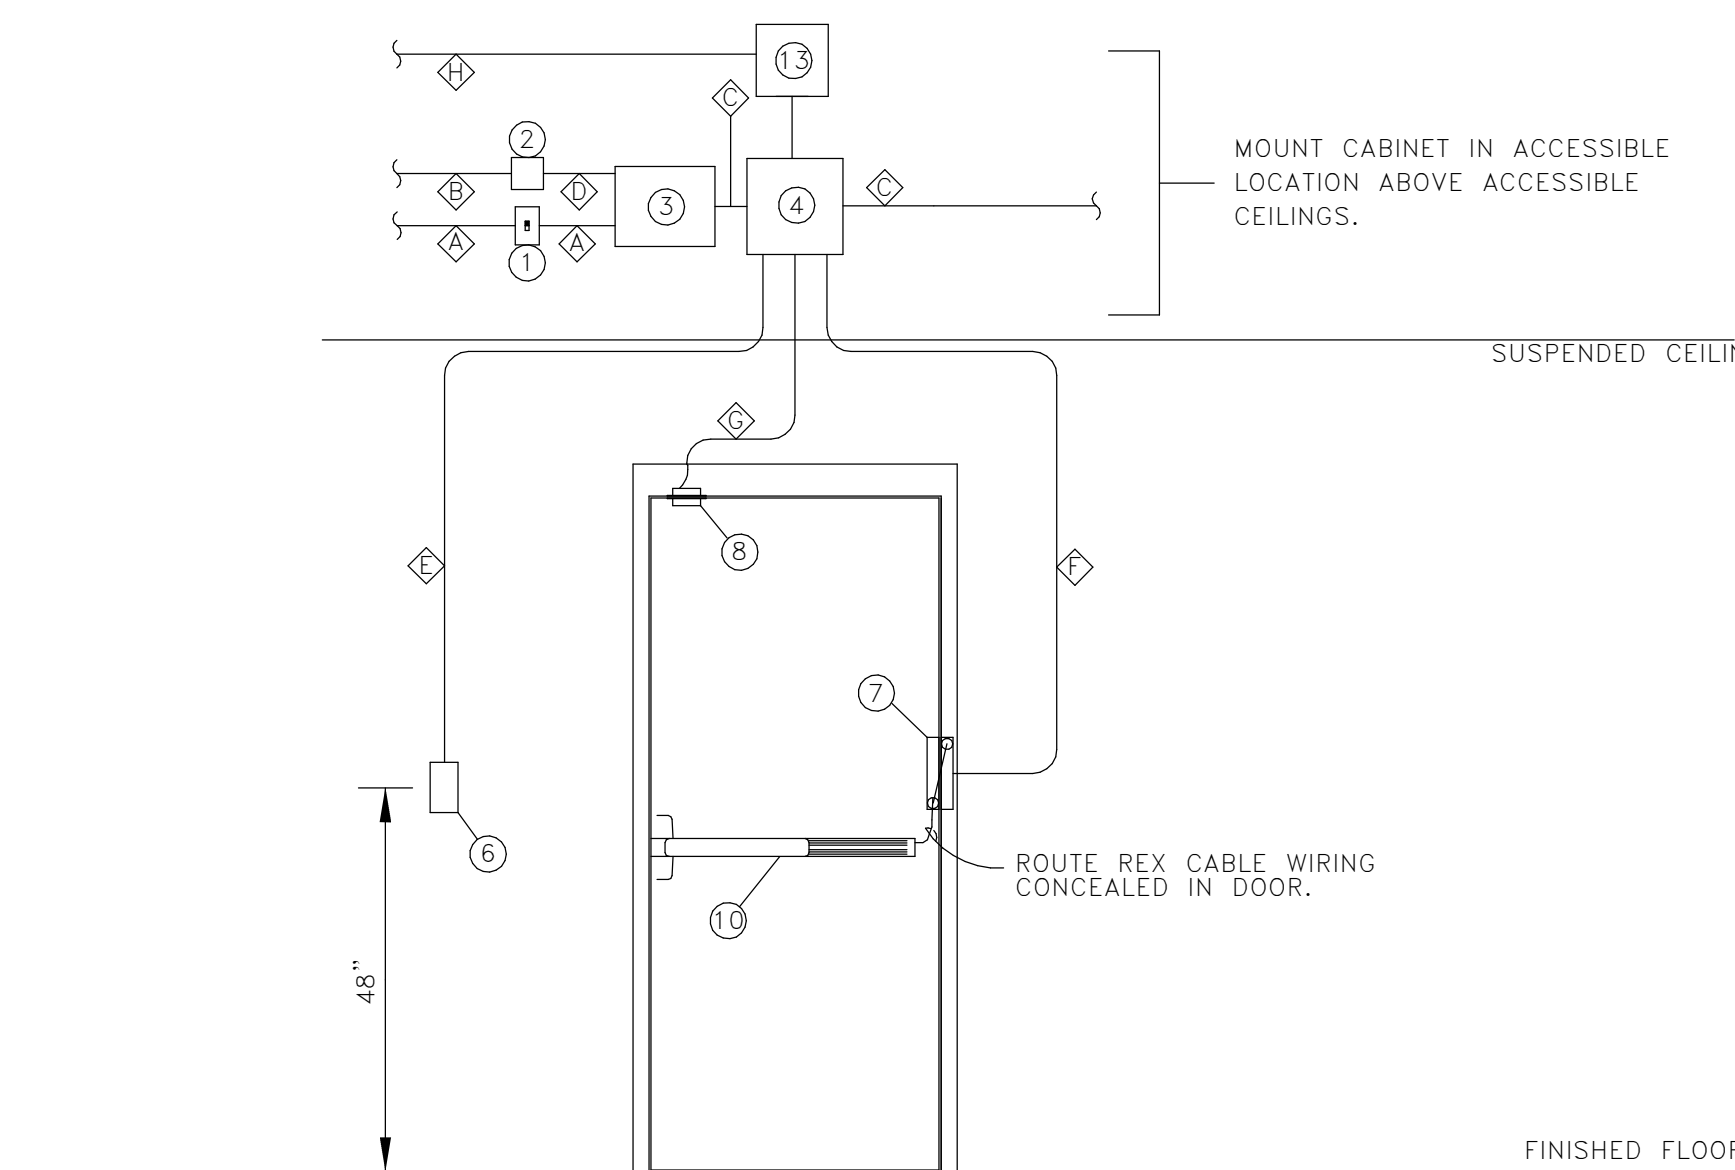


7 ELECTRIC LATCH TYPICAL SINGLE DOOR DETAIL ACCESS CONTROLLED DOORS
E2.1 SCALE: NOT TO SCALE

KEY NOTES

GENERAL NOTES

- 1
- 2
- 3
- 4
- 5

BEA BELKA ENGINEERING ASSOCIATES, INC.
7 CLUSTERS COURT, SUITE 201
COLUMBIA, SOUTH CAROLINA 29210
(803) 731-0650 fax (803) 731-2880
Cliff Stringfield
EMAIL: CStringfield@belsouth.net

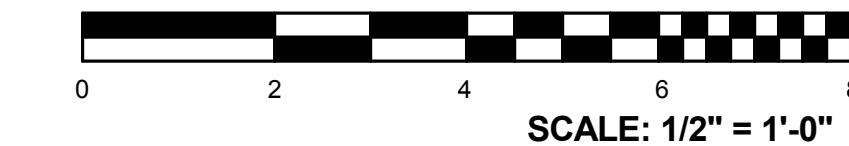

GARVIN DESIGN GROUP
803.212.1032 p / 803.212.1041 f
Columbia, SC 29902
1209 Lincoln Street P.O. Box 18

SOUTH CAROLINA PROFESSIONAL ENGINEERING ASSOCIATION
No. C00953
STATE OF AUTHORITY

SOUTH CAROLINA PROFESSIONAL ENGINEERING ASSOCIATION
No. 2616
09-09-16
STATE OF AUTHORITY

PROJECT TITLE
FOUNDERS PARK PLAYER'S LOUNGE RENOVATION AND MEDIA ROOM ADDITION
431 WILLIAMS STREET
COLUMBIA, SC 29201

NO.	NAME	DATE

DESIGNED BY: JJS	CHECKED BY: CES
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DRAWING TITLE
ELECTRICAL ELEVATIONS & DETAILS

PROJECT NO. 142E16
DATE 08/08/16
DRAWING NO. **E2.1**