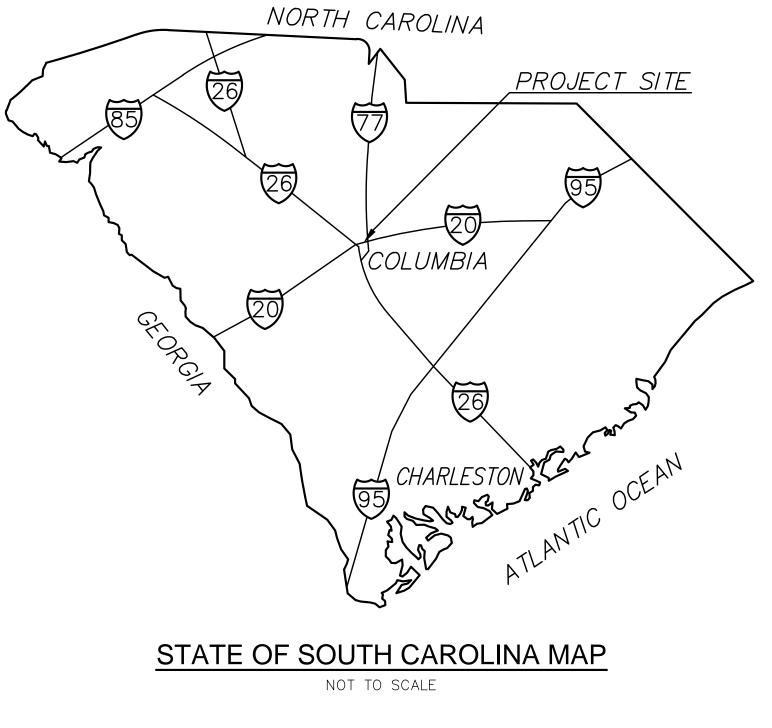
NOTE: IT IS CONTRACTORS RESPONSIBILITY TO VERIFY THEY AND THEIR SUBCONTRACTORS HAVE THE CORRECT/MOST UP-TO-DATE PLANS AVAILABLE

SITE CONSTRUCTION DRAWINGS FOR FUEL TANK ADDITIONS BLOSSOM STREET (WEST ENERGY) **STATE PROJECT NUMBER H27-Z228**



NOTE TO CONTRACTOR: CONTRACTOR SHALL NOTIFY PUPS, METROPOLITAN WATER DISTRICT (864-503-0822) AND USC UPSTATE FACILITIES MANAGEMENT (864-503-5500) A MINIMUM THREE(3) DAYS PRIOR TO DIGGING.

NOTE: INFORMATION REGARDING THE REPUTED PRESENCE, SIZE, CHARACTER AND LOCATION OF

EXISTING UNDERGROUND UTILITIES AND STRUCTURES WAS OBTAINED FROM LOCAL UTILITY COMPANIES AND AVAILABLE DRAWINGS SUPPLIED BY THE OWNER AND IS SHOWN HEREON. THERE IS NO CERTAINTY OF THE ACCURACY OF THIS INFORMATION AND IT SHALL BE CONSIDERED IN THAT LIGHT BY THOSE USING THIS DRAWING, HOWEVER, COX and DINKINS, INC. HAS NO NOTICE OR KNOWLEDGE OF ANY FACTS THAT WOULD LEAD US TO CONCLUDE THAT THE INFORMATION IS NOT ACCURATE. BUT UTILITIES AND STRUCTURES NOT SHOWN MAY BE ENCOUNTERED, THE OWNER. HIS EMPLOYEES. HIS CONSULTANTS. HIS ASSIGNS AND HIS CONTRACTORS SHALL HEREBY DISTINCTLY UNDERSTAND THAT COX and DINKINS, INC. IS NOT RESPONSIBLE FOR THE CORRECTNESS OR SUFFICIENCY OF THE UNDERGROUND INFORMATION. INFORMATION WITH RESPECT TO ABOVE GROUND MONUMENTS OF SUCH UTILITIES IS BASED UPON ACTUAL FIELD MEASUREMENTS AND OBSERVATIONS, AND IS SHOWN HEREON.



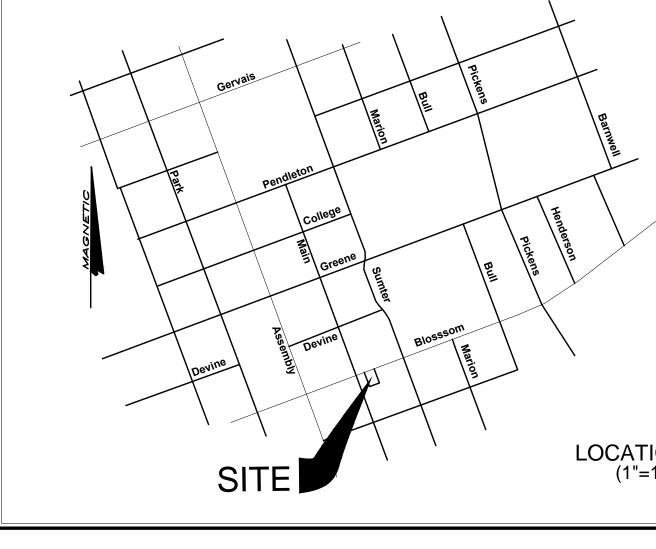
PREPARED FOR:

UNIVERSITY OF SOUTH CAROLINA

FACILITIES DESIGN AND CONSTRUCTION 743 GREENE STREET COLUMBIA, SOUTH CAROLINA 29208 803.777.3126

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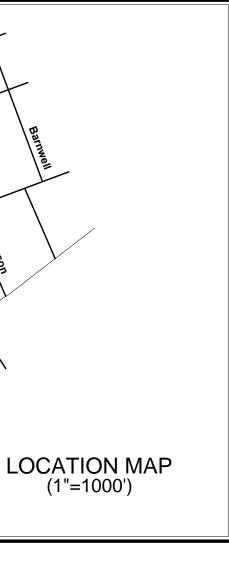




COX AND DINKINS, INC 724 BELTLINE BLVD. COLUMBIA, SC 29205 803-254-0518 Fax: 803-765-0993 Email: cdinc@coxanddinkins.cor S PLANNING NSTRUCTION 31A, SC 29208

CAMPUS AND CONS columbia, COX AND DINKINS, INC No. C00294 -2016 \mathcal{D} • = \bigcirc Σ' \mathcal{A} ADDITIONS T (WEST ENER \rightarrow DITY, CITY OF COVER of Sout TANK \bigcirc FUEL \geq \rightarrow LS1. \mathbb{O} • 🛏 Д SHEET

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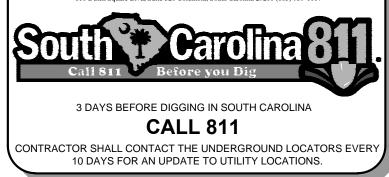


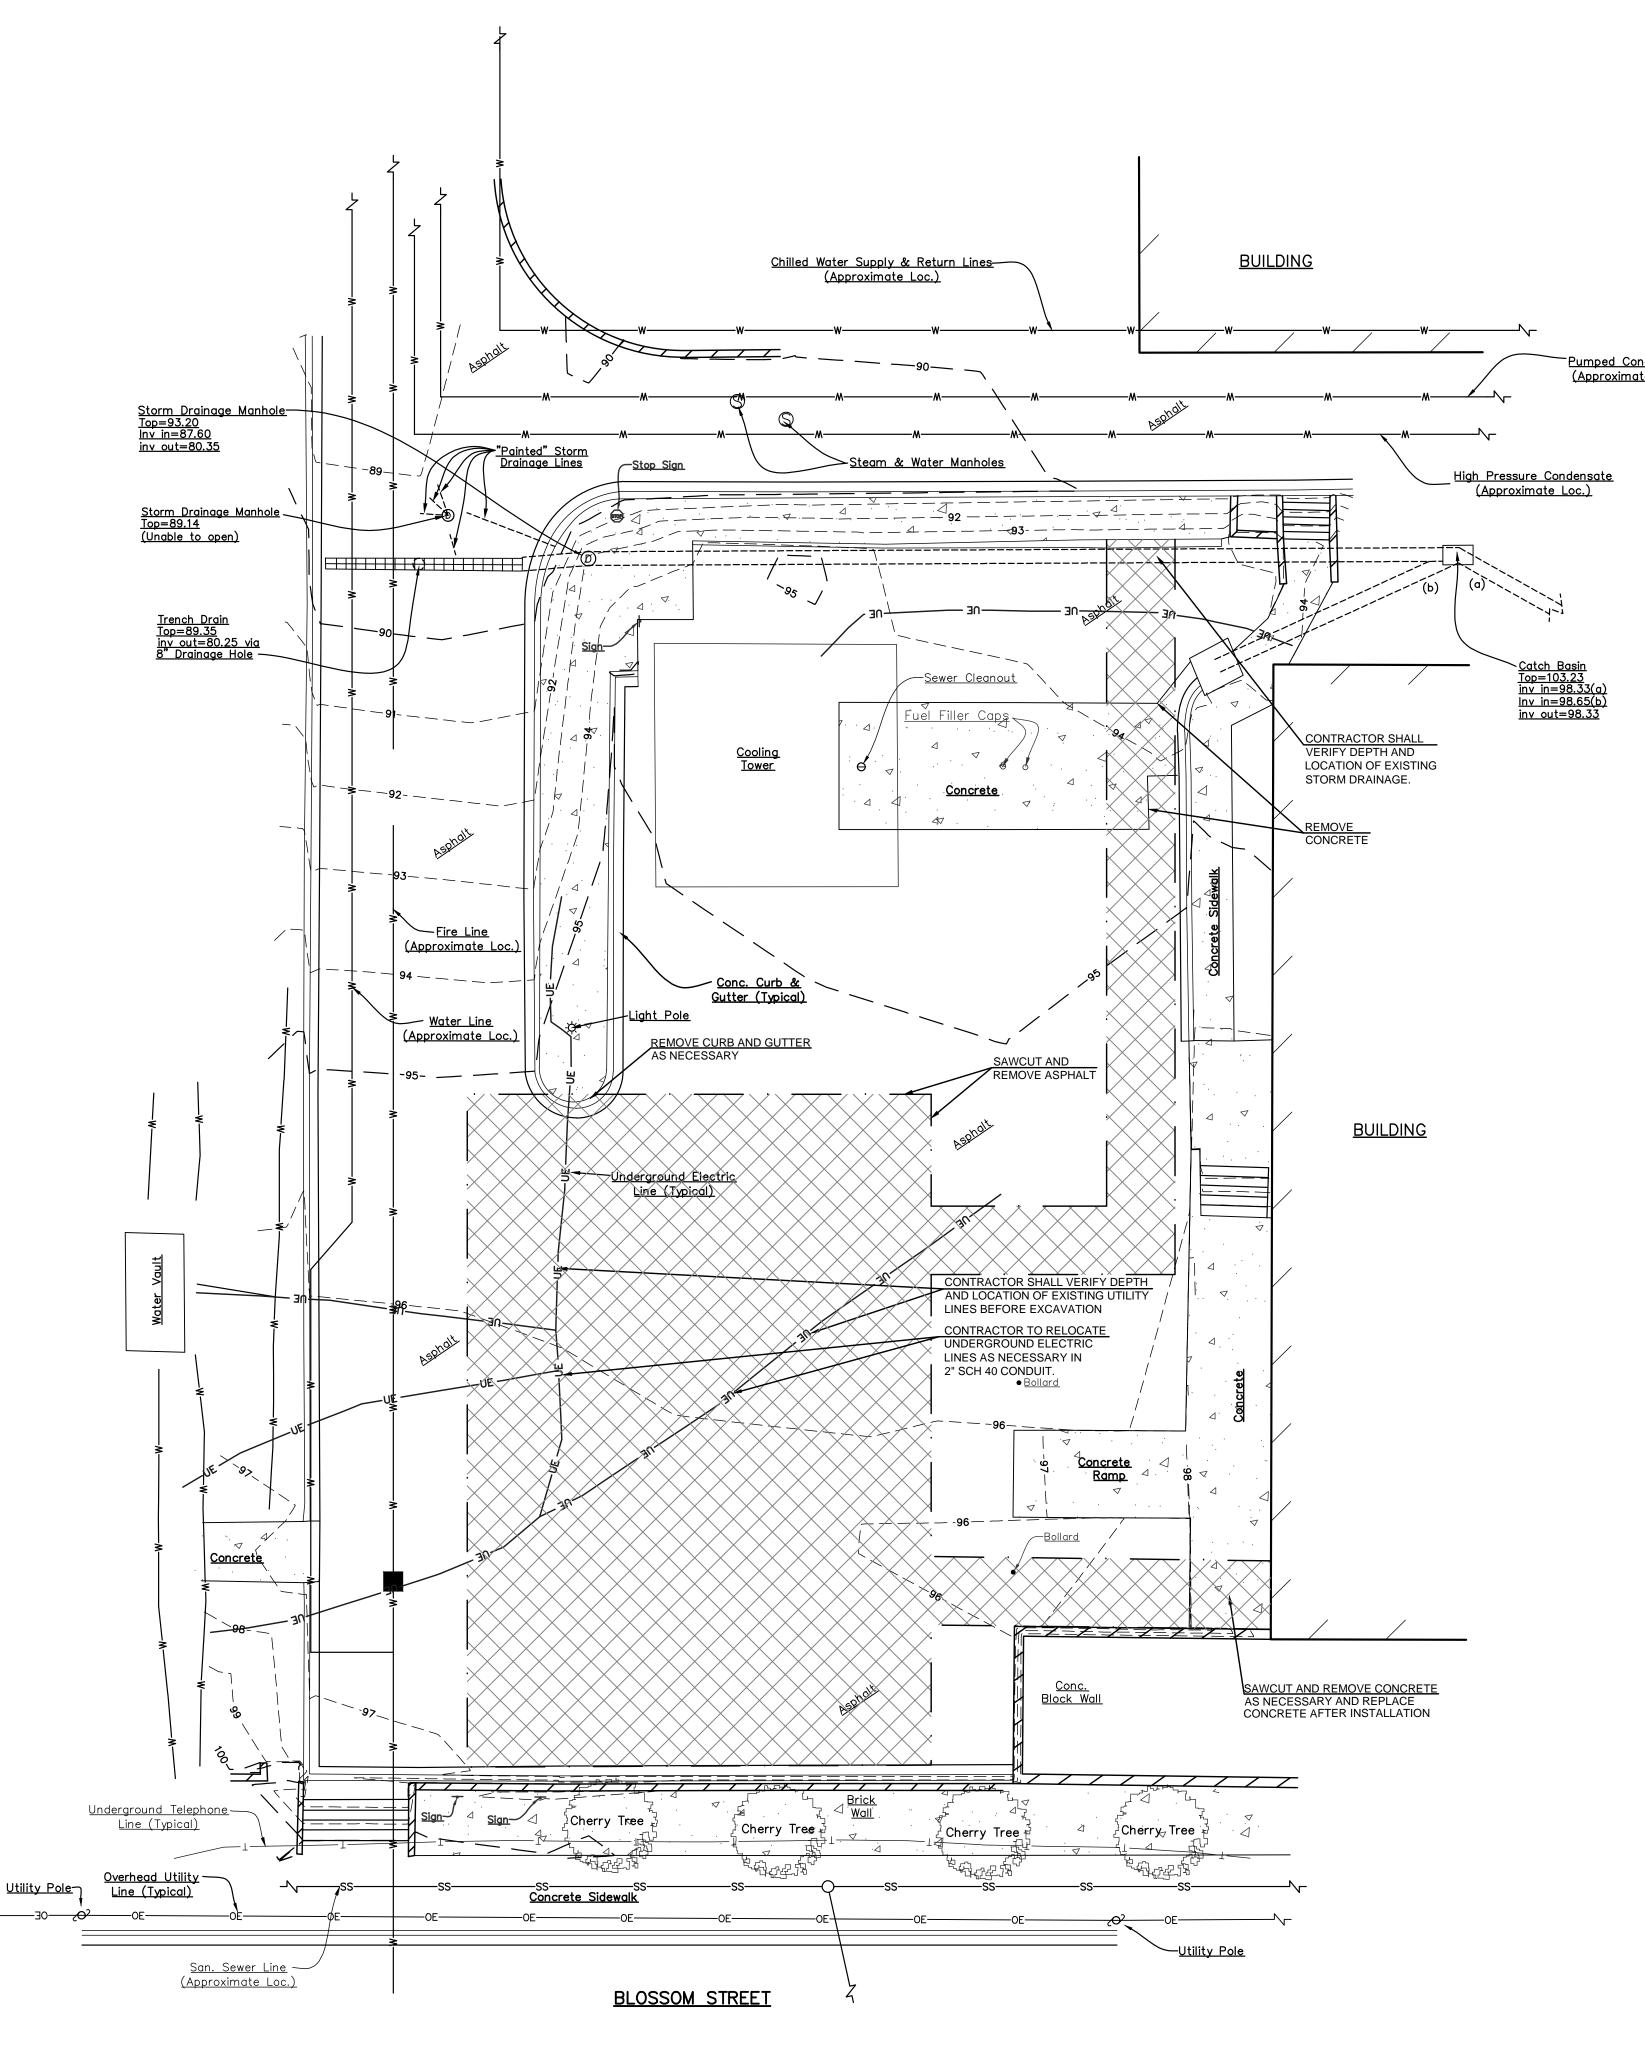
The	Utility Protect, , Suite 320 Columbia, South Ca		
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3 DAYS BEFORE DIGGING IN SOUTH CAROLINA CALL 811 CONTRACTOR SHALL CONTACT THE UNDERGROUND LOCATORS EVERY 10 DAYS FOR AN UPDATE TO UTILITY LOCATIONS.

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The Palmetto Utility Protection Service, Inc. 810 Dutch Square Blvd, Suite 320 Columbia, South Carolina 29210 (803) 939-1117





GENERAL NOTES:

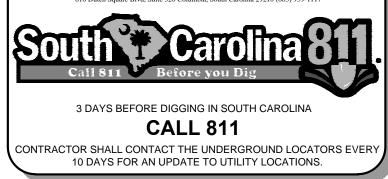
1. UTILITIES SHOWN WERE LOCATED BY GROUND PENETRATING RADAR. THE LOCATION OF UNDERGROUND UTILITIES IS NOT GUARANTEED AND THE CONTRACTOR IS RESPONSIBLE FOR FIELD VERIFYING ALL UTILITIES.

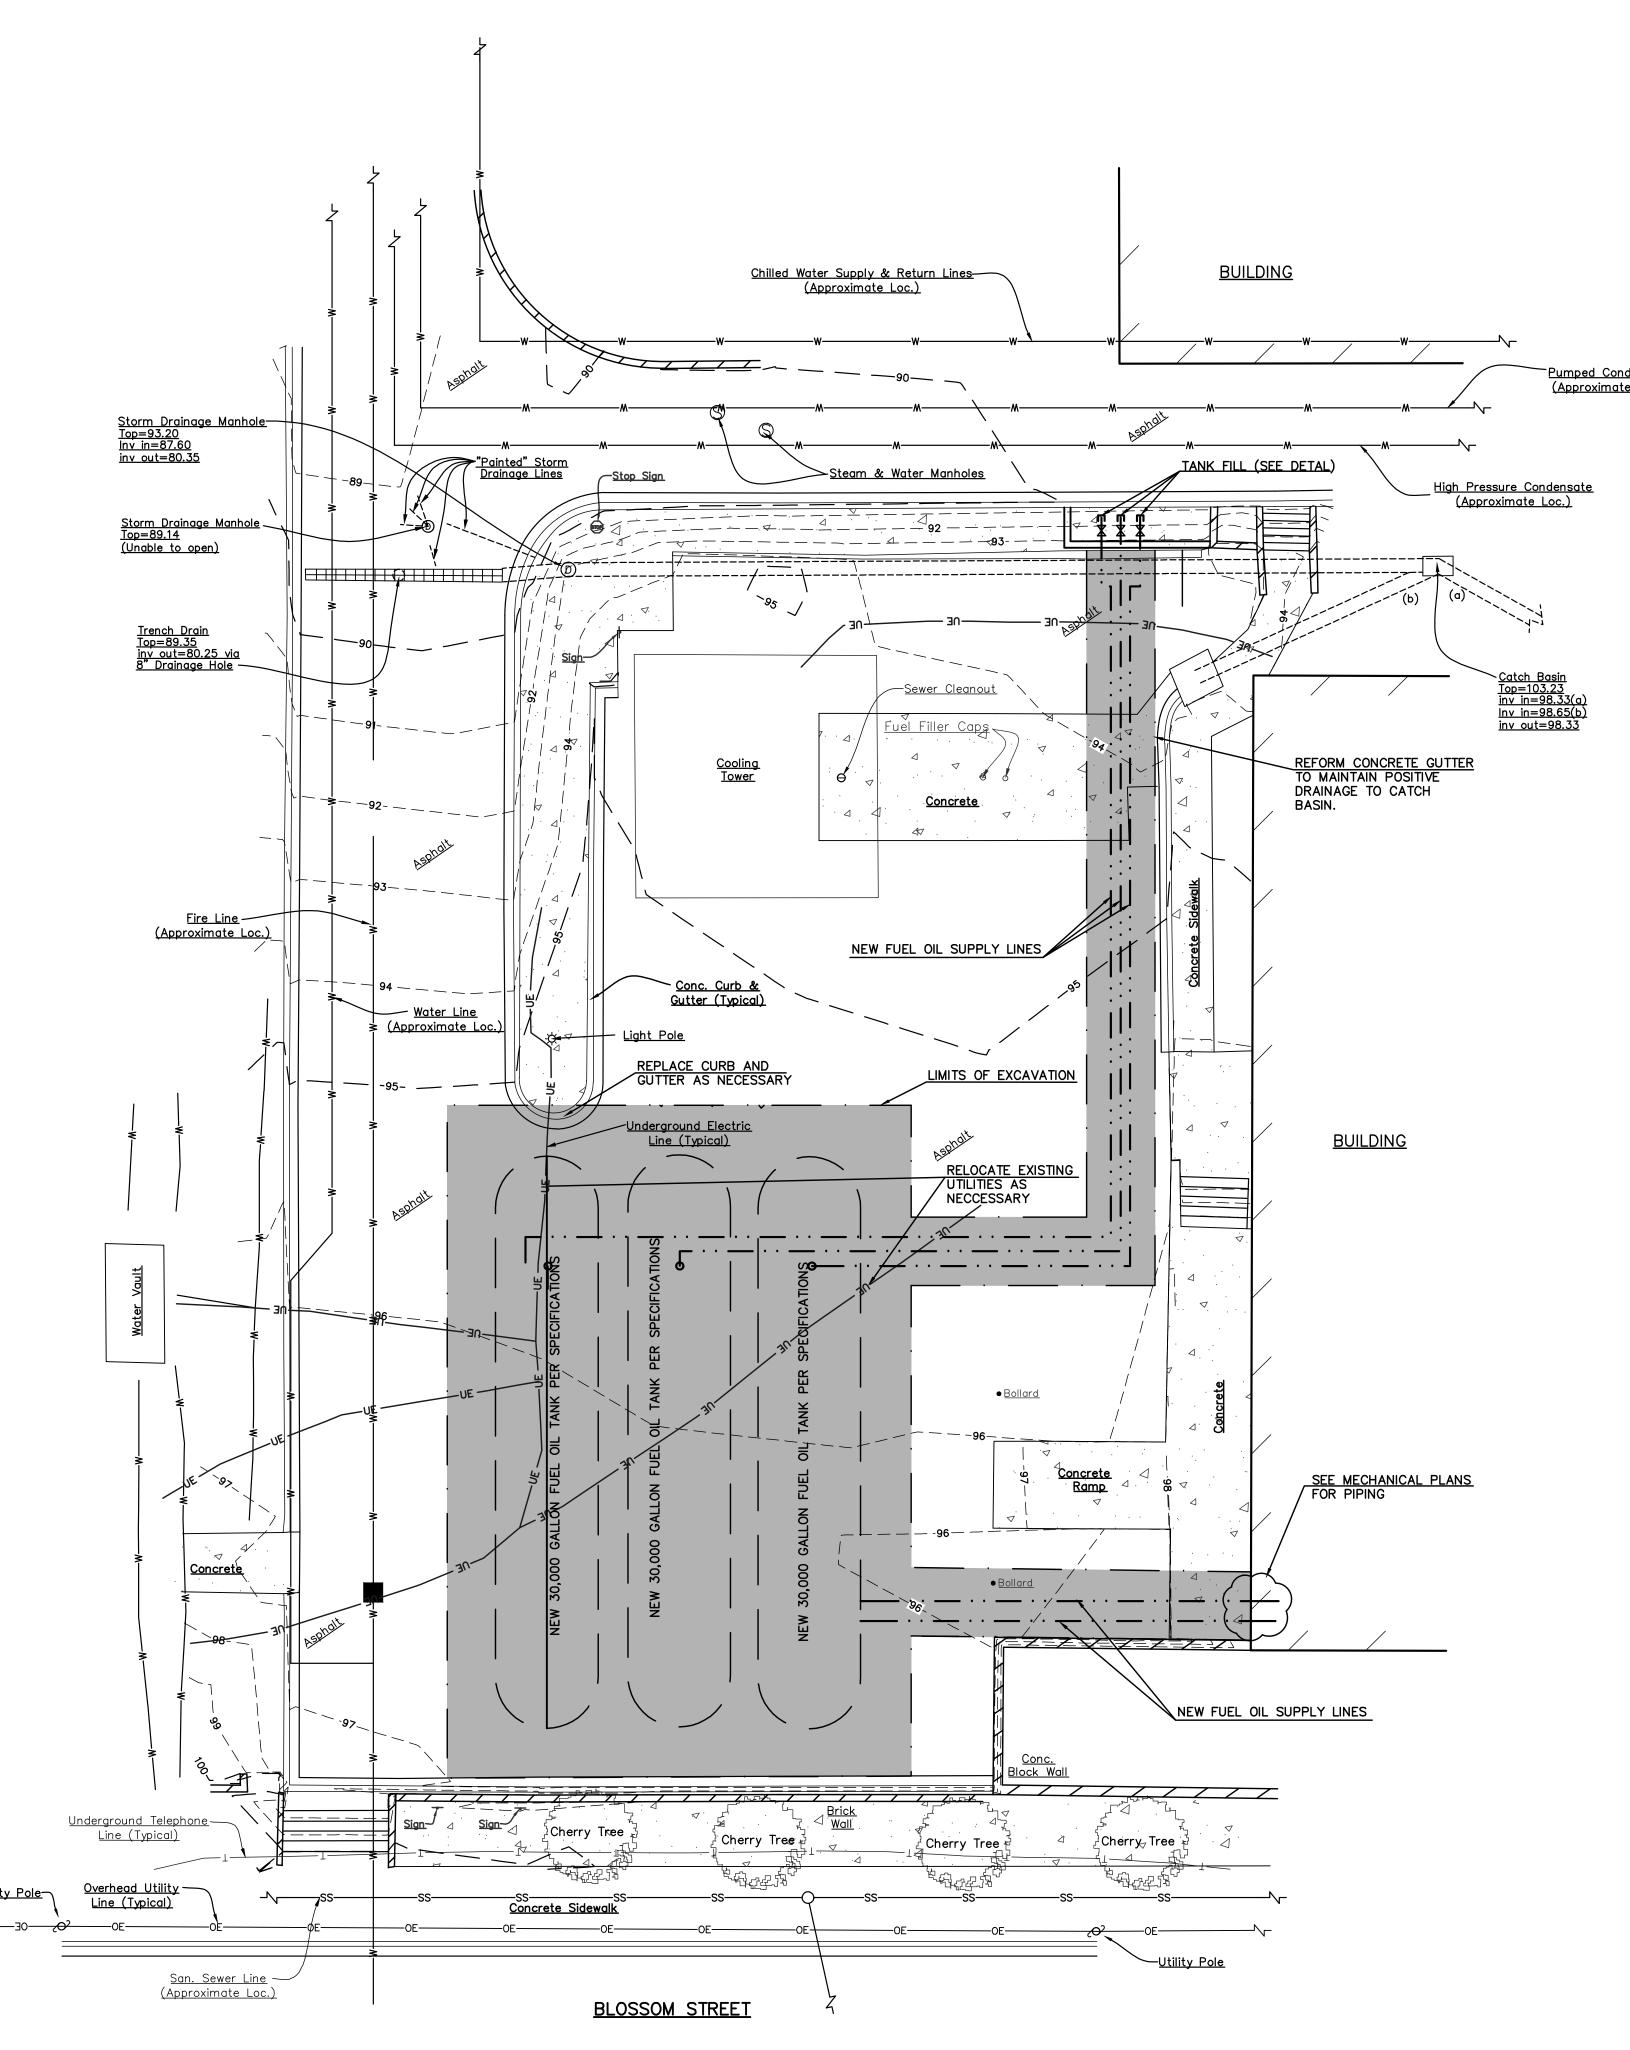
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- 3. CONTRACTOR TO CONTACT CITY OF COLUMBIA ENGINEERING PRIOR TO BEGINNING CONSTRUCTION.

0 0 0 0 0 GRAPHIC SCALE IN FEET SCALE: 1"=10 FET FET FET COLUMBIA SC 29205 S03-254-0518 FA: 803-765-0993 FA: 803-765-0993 Email: coinc@cocanddinkins.com TROJECT: 1891		CAMPUS PLANNING AND CONSTRUCTION columbia, sc 29208
1) THIS MAP IS NOT MEANT TO REPRESENT A LAND SURVEY IN ANY WAY AND CANNOT BE RECORDED NOR CAN IT BE USED FOR THE CONVEYANCE OF PROPERTY. A BOUNDARY SURVEY HAS NOT BEEN PERFORMED AT THIS TIME. 2) THE LOCATION OF OTHER UNDERGROUND UTILITIES AND THEIR SERVICES ARE UNKNOWN. 3) MAPPING DATA PROVIDED BY UNIVERSITY OF SOUTH CAROLINA	CHECKED BY: JLP ORIG. BY DRAWN BY	COX AND DINKINS, INC. No. COO294
848 pg. 49&61	BUILDING: DRAWING: DATE: DRAWN BY: 9-2-2016 CGM REV. DESCRIPTION DATE	
CONSTRUCTION SEQUENCE 1. INSTALL INLET PROTECTION AT INLETS DOWNSTREAM OF CONSTRUCTION AREA AND SET UP STOCK PILE AREA 2. DEMO EXISTING ASPHALT AND PORTION OF CONCRETE. 3. INSTALL STORM SASHALT AND PORTION OF CONCRETE. 3. INSTALL STORM SASHALT AND PORTION PER GEORECHMICAL REPORT. 5. INSTALL TUEL TANKS, FUEL SUPPLY LINES AND CONNECT WITH THE BUILDING AS SHOWN ON SIZETS III, WATER DATA STOR FOR GEOREMENTS. 6. INSTALL AND PARPIN SAST DI GEOTECHNICAL REQURRENTS. 7. REMOVE DEBRIS AND EXCESS DIET FROM STOCK PILE AREA. 8. INSTALL AND PAPAR ASPHALT PAVENENT AND CONCRETE DOCK. 9. RE-STRIPE PARING SPACES IN CONSTRUCTION AREA AS NEEDED. 10. REMOVE INLET PROTECTION. DEMOLITION AND CLEARING NOTES: 1) THE CONTRACTOR SHALL FRED VERIFY ALL ITEMS TO BE DEMOLISHED AND REMOVED FROM THE STE. THE VERIFICATION PROCESS SHALL INCLUDE VISITING AND ON THIS PLAN OR NOT. SHALL BE THE RESPONSIBILTY OF THE CONTRACTOR. CONTRACTOR SHALL FRED VERIFY ALL ITEMS TO BE DEMOLISHED AND REMOVED FROM THE STE. THE VERIFICATION PROCESS SHALL INCLUDE VISITING AND ON THIS PLAN OR NOT. SHALL BE THE RESPONSIBILTY OF THE CONTRACTOR. OUTRACTOR SHALL FREMEVEL SIGNALING CURB AND GUTTER, AND ASPHALT FAVENENTS AS SHOWN TO CONSTRUCT IMPROVEMENTS. OTTRACTOR SHALL REGUVE AND DELOW GROUND LEVEL) AS NECESSARY TO ACCOMMODATE CONSTRUCTION SAREAWY AND AREAWY AND	ADDITIONS F (WEST ENERGY)	EXISTING COUNTY, CITY OF COLUMBIA, SC EXISTING CONDITIONS & DEMOLITION PLAN University of South Carolina
 NOTES: THE LOCATIONS OF OTHER UNDERGROUND UTILITIES ARE UNKNOWN. THE CONTOUR INTERVAL = ONE (1') FOOT. ALL DIMENSIONS ARE TO THE FACE OF CURB UNLESS OTHERWISE NOTED. ELEVATIONS AND TOPOGRAPHICAL INFORMATION ARE BASED UPON ASSUMED DATUM SAN SEWER LINES, ALL WATER LINES, FIRE LINES, AND STEAM LINES WERE SCALED FROM REFERENCE NO. 1, AND IS ON FILE IN OUR OFFICE)1

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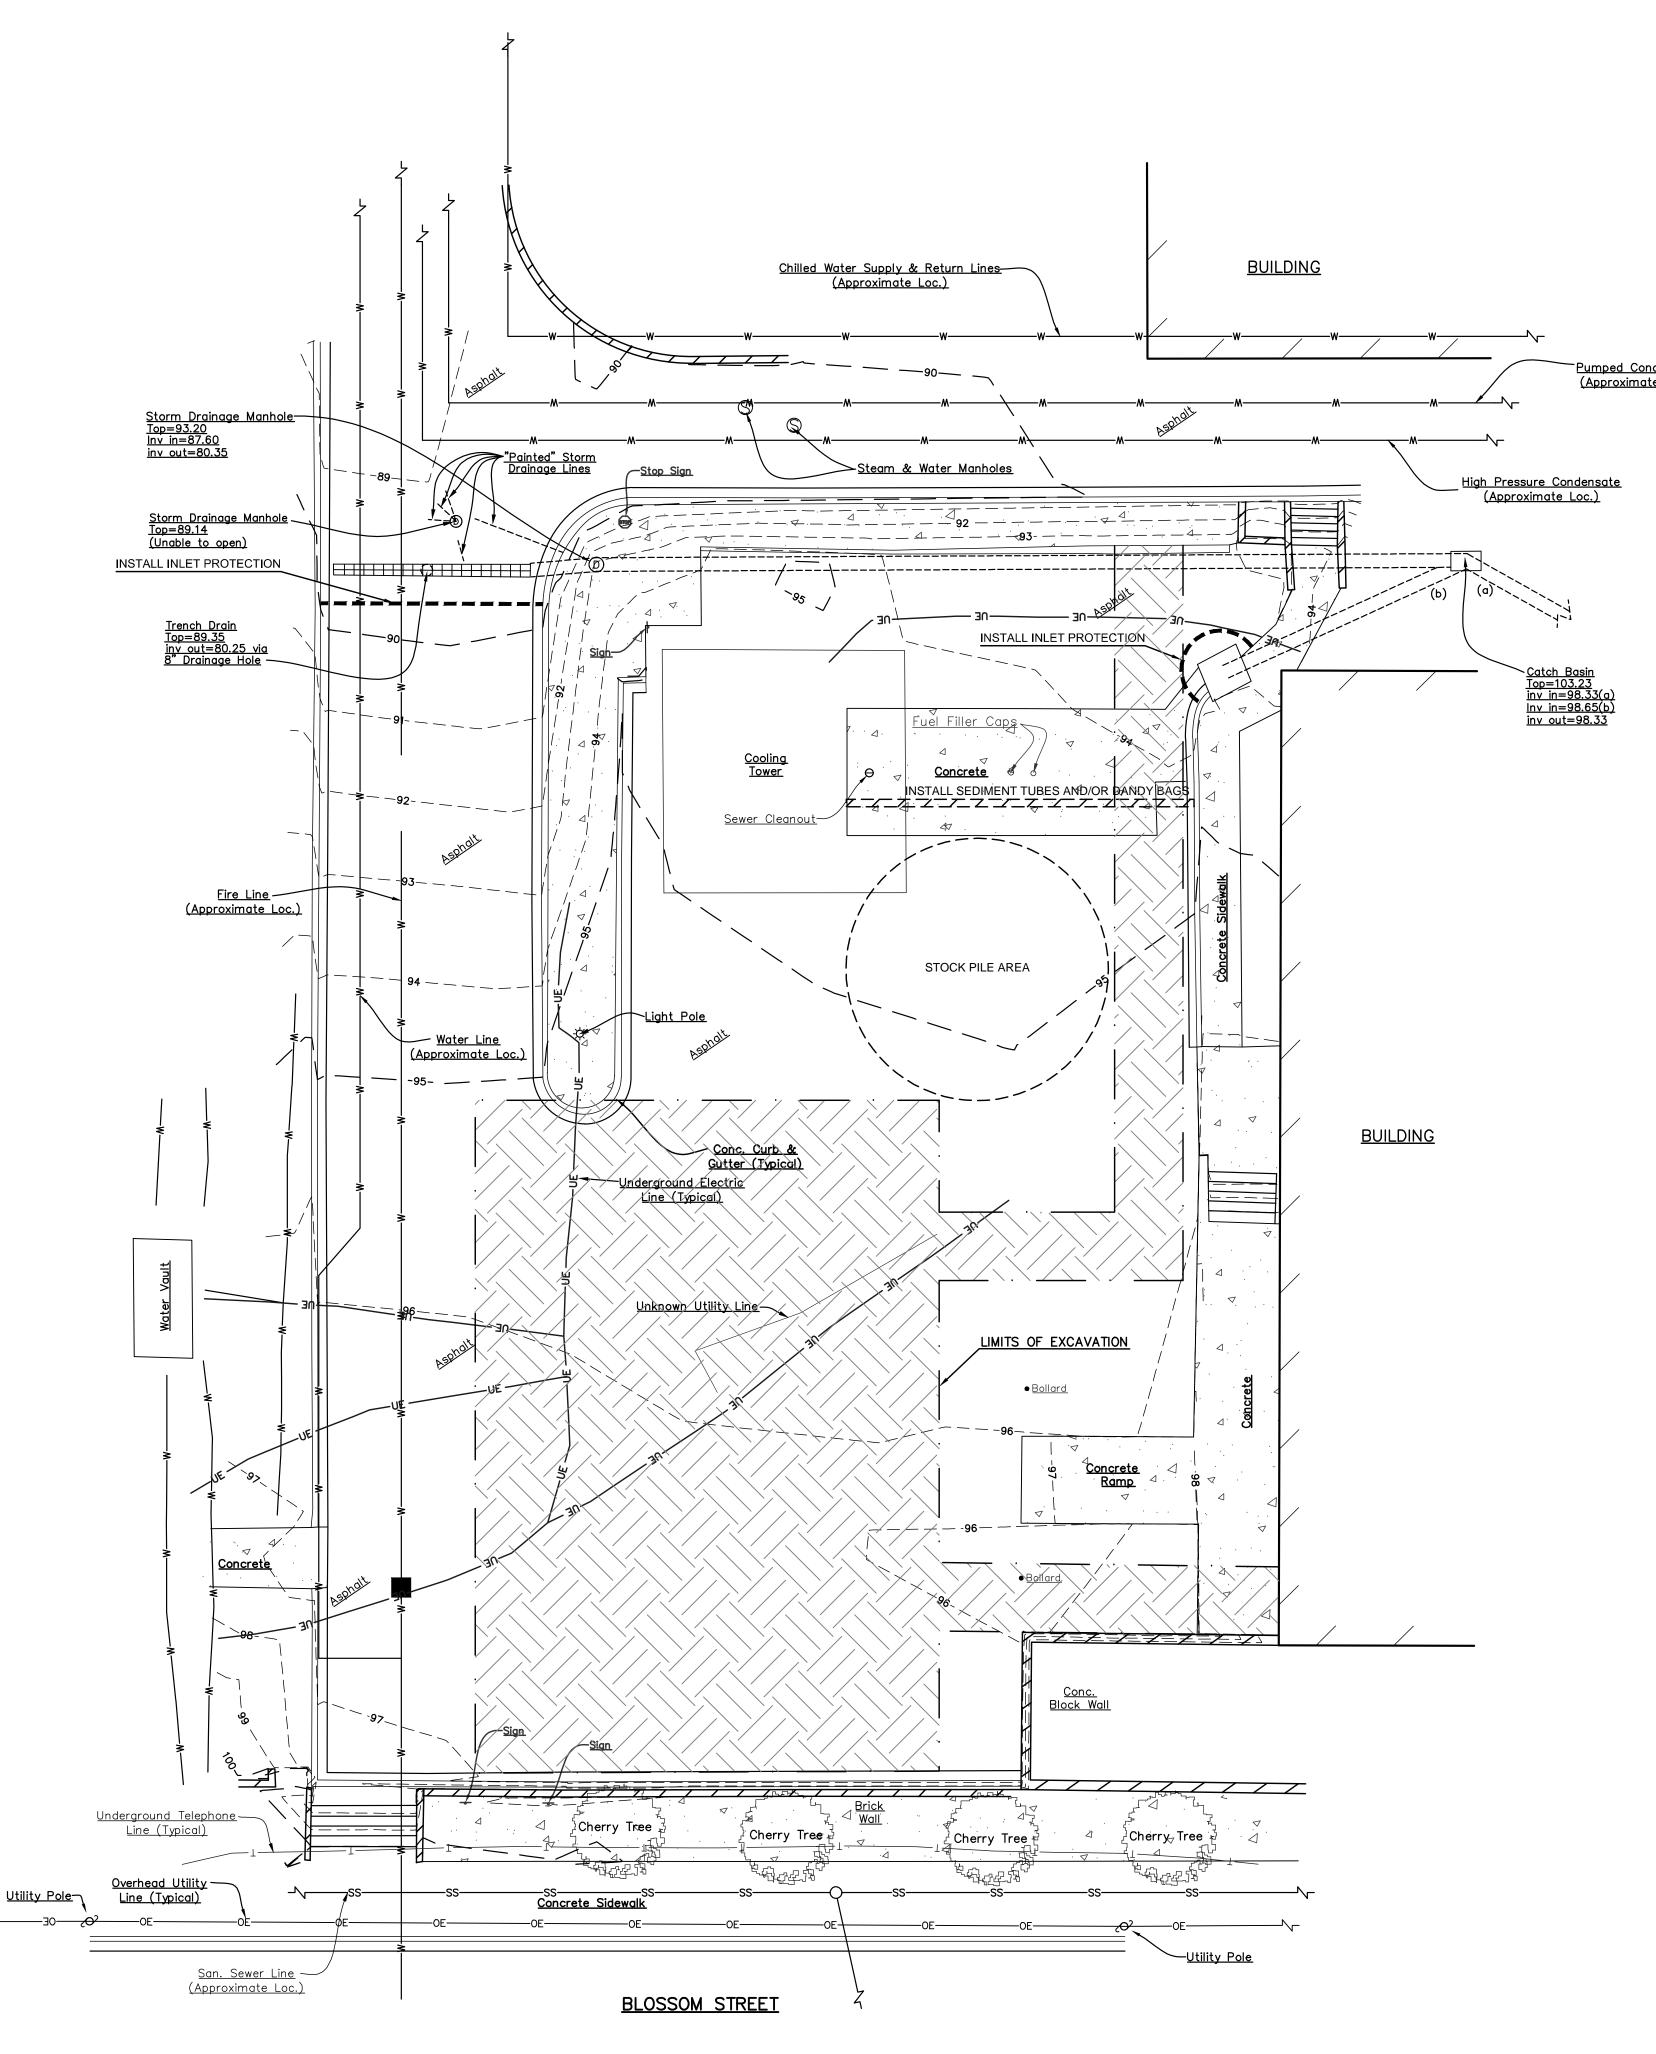
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	 THESE PLANS SHOW LOCATION OF NEW FUEL TANKS AND EXDEMOLITION AND PAVEMENT REPAIR. PLEASE SEE MECHANICAND PIPING INSTALLATION. CONTRACTOR SHALL COMPLY WITH ALL TALK MANUFACTURED MATERIAL, PROCEDURE AND COMPACTION CONTRACTOR SHALL COMPLY WITH ALL GEOTECHNICAL PAVE THE LOCATIONS OF OTHER UNDERGROUND UTILITIES ARE UN THE CONTOUR INTERVAL = ONE (1') FOOT. ALL DIMENSIONS ARE TO THE FACE OF CURB UNLESS OTHER ELEVATIONS AND TOPOGRAPHICAL INFORMATION ARE BASED SAN SEWER LINES, ALL WATER LINES, FIRE LINES, AND STEAREFERENCE NO. 1, AND IS ON FILE IN OUR OFFICE 	CAL PLANS FOR FUEL TANKS R'S SPECS FOR BACKFILL MENT REPORT REQUIREMENTS. KNOWN. RWISE NOTED. UPON ASSUMED DATUM	FUEL TANK AC		RICHLAND COUNTY, CITY OF		rsity of
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	EXISTING CONCRETE NEW HEAVY DUTY CONCRETE TO BE INSTALLED A BACKFILL AND COMPACTION. BACKFILL AND COM MANUFACTURER SPECIFICATIONS AND GEOTECHNI	PACTION SHALL COMPLY WITH TANK	ROJECT TITLE:	ſ:	*		
	REFERENCES:			$\overline{}$		<i>۲</i>	
	1) MASTER PLAN PREPARED FOR THE UNIVERSITY OF SOUTH PROJECT DEVELOPMENT OFFICE, DATED JANUARY 5, 1998	CAROLINA, DESIGN AND ENGINEERING , SHEET G—2a.		` 		/ -	

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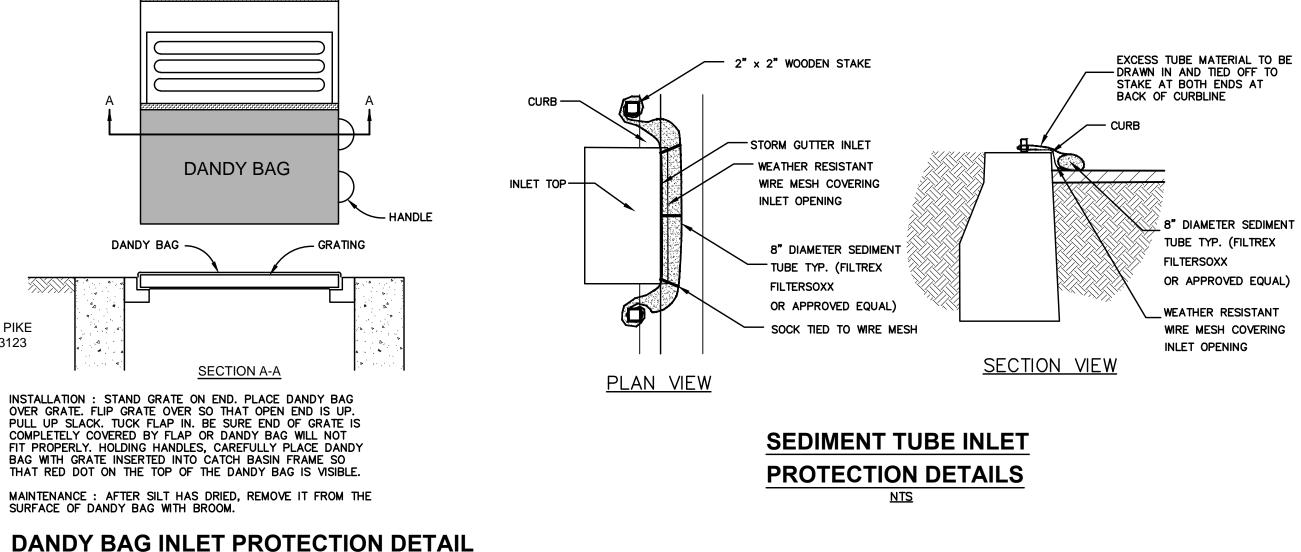
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MATERIAL THAT IS NOT U	E FOR HAULING AND DISPOSAL OF EX TILIZED FOR BACKFILL. CONTRACTOR SITE FOR NO MORE THAN 48 HOURS	CAVATED MAY	DRAWING: DATE: DRAWN BY: 9-2-2016 CGM DESCRIPTION DATE	
			BUILDING: REV.	
			FUEL TANK ADDITIONS BLOSSOM STREET (WEST ENERGY)	RICHLAND COUNTY, CITY OF COLUMBIA, SC SEDIMENT & EROSION CONTROL PLAN University of South Carolina
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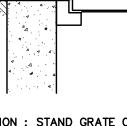
SITE DETAILS:

SEDIMENT AND EROSION CONTROL NOTES

- 1. IF NECESSARY, SLOPES WHICH EXCEED EIGHT (8) VERTICAL FEET SHOULD BE STABILIZED WITH SYNTHETIC OR VEGETATIVE MATS, IN ADDITION TO HYDROSEEDING. IT MAY BE NECESSARY TO INSTALL TEMPORARY SLOPE DRAINS DURING CONSTRUCTION. TEMPORARY BERMS MAY BE NEEDED UNTIL THE SLOPE IS BROUGHT TO GRADE.
- STABILIZATION MEASURES SHALL BE INITIATED AS SOON AS PRACTICABLE IN PORTIONS OF THE SITE WHERE CONSTRUCTION ACTIVITIES HAVE TEMPORARILY OR PERMANENTLY CEASED, BUT IN NO CASE MORE THAN FOURTEEN (14) DAYS AFTER WORK HAS CEASED, EXCEPT AS STATED BELOW:
- WHERE STABILIZATION BY THE 14TH DAY IS PRECLUDED BY SNOW COVER OR FROZEN GROUND CONDITIONS, STABILIZATION MEASURES MUST BE INITIATED AS SOON AS PRACTICABLE.
- WHERE CONSTRUCTION ACTIVITY ON A PORTION OF THE SITE IS TEMPORARILY CEASED, AND EARTH-DISTURBING ACTIVITIES WILL BE RESUMED WITHIN 14 DAYS, TEMPORARY STABILIZATION MEASURES DO NOT HAVE TO BE IN INITIATED ON THAT PORTION OF THE SITE.
- ALL SEDIMENT AND EROSION CONTROL DEVICES SHALL BE INSPECTED ONCE EVERY CALENDAR WEEK. IF PERIODIC INSPECTION OR OTHER INFORMATION INDICATES THAT A BMP HAS BEEN INAPPROPRIATELY OR INCORRECTLY INSTALLED, THE PERMITTEE MUST ADDRESS THE NECESSARY REPLACEMENT OR MODIFICATION REQUIRED TO CORRECT THE BMP WITHIN 48 HOURS OF IDENTIFICATION.
- . PROVIDE SILT FENCE AND/OR OTHER CONTROL DEVICES, AS MAY BE REQUIRED, TO CONTROL SOIL EROSION DURING UTILITY CONSTRUCTION. ALL DISTURBED AREAS SHALL BE CLEANED, GRADED, AND STABILIZED WITH GRASSING IMMEDIATELY AFTER THE UTILITY INSTALLATION. FILL, COVER, AND TEMPORARY SEEDING AT THE END OF EACH DAY ARE RECOMMENDED. IF WATER IS ENCOUNTERED WHILE TRENCHING, THE WATER SHOULD BE FILTERED TO REMOVE ANY SEDIMENT BEFORE BEING PUMPED BACK INTO ANY WATERS OF THE STATE.
- ALL EROSION CONTROL DEVICES SHALL BE PROPERLY MAINTAINED DURING ALL PHASES OF CONSTRUCTION AND UNTIL THE COMPLETION OF ALL CONSTRUCTION ACTIVITIES AND ALL DISTURBED AREAS HAVE BEEN STABILIZED. ADDITIONAL CONTROL DEVICES MAY BE REQUIRED DURING CONSTRUCTION IN ORDER TO CONTROL EROSION AND/OR OFFSITE SEDIMENTATION. ALL TEMPORARY CONTROL DEVICES SHALL BE REMOVED ONCE CONSTRUCTION IS COMPLETE AND THE SITE HAS BEEN STABILIZED.
- THE CONTRACTOR MUST TAKE NECESSARY ACTION TO MINIMIZE THE TRACKING OF MUD ONTO PAVED ROADWAY(S) FROM CONSTRUCTION AREAS AND TO MINIMIZE THE GENERATION OF DUST. THE CONTRACTOR SHALL DAILY REMOVE MUD/SOIL FROM PAVEMENT, AS MAY BE REQUIRED.
- RESIDENTIAL SUBDIVISIONS REQUIRE EROSION CONTROL FEATURES FOR INFRASTRUCTURE AS WELL AS FOR INDIVIDUAL LOT CONSTRUCTION. INDIVIDUAL PROPERTY OWNERS SHALL FOLLOW THESE PLANS DURING CONSTRUCTION OR OBTAIN APPROVAL OF AN INDIVIDUAL PLAN IN ACCORDANCE WITH S.C. REG. 72-300 ET SEQ. AND SCR100000. TEMPORARY DIVERSION BERMS AND/OR DITCHES MUST BE PROVIDED AS NEEDED DURING
- CONSTRUCTION TO PROTECT WORK AREAS FROM UPSLOPE RUNOFF AND/OR TO DIVERT SEDIMENT-LADEN WATER TO APPROPRIATE TRAPS OR STABLE OUTLETS. ALL WATERS OF THE STATE (WoS), INCLUDING WETLANDS, ARE TO BE FLAGGED OR OTHERWISE
- CLEARLY MARKED IN THE FIELD. A DOUBLE ROW OF SILT FENCE IS TO BE INSTALLED IN ALL AREAS WHERE A 50-FOOT BUFFER CANNOT BE MAINTAINED BETWEEN THE DISTURBED AREA AND ALL WoS. A 10-FOOT BUFFER SHOULD BE MAINTAINED BETWEEN THE LAST ROW OF SILT FENCE AND ALL WoS. 10. LITTER, CONSTRUCTION DEBRIS, OILS, FUELS, AND BUILDING PRODUCTS WITH SIGNIFICANT
- POTENTIAL FOR IMPACT (SUCH AS STOCKPILES OF FRESHLY TREATED LUMBER) AND CONSTRUCTION CHEMICALS THAT COULD BE EXPOSED TO STORM WATER MUST BE PREVENTED FROM BECOMING A POLLUTANT SOURCE IN STORM WATER DISCHARGES. 11. A COPY OF THE SWPPP, INSPECTION RECORDS, AND RAINFALL DATA MUST BE RETAINED AT THE
- CONSTRUCTION SITE OR NEARBY LOCATION EASILY ACCESSIBLE DURING NORMAL BUSINESS HOURS. FROM THE DATE OF COMMENCEMENT OF CONSTRUCTION ACTIVITIES THROUGH THE DATE FINAL STABILIZATION IS REACHED.
- 12. INITIATE STABILIZATION MEASURES ON ANY EXPOSED STEEP SLOPE (3H: 1V OR GREATER) WHERE LAND-DISTURBING ACTIVITIES HAVE PERMANENTLY OR TEMPORARILY CEASED, AND WILL NOT RESUME FOR A PERIOD OF 7 CALENDAR DAYS.
- 13. MINIMIZE TOPSOIL COMPACTION AND, UNLESS INFEASIBLE, PRESERVE TOPSOIL. 14. MINIMIZE THE DISCHARGE OF POLLUTANTS FROM EQUIPMENT AND VEHICLE WASHING, WHEEL WASH WATER, AND OTHER WASH WATERS. WASH WATERS MUST BE TREATED IN A SEDIMENT BASIN OR ALTERNATIVE CONTROL THAT PROVIDES EQUIVALENT OR BETTER TREATMENT PRIOR TO DISCHARGE. 15. MINIMIZE THE DISCHARGE OF POLLUTANTS FROM DEWATERING OF TRENCHES AND EXCAVATED AREAS. THESE DISCHARGES ARE TO BE ROUTED THROUGH APPROPRIATE BMPS (SEDIMENT BASIN,
- FILTER BAG, ETC). 16. THE FOLLOWING DISCHARGES FROM THE SITE ARE PROHIBITED: • WASTEWATER FROM THE WASHOUT OF CONCRETE, UNLESS MANAGED BY AN APPROPRIATE
- CONTROL; • WASTEWATER FROM THE WASHOUT AND CLEANOUT OF STUCCO, PAINT, FORM RELEASE OILS,
- CURING COMPOUNDS AND OTHER CONSTRUCTION MATERIALS; • FUELS, OILS, OR OTHER POLLUTANTS USED IN VEHICLE AND EQUIPMENT OPERATION AND MAINTENANCE; AND
- SOAPS AND SOLVENTS USED IN VEHICLE AND EQUIPMENT WASHING. 17. AFTER CONSTRUCTION ACTIVITIES BEGIN, INSPECTIONS MUST BE CONDUCTED AT LEAST ONCE EVERY CALENDAR WEEK AND MUST BE CONDUCTED UNTIL FINAL STABILIZATION IS REACHED ON ALL AREAS OF THE CONSTRUCTION SITE.
- 18. IF EXISTING BMPS REQUIRE MODIFICATION OR IF ADDITIONAL BMPS ARE NECESSARY TO COMPLY WITH THE REQUIREMENTS OF THIS PERMIT AND/OR SC'S WATER QUALITY STANDARDS. IMPLEMENTATION MUST BE COMPLETED BEFORE THE NEXT STORM EVENT WHENEVER PRACTICABLE. IF IMPLEMENTATION BEFORE THE NEXT STORM EVENT IS IMPRACTICABLE, THE SITUATION MUST BE DOCUMENTED IN THE SWPPP AND ALTERNATIVE BMPS MUST BE IMPLEMENTED AS SOON AS REASONABLY POSSIBLE.
- 19. A PRE-CONSTRUCTION CONFERENCE MUST BE HELD FOR EACH CONSTRUCTION SITE WITH AN APPROVED ON-SITE SWPPP PRIOR TO THE COMMENCEMENT OF CONSTRUCTION ACTIVITIES. FOR NON-LINEAR PROJECTS THAT DISTURB 10 ACRES OR MORE THIS CONFERENCE MUST BE HELD ON-SITE UNLESS THE DEPARTMENT HAS APPROVED OTHERWISE. 20. THE CONTRACTOR SHALL MAINTAIN A RAIN GAUGE ON SITE AND MAINTAIN DAILY PRECIPITATION
- RECORDS IN THE SWPPP MANUAL PER SCDHEC REQUIREMENTS. THE CONTRACTOR SHALL NOTIFY THE SWPPP INSPECTOR OF ALL RAINFALL EVENTS OF OVER ONE-HALF INCH PRECIPITATION. 21. LAND DISTURBING ACTIVITIES SHALL NOT COMMENCE UNTIL APPROVAL TO DO SO HAS BEEN
- ISSUED BY GOVERNING AUTHORITIES. 22. THE CONTRACTOR SHALL COMPLY WITH APPLICABLE STATE AND LOCAL ORDINANCES. 23. THE EROSION CONTROL MEASURES INCLUDED IN THE STORM WATER POLLUTION PREVENTION PLAN SHALL BE INSTALLED PRIOR TO INITIAL LAND DISTURBANCE ACTIVITIES OR AS SOON AS PRACTICAL. SEDIMENT SHALL BE PREVENTED FROM DISCHARGING FROM THE PROJECT SITE BY INSTALLING AND MAINTAINING CONTROL PRACTICES AS SHOWN ON THIS PLAN. IF SHOWN ON THESE PLANS, ENERGY- DISSIPATION DEVICES OR EROSION CONTROL AT THE OUTFALL OF THE STORM SEWER SYSTEM SHALL BE INSTALLED AT THE TIME OF THE CONSTRUCTION OF THE OUTFALL. STRUCTURAL PRACTICES SHALL BE USED TO CONTROL EROSION FROM ALL SITES
- REMAINING UNDISTURBED FOR MORE THAN 14 DAYS. 24. THE CONTRACTOR SHALL CONTROL WASTES, GARBAGE, DEBRIS, WASTEWATER, AND OTHER SUBSTANCES ON THE SITE IN SUCH A WAY THAT THEY SHALL NOT BE TRANSPORTED FROM THE SITE BY THE ACTION OF WINDS, STORM WATER RUNOFF, OR OTHER FORCES. PROPER DISPOSAL OR MANAGEMENT OF ALL WASTES AND UNUSED BUILDING MATERIAL, APPROPRIATE TO THE NATURE OF THE WASTE OR MATERIAL IS REQUIRED. COMPLIANCE IS REQUIRED WITH ALL STATE OR LOCAL REGULATIONS REGARDING WASTE DISPOSAL, SANITARY SEWER, OR SEPTIC SYSTEMS. 25. ALL ON-SITE STORM DRAIN INLETS SHALL BE PROTECTED AGAINST SEDIMENTATION AS SHOWN ON
- THESE PLANS. 26. THIS EROSION CONTROL PLAN SHALL BE IMPLEMENTED ON ALL DISTURBED AREAS WITHIN THE CONSTRUCTION SITE. ALL MEASURES INVOLVING EROSION CONTROL PRACTICES SHALL BE INSTALLED UNDER THE GUIDANCE OF QUALIFIED PERSONNEL EXPERIENCED IN EROSION CONTROL, AND FOLLOWING THE PLANS AND SPECIFICATIONS INCLUDED HEREIN.
- 27. DURING THE PERIOD OF CONSTRUCTION ACTIVITY, ALL SEDIMENT BASINS AND OTHER EROSION CONTROL MEASURES SHALL BE MAINTAINED BY THE CONTRACTOR. AT COMPLETION OF CONSTRUCTION, THE CONTRACTOR SHALL COORDINATE THE TRANSFER OF MAINTENANCE RESPONSIBILITIES, IF REQUIRED, WITH THE OWNER. MAINTENANCE SHALL BE IN ACCORDANCE WITH DHEC'S MANUAL, "SOUTH CAROLINA STORMWATER MANAGEMENT AND SEDIMENT CONTROL HANDBOOK FOR LAND DISTURBANCE ACTIVITIES".
- 28. ALL EROSION CONTROL PRACTICES SHALL BE IN ACCORDANCE WITH "SOUTH CAROLINA STORMWATER MANAGEMENT AND SEDIMENT CONTROL HANDBOOK FOR LAND DISTURBANCE ACTIVITIES"
- 29. EXISTING VEGETATION SHALL BE PROTECTED AS MUCH AS PRACTICAL. 30. IF SYNTHETIC OR PERMANENT VEGETATIVE MATTING IS USED, THE MANUFACTURER'S REPRESENTATIVE MUST PROVIDE WRITTEN APPROVAL OF THE INSTALLATION OF THE MATERIAL. A COPY THAT LETTER MUST BE PROVIDED TO THE OWNER AND THE ENGINEER.
- 31. IF THE INSTALLATION OF THE STORM DRAINAGE SYSTEM IS INTERRUPTED BY WEATHER OR NIGHTFALL, PIPE ENDS SHALL BE COVERED WITH FILTER FABRIC.
- 32. THE CONTRACTOR SHALL REMOVE SEDIMENT FROM THE DETENTION POND/SEDIMENT BASIN AT SUCH TIME AS IT REACHES A DEPTH OF 0.5 FEET ABOVE THE DESIGN BOTTOM ELEVATION OF THE
- POND/BASIN. DISPOSAL OF THE MATERIAL IS ALSO THE RESPONSIBILITY OF THE CONTRACTOR. 33. THE CONTRACTOR SHALL REMOVE ALL ACCUMULATED SEDIMENT FROM THE DETENTION POND/SEDIMENT BASIN AFTER THE SITE IS STABILIZED, ENSURING THAT THE DESIGN VOLUME OF THE POND/BASIN HAS BEEN PROVIDED FOLLOWING STABILIZATION.
- 34. ALL TEMPORARY CONTROL DEVICES SHALL BE REMOVED ONCE CONSTRUCTION IS COMPLETE AND THE SITE IS STABILIZED. 35. THE CONTRACTOR SHALL RESPREAD THE TOPSOIL ON SITE AS MUCH AS POSSIBLE PRIOR TO
- FINAL GRADING AND STABILIZATION. 36. THIS PLAN SHALL NOT BE CONSIDERED ALL INCLUSIVE. THE CONTRACTOR SHALL TAKE ALL
- NECESSARY MEASURES AT HIS EXPENSE TO REDUCE EROSION AND PREVENT SEDIMENT FROM LEAVING THE SITE. THE CONTRACTOR IS RESPONSIBLE FOR ALL CLEANUP AND REPAIR ON-SITE AND DOWNSTREAM DUE TO EROSION AND SILTATION.

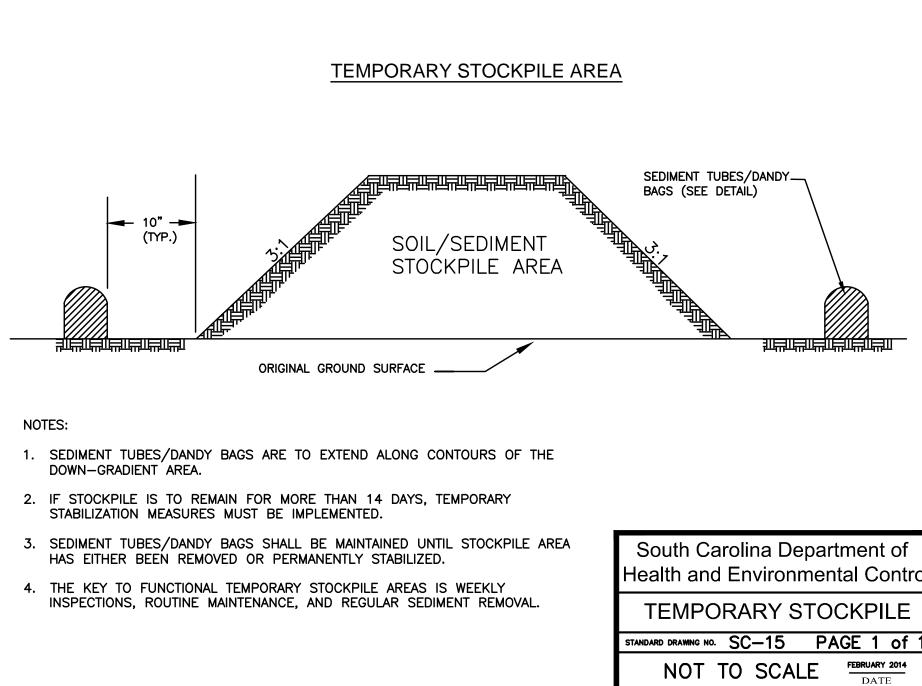


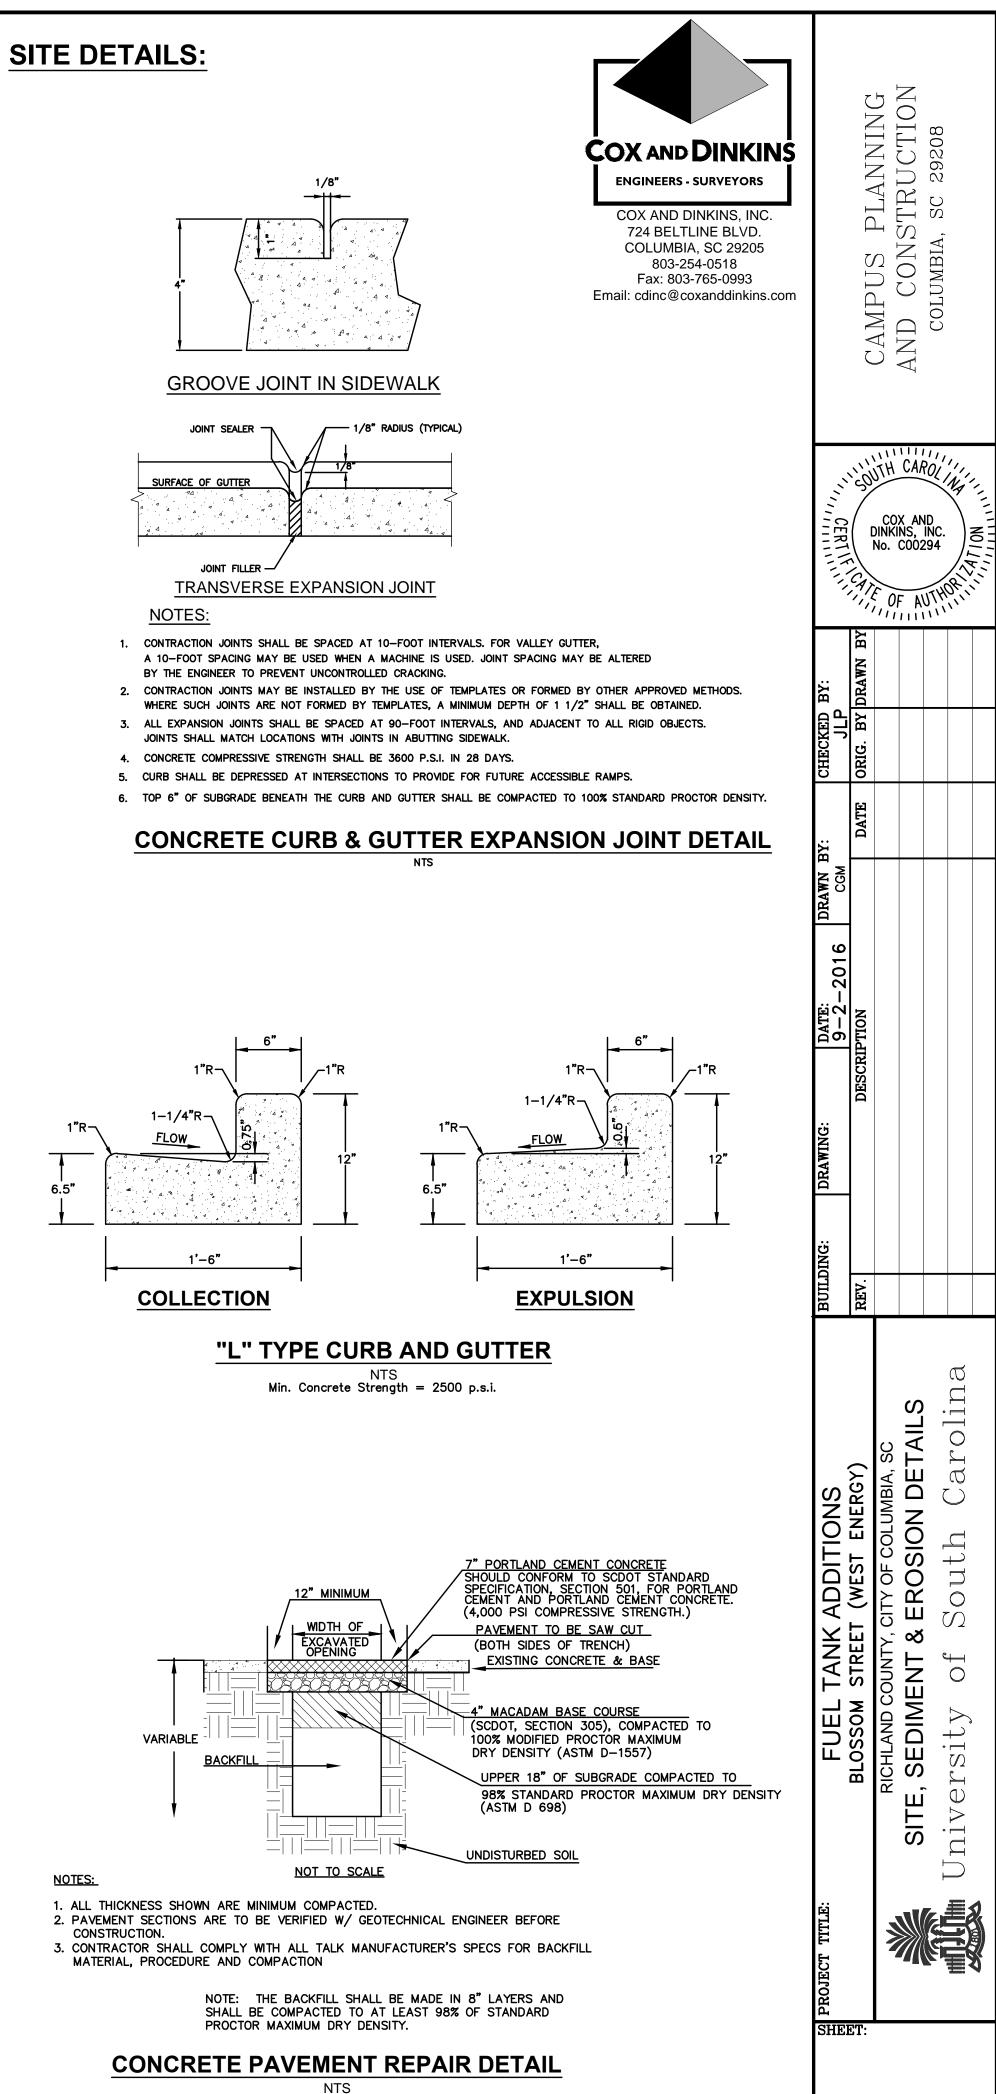
CONTACT INFO: DANDY PRODUCTS 2011-R HARRISBURG PIKE GROVE CITY, OHIO 43123 800-591-2284



(OR ENGR APPROVED EQUAL)

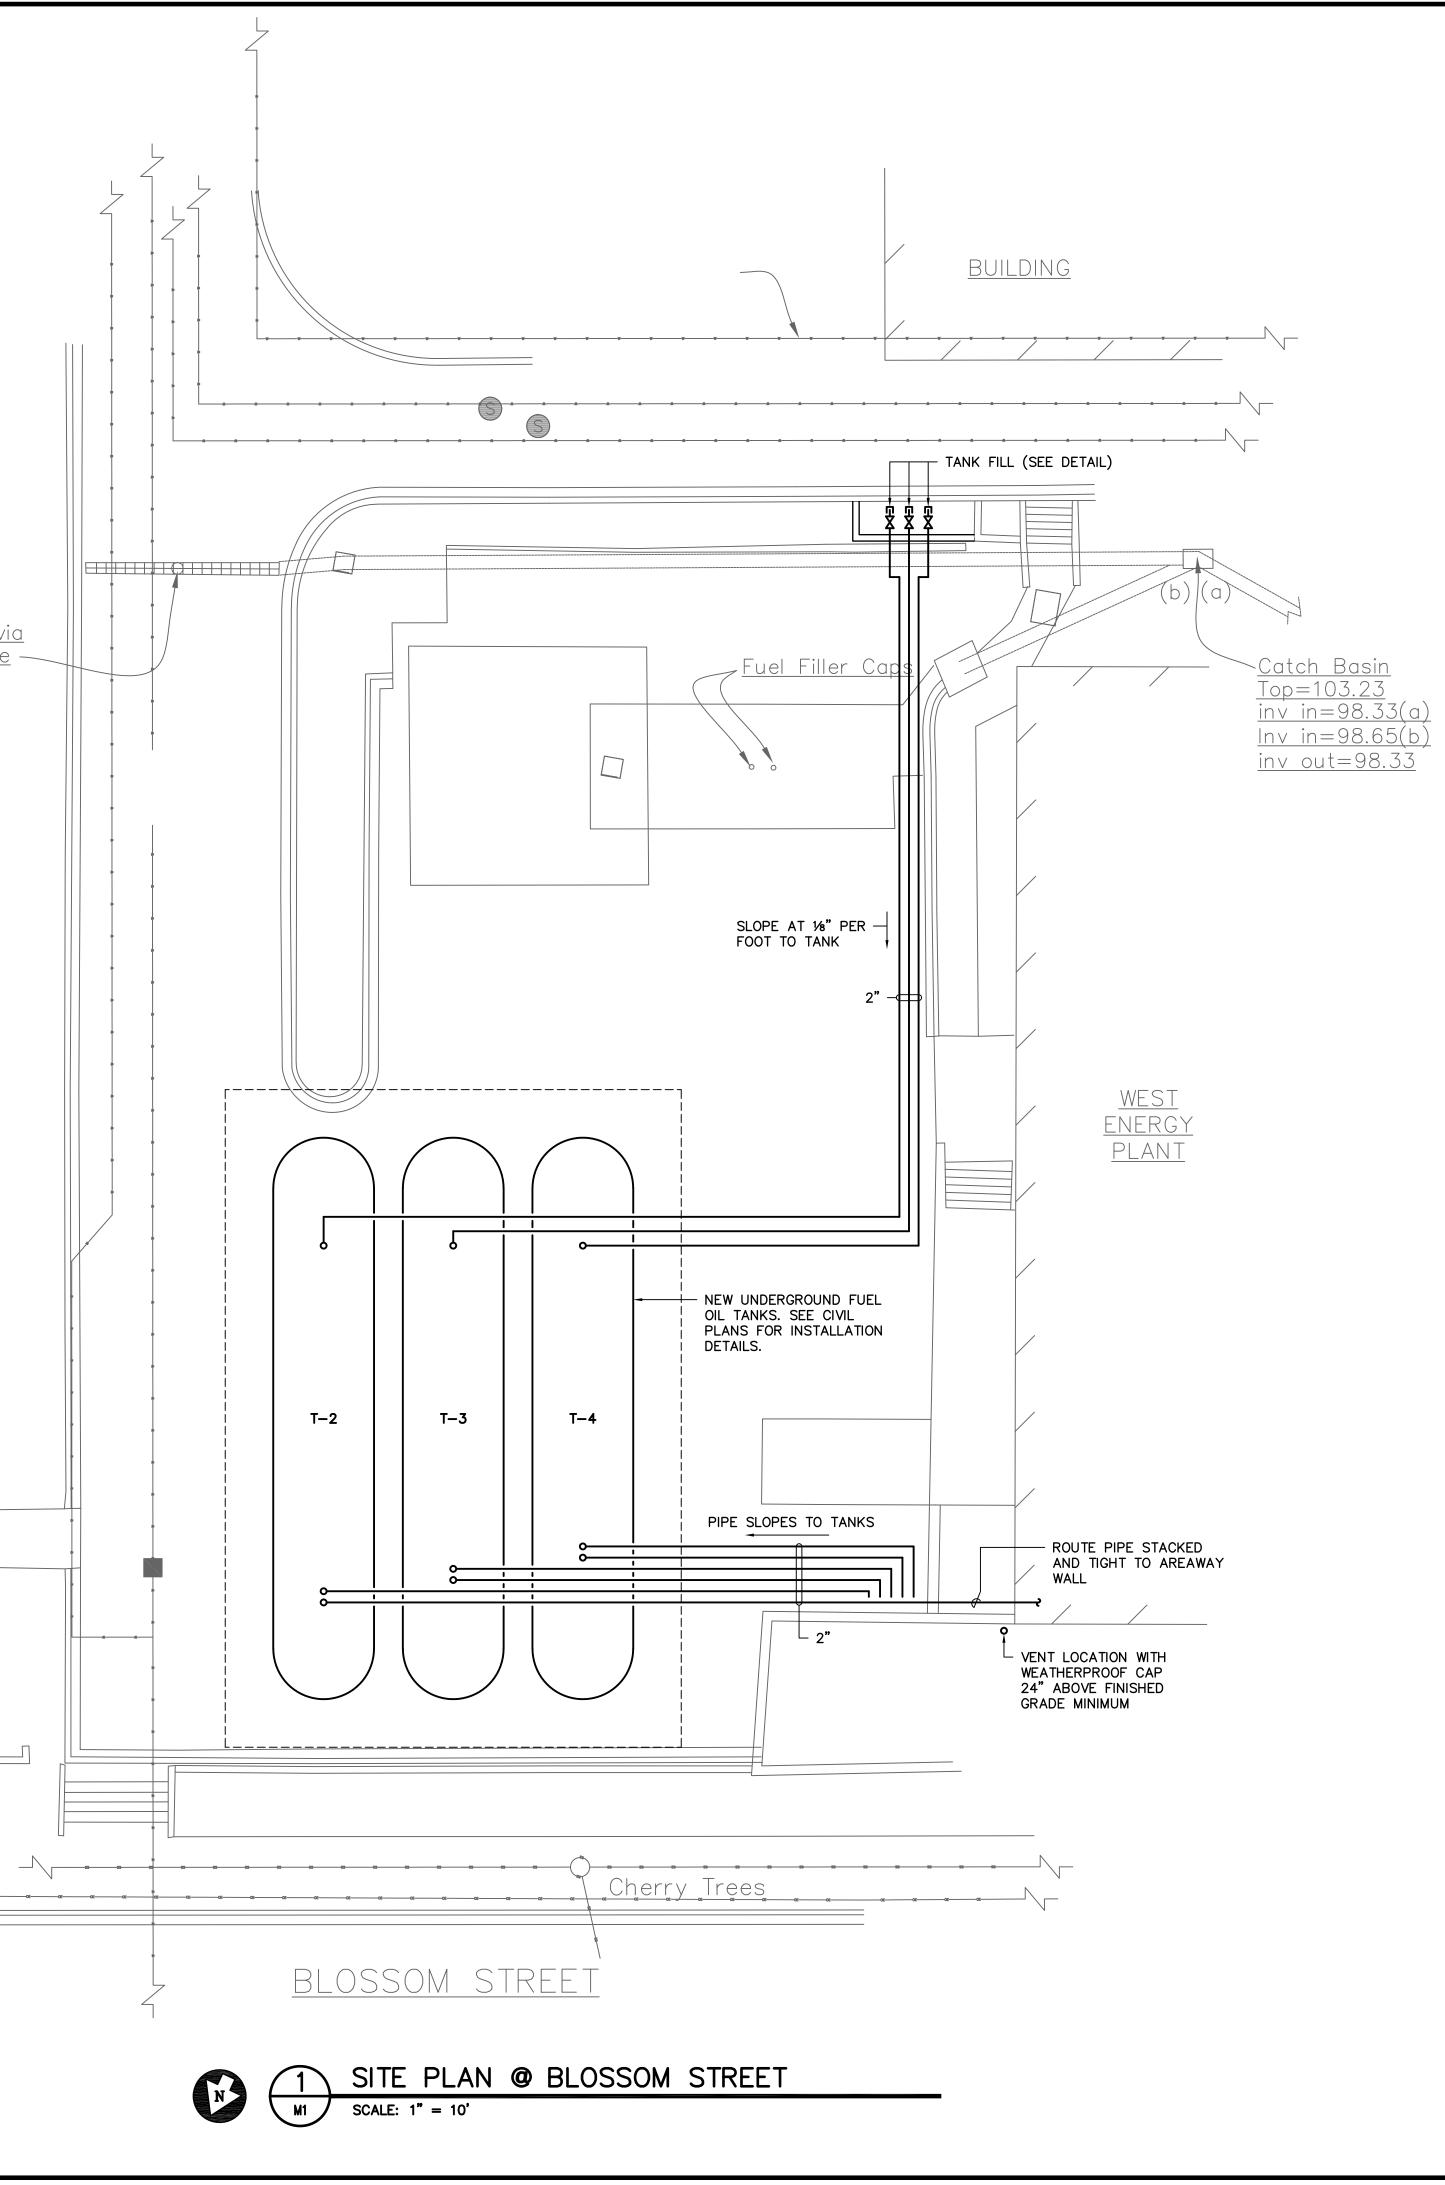
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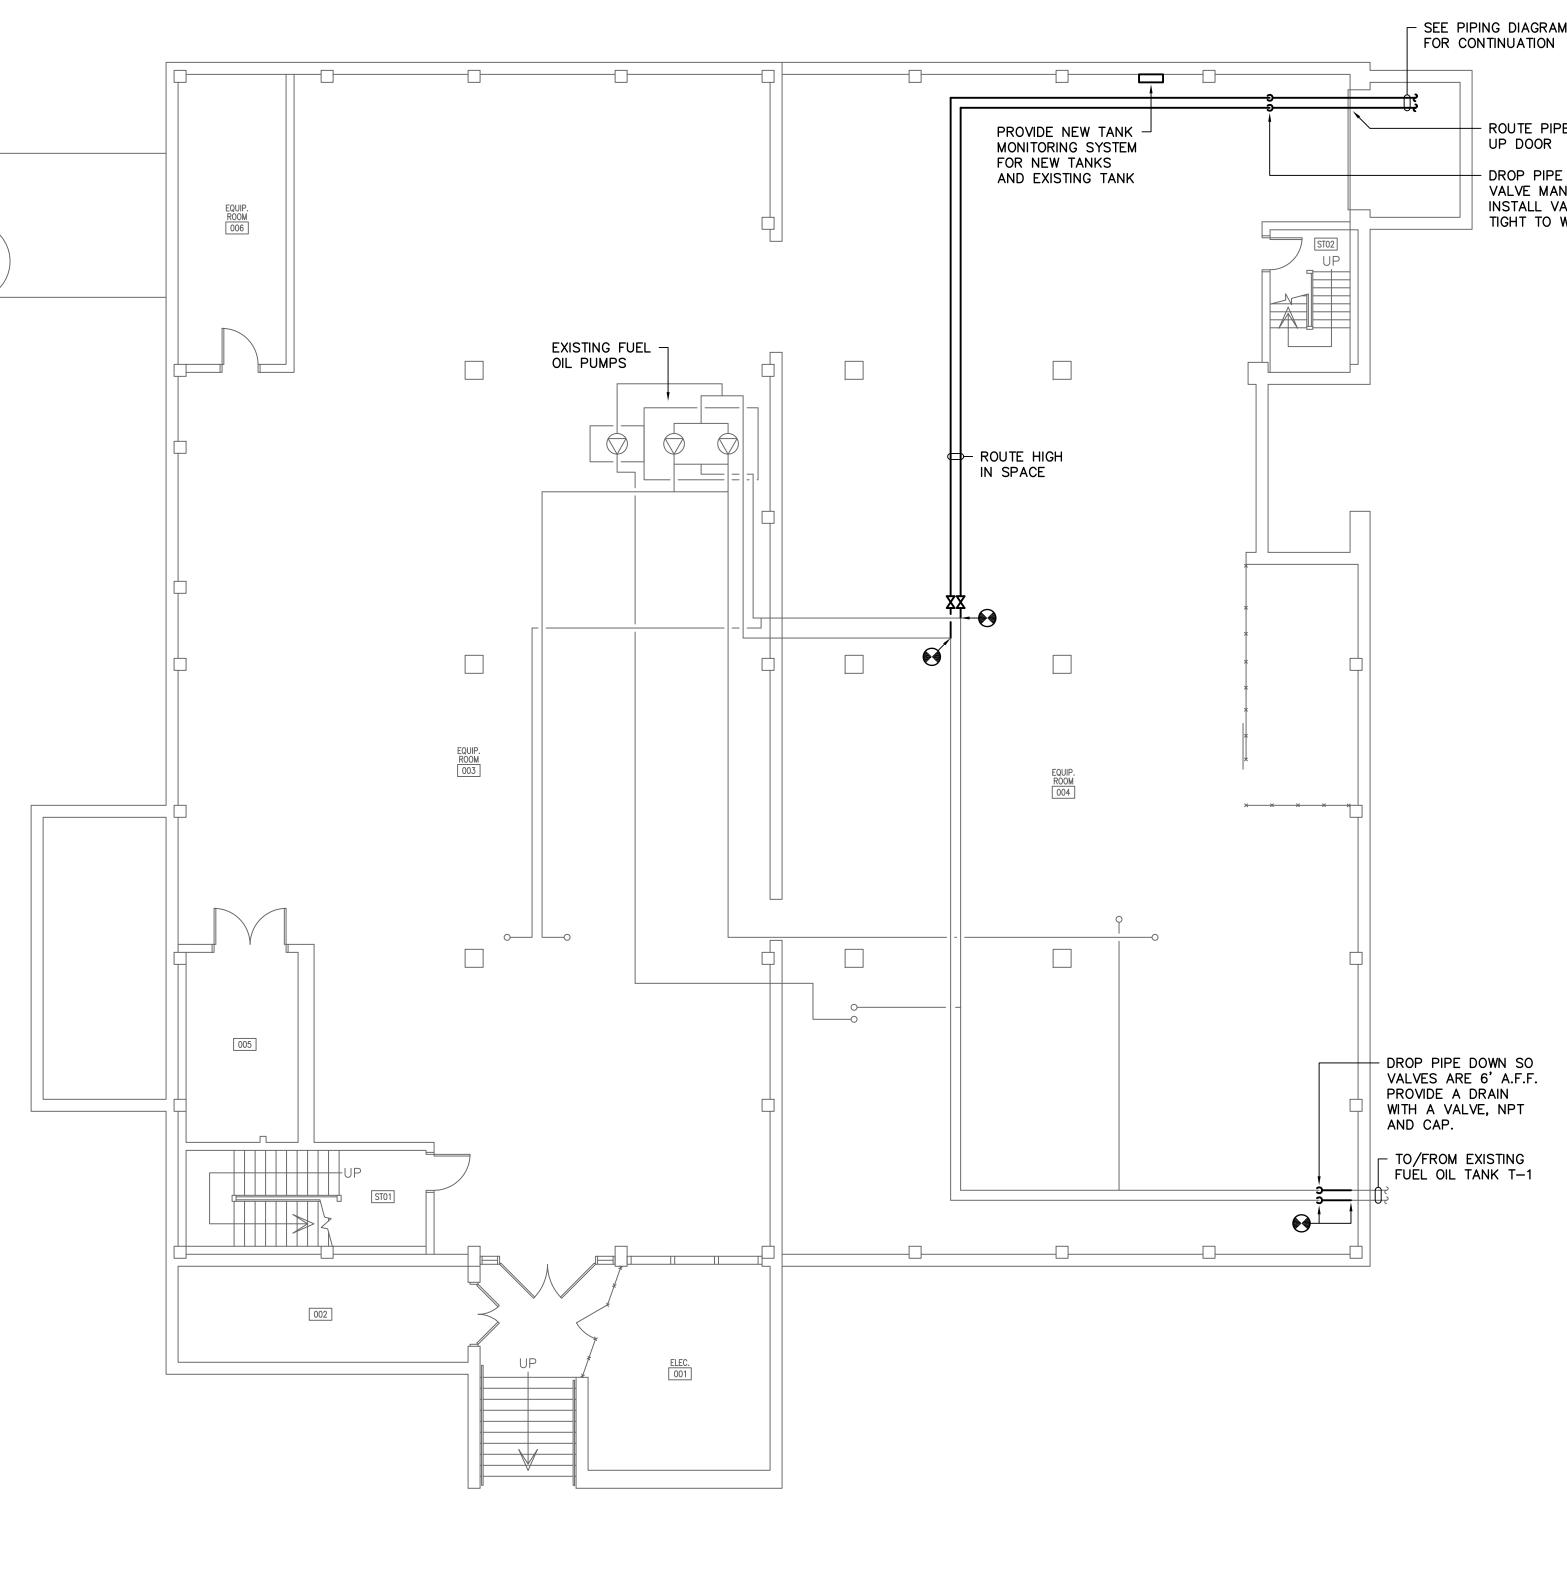


VERIFY WITH GEOTECHNICAL REPORTS

<u>Top=93.20</u> <u>Inv in=87.60</u> inv out=80.35 <u>Trench Drain</u> <u>Top=89.35</u> <u>inv out=80.25 via</u> <u>8" Drainage Hole</u> — _____



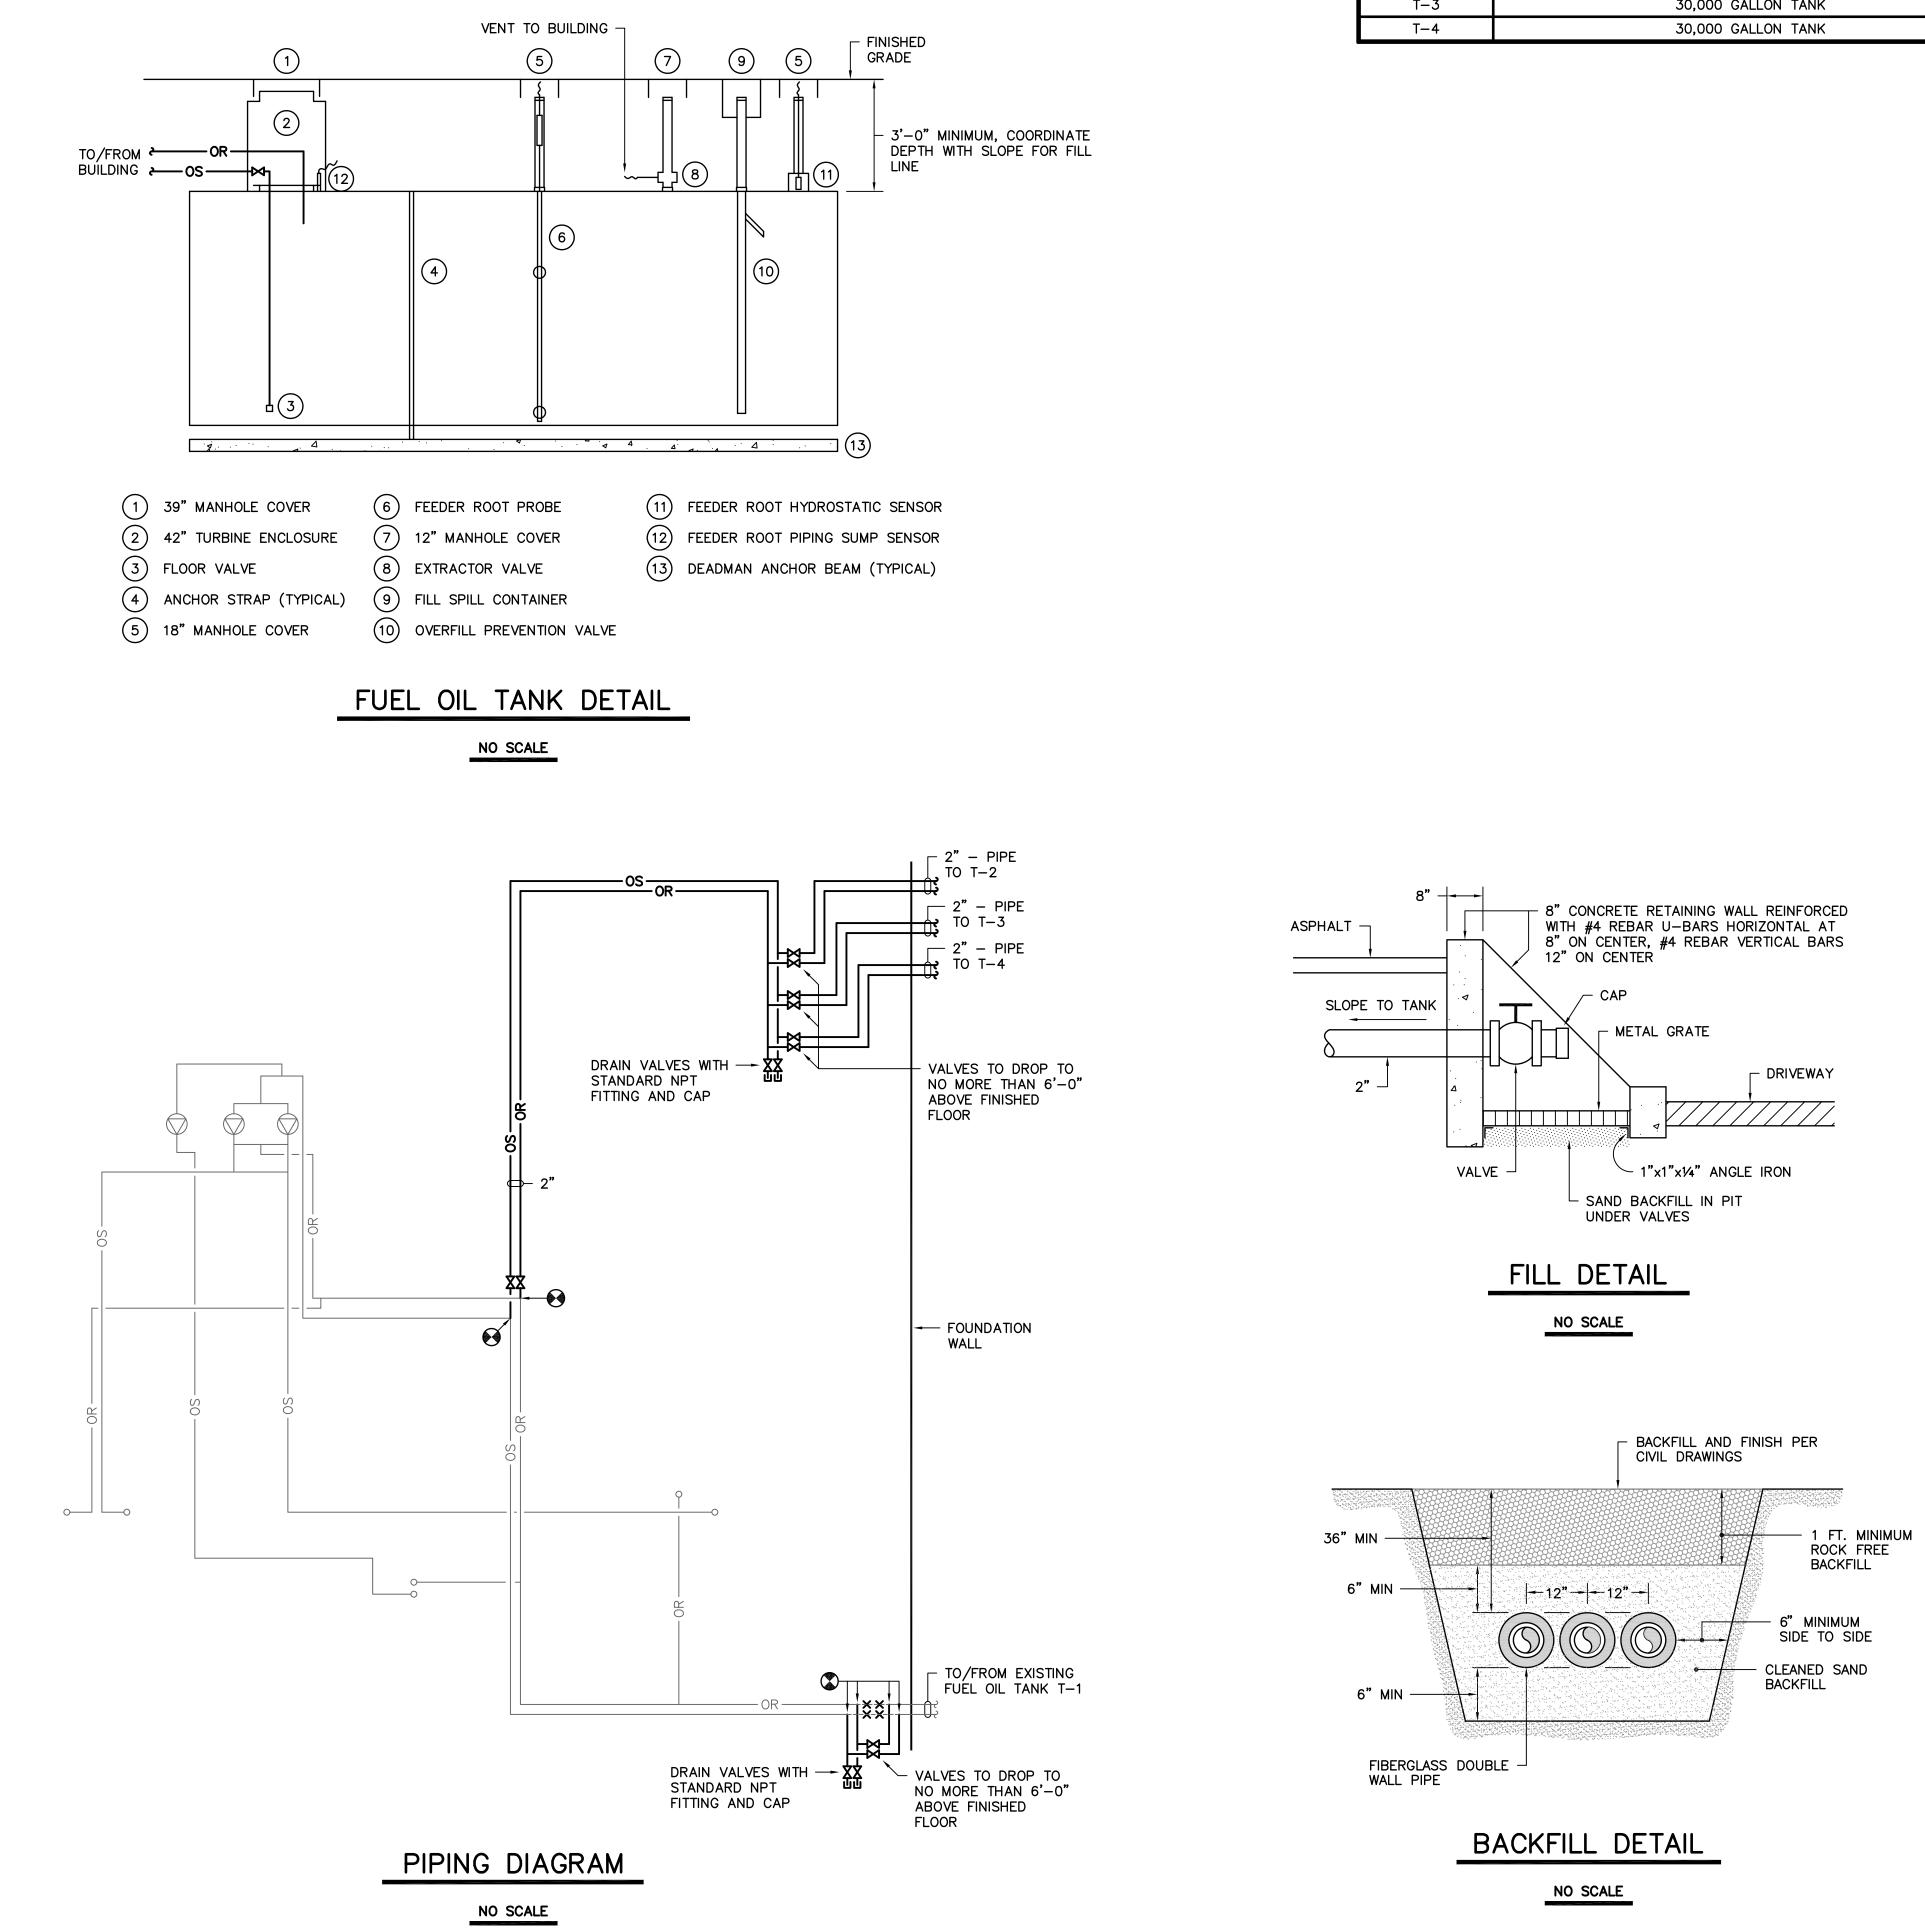
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SWYGERT AND ASSOCIATES, LTD. NO. CO0227	Swygert & Associa CONSULTING ENGINE DBA Swygert & Assoc., Ltd. Post Office Box 11686 Columbia, S.C. 29211 Telephone: (803) Facsimile: (803) mail@swygert-ass	ERS	SHEET IN	M1 of set: of



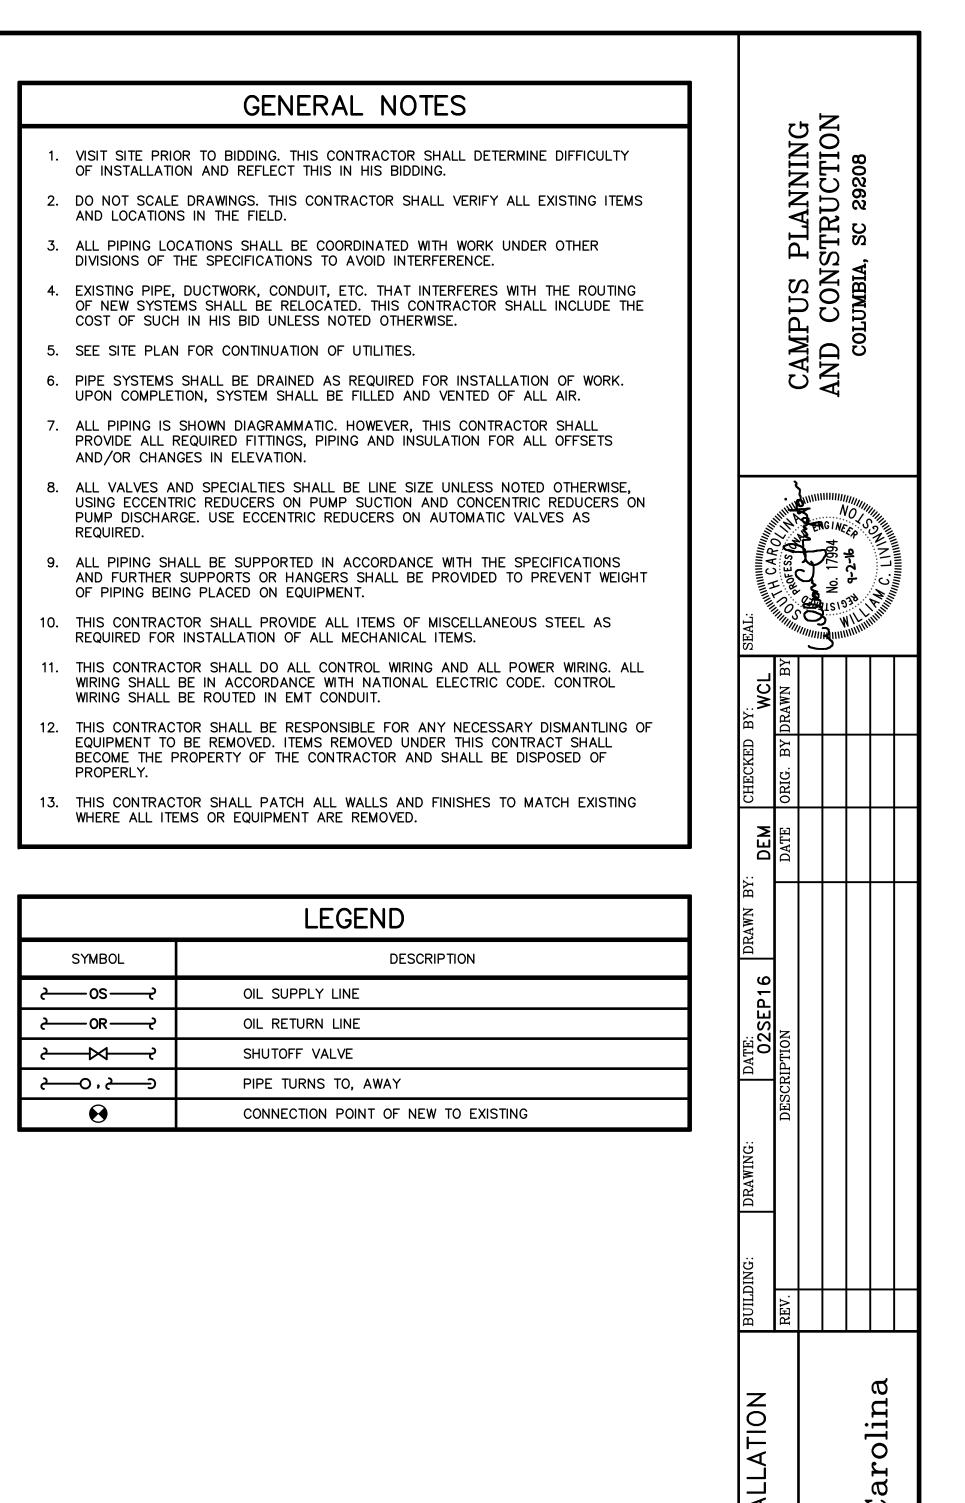


N (1) WEST ENERGY FACILITY BASEMENT FLOOR PLAN N2) SCALE: 1/8" = 1'-0"

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	TANK SCHEDULE
TAG	MODEL
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