

Spartanburg, South Carolina

UPSTATE ADMINISTRATION BUILDING REPAIRS AND RENOVATIONS - REBID

State Project #H34-9541-JV-B **GMK Project #11049.03** October 23, 2015 CONSTRUCTION DOCUMENTS

Prepared by:



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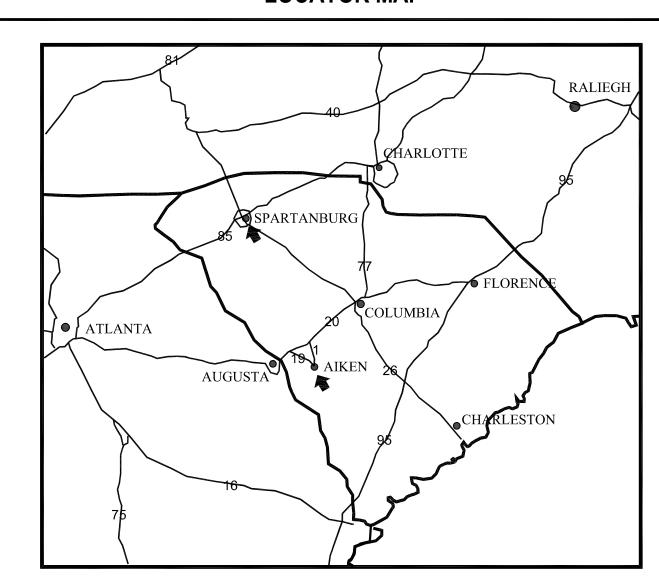
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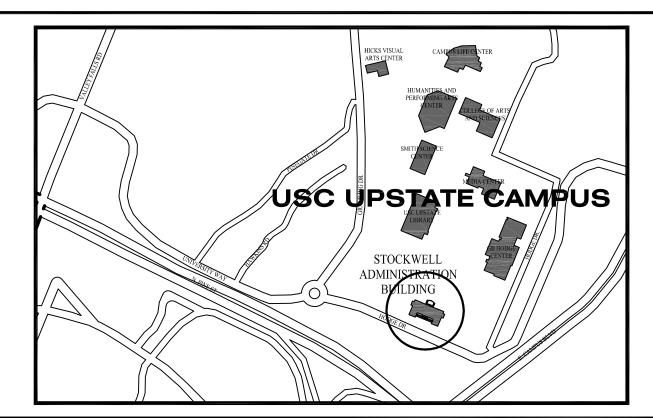
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LOCATOR MAP



KEY PLAN



GENERAL NOTES:

1. ALL CONTRACTORS/SUBCONTRACTORS/PERSONS THAT WILL BE ENGAGED IN LAND DISTRUBING ACTIVITIES SHALL COMPLY WITH ALL EROSION CONTROL AND STORMWATER POLLUTION PREVENTION REQUIREMENTS CONTAINED THROUGHOUT THE DRAWINGS, SPECIFICATIONS AND PERMITS.

- 2. TOPOGRAPHIC INFORMATION WAS PROVIDED GRAMLING BROTHERS SURVEYING, INC, PO BOX 389, GRAMLING, SC 29348, PHONE: 864.472.2157
- 3. CONTRACTOR TO MAINTAIN ACCESS TO ALL DRIVEWAYS AND ROADWAYS DURING CONSTRUCTION.

4. THE EXISTING UNDERGROUND UTILITIES SHOWN HEREON ARE BASED UPON AVAILABLE INFORMATION. THE CONTRACTOR SHALL BE RESPONSIBLE FOR DETERMINING THE EXACT LOCATION OF ALL UTILITIES PRIOR TO BEGINNING ANY WORK. IF UTILITIES OTHER THAN THOSE SHOWN HEREON ARE ENCOUNTERED, THE CONTRACTOR SHALL NOTIFY THE ENGINEER IMMEDIATELY AND TAKE APPROPRIATE MEASURES TO PROTECT THE LINE(S) AND ENSURE CONTINUED SERVICE. DAMAGE CAUSED TO EXISTING UTILITIES BY THE CONTRACTOR SHALL BE REPAIRED BY THE CONTRACTOR AT NO ADDITIONAL COST TO THE OWNER. THE CONTRACTOR SHALL VERIFY THE CONNECTION POINTS OF NEW UTILITIES TO EXISTING UTILITIES PRIOR TO BEGINNING CONSTRUCTION.

- 5. THE CONTRACTOR SHALL INSTALL TREE PROTECTION BARRICADES PRIOR TO BEGINNING EARTHWORK OPERATIONS, IF REQUIRED.
- 6. OFF-SITE BORROW NECESSARY FOR THE CONSTRUCTION OF THIS PROJECT SHALL BE PROVIDED BY THE CONTRACTOR FROM SOURCES DEVELOPED BY THE CONTRACTOR.
- 7. THE CONTRACTOR SHALL NOTIFY THE ENGINEER IF UNSUITABLE MATERIAL IS DISCOVERED PRIOR TO BEGINNING ANY REMOVAL OPERATION.
- 8. THE CONTRACTOR SHALL GRADE DISTURBED AREA TO MATCH EXISTING CONDITIONS AND SOD AREAS THAT WERE PREVIOUSLY GRASSED. THE OWNER WILL INSTALL PLANTS IN THE ORNAMENTAL LANDSCAPE BEDS.

9. ALL TRAFFIC CONTROL SIGNS AND PAVEMENT MARKINGS SHALL BE IN ACCORDANCE WITH THE MANUAL ON UNIFORM TRAFFIC CONTROL DEVICES FOR STREETS AND HIGHWAYS AND THE SOUTH CAROLINA MANUAL ON UNIFORM TRAFFIC CONTROL DEVICES, BOTH CURRENT EDITIONS.

- 10. CONTRACTOR SHALL GRADE ALL AREAS TO DRAIN FOR POSITIVE FLOW PRIOR TO FINAL APPROVAL. CONTRACTOR TO ENSURE POSITIVE DRAINAGE AWAY FROM THE BUILDING.
- 11. THE DESIGN ADEQUACY AND SAFETY OF ALL BRACING, SHORING AND TEMPORARY SUPPORTS, ETC. IS THE SOLE RESPONSIBILITY OF THE CONTRACTOR.
- 12. THE GENERAL CONTRACTOR SHALL REVIEW AND STAMP APPROVED ANY AND ALL SHOP DRAWINGS AND SUBMITTALS PRIOR TO SUBMITTING TO THE ENGINEER FOR REVIEW.
- 13. IT IS THE RESPONSIBILITY OF THE OWNER TO OBTAIN THE SERVICES OF A QUALIFIED GEOTECHNICAL ENGINEER WHO SHALL PERFORM INVESTIGATIONS TO VERIFY THAT THE SOIL CONDITIONS ARE AT LEAST THAT WHICH ARE STATED HEREIN.
- 14. ALL WORK WILL BE PERFORMED IN ACCORDANCE WITH THE REQUIREMENTS OF SPARTANBURG COUNTY AND SCDHEC.
- 15. IN PERFORMING CONSTRUCTION OBSERVATION VISITS TO THE JOBSITE, THE ENGINEER SHALL HAVE NO CONTROL OVER NOR RESPONSIBILITY FOR THE CONTRACTOR'S MEANS, METHODS, SEQUENCE, TECHNIQUES OR PROCEDURES IN PERFORMING THE WORK.
- 16. THE CONTRACTOR'S MEANS, METHODS, SEQUENCE, TECHNIQUES OR PROCEDURES IN PERFORMING THE WORK IS SOLELY THE RESPONSIBILITY OF THE CONTRACTOR, WHO IS ALSO RESPONSIBLE FOR COMPLYING WITH ALL HEALTH AND SAFETY PRECAUTIONS AS REQUIRED BY ANY REGULATORY AGENCY AND THE SPECIFICATIONS DEVELOPED FOR THIS SCOPE OF WORK.

17. IT IS THE CONTRACTOR'S RESPONSIBILTY FOR DESIGN, ADEQUACY AND IMPLEMENTATION OF ALL DEWATERING. DISCHARGES FROM DEWATERING DEVICES SHALL BE EQUIPPED SO AS TO PREVENT EROSION AND/OR DEPOSITION OF SEDIMENT BEYOND CONSTRUCTION LIMITS.

- 18. ALL DEMOLITION MATERIAL TO BE HAULED OFF SITE AT CONTRACTOR'S EXPENSE.
- 19. TOTAL LAND DISTURBANCE IS 0.2 ACRES. SEE EROSION CONTROL PLAN SHEET FOR LIMITS OF CONSTRUCTION.
- 20. CONTRACTOR TO PROVIDE AS-BUILT OF NEW STORM DRAINAGE LINES AND STORM DRAINAGE BOXES IN AN AUTOCAD FORMAT ON THE SAME COORDINATE SYSTEM AS THE ORIGINAL DRAWINGS

EROSION CONTROL NOTES:

BE INITIATED AS SOON AS PRACTICABLE.

1. IF NECESSARY, SLOPES WHICH EXCEED EIGHT (8) VERTICAL FEET SHOULD BE STABILIZED WITH SYNTHETIC OR VEGETATIVE MATS, IN ADDITION TO GRASSING/HYDROSEEDING. IT MAY BE NECESSARY TO INSTALL TEMPORARY SLOPE DRAINS DURING CONSTRUCTION. TEMPORARY BERMS MAY BE NEEDED UNTIL THE SLOPE IS BROUGHT TO GRADE.

2. STABILIZATION MEASURES SHALL BE INITIATED AS SOON AS PRACTICABLE IN PORTIONS OF THE SITE WHERE CONSTRUCTION ACTIVITIES HAVE TEMPORARILY OR PERMANENTLY CEASED, BUT IN NO CASE MORE THAN FOURTEEN (14) DAYS AFTER WORK HAS CEASED, EXCEPT AS STATED BELOW.

**WHERE STABILIZATION BY THE 14TH DAY IS PRECLUDED BY SNOW COVER OR FROZEN GROUND CONDITIONS STABLILZATION MEASURES MUST

»WHERE CONSTRUCTION ACTIVITY ON A PORTION OF THE SITE IS TEMPORARILY CEASED, AND EARTH-DISTURBING ACTIVITIES WILL BE RESUMED WITHIN 14 DAYS, TEMPORARY STABILIZATION MEASURES DO NOT HAVE TO BE INITIATED ON THAT PORTION OF THE SITE.

3. ALL SEDIMENT AND EROSION CONTROL DEVICES SHALL BE INSPECTED ONCE EVERY CALENDAR WEEK. IF PERIODIC INSPECTION OR OTHER INFORMATION INDICATES THAT A BMP HAS BEEN INAPPROPRIATELY INSTALLED, THE PERMITTEE MUST ADDRESS THE NECESSARY REPLACEMENT OR MODIFICATION REQUIRED TO CORRECT THE BMP WITHIN 48 HOURS OF IDENTIFICATION.

4. PROVIDE SILT FENCE AND/OR OTHER CONTROL DEVICES, AS MAY BE REQUIRED, TO CONTROL SOIL EROSION DURING UTILITY CONSTRUCTION. ALL DISTURBED AREAS SHALL BE CLEANED, GRADED, AND STABILIZED WITH GRASSING IMMEDIATELY AFTER THE UTILITY INSTALLATION. FILL, COVER, AND TEMPORARY SEEDING AT THE END OF EACH DAY ARE RECOMMENDED. IF WATER SHOULD BE FILTERED TO REMOVE ANY SEDIMENTS BEFORE BEING PUMPED BACK INTO ANY WATERS OF THE

5. ALL EROSION CONTROL DEVICES SHALL BE PROPERLY MAINTAINED DURING ALL PHASES OF CONSTRUCTION UNTIL THE COMPLETION OF ALL CONSTRUCTION ACTIVITIES AND ALL DISTURBED AREAS HAVE BEEN STABILIZED. ADDITIONAL CONTROL DEVICES MAY BE REQUIRED DURING CONSTRUCTION, IN ORDER TO CONTROL EROSION AND/OR OFFSITE SEDIMENTATION. ALL TEMPORARY CONTROL DEVICES SHALL BE REMOVED ONCE CONSTRUCTION IS COMPLETED AND THE SITE IS STABILIZED.

6. THE CONTRACTOR MUST TAKE NECESSARY ACTION TO MINIMIZE TRACKING OF MUD ONTO PAVED ROADWAY(S) FROM CONSTRUCTION AREAS AND THE GENERATION OF DUST. THE CONTRACTOR SHALL DAILY REMOVE MUD/SOIL FROM PAVEMENT, AS MAY BE REQUIRED.

7. RESIDENTIAL SUBDIVISIONS REQUIRE EROSION CONTROL FEATURES FOR INFRASTRUCTURE AS WELL AS FOR INDIVIDUAL LOT CONSTRUCTION. INDIVIDUAL PROPERTY OWNERS SHALL FOLLOW THESE PLANS DURING CONSTRUCTION OR OBTAIN APPROVAL OF AN INDIVIDUAL PLAN IN

8. TEMPORARY DIVERSION BERMS AND/OR DITCHES WILL BE PROVIDED AS NEEDED DURING CONSTRUCTION TO PROTECT WORK AREAS FROM UPSLOPE RUNOFF AND/OR DIVERT SEDIMENT LADEN WATER TO APPROPRIATE TRAPS OR STABLE OUTLETS.

9. ALL WATERS OF THE STATE (WoS), INCLUDING WETLANDS, ARE TO BE FLAGGED OR OTHERWISE CLEARLY MARKED IN THE FIELD. A DOUBLE ROW OF SILT FENCE IS TO BE INSTALLED IN ALL AREAS WHERE A 50-FT BUFFER CAN'T BE MAINTAINED BETWEEN THE LAST ROW OF SILT FENCE AND ALL WoS.

10. LITTER, CONSTRUCTION DEBRIS, OILS, FUELS, AND BUILDING PRODUCTS WITH SIGNIFICANT POTENTIAL FOR IMPACT (SUCH AS STOCKPILES OF FRESHLY TREATED LUMBER) AND CONSTRUCTION CHEMICALS THAT COULD BE EXPOSED TO STORM WATER MUST BE PREVENTED FROM BECOMING A POLLUTANT SOURCE IN STORM WATER DISCHARGES.

11. A COPY OF THE SWPPP, INSPECTION RECORDS, AND RAINFALL DATA MUST BE RETAINED AT THE CONSTRUCTION SITE OR A NEARBY LOCATION EASILY ACCESSIBLE DURING NORMAL BUSINESS HOURS. FROM THE DATE OF COMMENCEMENT OF CONSTRUCTION ACTIVITIES TO

THE DATE THAT THE FINAL STABILIZATION IS REACHED.

12. INITIATE STABILIZATION MEASURES ON ANY EXPOSED SLOPE (3H:1V OR GREATER) WHERE LAND-DISTURBIUNG ACTIVITIES HAVE PERMANENTLY OR TEMPORARILY CEASED, AND WILL NOT RESUME FOR A PERIOD OF SEVEN (7) CALENDAR DAYS.

13. MINIMIZE SOIL COMPACTION AND, UNLESS INFEASIBLE, PRESERVE TOPSOIL.

14. MINMIMZE THE DISCHARGE OF POLLUTANTS FROM EQUIPMENT AND VEHICLE WASHING, WHEEL WASH WATER, AND OTHER WASH WATERS. WASH WATERS MUST BE TREATED IN A SEDIMENT BASIN OR ALTERNATIVE CONTROL THAT PROVIDES EQUIVALENT OR BETTER TREATMENT PRIOR TO DISCHARGE.

15. MINIMIZE THE DISCHARGE OF POLLUTANTS FROM DEWATERING OF TRENCHES AND EXCAVATED AREAS. THESE DISCHARGES ARE TO BE ROUTED THROUGH APPROPRIATE BMPs (SEDIMENT BASIN, FILTER BAG, ETC.).

16. THE FOLLOWING DISCHARGES FROM SITES ARE PROHIBITED:

**WASTEWATER FROM WASHOUT OF CONCRETE, UNLESS MANAGED BY AN APPROPRIATE CONTROL

ACCORDANCE WITH S.C. REG. 72-300 ET SEQ AND SCR100000.

»WASTEWATER FROM WASHOUT AND CLEANOUT OF STUCCO, PAINT, FROM RELEASE OILS, CURING COMPOUNDS AND OTHER CONSTRUCTION MATERIALS »FUELS, OILS, OR OTHER POLLUTANTS USED IN VEHICLE AND EQUIPMENT OPERATION AND MAINTENANCE »SOAPS OR SOLVENTS USED IN VEHICLE AND EQUIPMENT WASHING

17. AFTER CONSTRUCTION ACTIVITIES BEGIN, INSPECTIONS MUST BE CONDUCTED AT A MINIMUM OF AT LEAST ONCE EVERY CALENDAR WEEK AND MUST BE CONDUCTED UNTIL FINAL STABILIZATION IS REACHED ON ALL AREAS OF THE CONSTRUCTION SITE.

18. IF EXISTING BMPs NEED TO BE MODIFIED OR IF ADDITIONAL BMPs ARE NECESSARY TO COMPLY WITH THE REQUIREMENTS OF THIS PERMIT AND/OR SC'S WATER QUALITY STANDARDS, IMPLEMENTATION MUST BE COMPLETED BEFORE THE NEXT STORM EVENT WHENEVER PRACTICABLE. IF IMPLEMENTATION BEFORE THE NEXT STORM EVENT IS IMPRACTICABLE, THE SITUATION MUST BE DOCUMENTED IN THE SWPPP AND ALTERNATIVE BMPs MUST BE IMPLEMENTED AS SOON AS REASONABLY POSSIBLE.

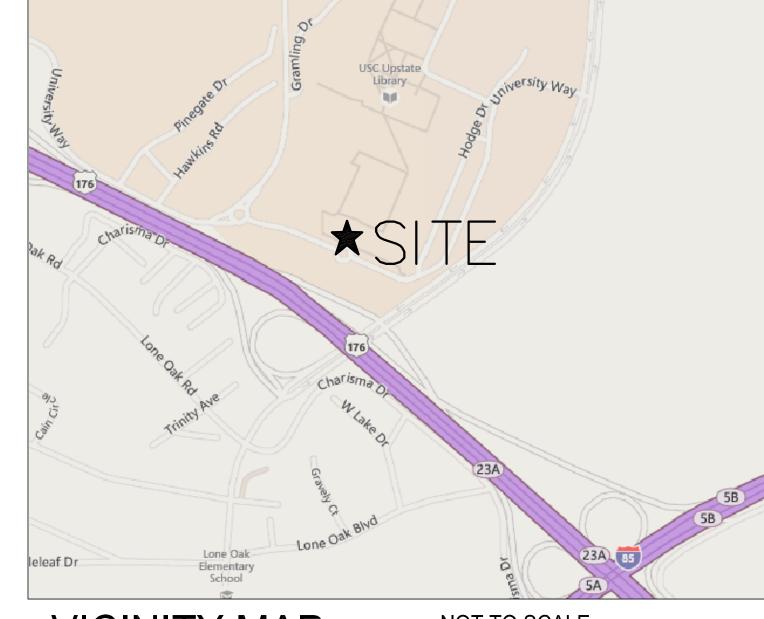
19. A PRE-CONSTRUCTION CONFERENCE MUST BE HELD FOR EACH CONSTRUCTION SITE WITH AN APPROVED ON-SITE SWPPP PRIOR TO THE IMPLEMENTATION OF CONSTRUCTION ACTIVITIES. FOR NON-LINEAR PROJECTS THAT DISTURB MORE THAN 10 ACRES OR MORE THIS CONFERENCE MUST BE HELD ON-SITE UNLESS THE DEPARTMENT HAS APPROVED OTHERWISE.

SEQUENCE OF CONSTRUCTION:

ITEMS MUST OCCUR IN THE ORDER LISTED; ITEMS CANNOT OCCUR CONCURRENTLY UNTIL SPECIFICALLY NOTED.

- RECEIVE NPDES COVERAGE FROM DHEC.
 PRE-CONSTRUCTION MEETING WITH SPARTANBURG COUNTY STORMWATER MANAGEMENT STAFF PRESENT.
- 3. NOTIFY THE SPARTANBURG COUNTY STORMWATER MANAGEMENT STAFF 48 HOURS PRIOR TO BEGINNING LAND-DISTURBING ACTIVITIES.
 4. INSTALLATION OF CONSTRUCTION ENTRANCE.
- 4. INSTALLATION OF CONSTRUCTION ENTRANCE.
 5. CLEARING AND GRUBBING ONLY AS NECESSARY FOR INSTALLATION OF PERIMETER CONTROLS.
- 6. INSTALLATION OF PERIMETER CONTROLS (E.G. SILT FENCE).
 7. CLEARING AND GRUBBING ONLY IN AREAS OF BASINS/PONDS.
- 8. INSTALLATION OF DETENTION POND AND INSTALLATION OF DIVERSIONS (SWALES) TO THE POND (OUTLET STRUCTURES MUST BE COMPLETELY INSTALLED AS SHOWN ON THE DETAILS BEFORE PROCEEDING TO NEXT STEP; AREAS DRAINING TO THESE STRUCTURES CANNOT BE DISTURBED UNTIL THE STRUCTURES AND DIVERSIONS (SWALES) TO THE STRUCTURE ARE COMPLETELY INSTALLED).
- 9. CLEARING AND GRUBBING OF SITE OR DEMOLITION (SEDIMENT AND EROSION CONTROL MEASURES FOR THESE AREAS MUST ALREADY BE INSTALLED).
- 10. ROUGH GRADING AND BUILDING PAD PREPARATION `
 11. INSTALLATION OF STORM DRAIN SYSTEM AND PLACEMENT OF INLET PROTECTION.
- 12. BUILDING CONSTRUCTION
 13. FINE GRADING, PAVING, ETC.
 14. PERMANENT STABILIZATION OF SITE.
- 15. CLEAN—OUT OF SEDIMENT BASIN THAT WAS USED AS SEDIMENT CONTROL STRUCTURES AND RE—GRADING OF DETENTION POND BOTTOMS; IF NECESSARY, MODIFICATION OF SEDIMENT BASIN RISER TO CONVERT TO DETENTION BASIN OUTLET STRUCTURE.

 16. SEDIMENT REMOVED FROM SEDIMENT BASIN TO BE USED TO FINE GRADE THE SITE IF IT IS SUITABLE MATERIAL FOR SUCH PURPOSES. OTHERWISE MATERIAL TO BE DISPOSED OF OFFSITE.
- 17. REMOVAL OF TEMPORARY SEDIMENT AND EROSION CONTROL MEASURES AFTER ENTIRE AREA DRAINING TO THE STRUCTURE IS FINALLY STABILIZED (THE DEPARTMENT RECOMMENDS THAT THE PROJECT OWNER/OPERATOR HAVE THE SWPPP PREPARER OR REGISTRATION EQUIVALENT APPROVE THE REMOVAL OF TEMPORARY STRUCTURES) ONCE CONSTRUCTION IS COMPLETE THE ITEMS BELOW MUST BE PERFORMED IN THE ORDER SHOWN.
- 18. PERFORM AS—BUILT SURVEYS OF ALL STORM DRAINAGE STRUCTURES AND SUBMIT TO SPARTANBURG COUNTY MS4 FOR COMPLIANCE
 19. SUBMIT NOTICE OF TERMINATION (NOT) TO SPARTANBURG COUNTY MS4 OR SCDHEC AS APPROPRIATE.
- NOTE: MAINTENANCE OF SEDIMENT AND EROSION CONTROL MEASURES MUST CONTINUE UNTIL THE SITE IS PERMANENTLY STABILIZED AND THE CONTROLS ARE REMOVED.



VICINITY MAP

NOT TO SCALE



CALL METRO WATER LOCATE: 864-503-0822



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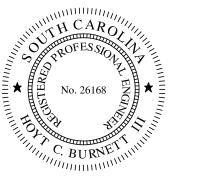
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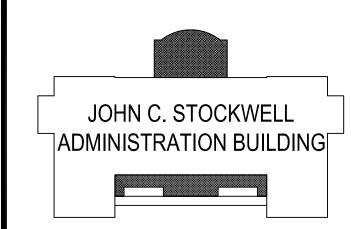
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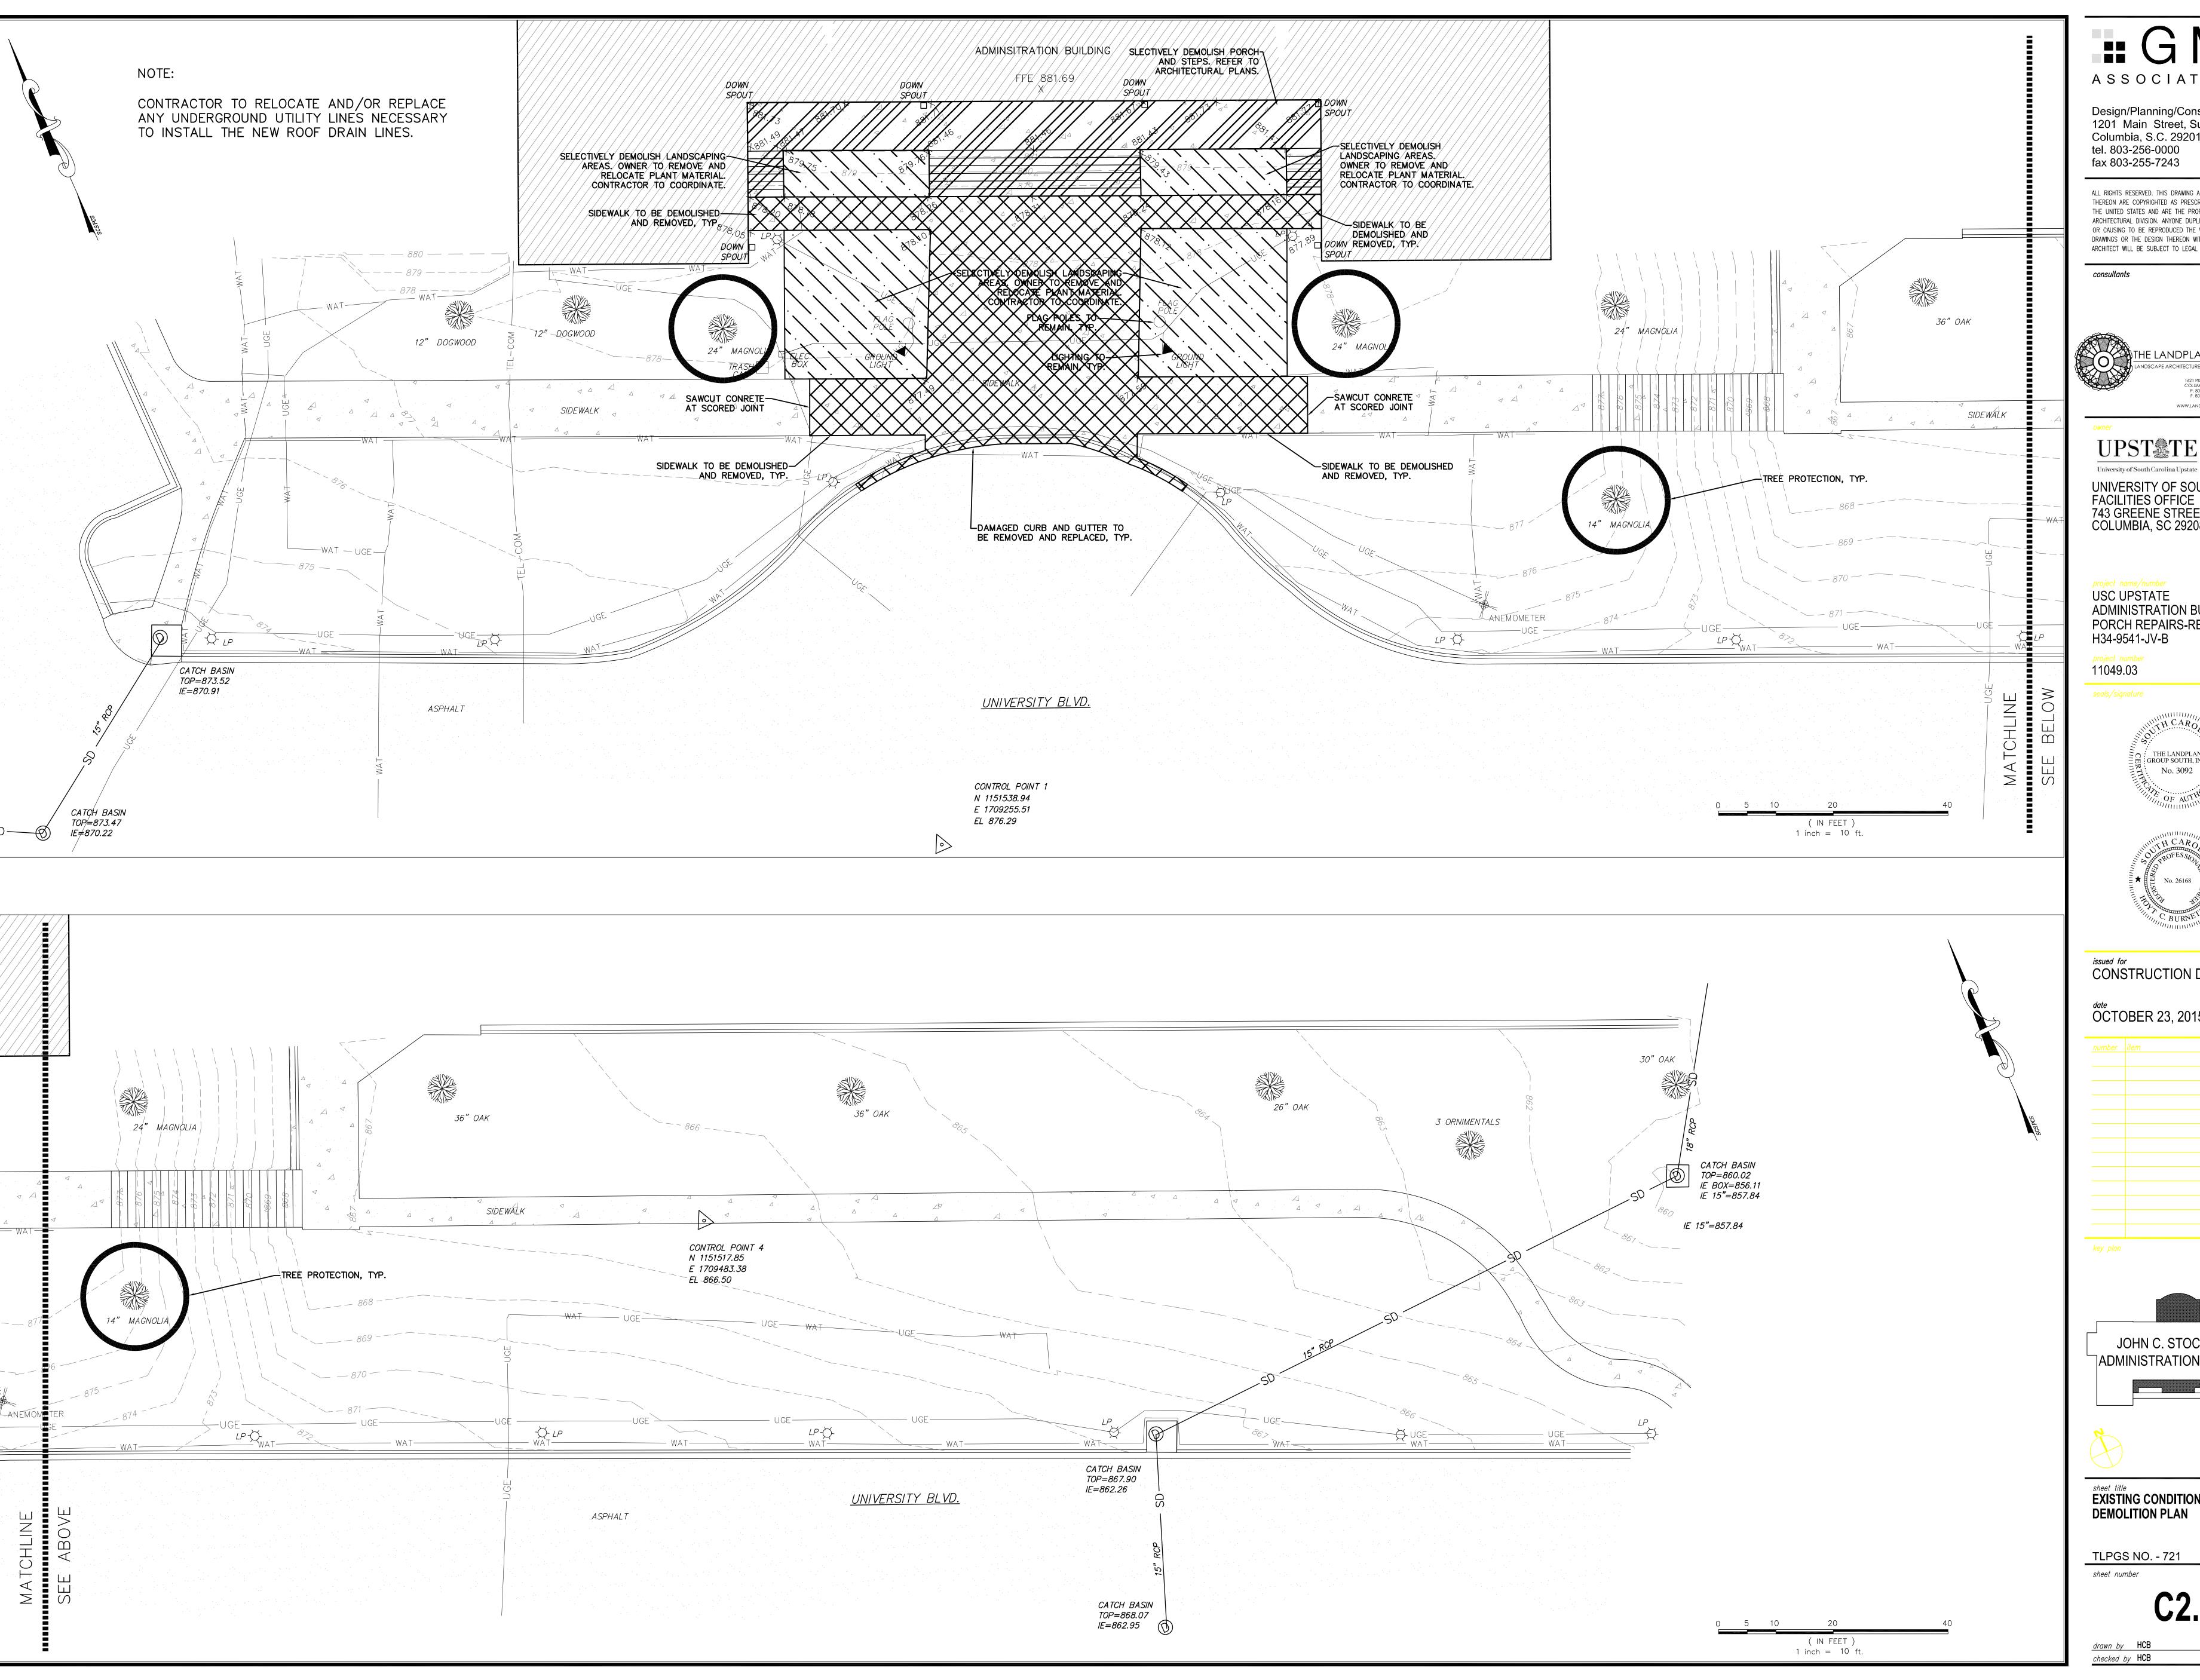
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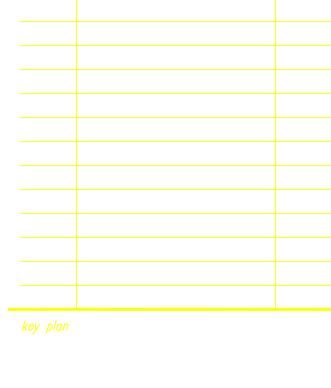
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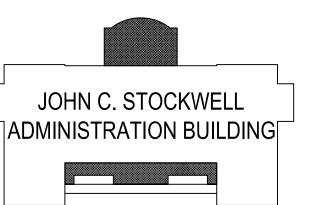




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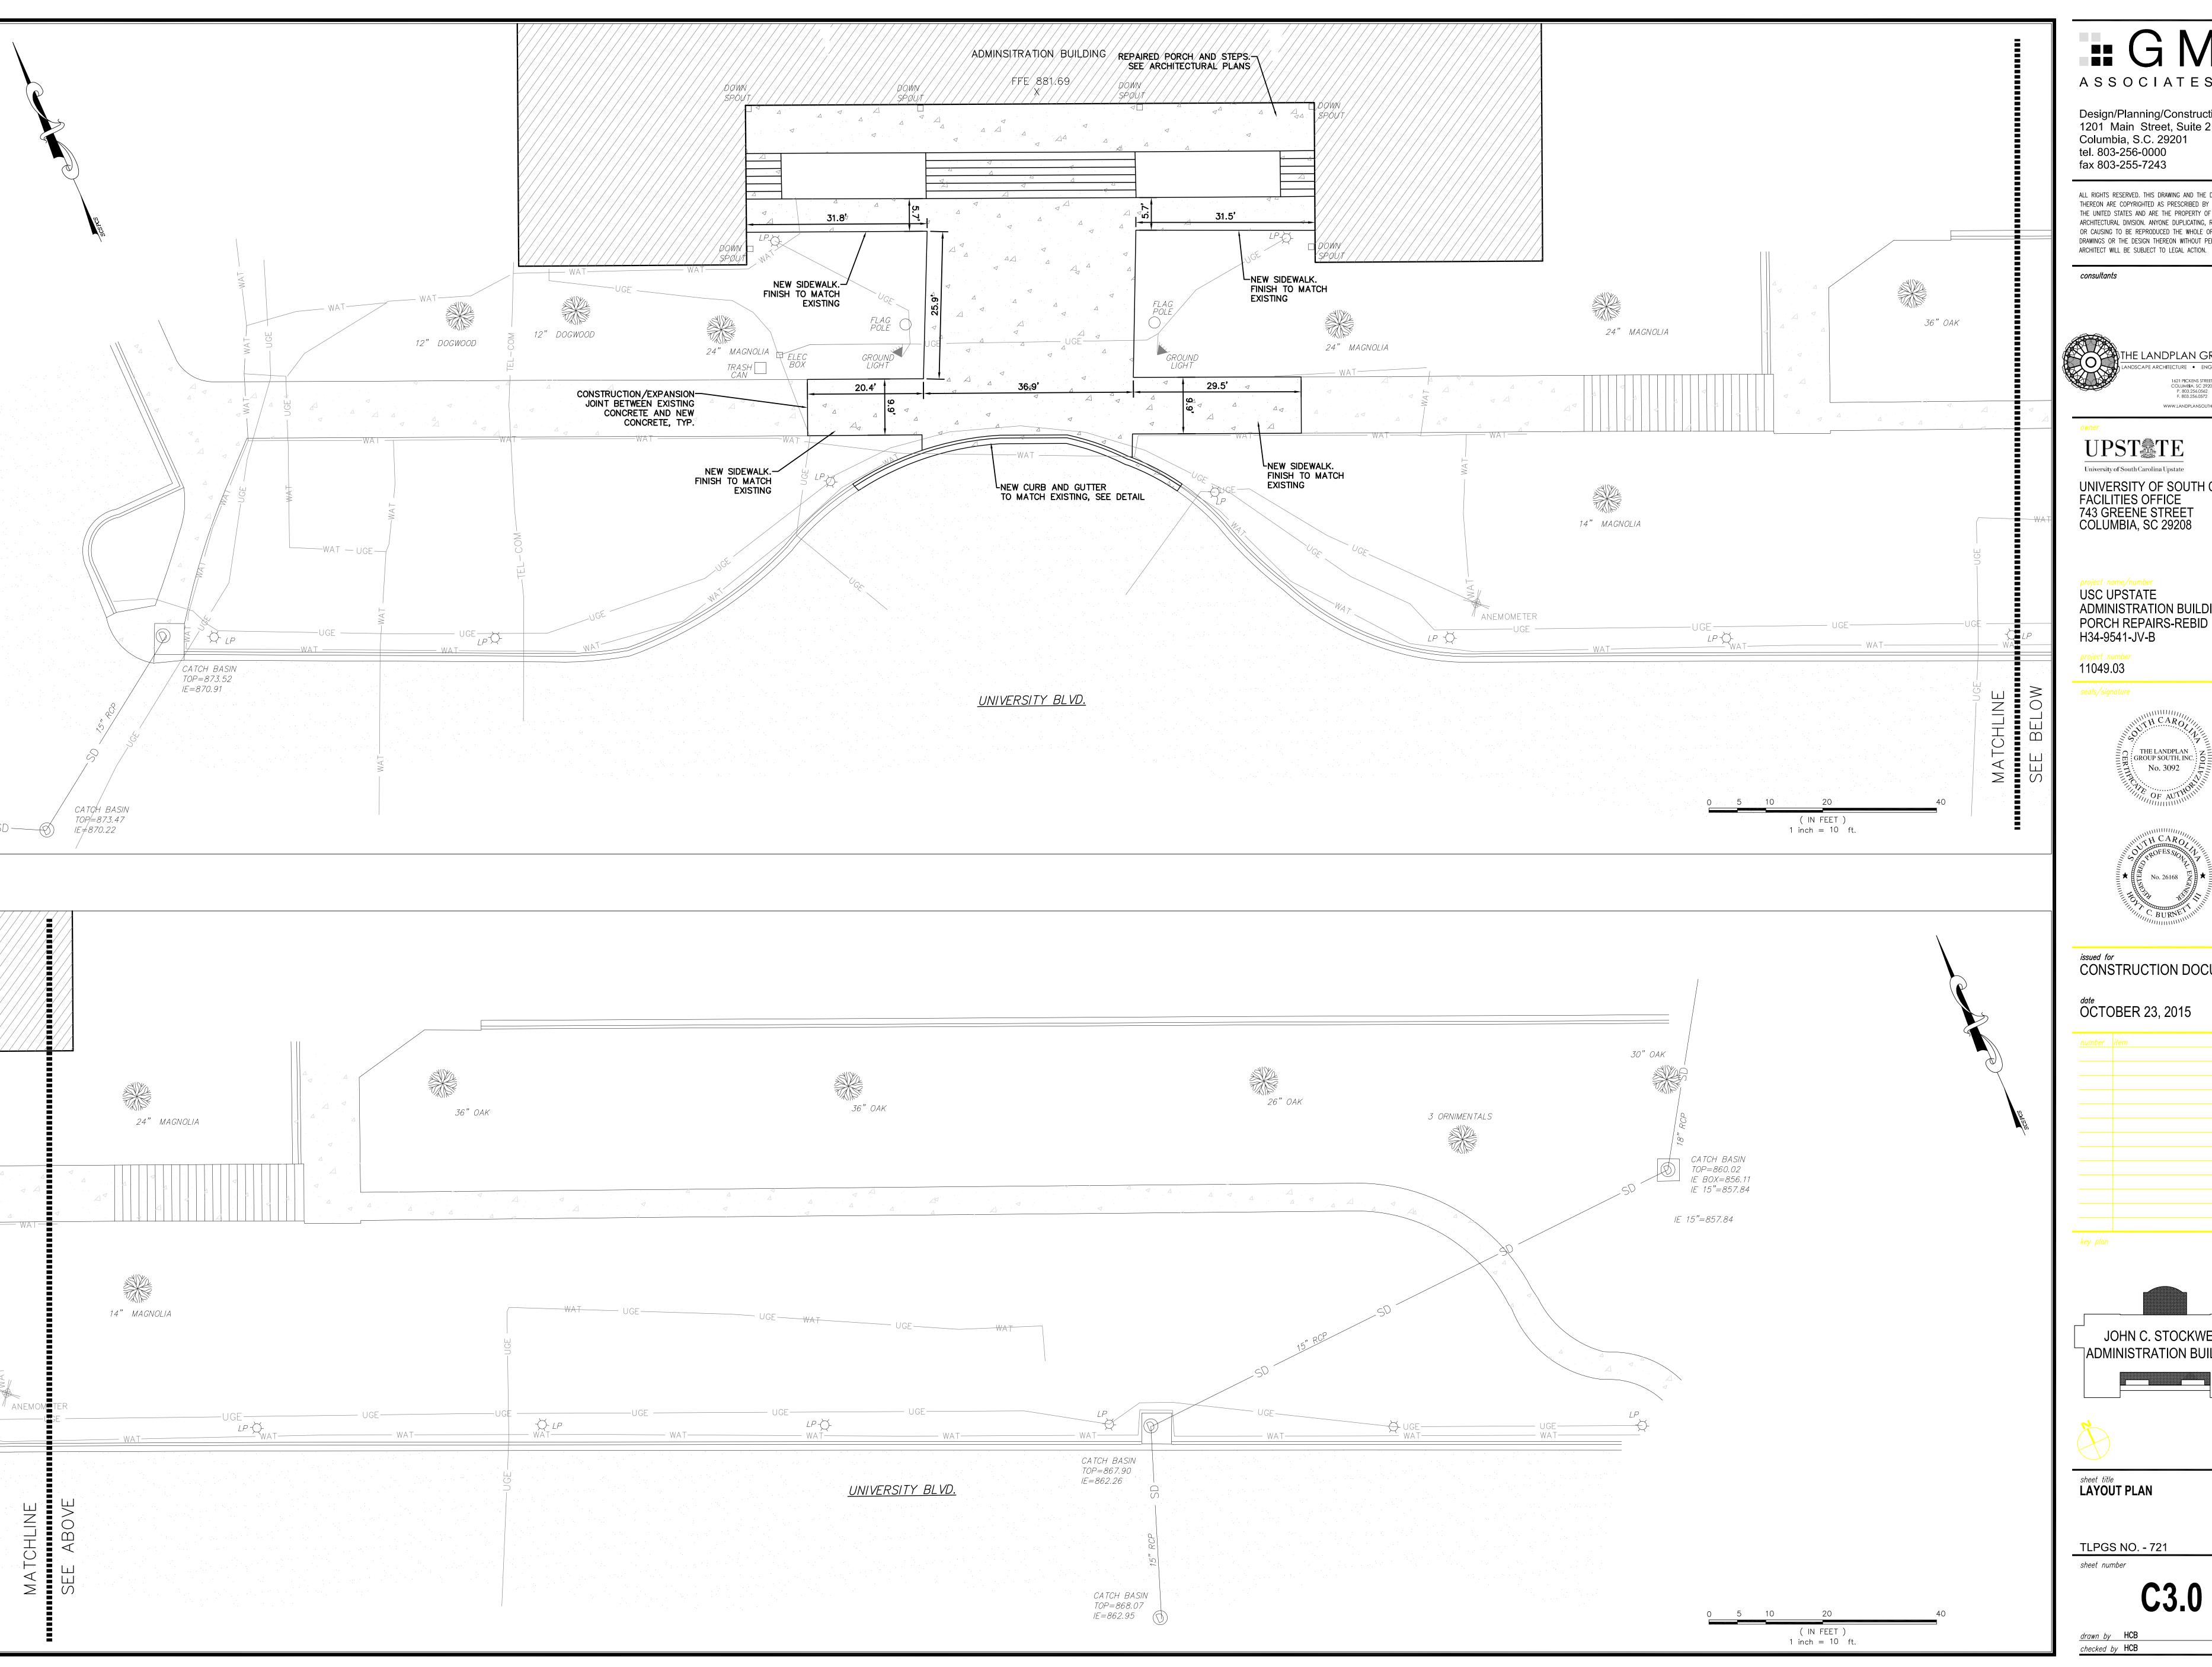
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sheet title **EXISTING CONDITIONS & DEMOLITION PLAN**

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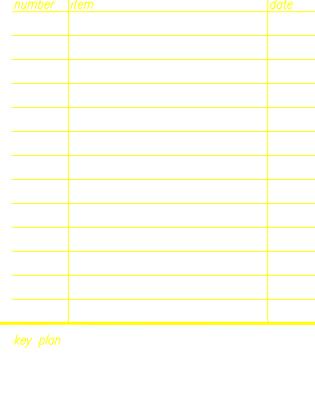
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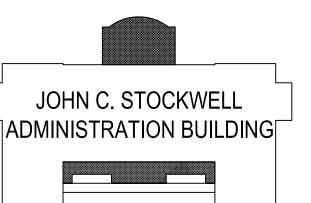




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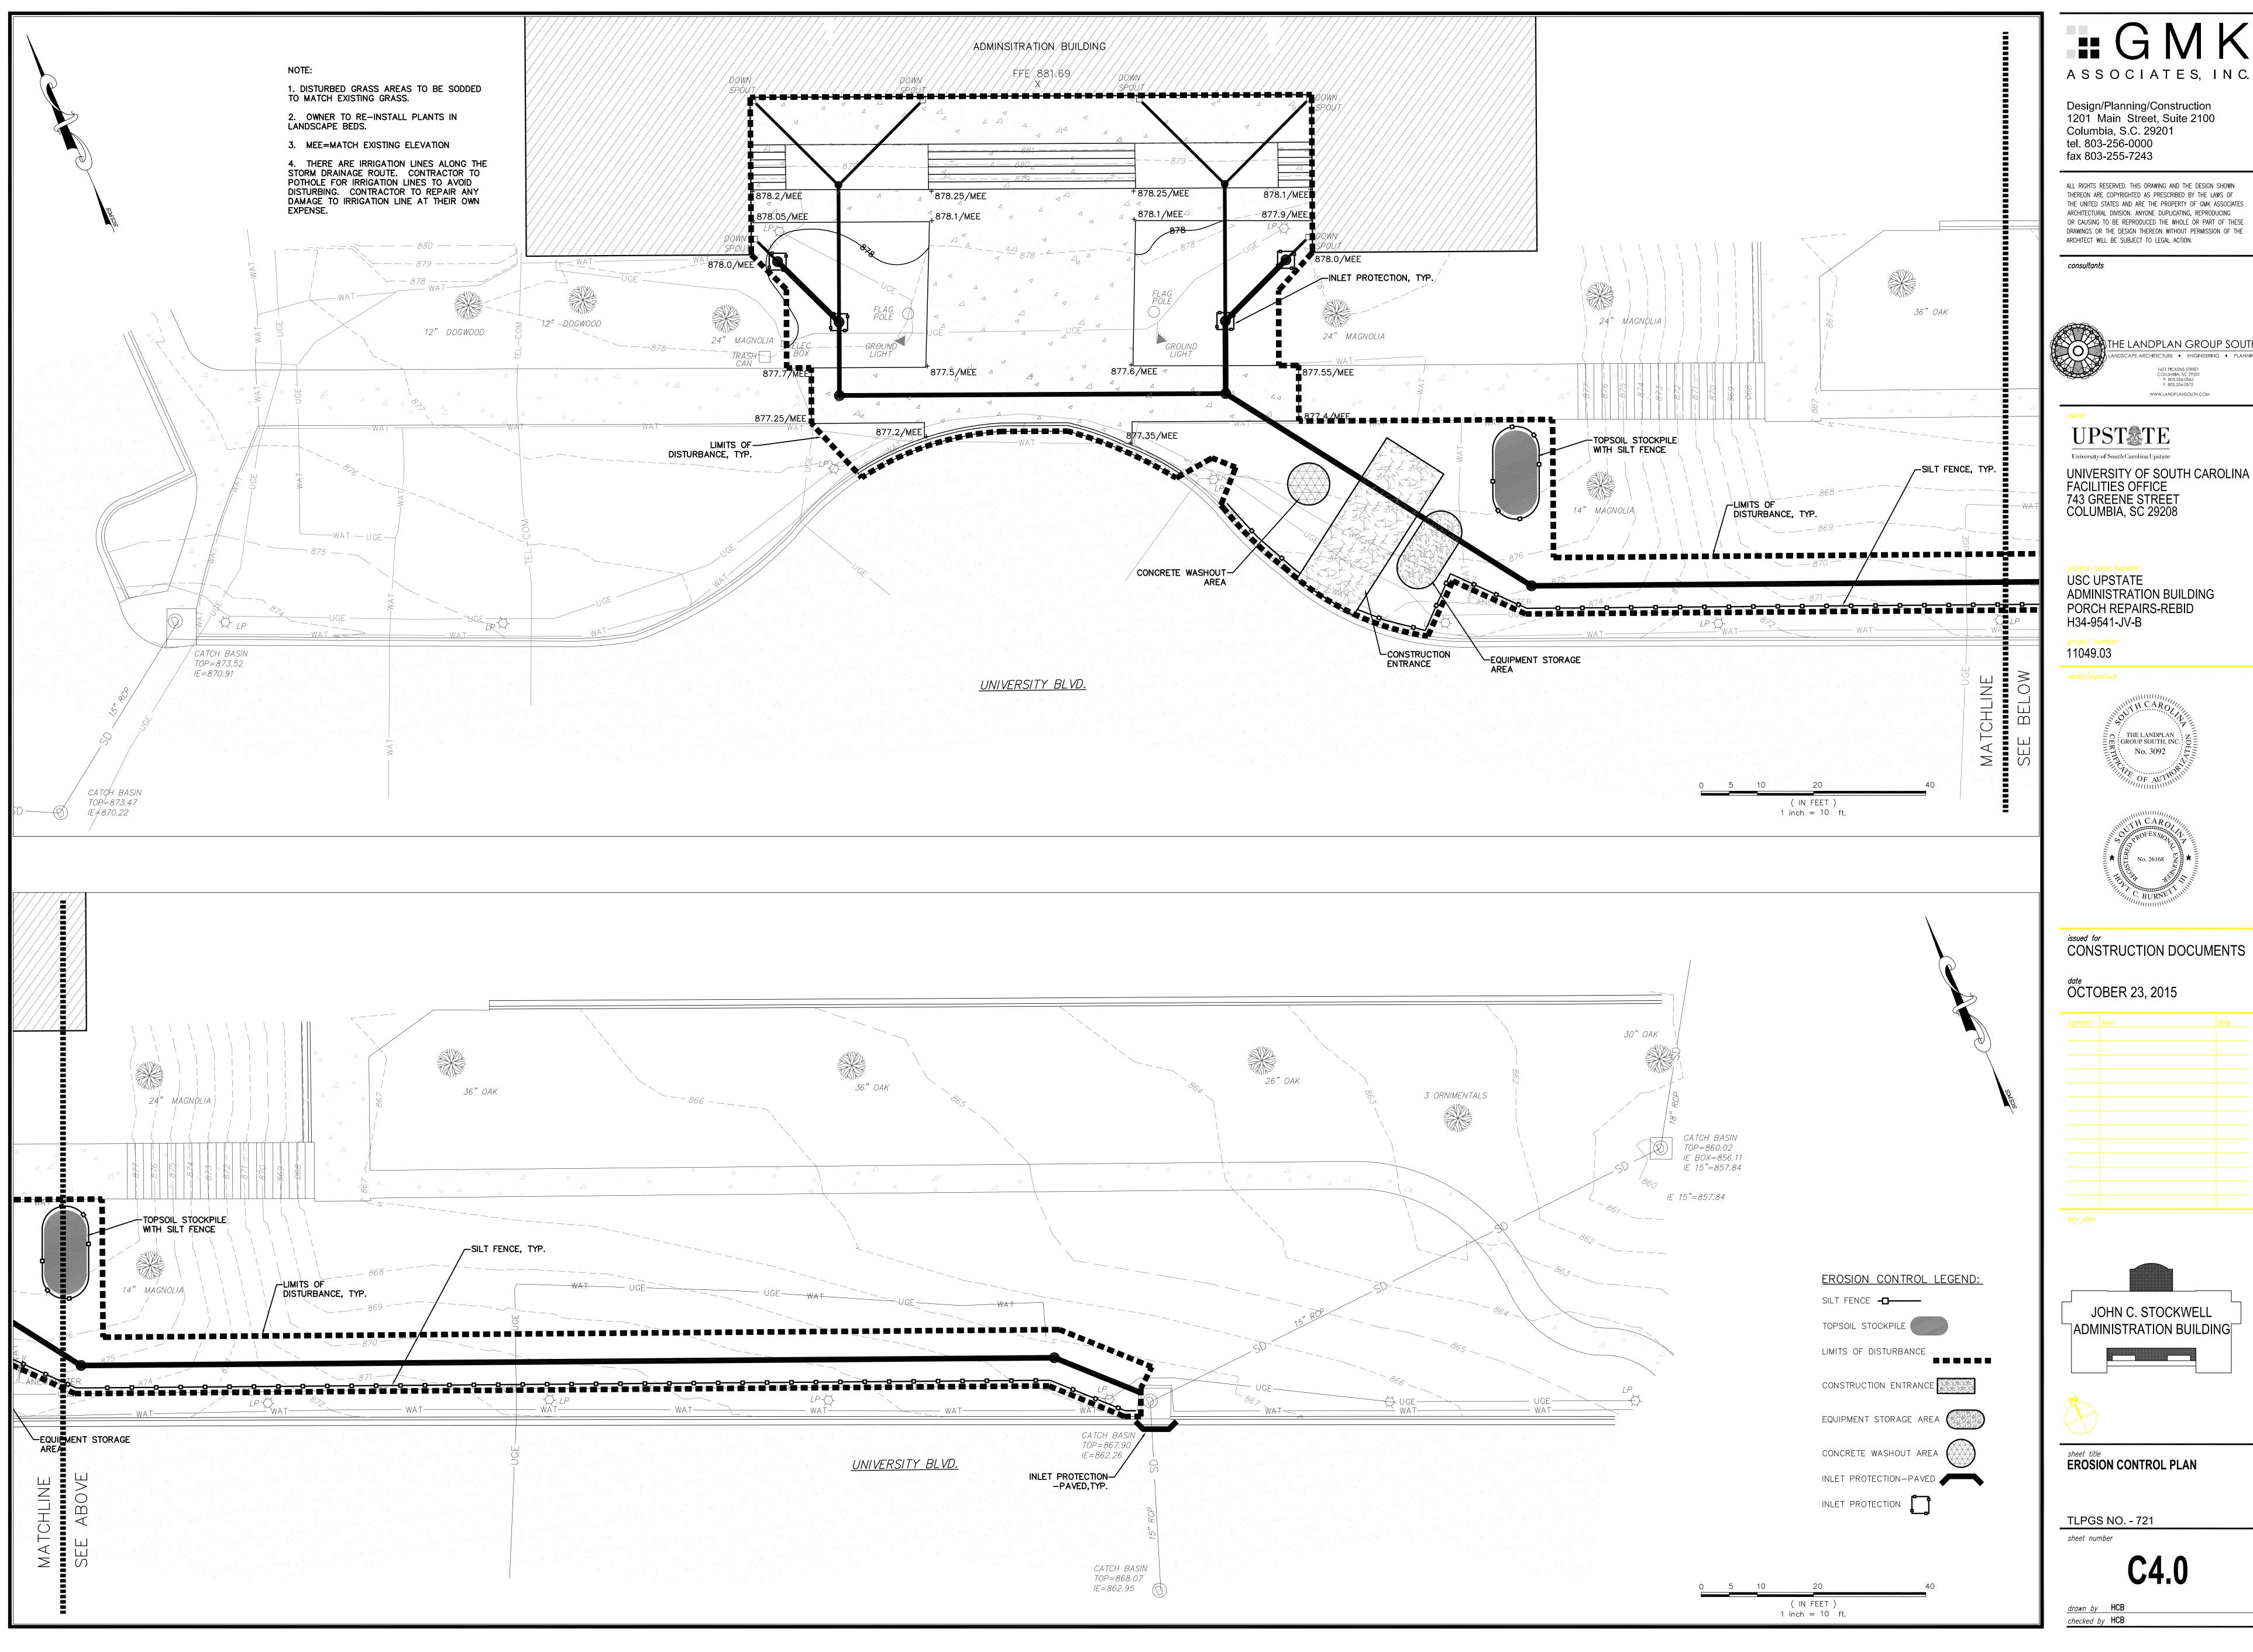




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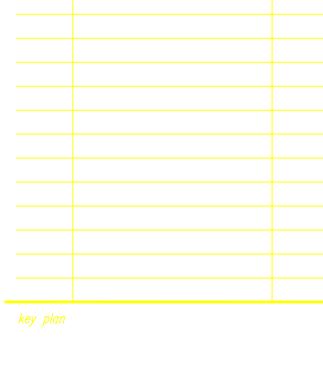
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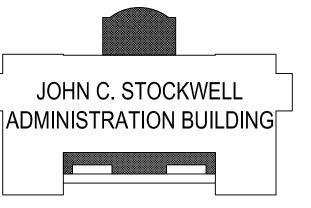
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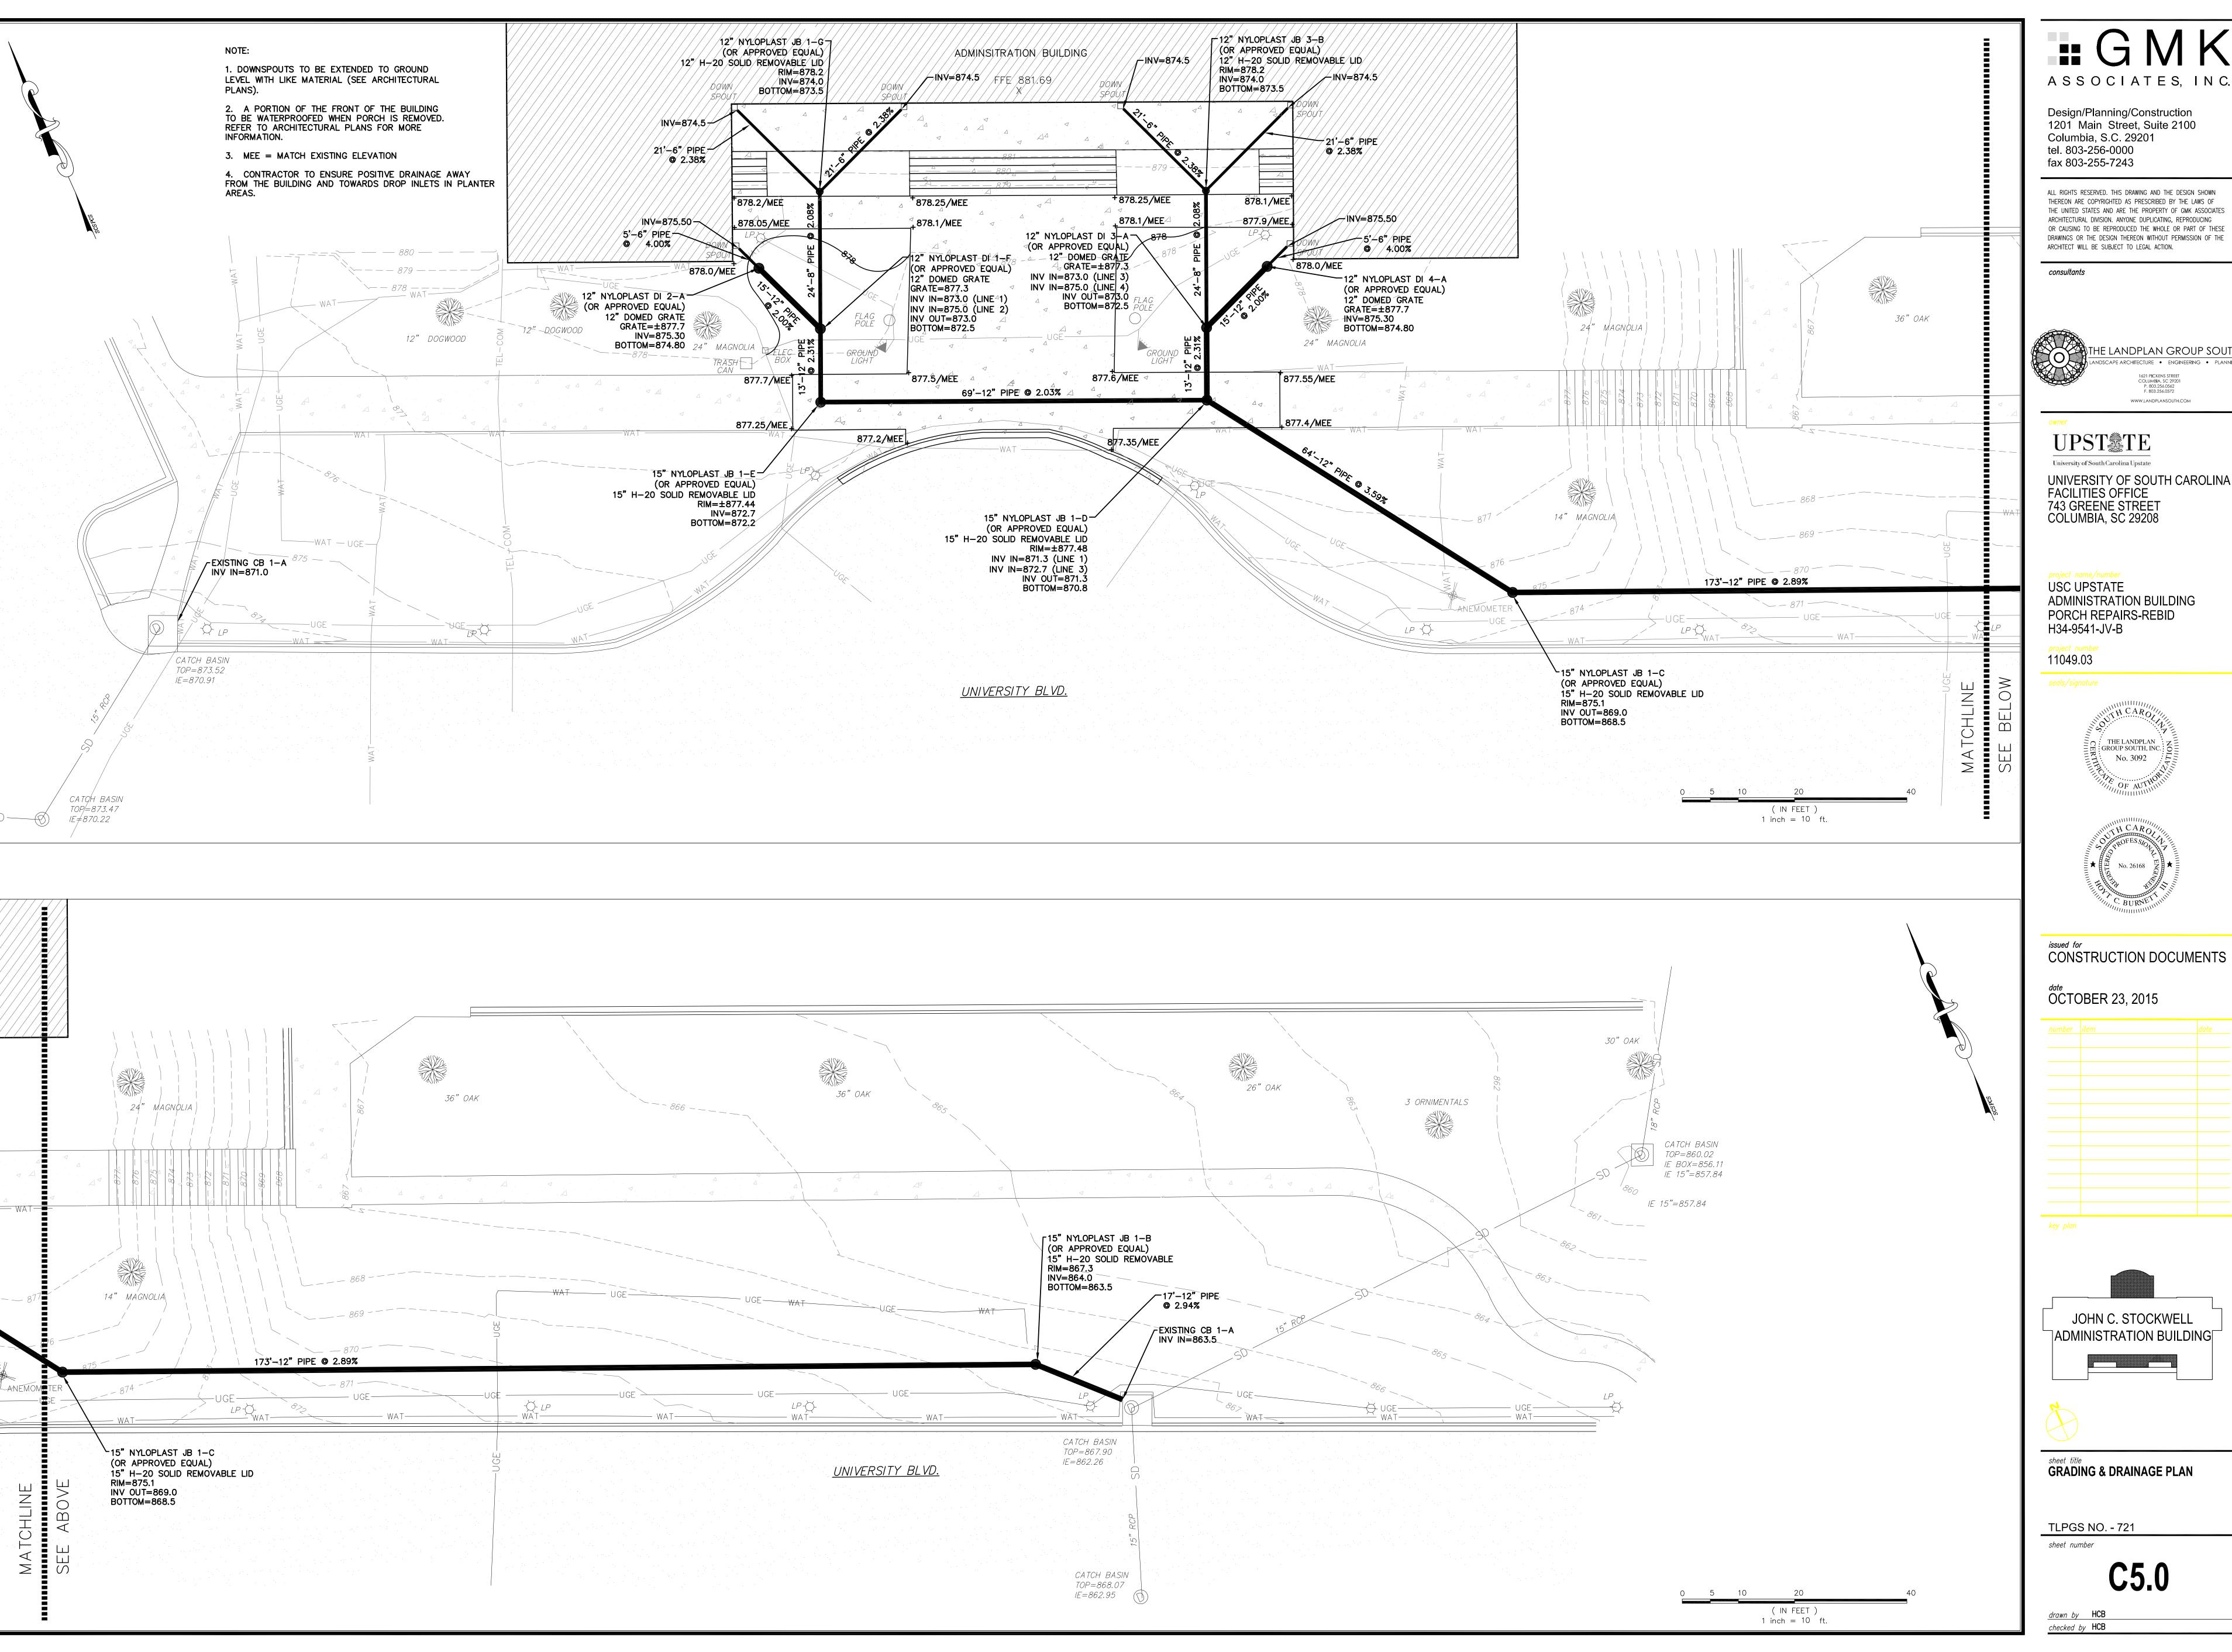


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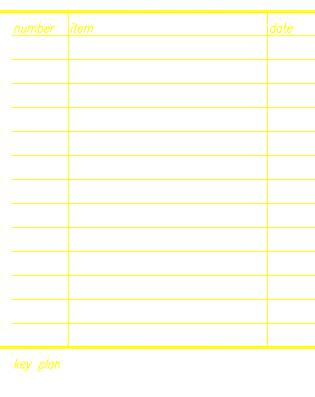
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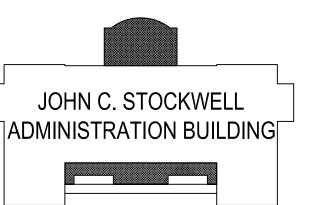
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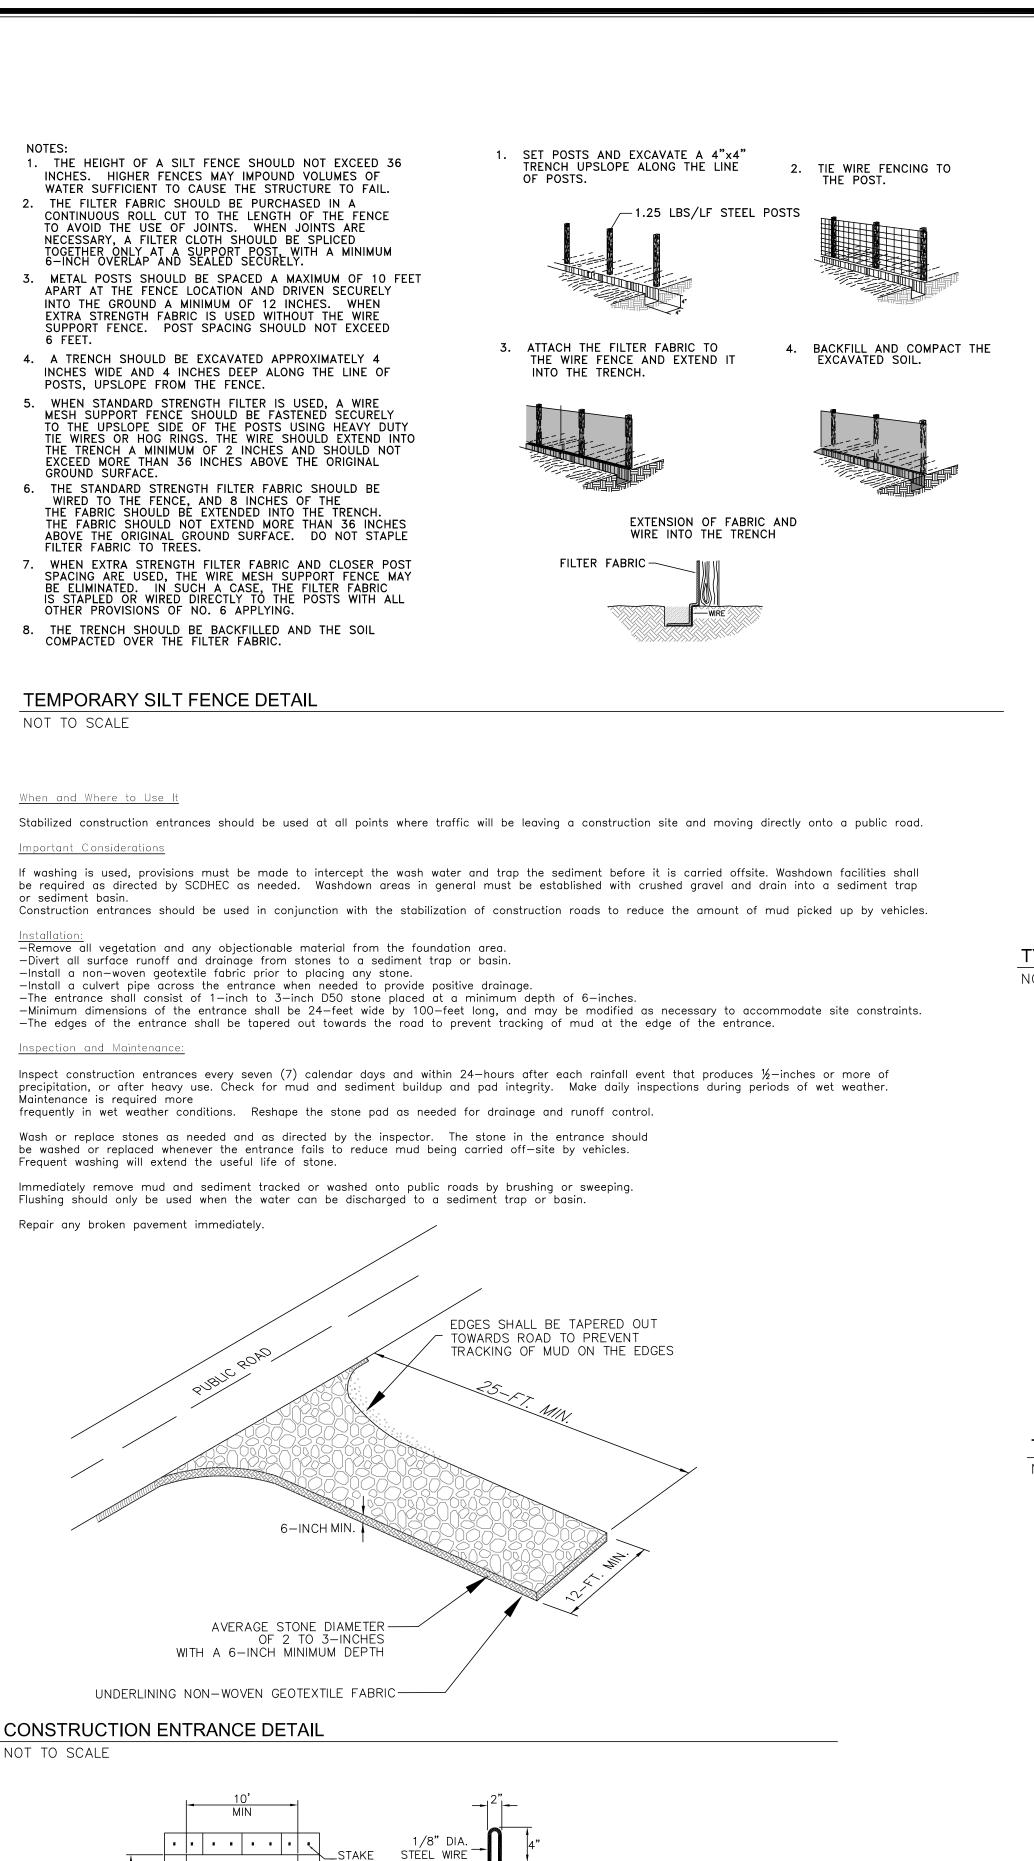


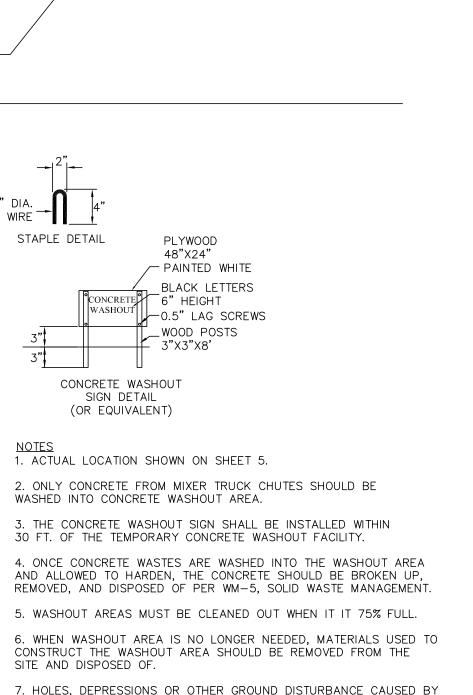


GRADING & DRAINAGE PLAN

TLPGS NO. - 721

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THE REMOVAL OF THE CONCRETE WASHOUT AREA SHOULD BE

BACKFILLED AND REPAIRED.

. /. | . . | . . | . .

TYPE "ABOVE GRADE" WITH STRAW BALES

PLASTIC LINING/

wood or --

METAL STAKES

(2 PER BALE)

CONCRETE WASHOUT AREA DETAIL

10 MIL

PLASTIC LINING

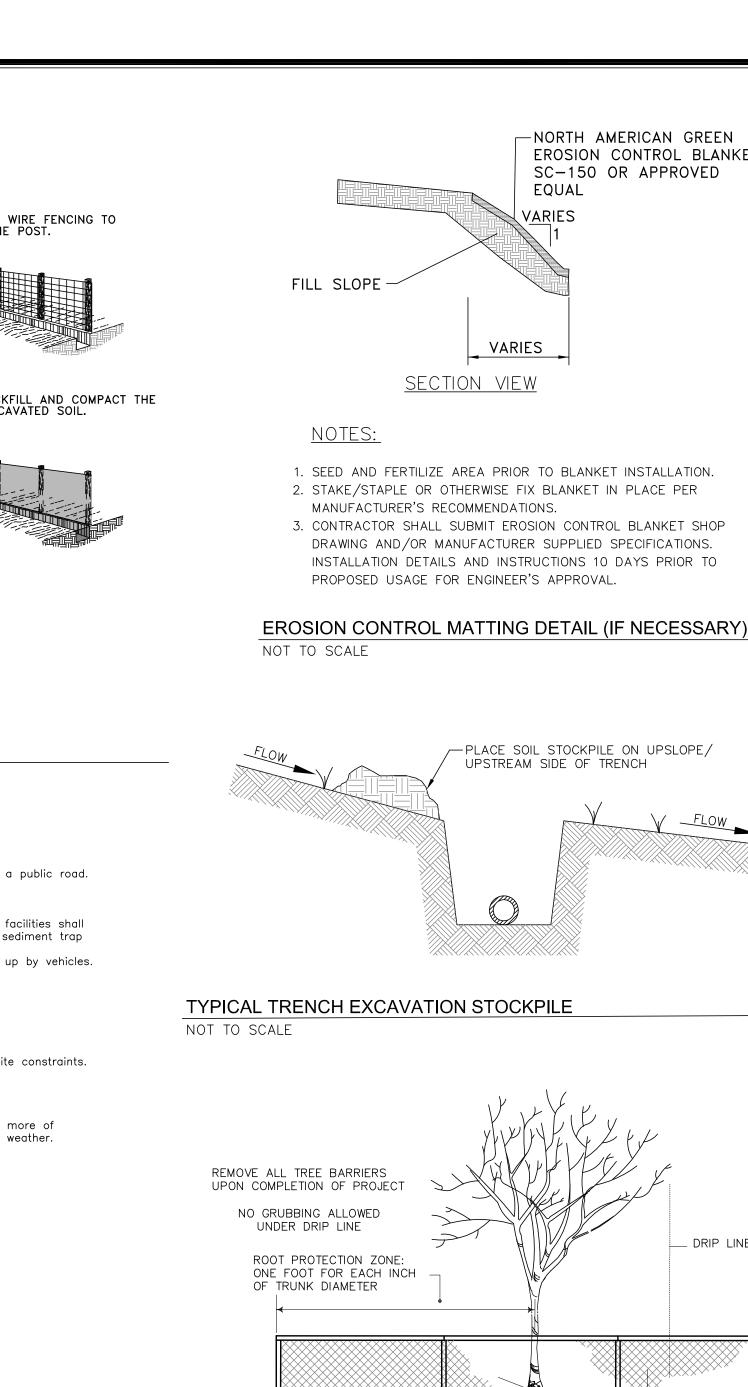
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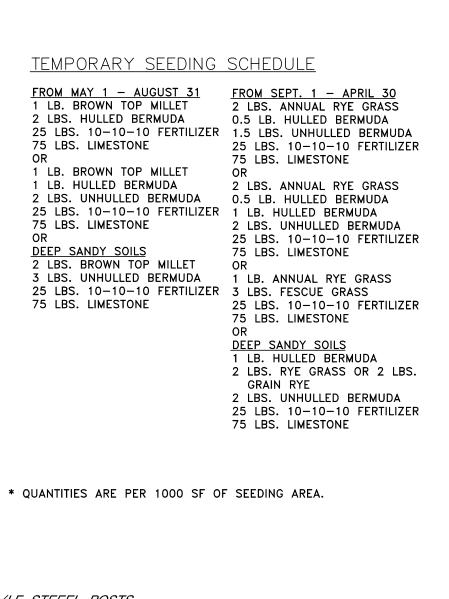
NATIVE MATERIAL

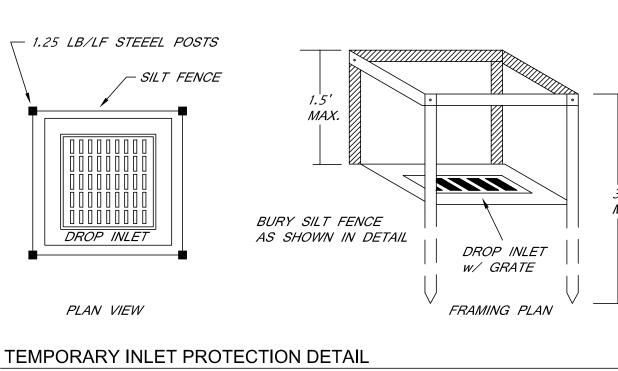
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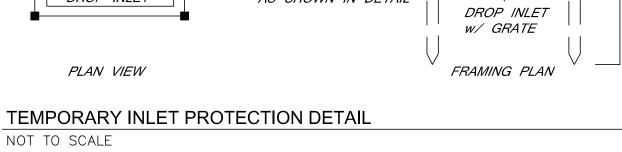
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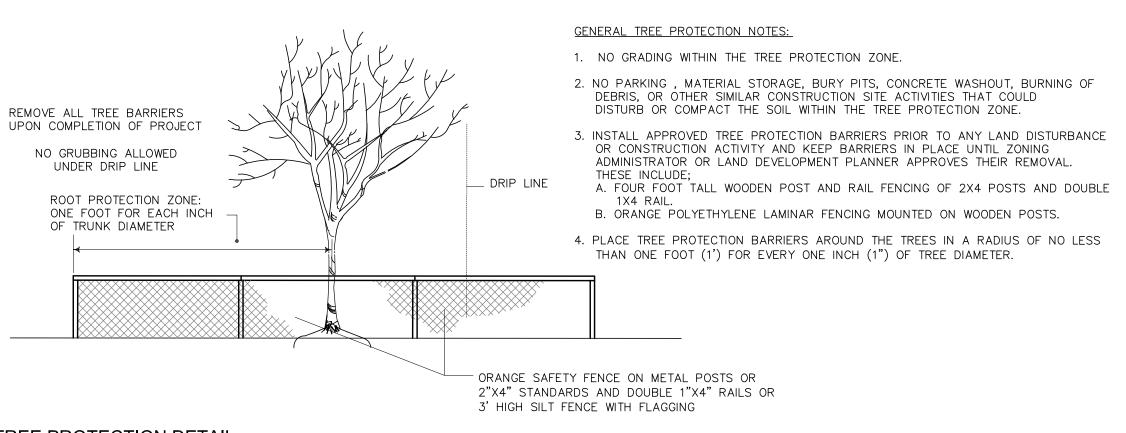
STRAW BALE

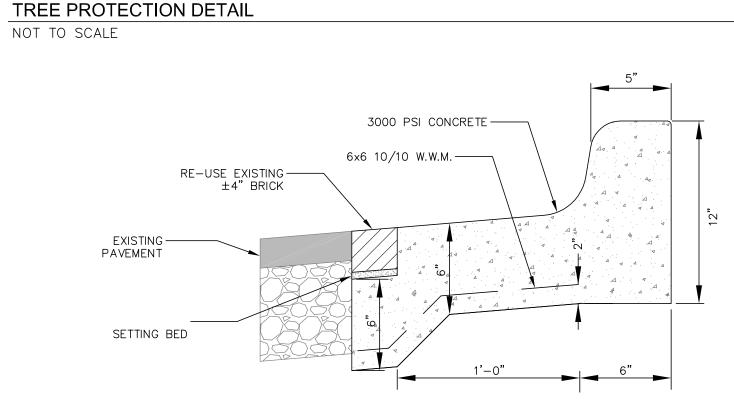












TO STORM

DRAINAGE BOX

NOT TO SCALE

TYPICAL ROOF DRAIN DETAIL

-NORTH AMERICAN GREEN

SC-150 OR APPROVED

EQUAL

-PLACE SOIL STOCKPILE ON UPSLOPE/

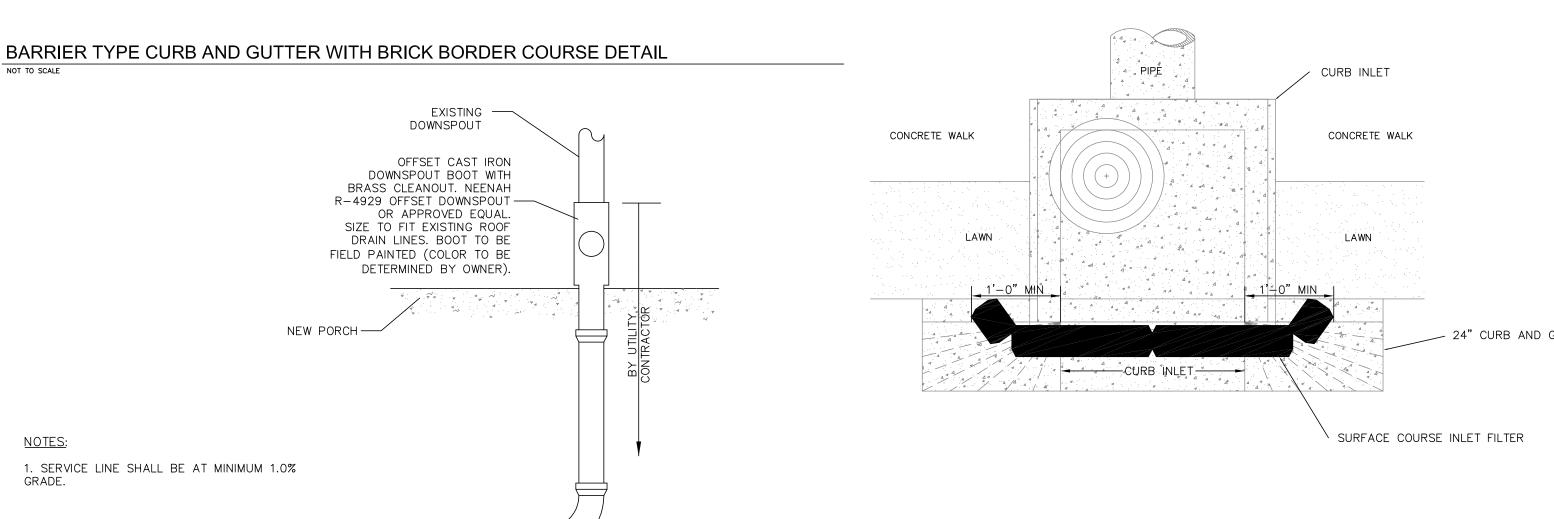
UPSTREAM SIDE OF TRENCH

VARIES

SECTION VIEW

EROSION CONTROL BLANKET

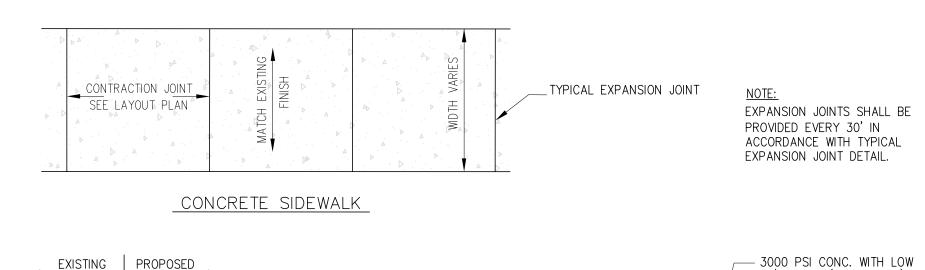
1. EXACT DIMENSIONS OF EXISTING CURB AND GUTTER ARE UNKNOWN. CONTRACTOR TO MATCH EXISTING CURB AND GUTTER. 2. CURB AND GUTTER TO BE CONSTRUCTED IN 10-FOOT LENGTHS. 5. 1/2 INCH EXPANSION JOINT SHALL BE PROVIDED AT INTERVALS NOT TO EXCEED 100 FEET, AT THE ENDS AND MID—POINT OF RETURNS, AND AT ANY POINT WHERE THE NEW CURB AND GUTTER ABUTS OTHER CONCRETE STRUCTURES. 4. CONTRACTOR TO REMOVE BRICKS FROM BRICK BORDER COURSE, CLEAN MORTAR FROM BRICKS AND RE-USE BRICKS IN NEW INSTALLATION. 5. IT IS UNKNOWN IF CONCRETE UNDER BRICK BORDER COURSE IS PART OF CONCRETE CURB AND GUTTER. THE CONTRACTOR MAY REMOVE CURB AND GUTTER WITHOUT REMOVING THE BRICK BORDER COURSE. SHOULD BRICK BORDER COURSE HAVE TO BE REMOVED, THIS DETAIL SHALL BE USED.

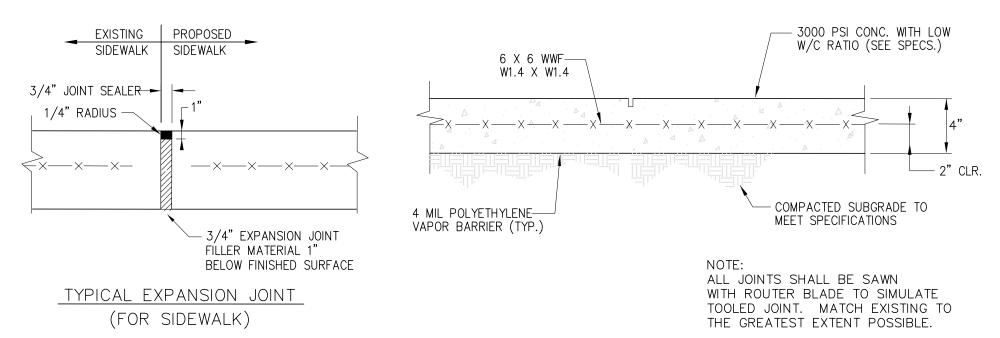


SURFACE COURSE INLET FILTER FOR EXISTING CATCH BASIN DETAIL NOT TO SCALE

(1) GRATE & INTEGRATED DUCTILE IRON FRAME TO MATCH BASIN O.D. GRATE TO BE REPLACED WITH SOLID LID FOR THOSE DRAIN BASIN DENOTED AS JUNCTION BOXES. REFER TO GRADING & DRAINAGE PLAN FOR LID TYPE (4) ADAPTER ANGLES VARIABLE 0° - 360° ACCORDING TO PLANS (2) VARIABLE SUMP DEPTH ACCORDING TO PLANS (6" MIN. BASED ON WATERTIGHT JOINT - MANUFACTURING REQ.) (CORRUGATED HDPE SHOWN) (3) VARIOUS TYPES OF INLET & OUTLET ADAPTERS AVAILABLE: 4" - 15" FOR CORRUGATED HDPE, PVC SEWER (EX: SDR 35), PVC DWV (EX: SCH 40), PVC C900/C905, CORRUGATED & RIBBED PVC THE BACKFILL MATERIAL SHALL BE CRUSHED STONE OR OTHER GRANULAR MATERIAL MEETING THE REQUIREMENTS OF CLASS I OR CLASS II MATERIAL AS DEFINED IN ASTM D2321. BEDDING & BACKFILL 1 - 12" & 15" FRAMES SHALL BE DUCTILE IRON PER ASTM A536 GRADE 70-50-05. FOR SURFACE DRAINAGE INLETS SHALL BE PLACED & 2 - DRAIN BASIN TO BE CUSTOM MANUFACTURED ACCORDING TO PLAN DETAILS. COMPACTED UNIFORMLY IN ACCORDANCE WITH ASTM D2321. RISERS ARE NEEDED FOR BASINS OVER 84" DUE TO SHIPPING RESTRICTIONS. 3 - DRAINAGE CONNECTION STUB JOINT TIGHTNESS SHALL CONFORM TO ASTM D3212 FOR CORRUGATED HDPE & PVC SEWER. 4 - ADAPTERS CAN BE MOUNTED ON ANY ANGLE 0° TO 360°

8"-15" DRAIN BASIN DETAIL NOT TO SCALE





1. CONCRETE SCORING 5' O.C. AND EXPANSION JOINTS AT 30' O.C. OR MATCH EXISTING SIDEWALK JOINT SPACING.

2. SIDEWALK CROSS SLOPE BE NO STEEPER THAN 1:48 AND SHALL MEET 2010 ADA STANDARDS FOR ACCESSIBLE DESIGN (SECTION 403.3).

SIDEWALK DETAIL NOT TO SCALE

SURFACE COURSE INLET FILTER NOTES: DRAWING SHOWS TYPE 16 CATCH BASIN. TYPE E INLET STRUCTURE FILTERS ARE APPLICABLE FOR CATCH BASIN TYPE 1, 16, 17, AND 18 AFTER THE ROAD

SURFACE COURSE IS PLACED.

2. PLACE CURB INLET FILTER AS SHOWN IN AREA WHERE SILT MAY SPILL OVER SIDEWALK AND CURB AFTER BASE IS PLACED. 3. CURB INLET FILTER SHALL BE INSTALLED IN FRONT OF THE CURB INLET

MINIMUM LENGTH 2 FEET LONGER THAN THE LENGTH OF THE CURB OPENING. THIS WILL ALLOW FOR SUFFICIENT LENGTH TO COVER THE INLET WITH AT LEAST ONE FOOT BEYOND THE INLET ON BOTH ENDS. 4. THE FILTER SHALL BE CONSTRUCTED WITH A SYNTHETIC MATERIAL THAT WILL ALLOW STORM WATER TO FREELY FLOW THROUGH WHILE TRAPPING SEDIMENT DEGRADATION BY ULTRAVIOLET EXPOSURE AND IS RESISTANT TO CONTAMINANTS COMMONLY ENCOUNTERED IN STORM WATER. STRAW,

OPENING. THE FILTER SHALL HAVE A MINIMUM DIAMETER OF 9 INCHES AND A

STRAW FIBER, STRAW BALES, PINE NEEDLES, AND LEAVE MULCH ARE NOT A PERMISSIBLE MATERIAL FOR FILTER CONSTRUCTION. MUSE FILTER FABRIC THAT IS CAPABLE OF REDUCING EFFLUENT SEDIMENT CONCENTRATIONS BY NO LESS THAN 80% UNDER TYPICAL SEDIMENT MIGRATION CONDITIONS.

5. FILL THE SGGREGATE COMPARTMENT TO A LEVEL (AT LEAST $\frac{1}{2}$ FULL) THAT WILL KEEP THE SURFACE COURSE INLET FILTER IN PLACE AND CREATE A SEAL BETWEEN THE FILTER AND ROAD SURFACE. 6. PONDING IS LIKELY IF SEDIMENT IS NOT REMOVED REGULARLY. INSPECTINO

OF CURB INLET FILTER SHOULD BE MADE EVERY SEVEN (7) CALENDAR DAYS. ANY NEEDED REPAIRS SHOULD BE HANDLED IMMEDIATELY. THE CURB INLET FILTER SHOULD BE CLEANED IF A VISUAL INSPECTION SHOWS SILT AND DEBRIS BUILT UP AROUND THE FILTER. SEDIMENT REMOVAL SHALL BE PAID FOR AS SILT BASINS.

ASSOCIATES. IN C.

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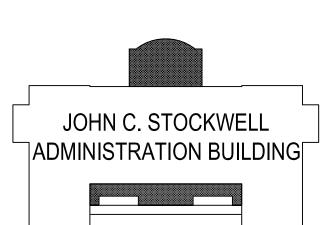
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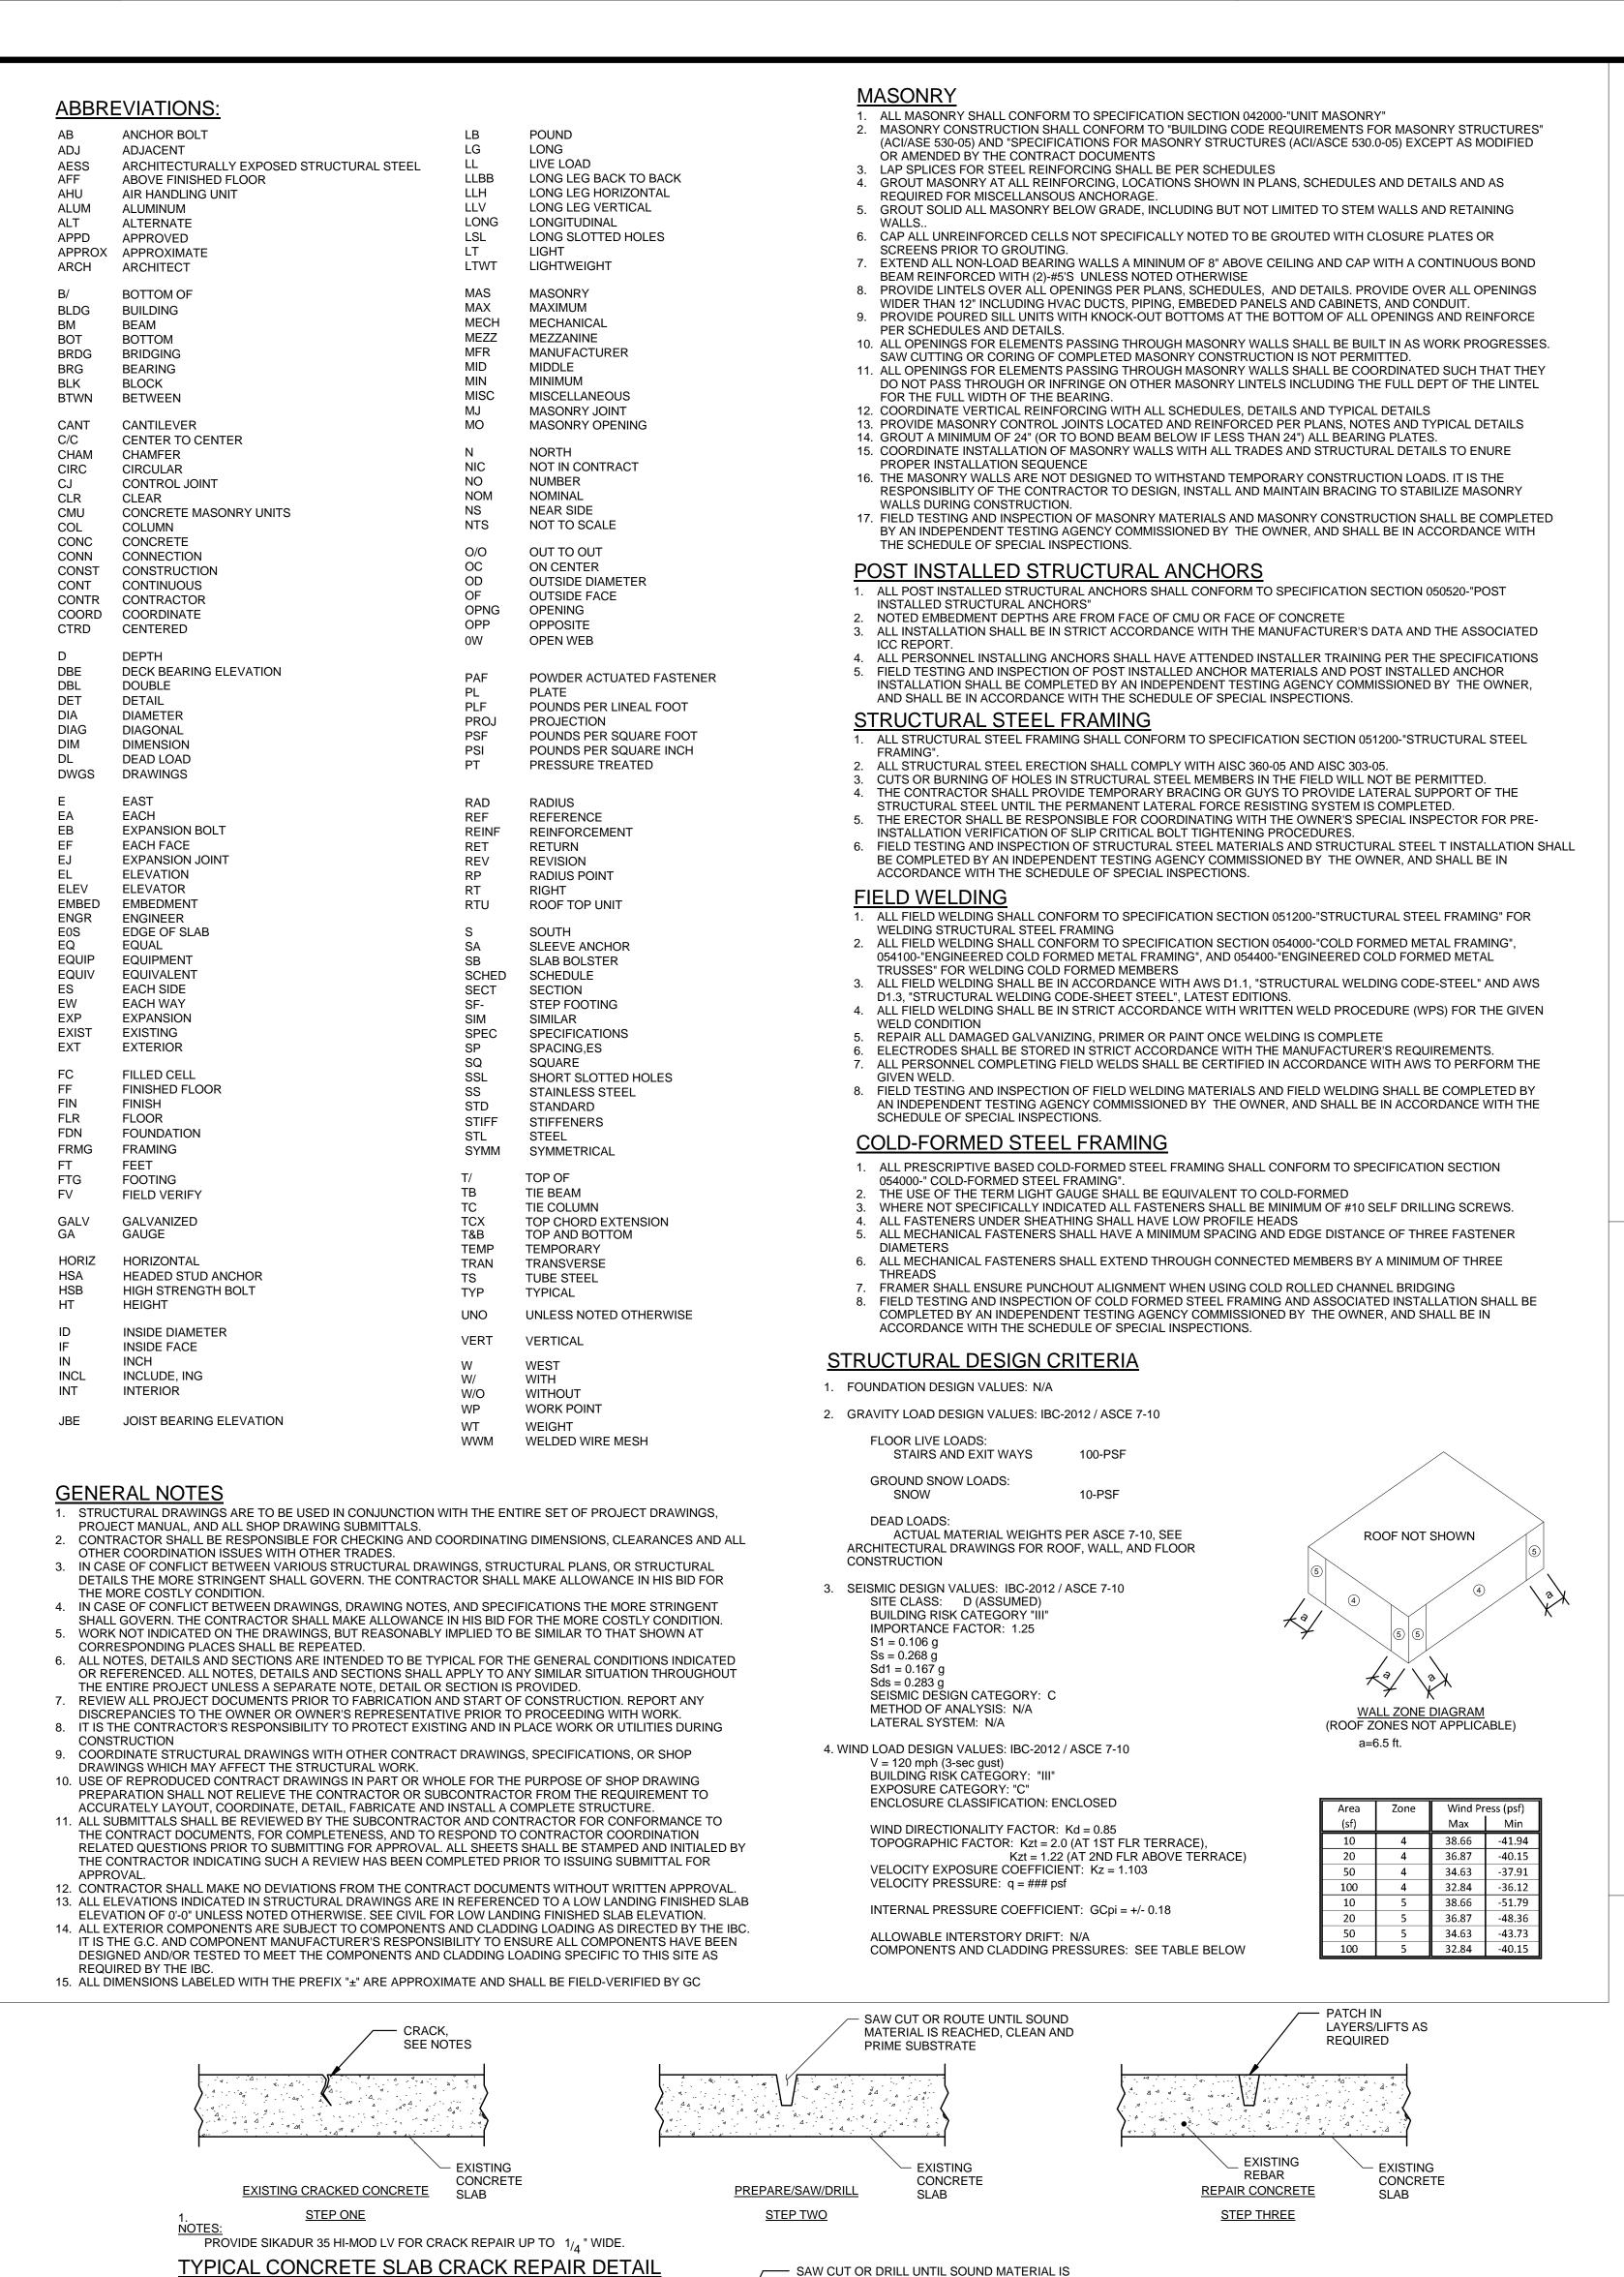




DETAILS

TLPGS NO. - 721 sheet number

drawn by HCB checked by HCB



— SAW CUT OR DRILL UNTIL SOUND MATERIAL IS

CONCRETE

PREPARE/SAW/DRILL

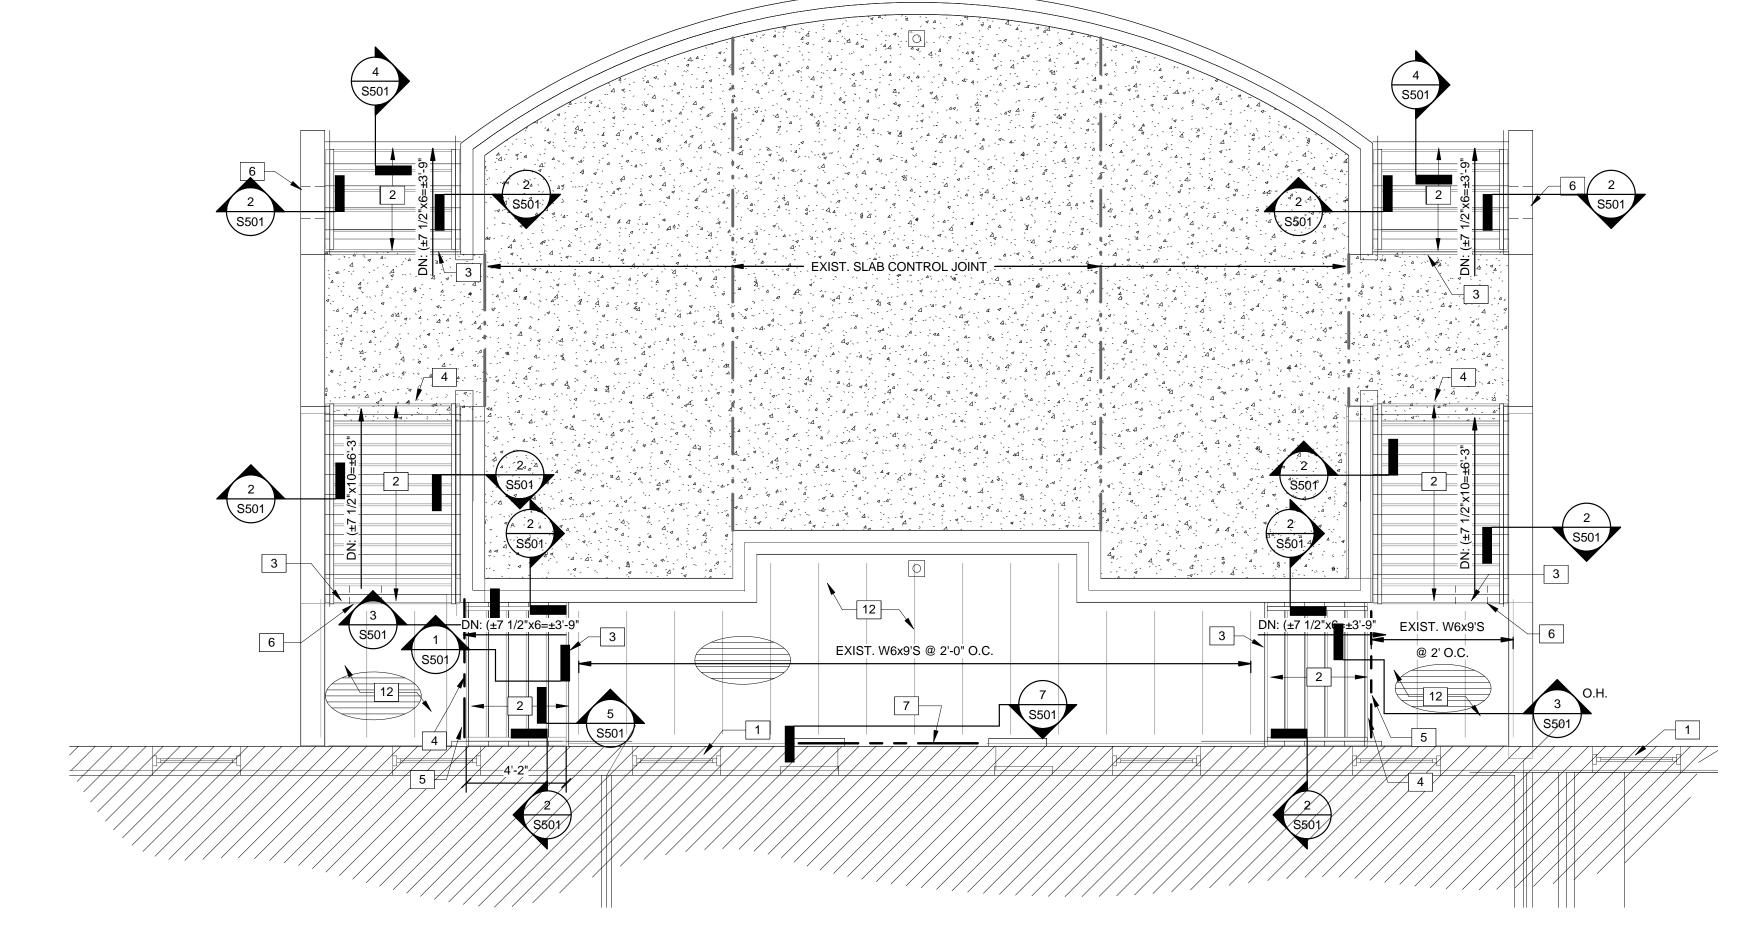
STEP TWO

PRIME EXISTING

REINFORCMENT

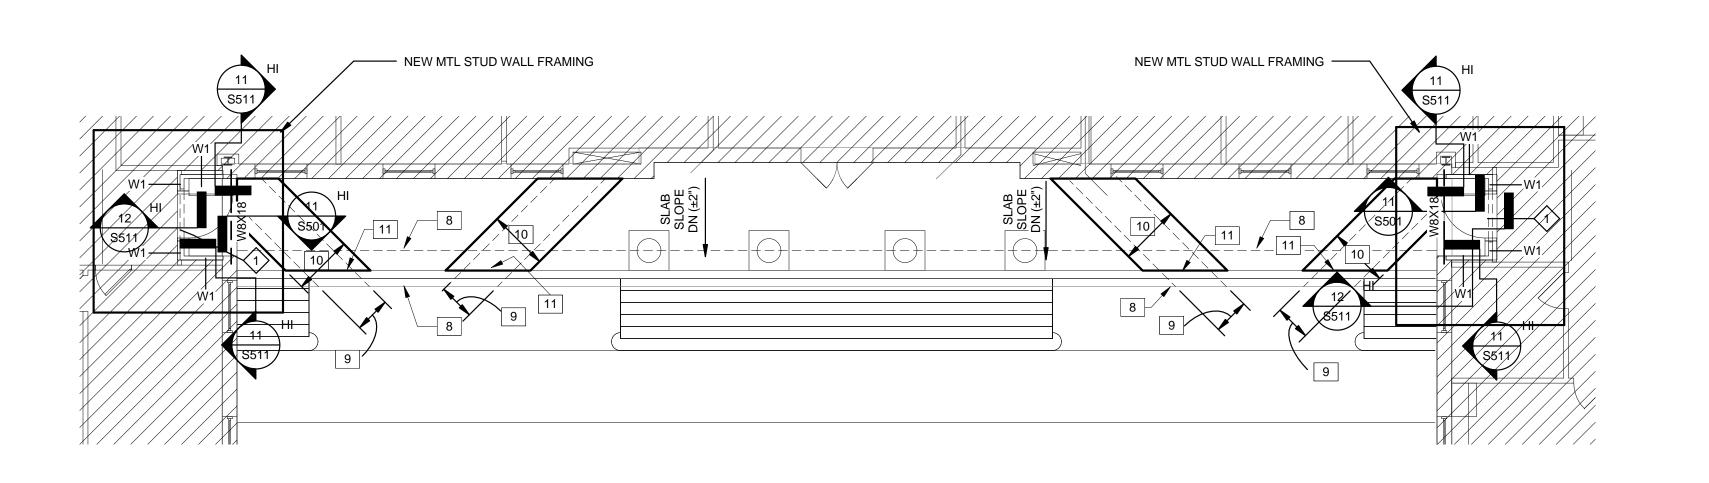
REACHED, CLEAN (INCLUSIVE OF REMOVAL OF

REBAR CORROSION) AND PRIME SUBSTRATE



TERRACE REPAIR AND REAR WALL FRAMING PLAN

[/] 1/4" = 1'-0"



WALL FRAMING AT FRONT PLAZA

PLAZA DECK AND TERRACE REPAIR GENERAL NOTES TYPICAL EXIST. SLAB CONSTRUCTION IS 4" SLAB ON GRADE, U.N.O. (SEE LEGEND BELOW FOR EXCEPTION)

• INDICATES SPAN DIRECTION OF EXISTING SLAB ON DECK, WHICH CONSISTS OF 3" LIGHTWEIGHT SLAB W/ ONE LAYER OF WWR ON 9/16" DEEP NON-COMPOSITE FLOOR DECK (TOTAL

WALL FRAMING PLAN GENERAL NOTES

TYPICAL DETAIL 6/S501

• INDICATES LIGHT GAUGE METAL STUD WALL OF WALL TYPE "W#" -SEE SCHEDULE ON 1/S511 AND TYPICAL DETAILS ON S511 FOR FRAMING REQUIREMENTS

INDICATES LIGHT GAUGE METAL STUD WALL OPENING OF TYPE "#" - SEE SCHEDULE ON 1/S511 AND TYPICAL DETAILS ON S511 FOR FRAMING REQUIREMENTS

TYPICAL DETAILS (1 & 2/S501); ALL FIELD WELDS SHALL BE REPAIRED

KEYED NOTES (THIS SHEET ONLY) FACE OF EXISTING BUILDING; BRICK VENEER FACE PROVIDE 1/8" THK H.D.G. STEEL PLATE OVERLAY ON STAIRS PER

W/ COLD GALVANIZING REPAIR PAINT TERMINATE OVERLAY PLATE ON STAIRS INTO SLAB AS SHOWN ON TYPICAL DETAIL 5/S501 TERMINATE OVERLAY PLATE ON STAIRS INTO SLAB AS SHOWN ON

REMOVE EXIST. W6x9 @ BASE OF STAIRS & REPLACE W/ HDG HSS6x4x1/4, W/ 1/4" CAP PLATE EA, END: PROVIDE NEW 1/2" x 10"x6" BRG. PLATE W/ (2) 5/8" DIA. x 5" EMBED. EPOXY BOLTS @ EA. END FOR ATTACHMENT TO EXISTING CMU WALL; ATTACH TO BRG. PLATE W/ MIN. EFF. 5/16" x 3" FLARE BEVEL WELD; ALL COMPONENTS TO BE HDG. BRG. CONDITION SHALL BE VERIFIED PRIOR TO FABRICATION

KEYED NOTES (THIS SHEET ONLY)

PRIOR TO PROVISION OF PLATE OVERLAY AT ADJACENT STAIRS, GC CREATE OPENING IN EXISTING CMU (PLUS BRICK) WALL TO ALLOW VISUAL ACCESS TO UNDERSIDE OF EXISTING STAIR. NOTIFY EOR ONCE OPENING IS ADDED, SO THAT EOR CAN EVALUATE WHETHER SPECIFIED OVERLAY MAY BE DELETED FROM SCOPE AND WHETHER ADDITIONAL REPAIRS ARE REQUIRED. ONCE EOR REVIEW IS COMPLETE AND DIRECTION PROVIDED. GC SHALL REPAIR OPENING WITH SIMILAR CMU AND/OR DRY-PACKED GROUT, AND BRICK VENEER TO MATCH EXISTING (SEE ARCH.)

REMOVE & REPLACE 4'-0" WIDE PIECE OF EXISTING C8x11.5 SUPPORTING EXISTING W6'S: CENTER SEGMENT TO BE REMOVED AT CORRODED SEGMENT; MAKE CUTS OF C8 ADJACENT TO AND BEYOND EXISTING ANCHORAGE POINTS; PROVIDE 3/4" x 6" EMBED. EPOXY BOLTS @ 24" O.C. (MIN=3) TO FACE OF WALL; PROVIDE NEW 3/8" TAB PLATES, TO BE WELDED TO C8 & TO WEBS OF W6('S) W/ 1/4" FILLET

EDGE OF EXIST. +/-1'-0" THK. x +/-3'-0" WIDE FTG BELOW CONCR. WALL: T/FTG EL = APPROX. 5'-0" BELOW SLAB; NOTE THAT EXCAVATION FOR PIPE IS TO EXTEND BELOW FTG. SEE TYP DTL 10/S501 FOR REQUIREMENTS WHERE PIPE EXTENDS UNDER EXIST. FTG. SEE CIVIL DRAWINGS FOR PIPING; MAX WIDTH OF EXCAVATION FOR INSTALLATION OF PIPE BELOW GRADE = +/-3'-0"

SEE CIVIL DRAWINGS FOR PIPING; CUT SLAB +/- 5'-0" WIDE AND EXCAVATE AS NOTED ON THIS DRAWING, W/ EDGE OF EXCAVATION 1'-0" MIN. FROM EA. EDGE OF SLAB CUT; AFTER BACK-FILLING PER SLAB TRENCHING DETAIL, PROVIDE NEW SLAB W/ THK & SLOPE TO MATCH EXIST. (5"-6" THK) W/ ONE LAYER OF 6x6~W2.1xW2.1 WWR; SEE TYP. DTL FOR ATTACHMENT TO ADJACENT EXIST. SLAB; PROVIDE CONCR. PROPERTIES AS FOLLOWS: N.W. CONCR. W/f'c=3 KSI: AIR CONTENT = 5% +/- 1.5%; PROVIDE STEEL TROWEL FINISH; SEE 10/S501 FOR REQUIREMENTS OF BACK-FILL AND PIPE ELEVATION UNDER

EXIST. FTG. AT INTERSECTION OF NEW SLAB W/ EXIST. WALL AT EDGE OF PLAZA DECK, PROVIDE 1/2" THK. EXPANSION JOINT FILLER MATERIAL BTW.

CONTRACTOR SHALL SOUND THE SLAB WITHIN EXTENTS OF THIS LANDING AND CHIP OUT HOLLOW OR LOOSE CONCRETE. THEN PROVIDE PATCHING PER EOR DIRECTION. IF REQUIRED PATCHING IS LESS THAN 6" IN WIDTH AND LENGTH, OR IF ONLY CRACKS (LESS THAN 3/16" IN WIDTH) ARE TO BE REPAIRED, THEN REFER TO CONCRETE REPAIR DETAIL 3/S001

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project name/number UPSTATE ADMINISTRATION BUILDING REPAIRS AND **RENOVATIONS - REBID** H34-9541-JV-B

11049.03

project number

seals/signature



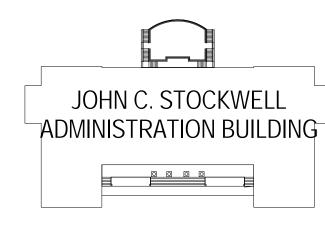


CONSTRUCTION DOCUMENTS

OCTOBER 23, 2015

number	item	date

key plan





sheet title

GENERAL NOTES AND FRAMING PLANS

sheet number

REPAIR AT REBAR W/ SURFACE (INSIGNIFICANT) CORROSION OF REBAR 3 CONCRETE SLAB REPAIR DETAIL

- EXISTING

EXISTING SPALLED CONCRETE

STEP ONE

REBAR IS SIGNIFICANTLY DAMAGED.

AREA OF SPALLED OR

UNSOUND CONCRETE

- EXISTING

CONCRETE

MIN. 1" CLEARANCE -

AROUND REBAR FOR

PREPARATION AND REPAIR

1. REBAR SHALL BE CONSIDERED <u>SIGNIFICANTLY</u> DAMAGED IF CORROSION/LOSS OF MATERIAL IS EQUAL TO OR GREATER

THAN 1/16 IN. IN DEPTH. SEE TYP. DETAIL OF REPLACEMENT AND SPLICE OF DAMAGED REBAR FOR REPAIR WHEN

2. PRIMER (FOR SUBSTRATE, INCLUSIVE OF REBAR) SHALL CONSIST OF SIKADUR 32 HI-MOD BONDING AGENT

3. PROVIDE SIKA REPAIR 222 (MORTAR) FOR REPAIR OF ALL HORIZONTAL SPALLING CONCRETE SURFACES BELOW.

EPOXIES AND SEALANTS SHALL BE SIKA PRODUCTS.

EPOXIES FOR CRACK REPAIRS:

CONCRETE PATCH IN

EXISTING

CONCRETE

LAYERS/LIFTS

- EXISTING

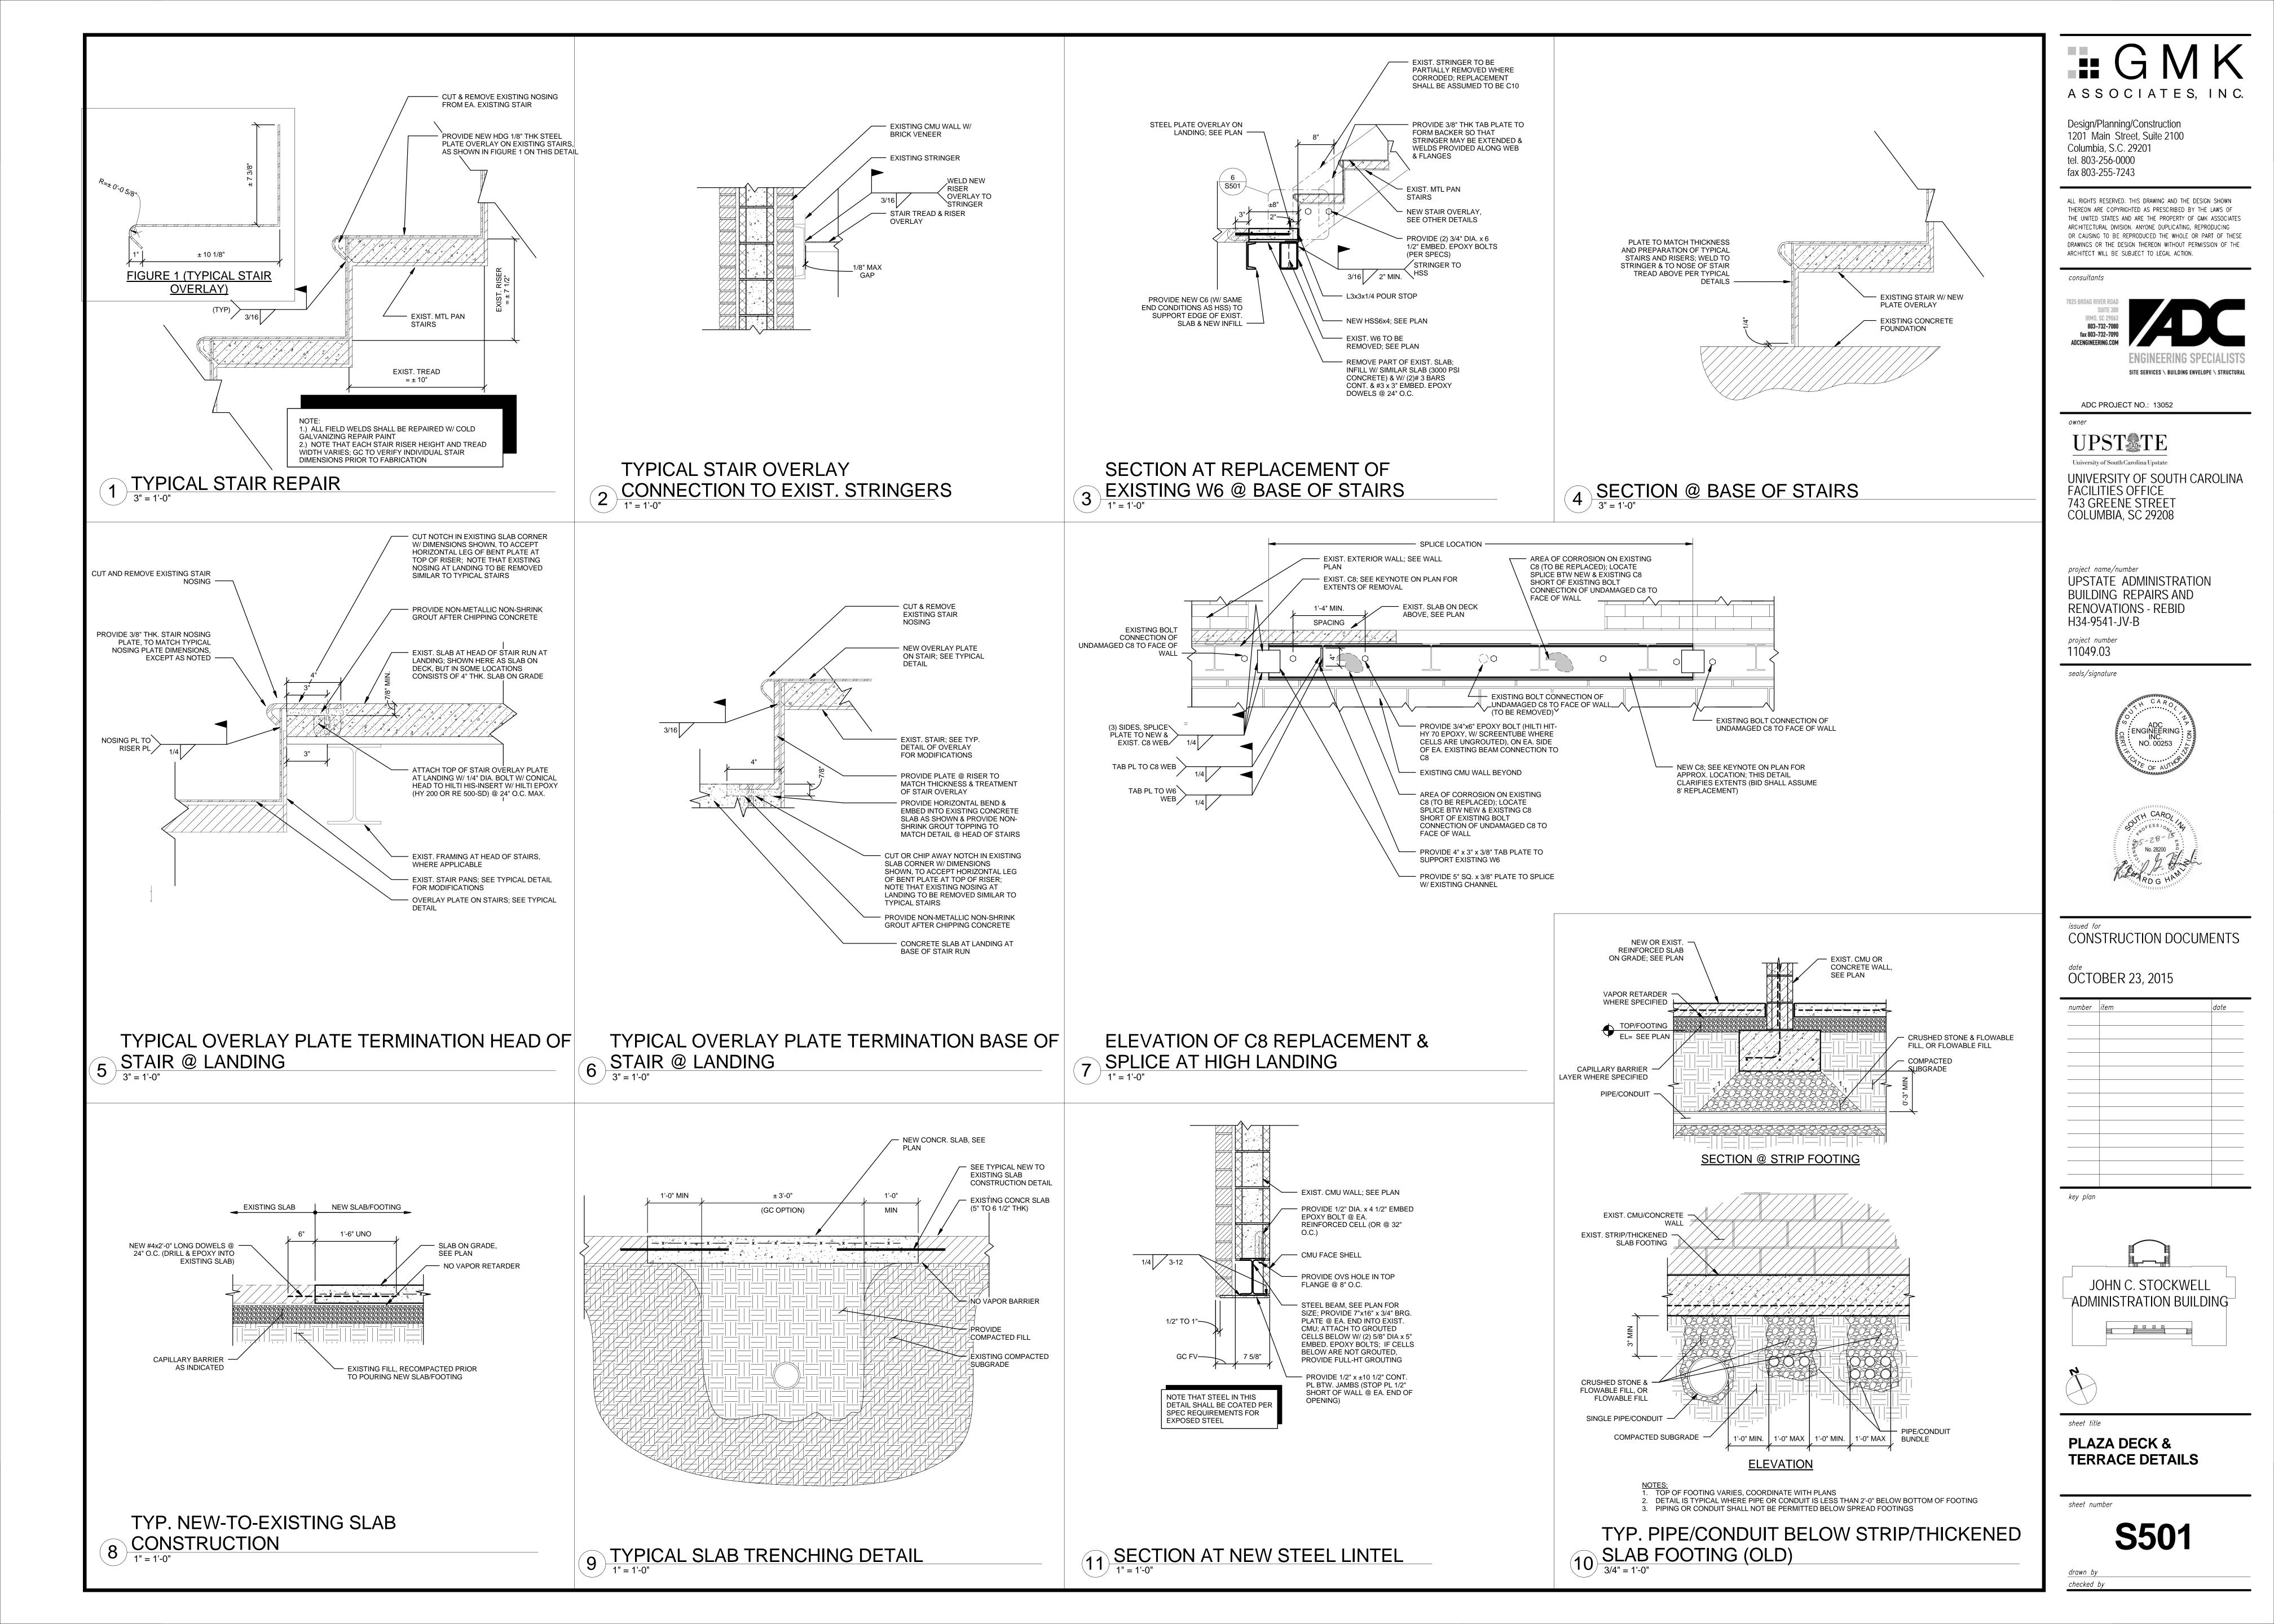
REBAR

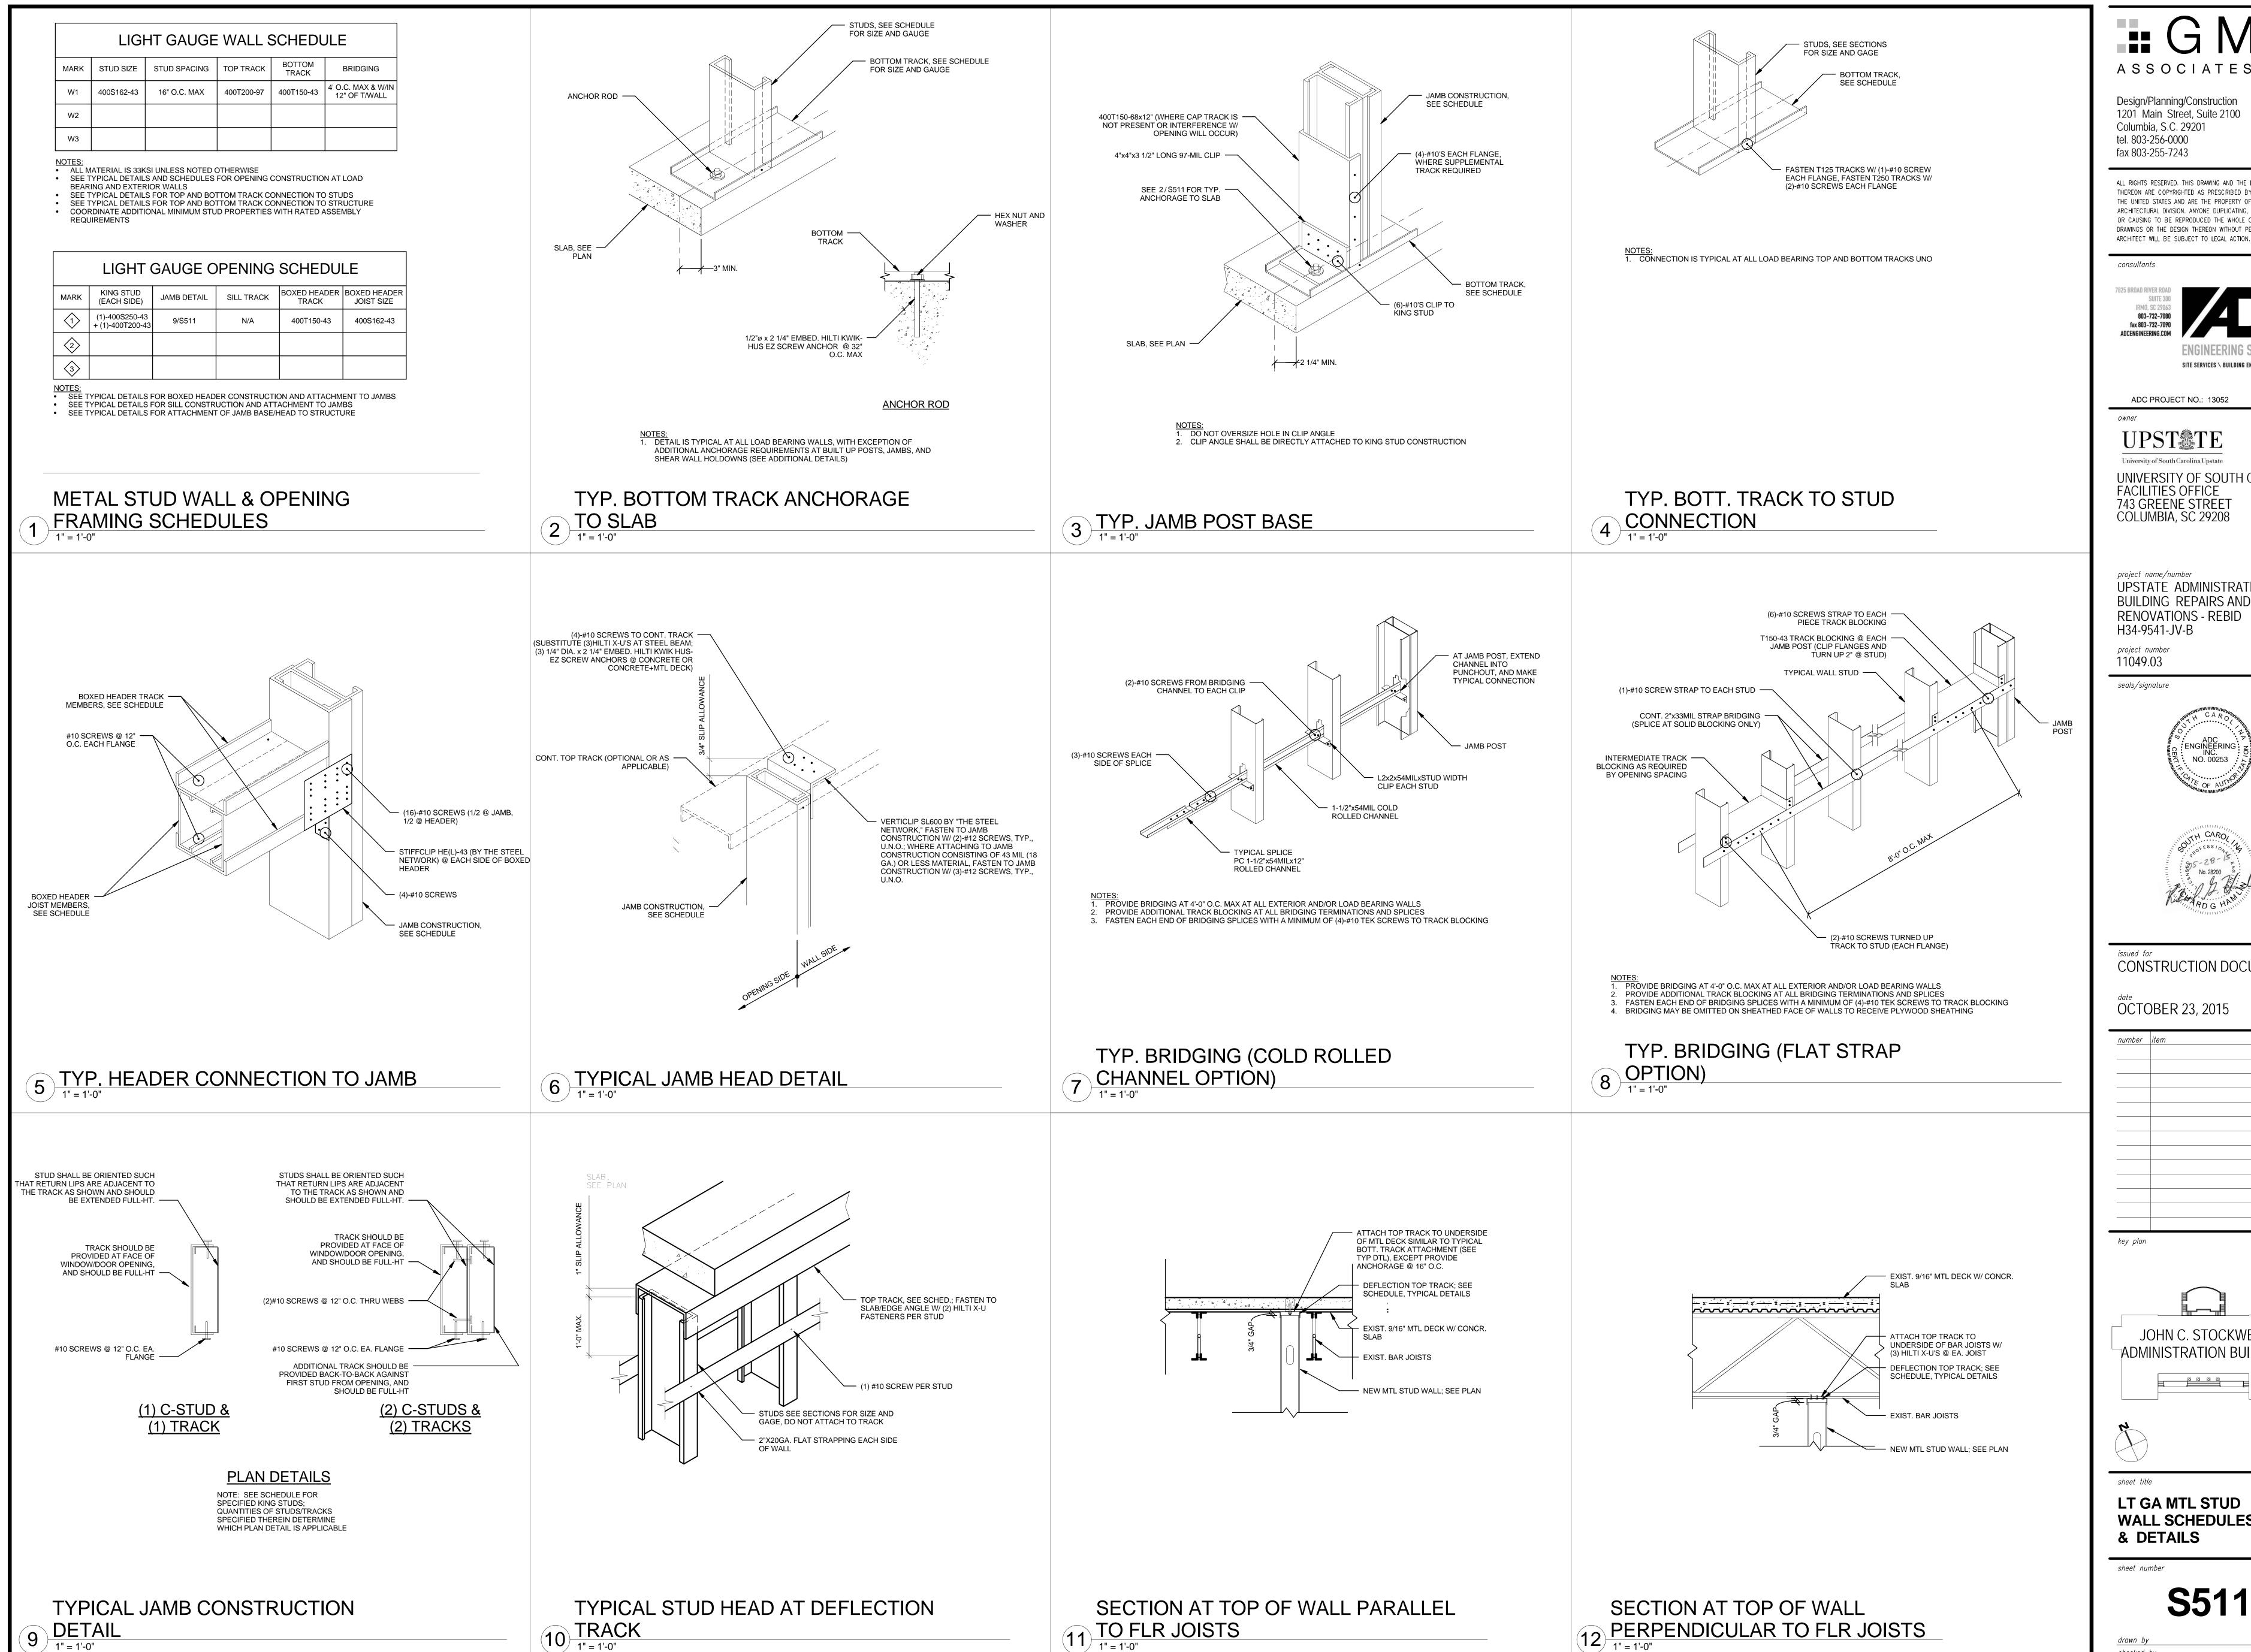
REPAIR SPALLING

STEP THREE

THE SIKA REPRESENTATIVE SHALL VERIFY THE PROPER PRODUCT IS BEING USED FOR THE PROPER REPAIR:

1. SEALANT FOR BRICK WORK SHALL BE SIKAFLEX 15LM. 2. INJECTION RESIN FOR CMU & BRICK SHALL BE SIKADUR 35 HI MOD LV. 3. INJECTION RESIN FOR CONCRETE SHALL BE SIKADUR 35 HI MOD LV. 4. SPALL REPAIRS HORIZONTAL SHALL BE SIKA REPAIR 222 FOR HORIZONTAL SURFACES, AND SIKA REPAIR 223 FOR OVERHEAD AND VERTICAL SURFACES.





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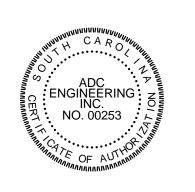
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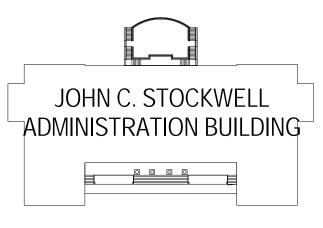




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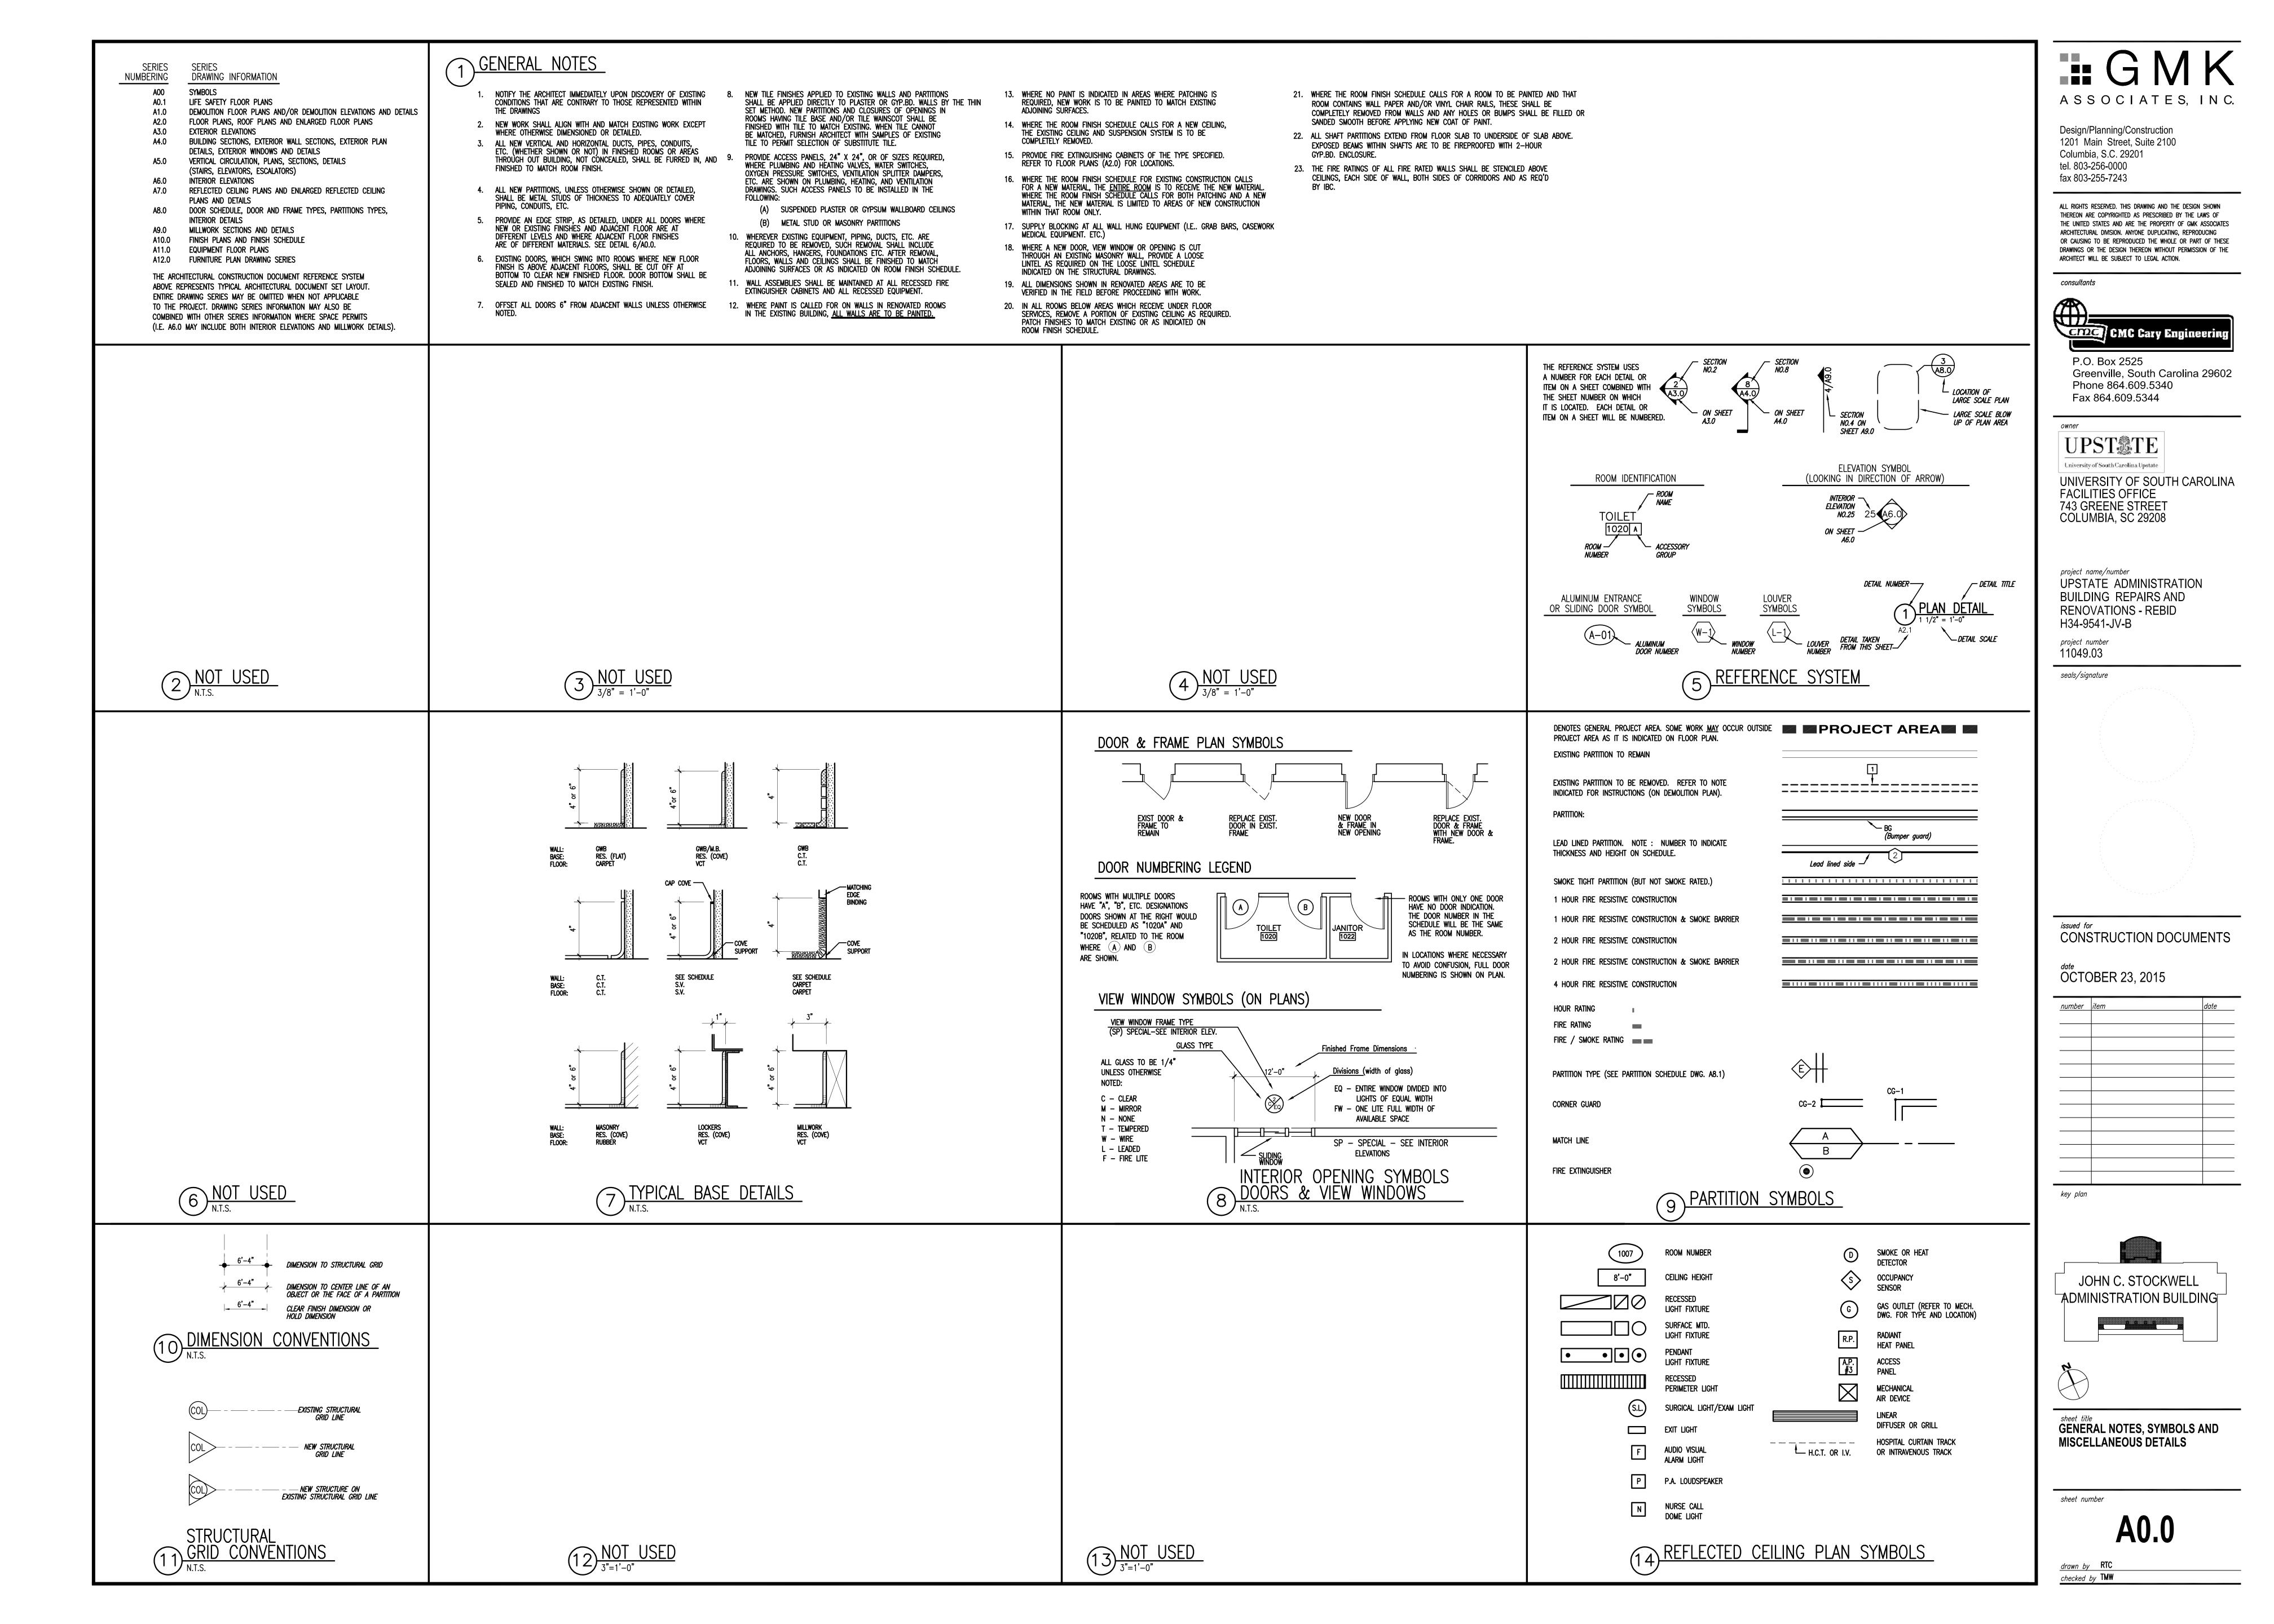


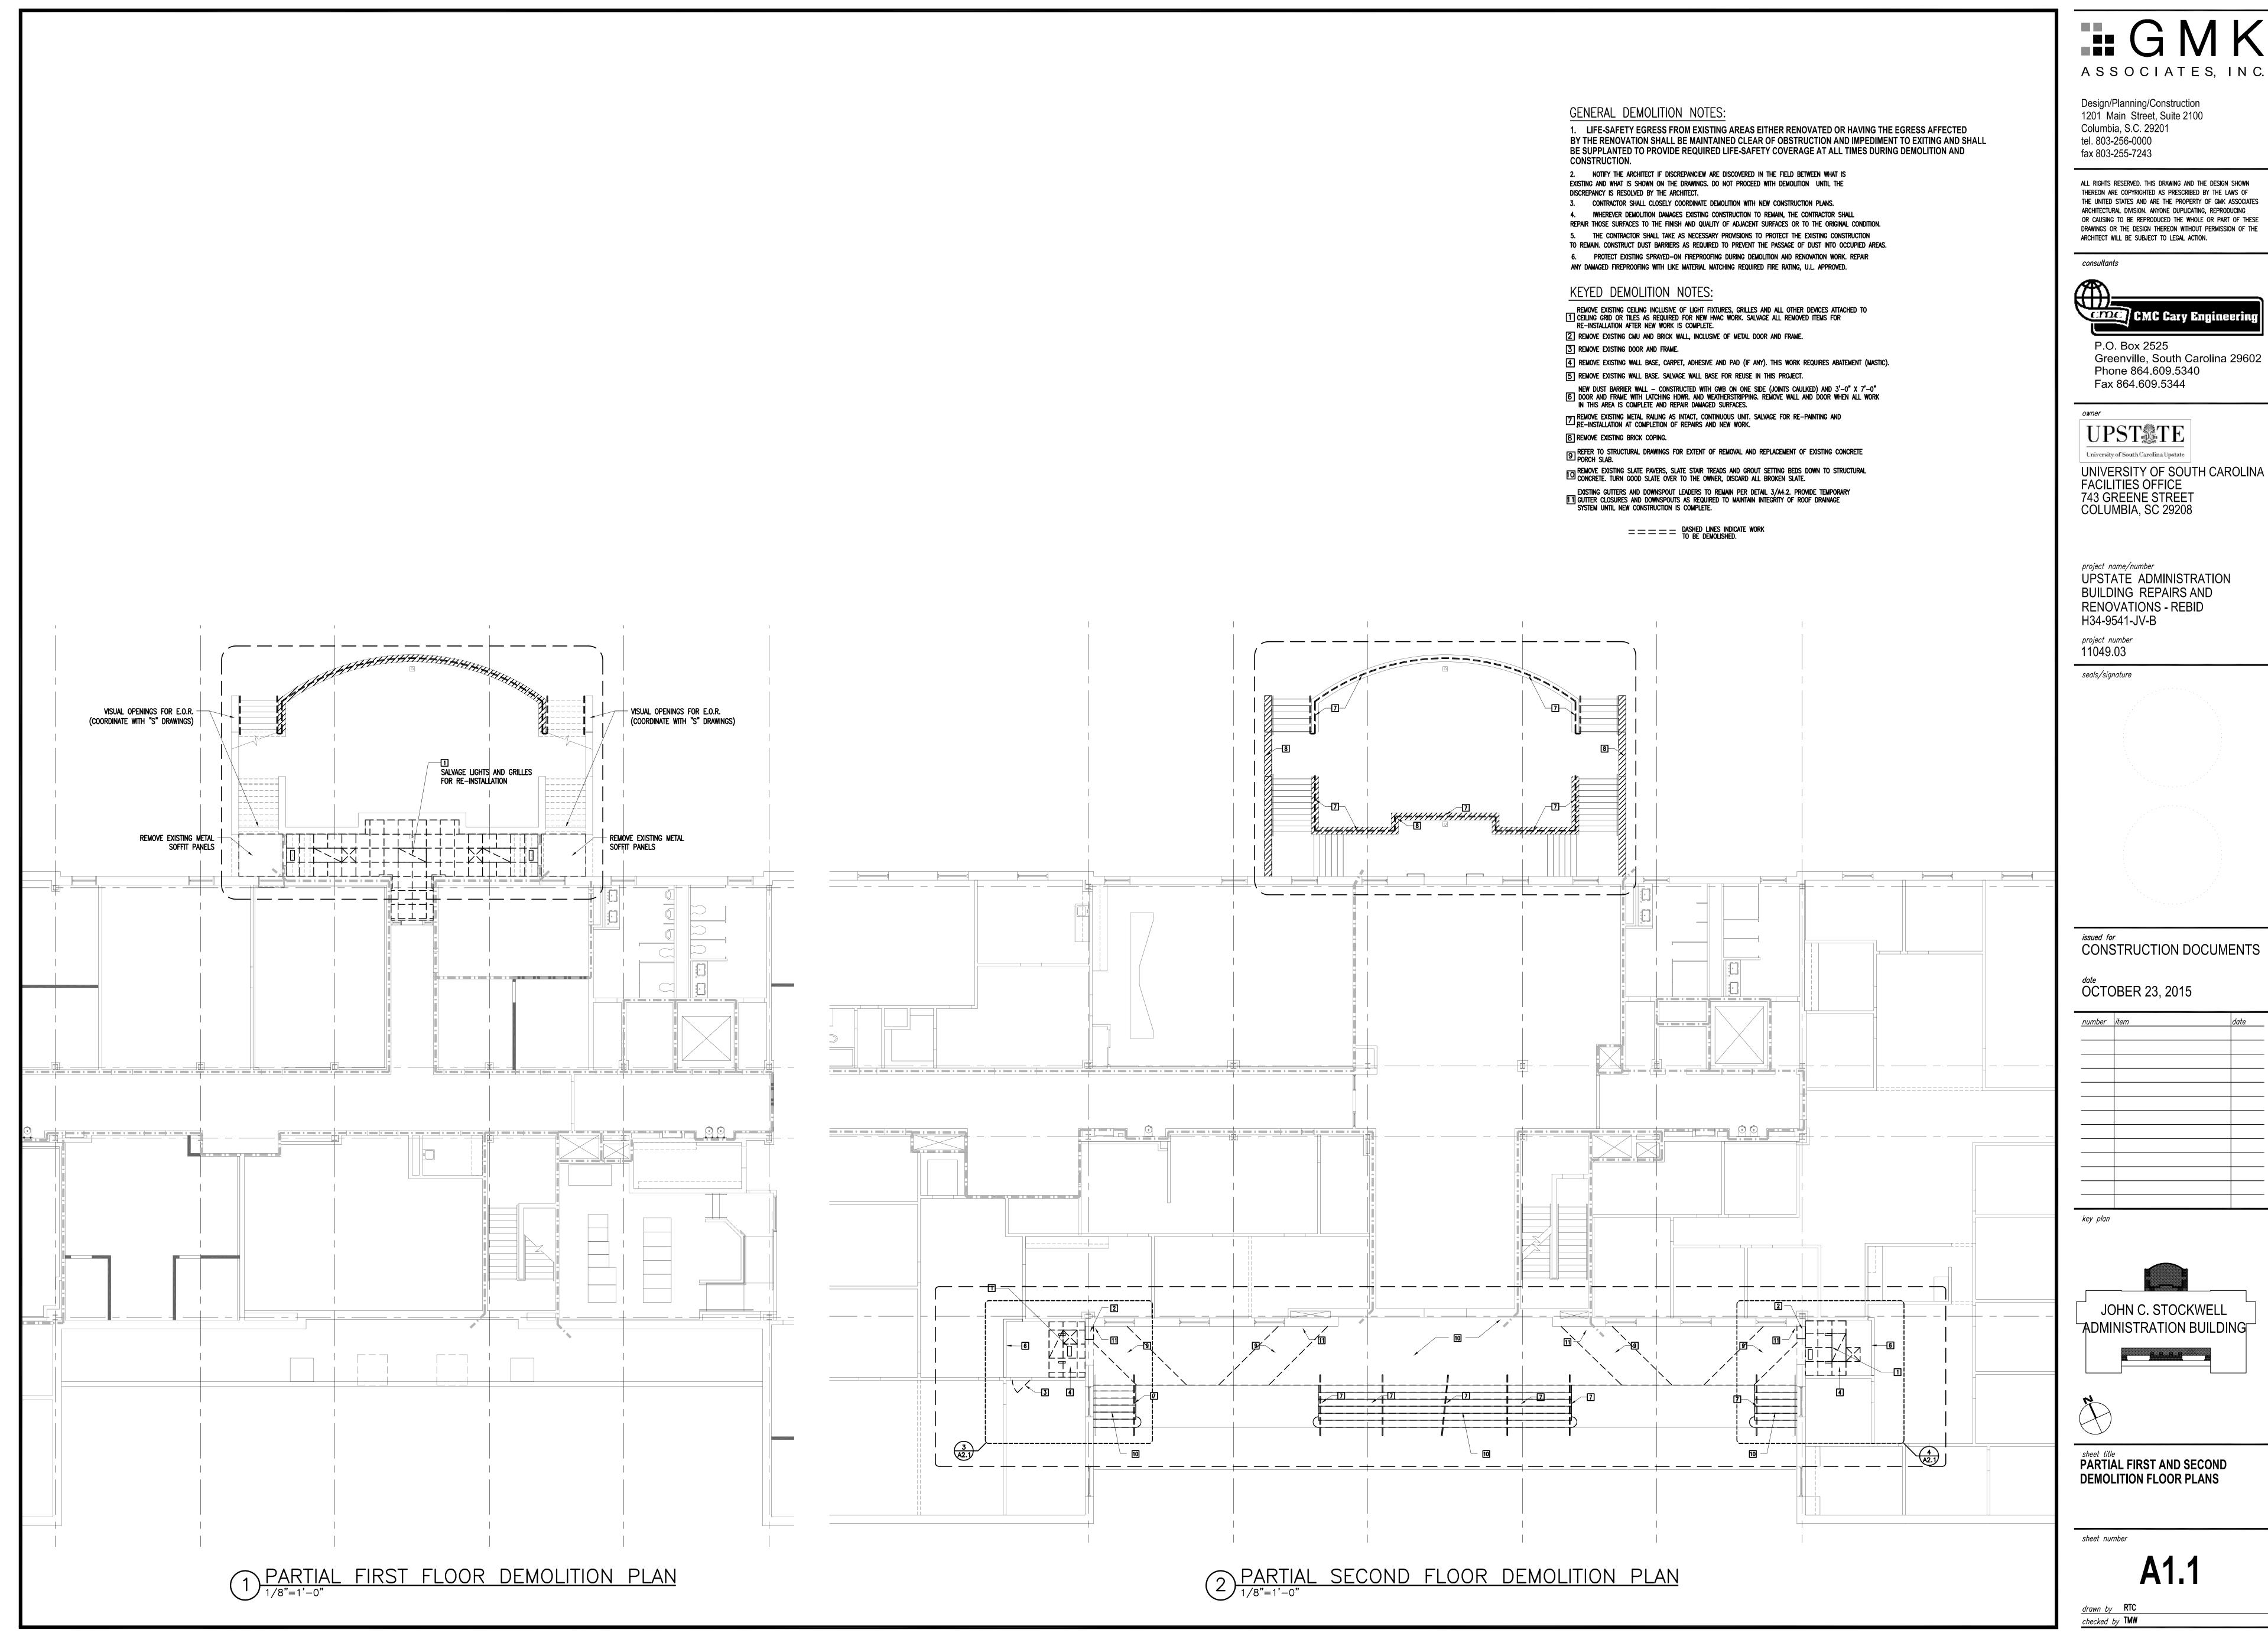


LT GA MTL STUD **WALL SCHEDULES** & DETAILS

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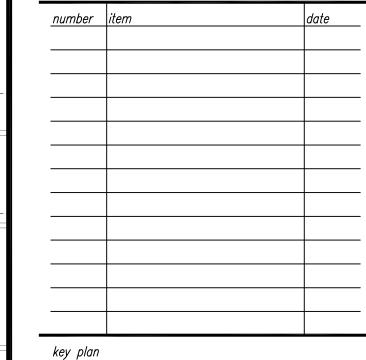
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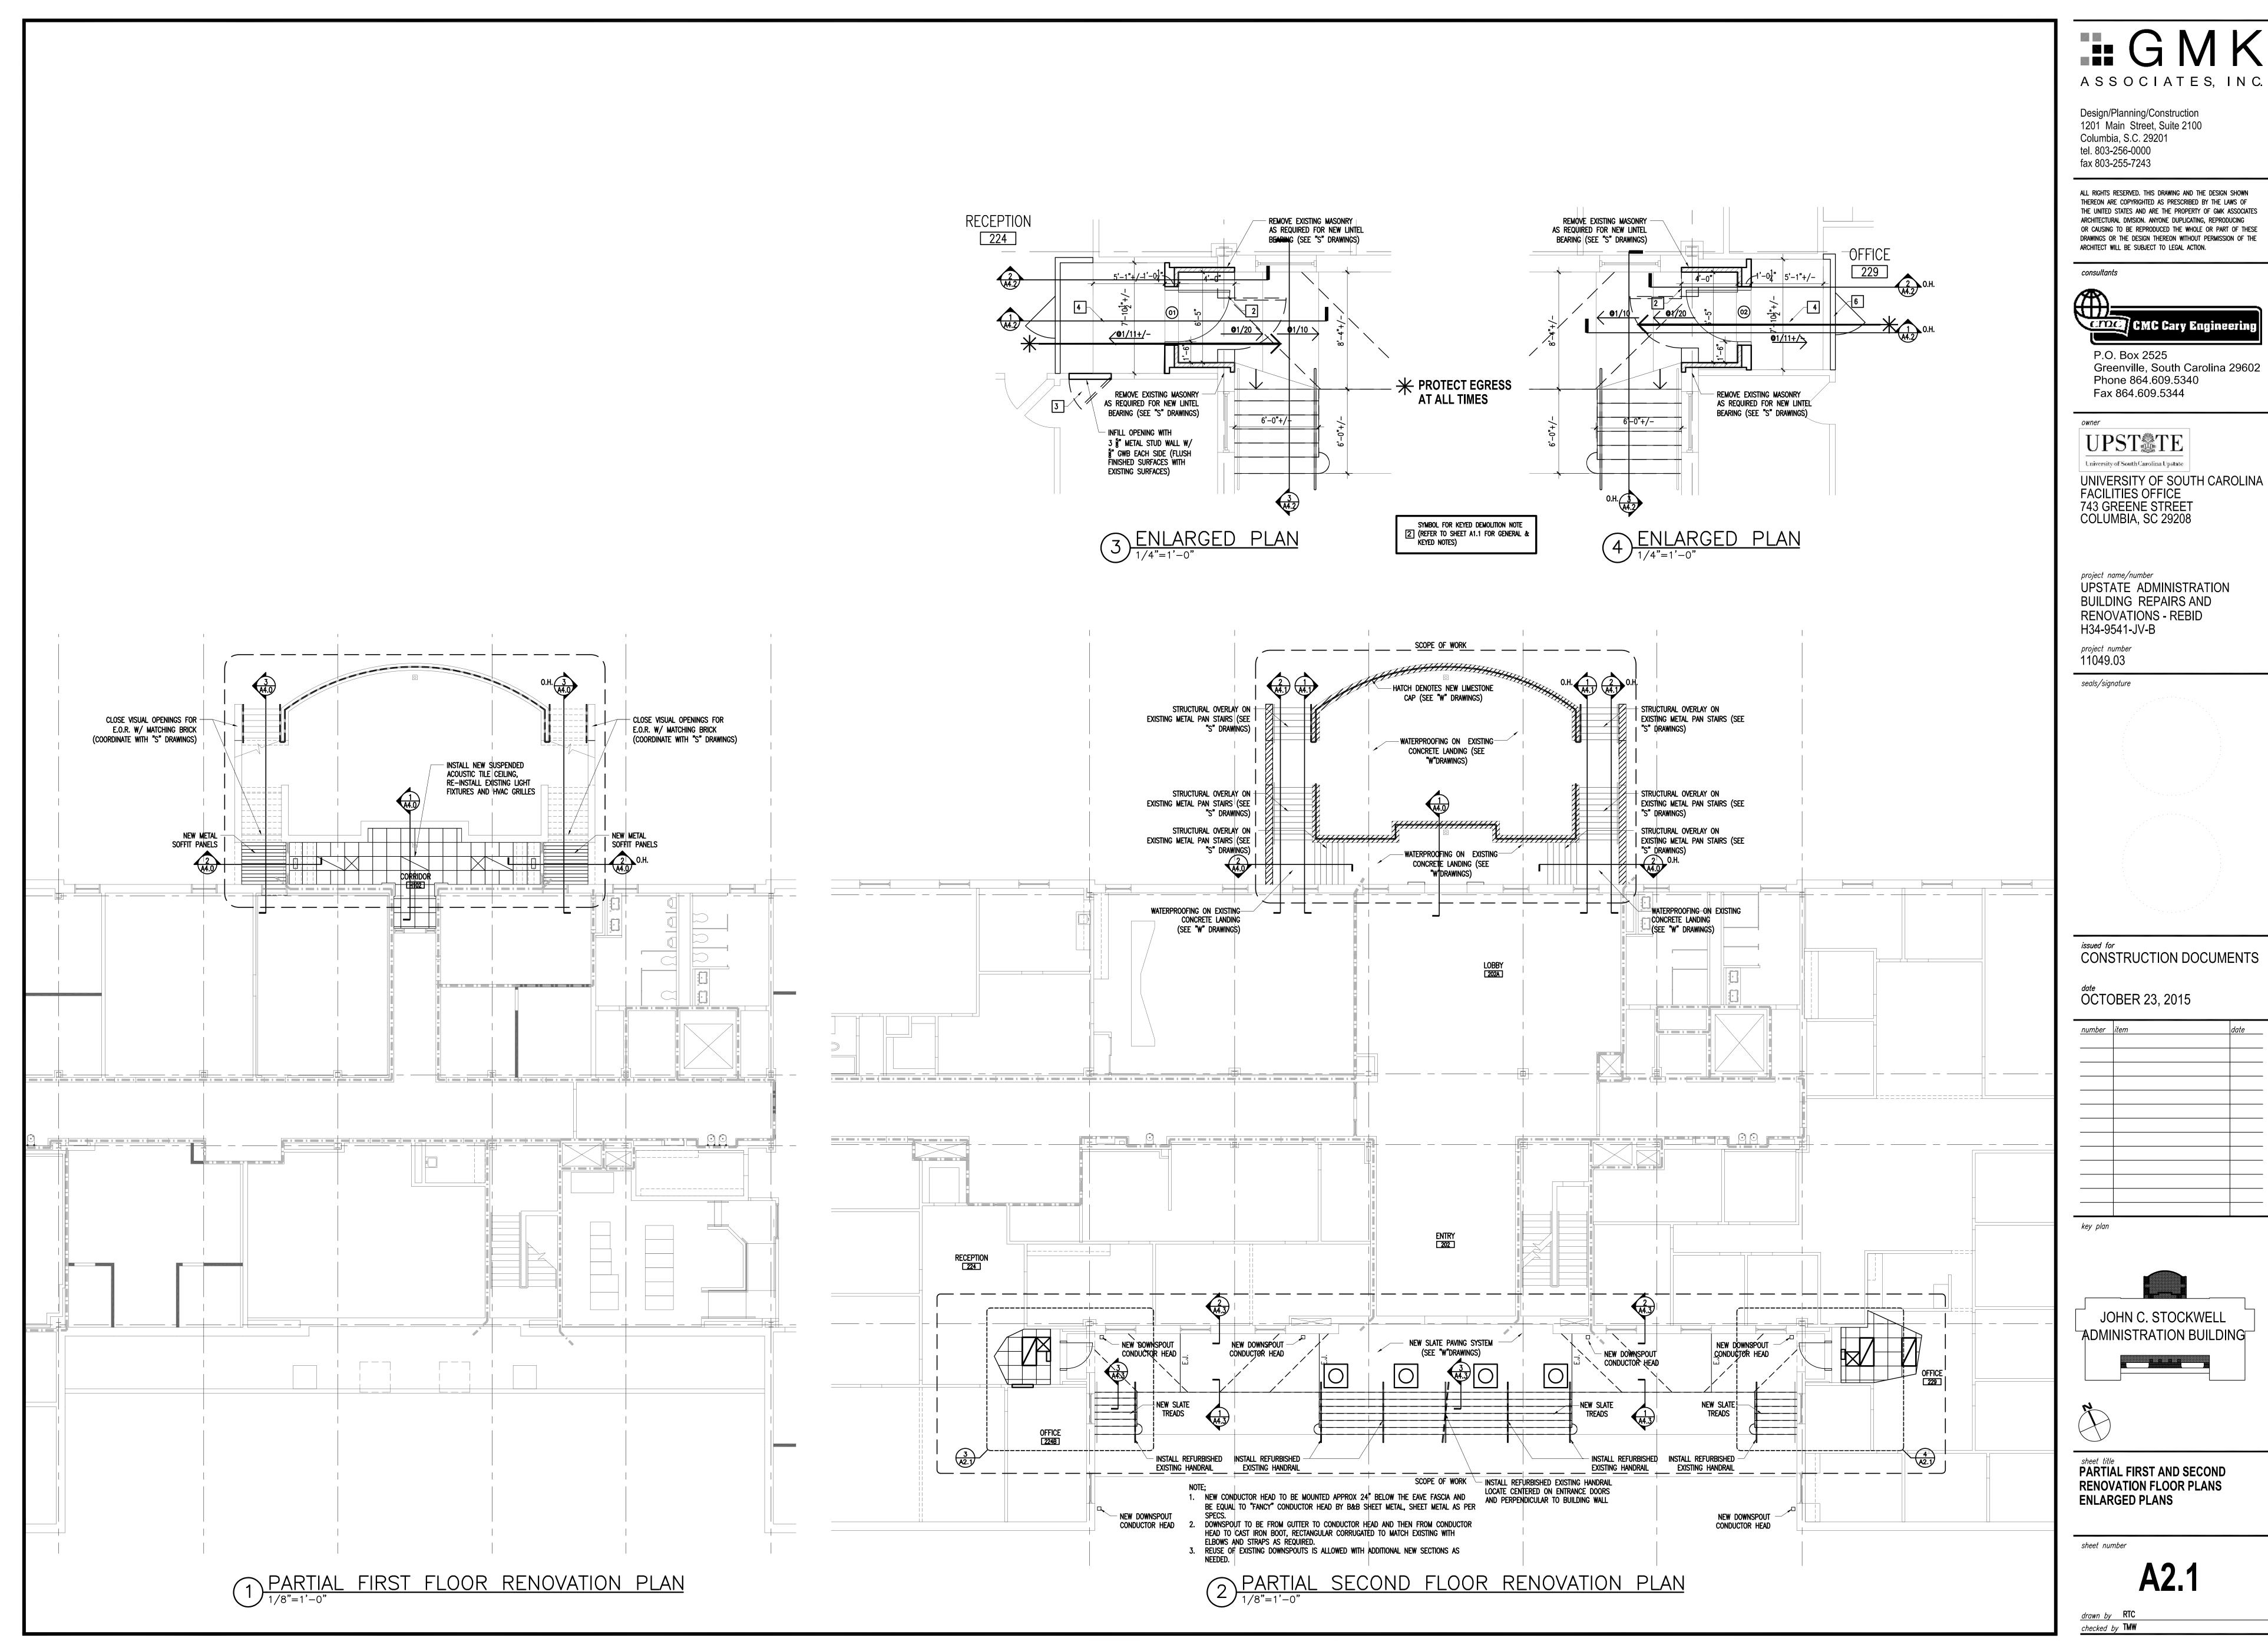




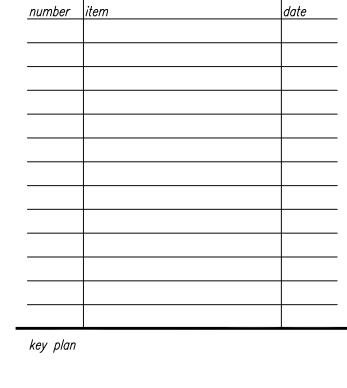
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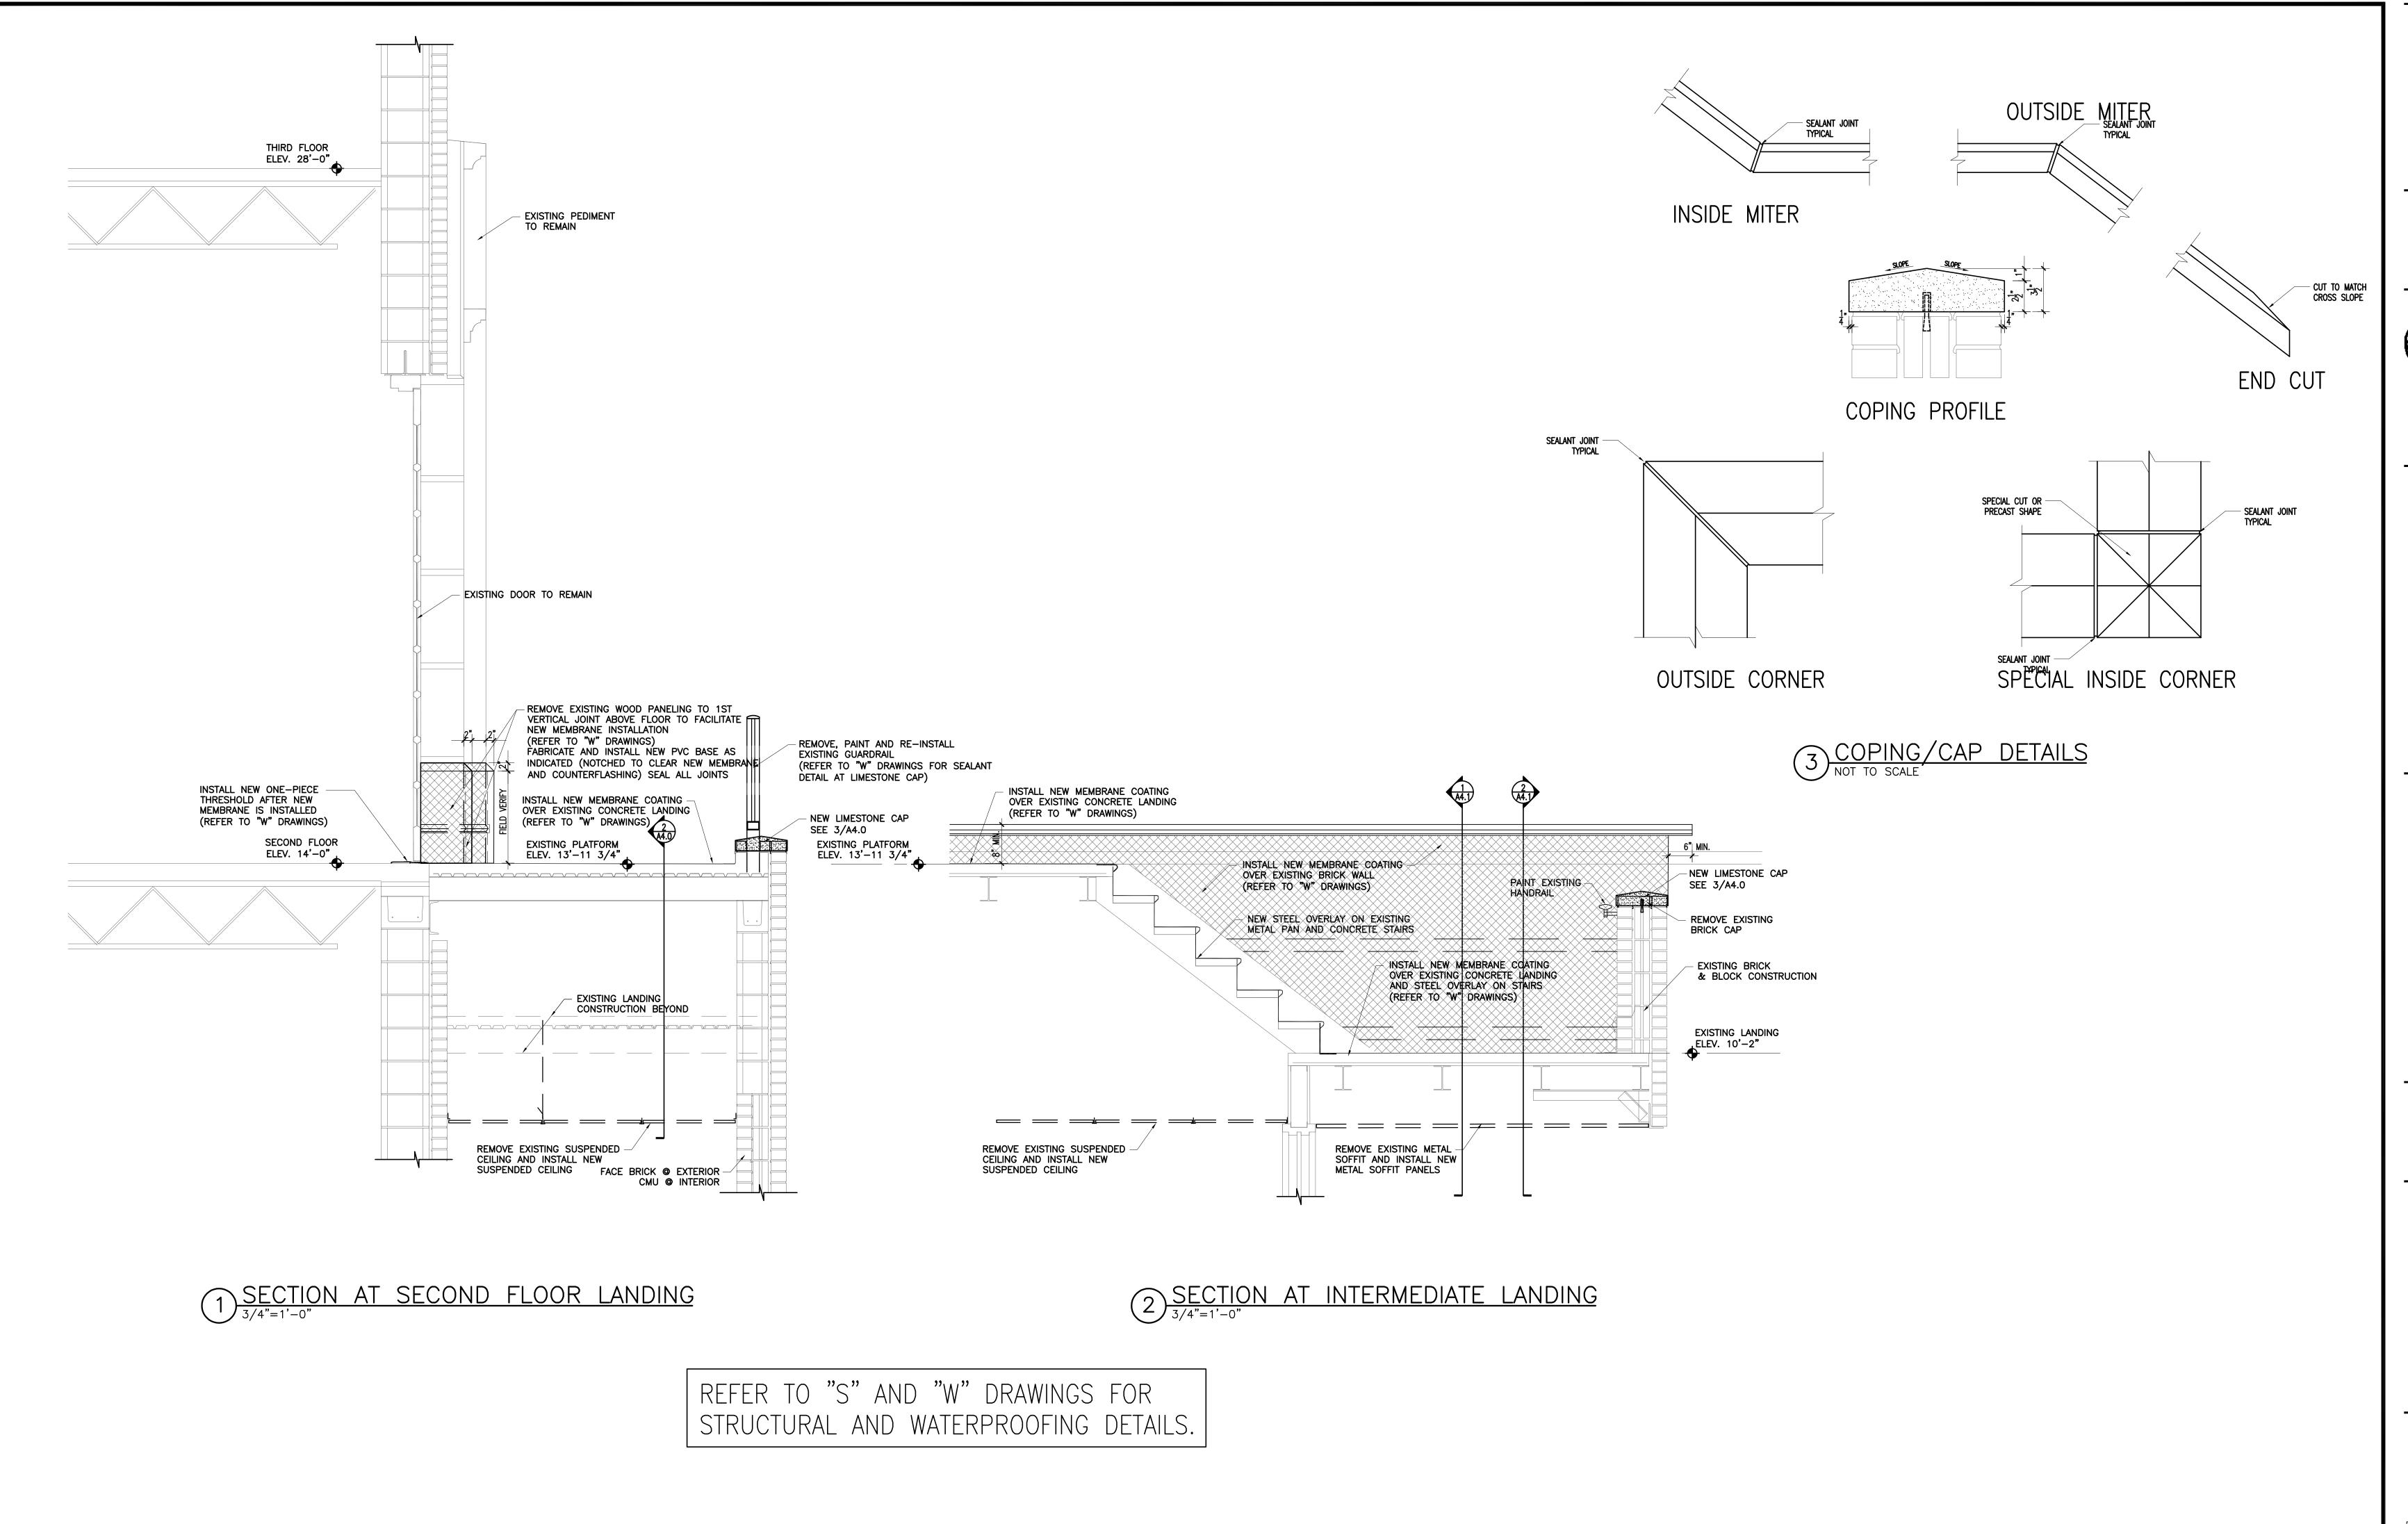
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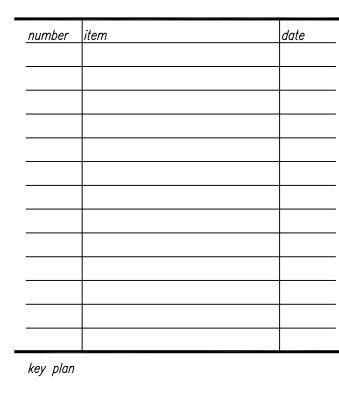
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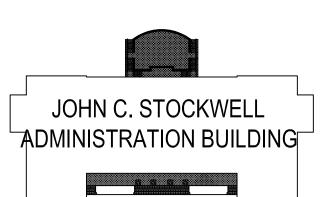
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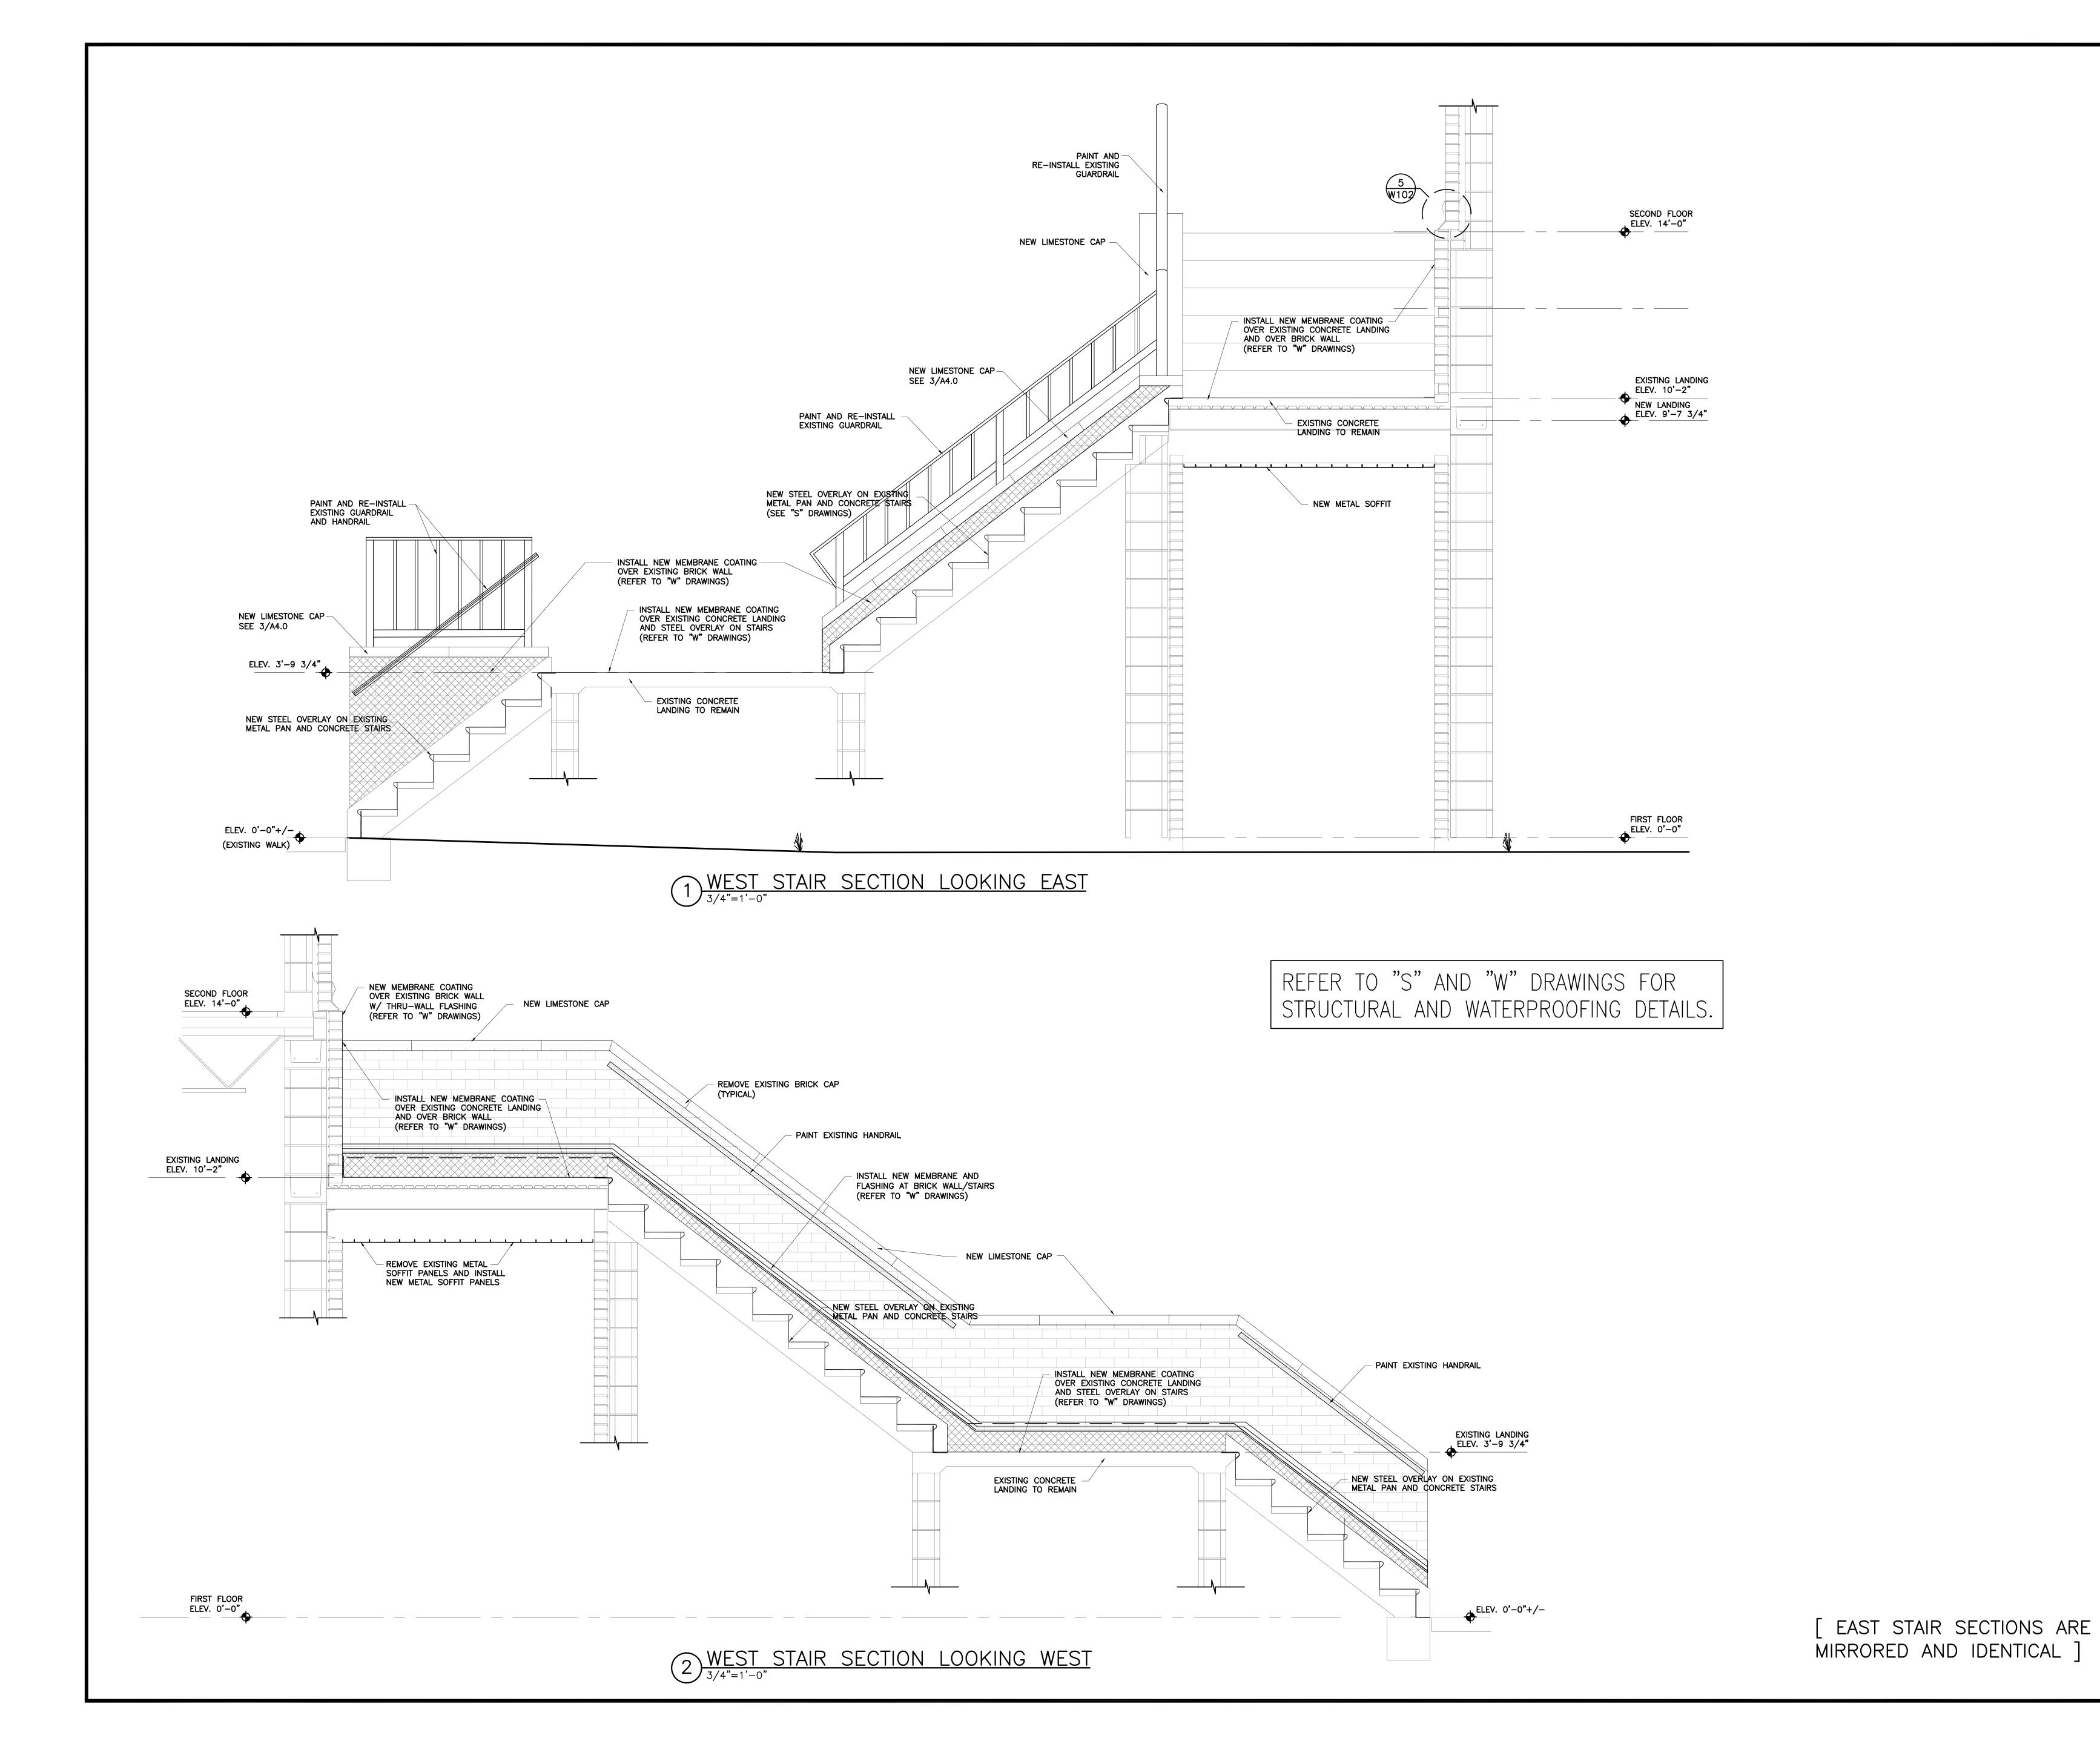


NORTH PORCH STAIR SECTIONS

sheet number

A4.0

drawn by RTC



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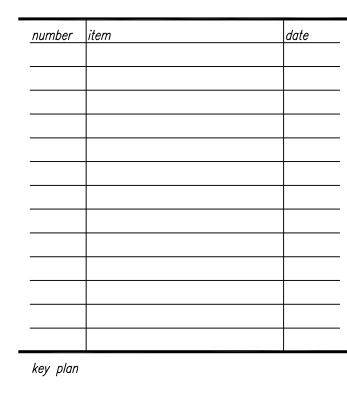
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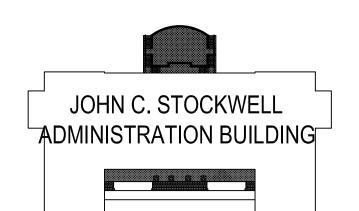
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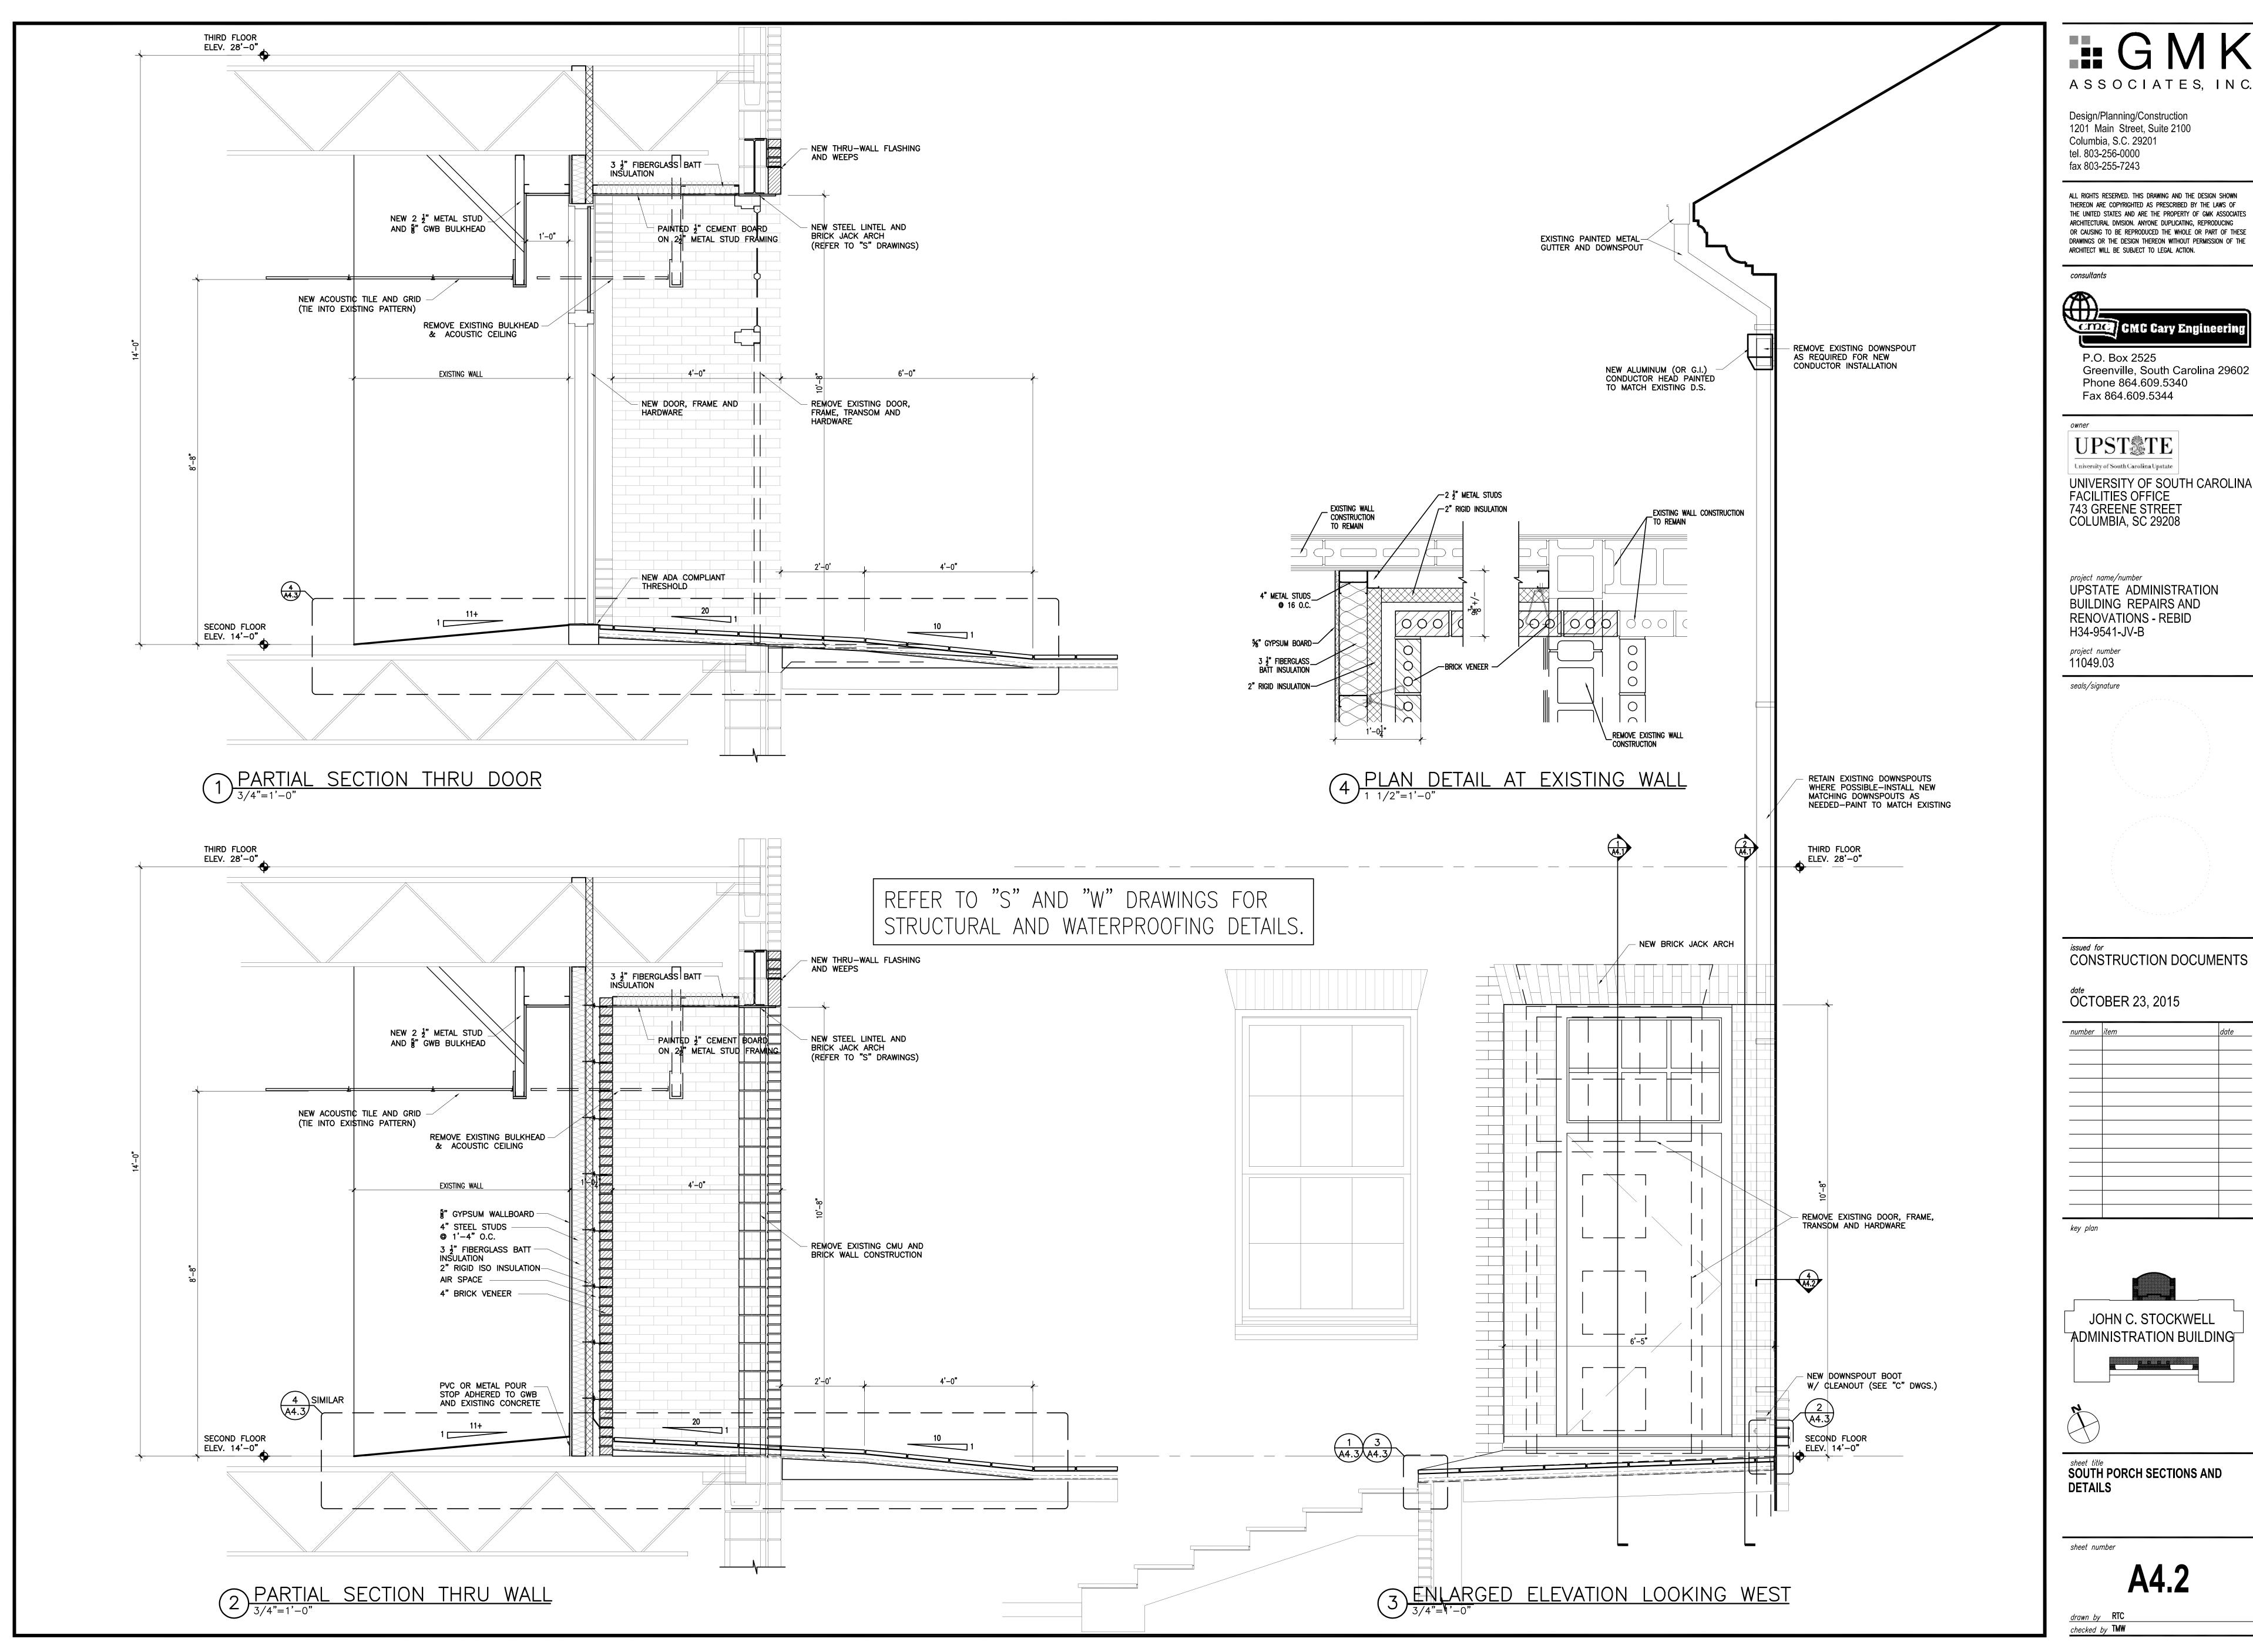


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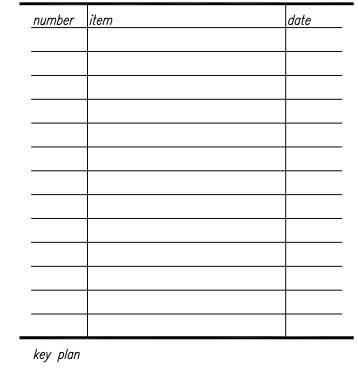
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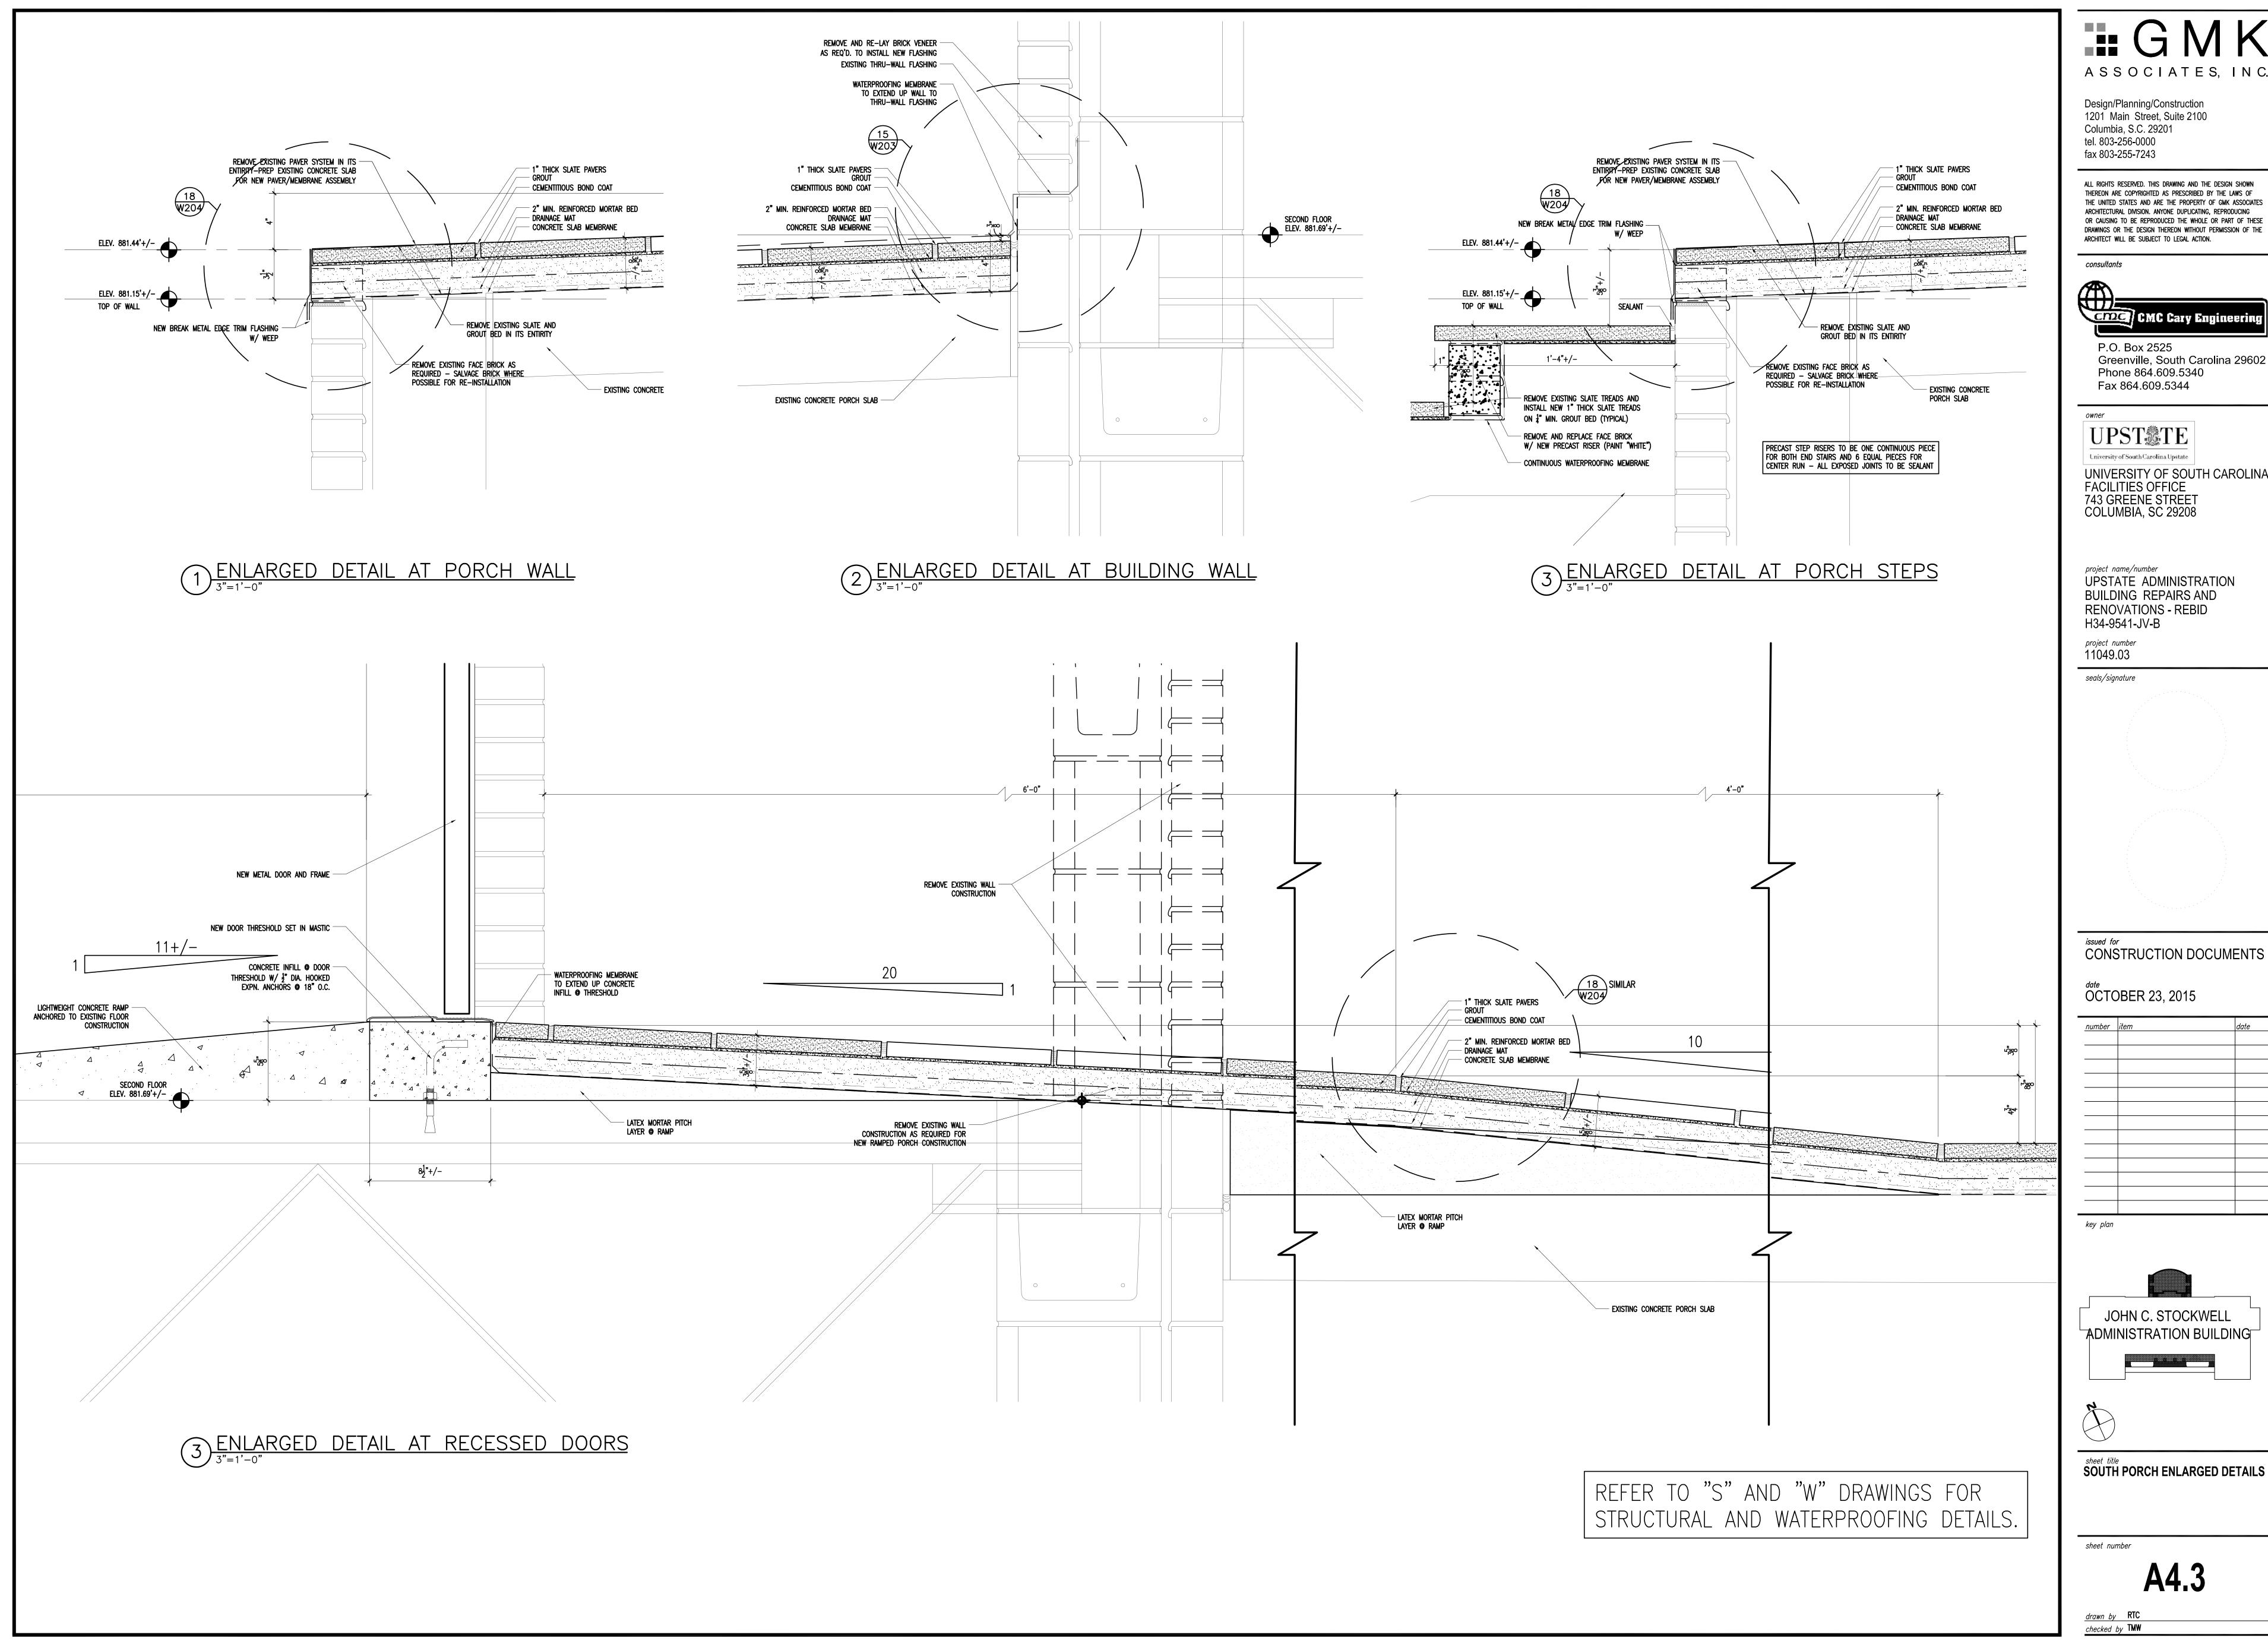
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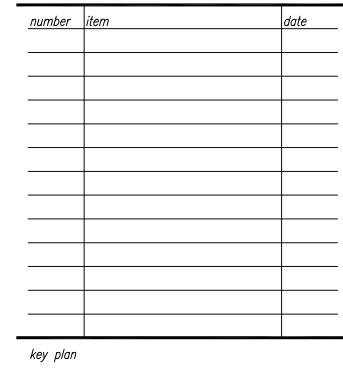
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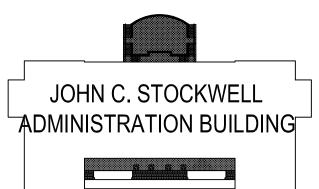
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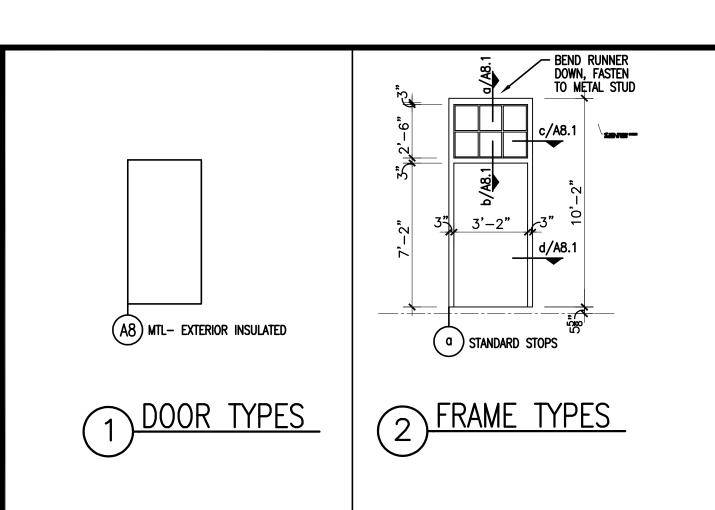
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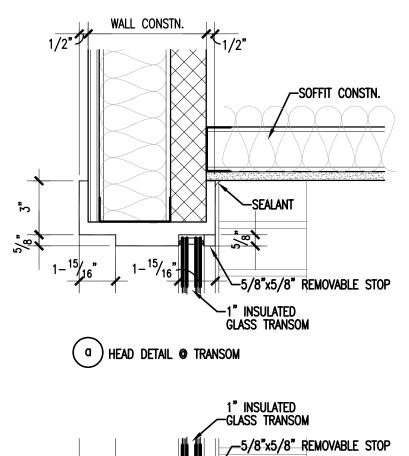
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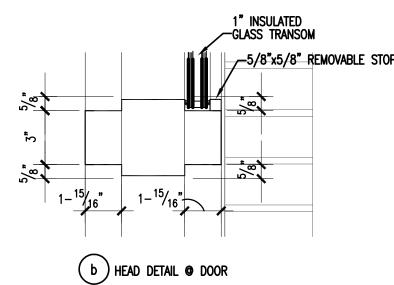
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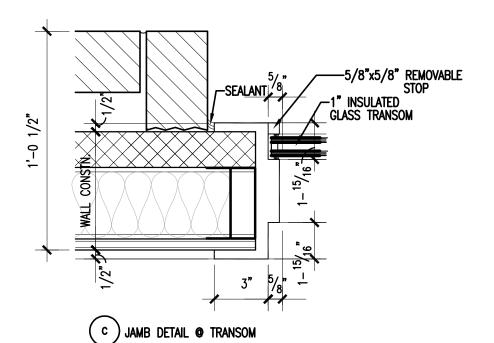


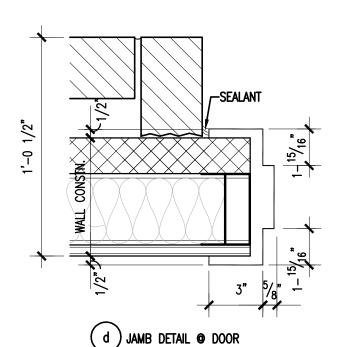




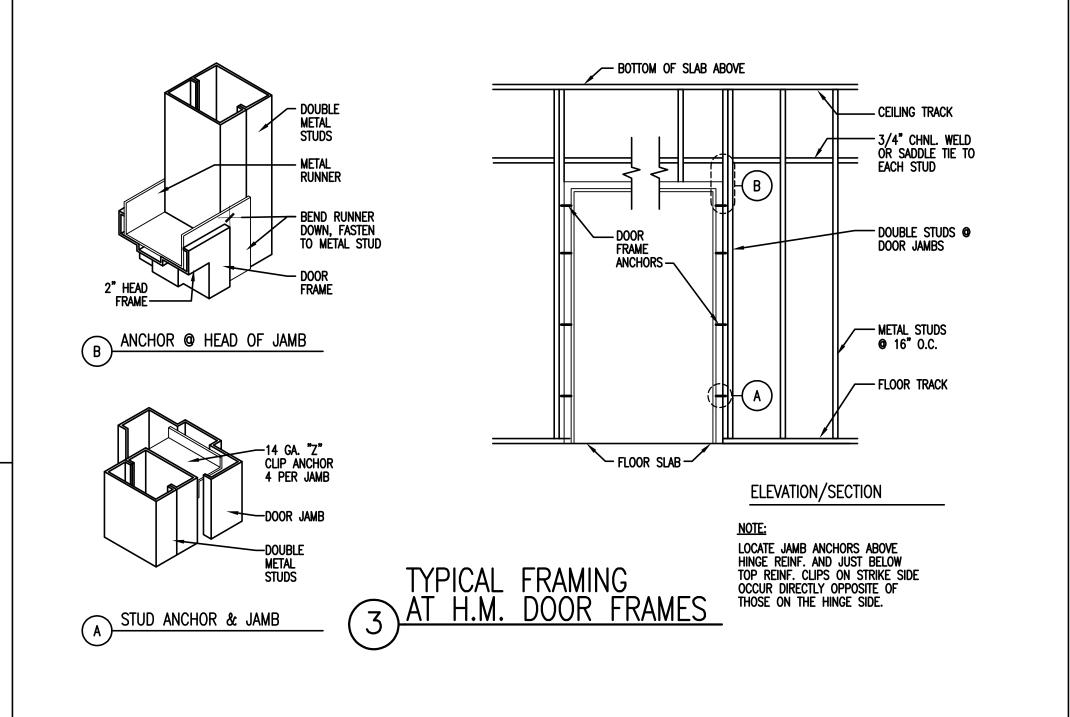








(4) HEAD/JAMB DETAILS



ROOM FINISH SCHEDULE									
ROOM NUMBER	ROOM NAME	FLOOR BAS		BASE	SE WALLS FINISH ACCENT		CELING FINISH ACCENT		REMARKS
NOMBER		FINISH	ACCENT		FINISH	ACCENT	FINISH	ACCENT	V
H102	CORRIDOR	EX	_	_	PNT	_	ACT	_	PTD. EXPOSED CMU WALLS
224	RECEPTION	CARPET	_	WD	GYP/PNT	_	ACT	_	PTD. GYPBD. CEILING BULKHEAD
229	OFFICE	CARPET	_	WD	GYP/PNT	_	ACT	_	PTD. GYPBD CEILING BULKHEAD

<u>FINISH LEGEND</u>: ACT = ACOUSTICAL CEILING TILE

RB = RUBBER BASE PNT = PAINT CPT = CARPETGYP = GYPSUM BOARD

WD = WOOD

FINISH NOTES:
1. CUT AND REMOVE EXISTING CARPET AS REQUIRED FOR NEW CONSTRUCTION. REMAINING CARPET TO REMAIN IN PLACE AND PROTECTED TO PREVENT DAMAGE DURING CONSTRUCTION.

DOOR SCHEDULE					
ROOM NAME	DQOR NUMBER	DOOR ELEV	DOOR SIZE	FRAME ELEV	REMARKS
RECEPTION 224	01	A8	3'-8" X 7'-2"	а	NEW DOOR, FRAME, HDWR. AND ADA THRESHOLD
OFFICE 229	02	A8	3'-8" X 7'-2"	а	NEW DOOR, FRAME, HDWR. AND ADA THRESHOLD
	_				

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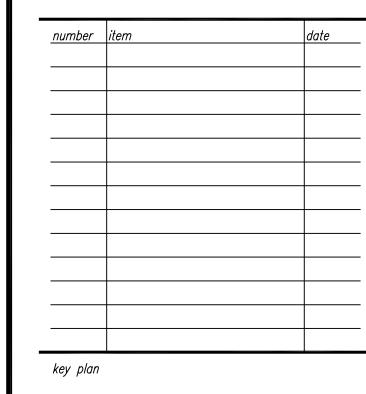
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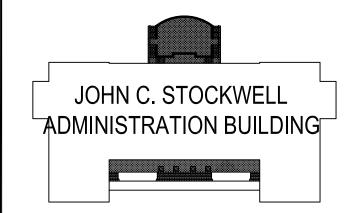
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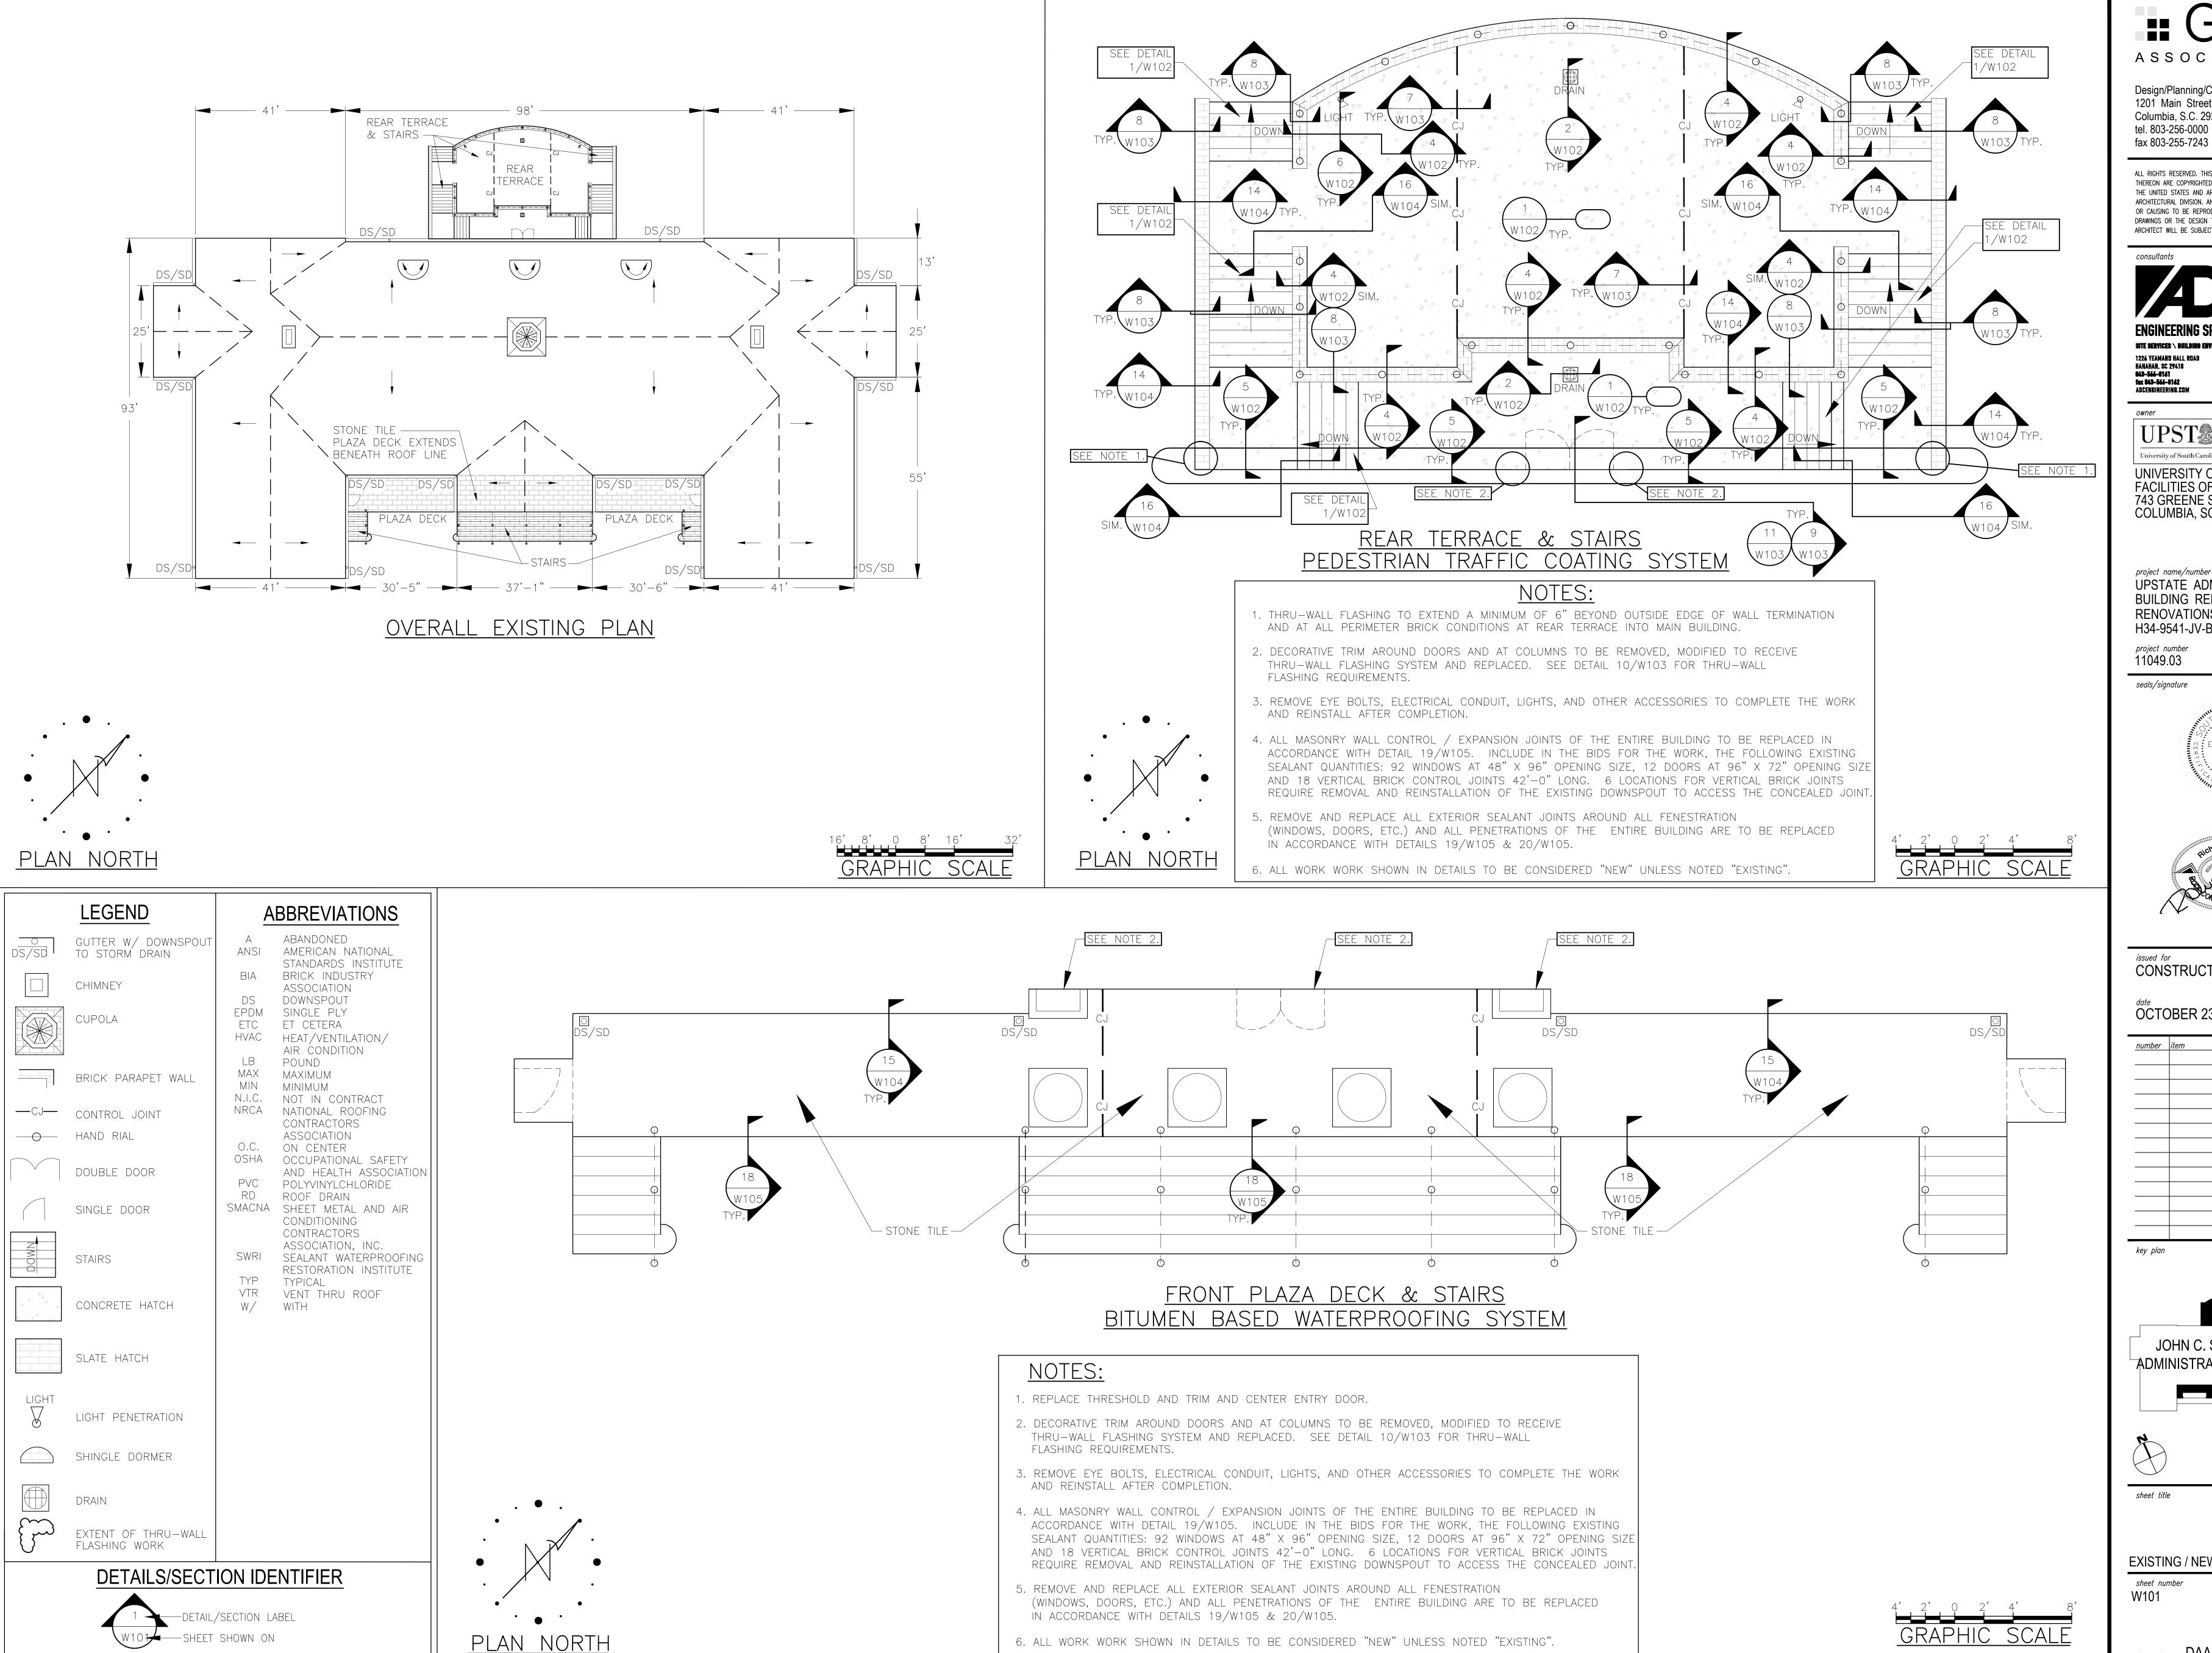




sheet title
ROOM FINISH SCHEDULE DOOR SCHEDULE, DOOR & FRAME TYPES AND DETAILS

sheet number

drawn by RTC checked by TMW



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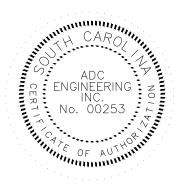
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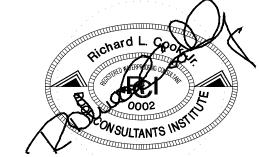
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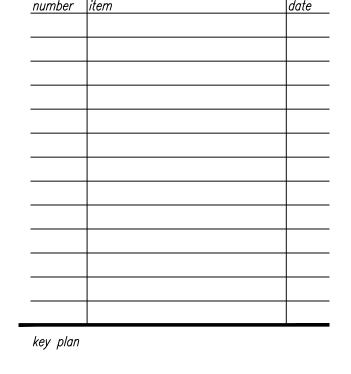
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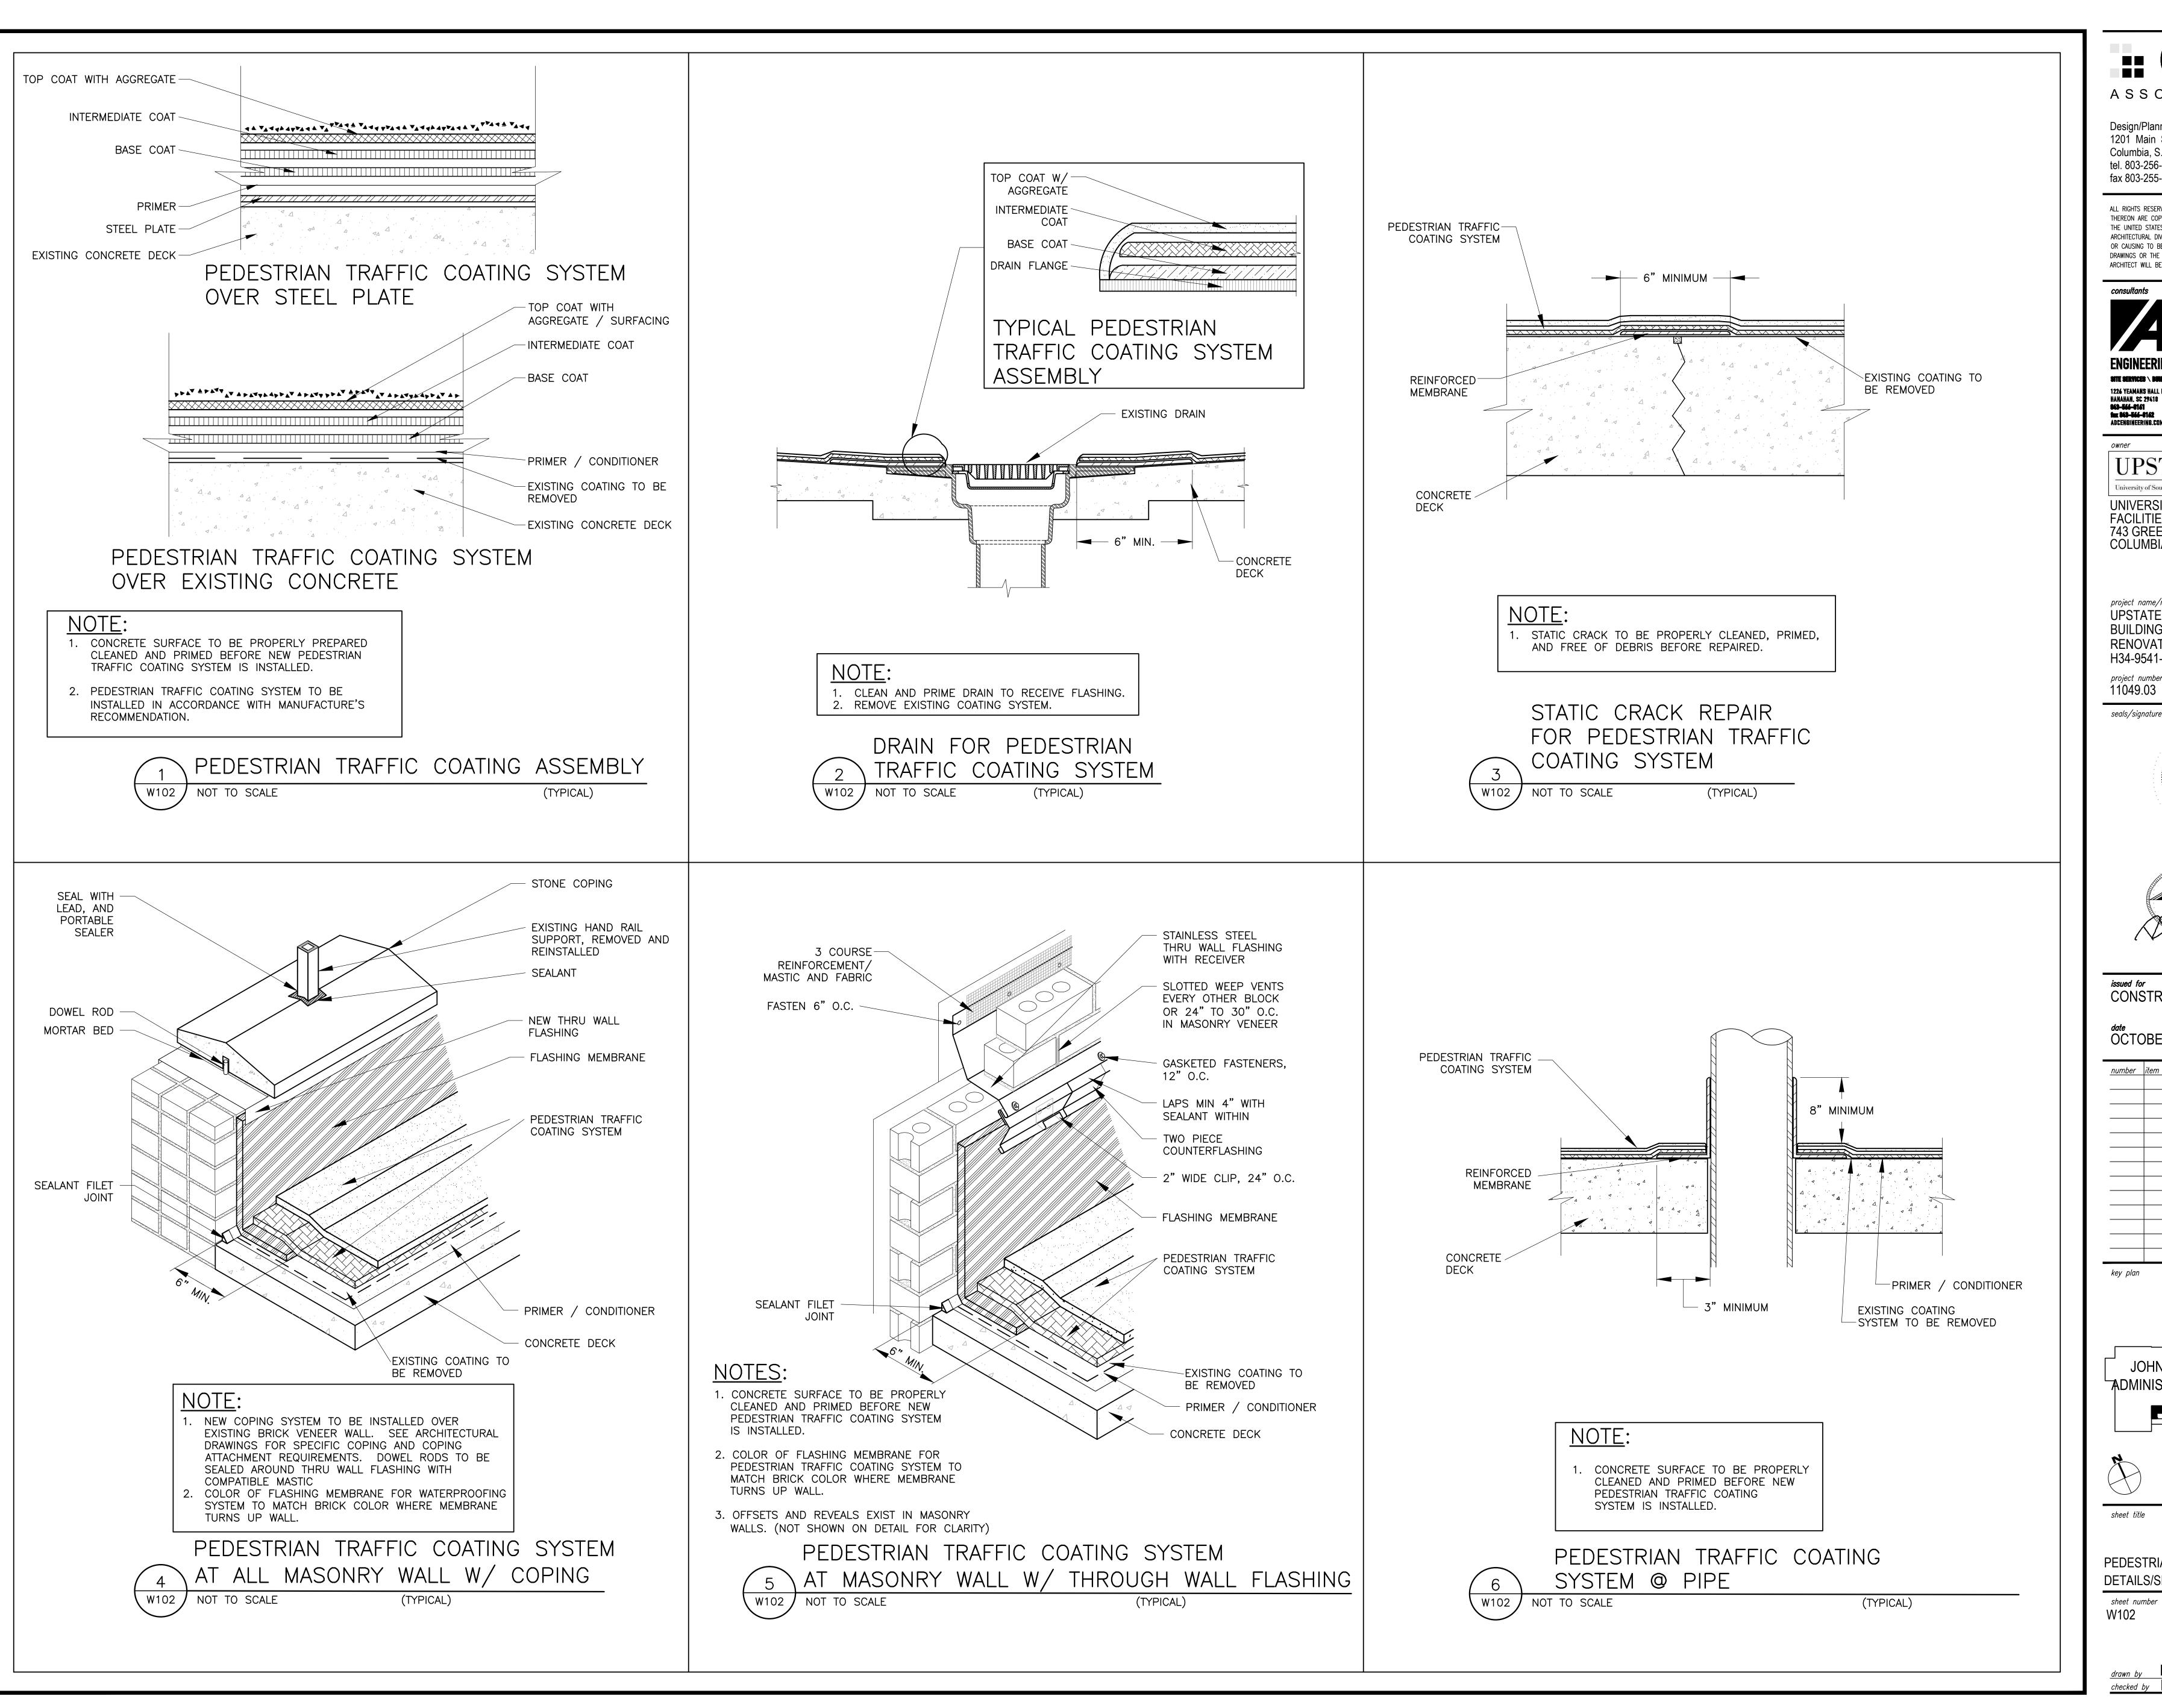




EXISTING / NEW PLAN

sheet number

drawn by DAA checked by RLC



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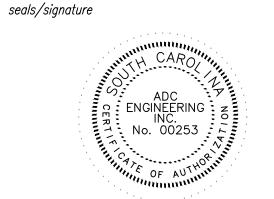
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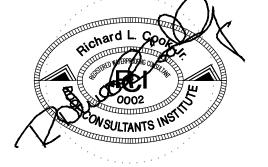
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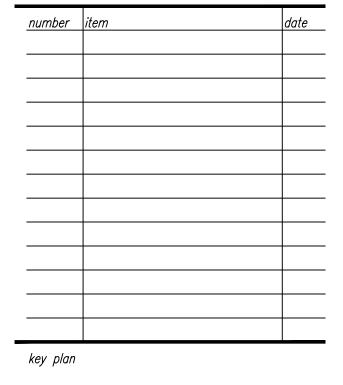
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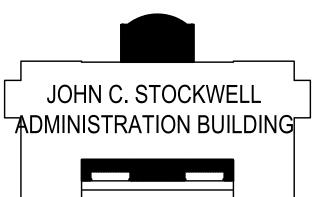




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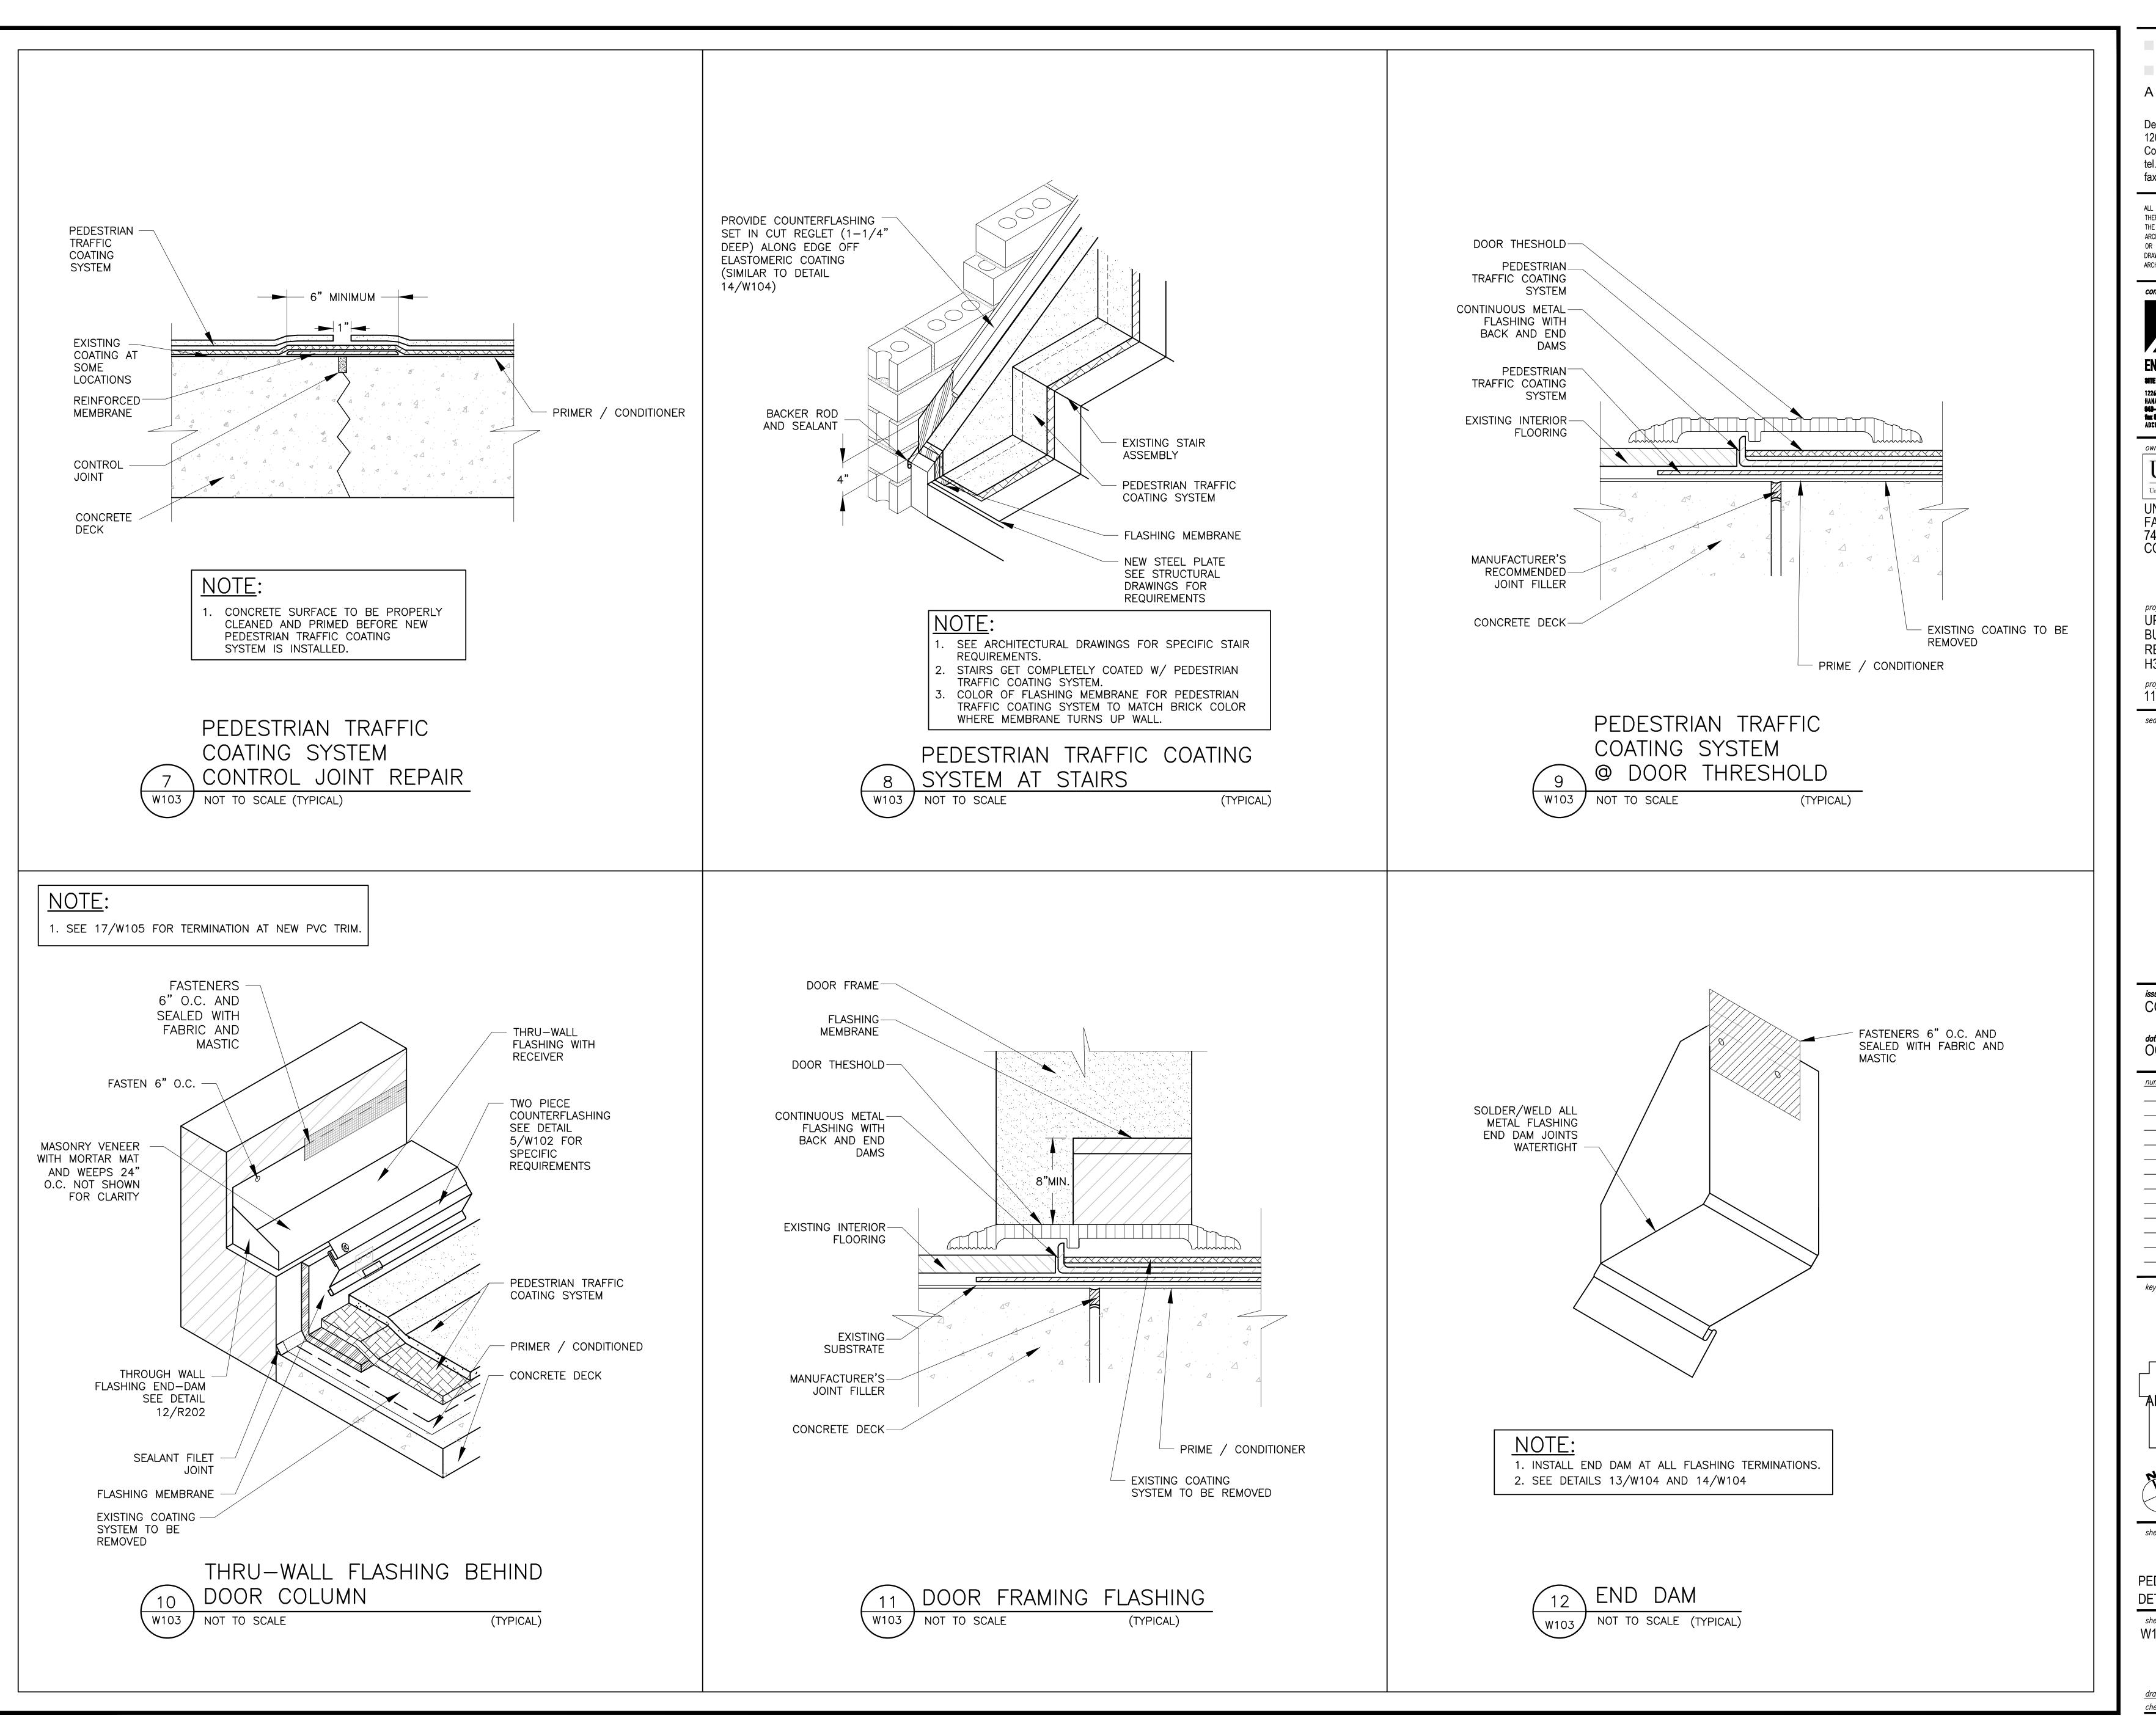




PEDESTRIAN TRAFFIC COATING **DETAILS/SECTIONS**

W102

drawn by DAA checked by RLC



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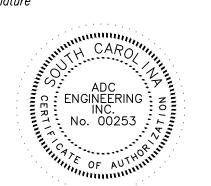
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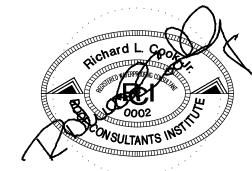
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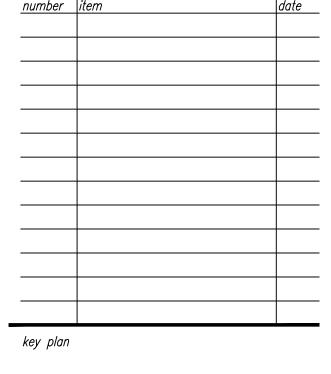
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date OCTOBER 23, 2015

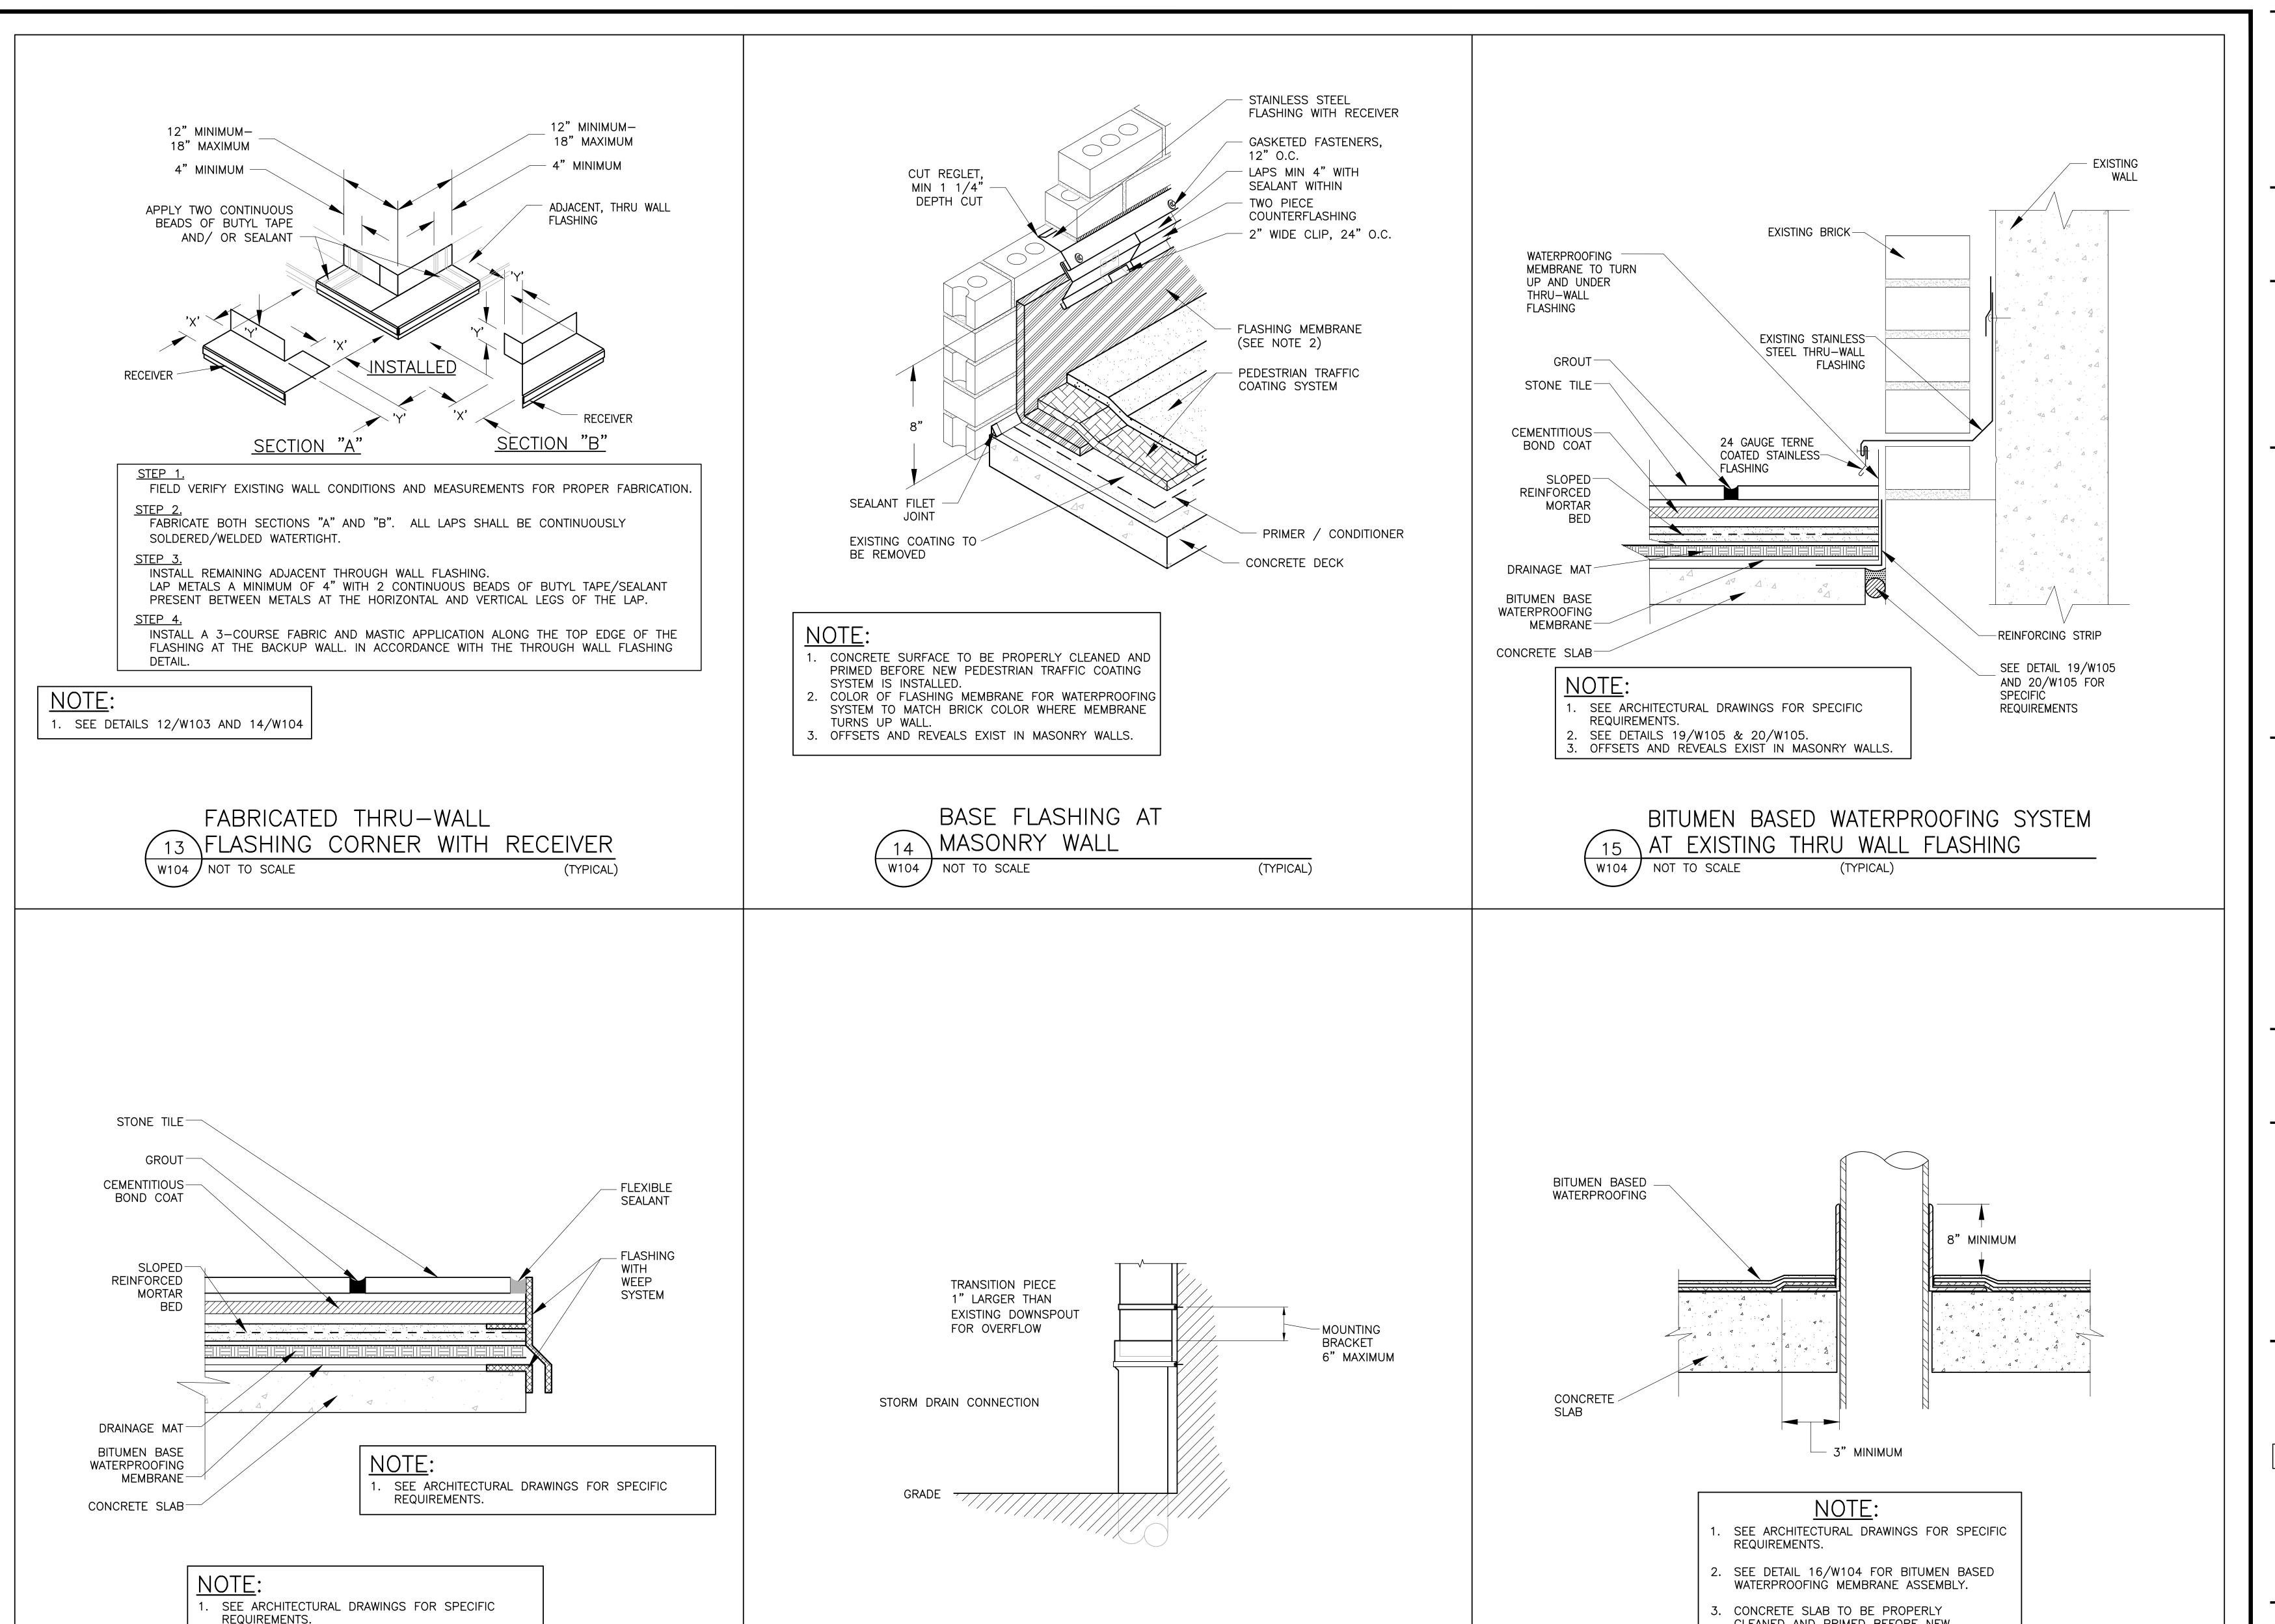






PEDESTRIAN TRAFFIC COATING **DETAILS/SECTIONS**

sheet number



GUTTER AND DOWNSPOUT

W104

NOT TO SCALE

CONNECTIONS TO STORM DRAIN

(TYPICAL)

BITUMEN BASED WATERPROOFING

(TYPICAL)

MEMBRANE ASSEMBLY

W104

NOT TO SCALE

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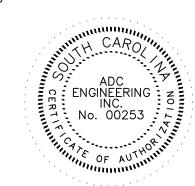
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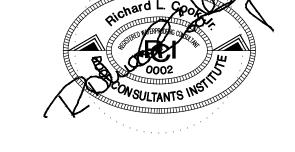
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BUILDING REPAIRS AND
RENOVATIONS - REBID
H34-9541-JV-B

11049.03

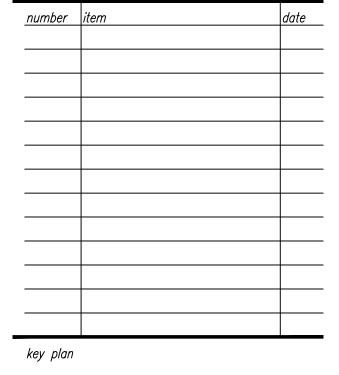
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sheet title

CLEANED AND PRIMED BEFORE NEW BITUMEN BASED WATERPROOFING

BITUMEN BASED WATERPROOFING

(TYPICAL)

SYSTEM IS INSTALLED.

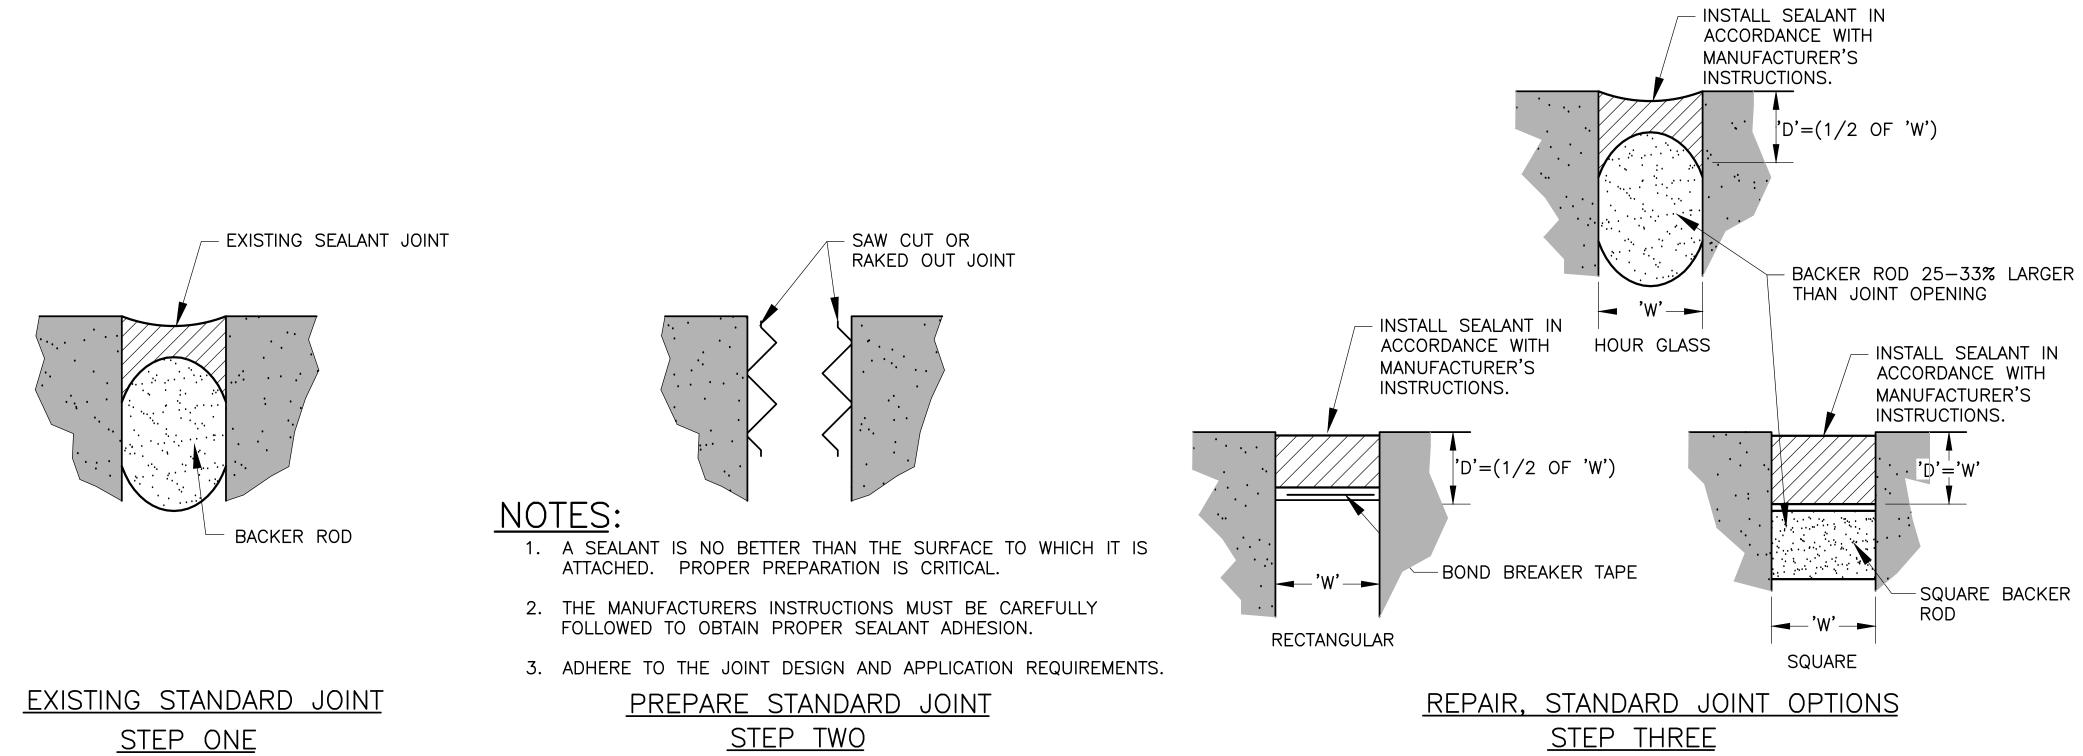
SYSTEM @ PIPE

W104 / NOT TO SCALE

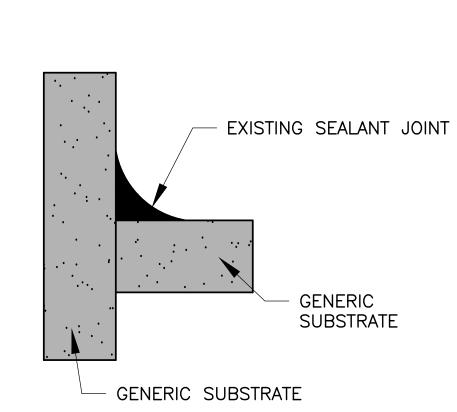
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sheet number W104

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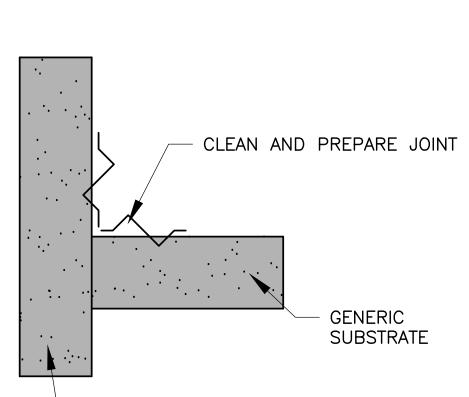






EXISTING CORNER/FILLET JOINT

STEP ONE



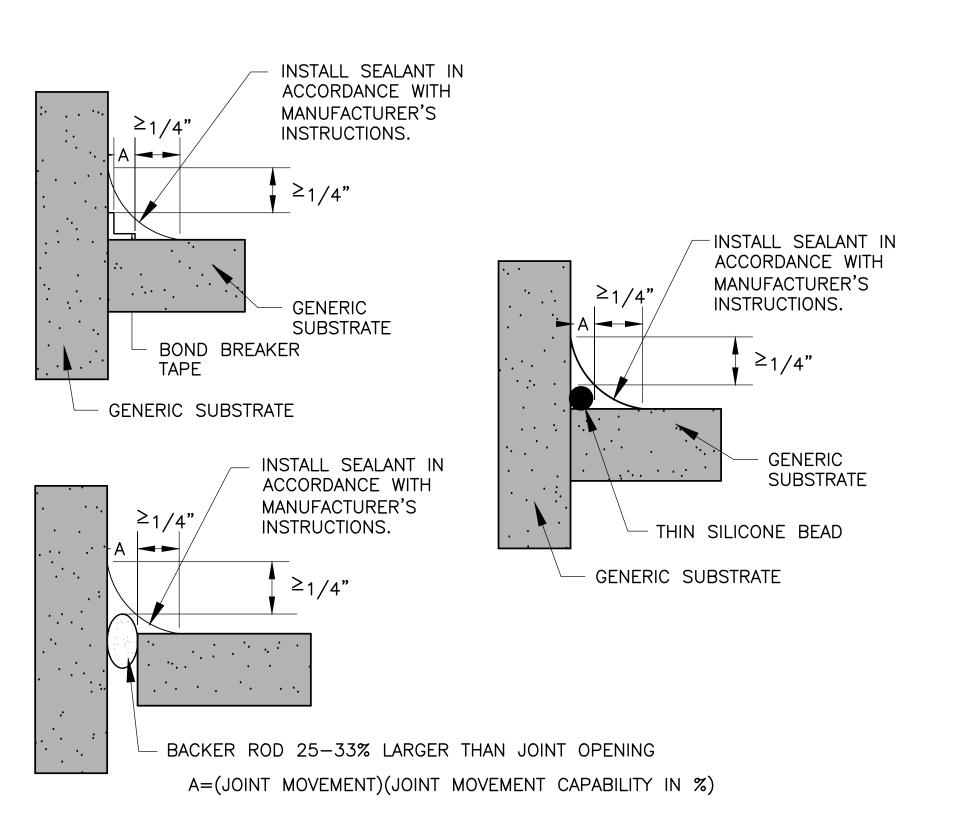
NOTES:

- 1. A SEALANT IS NO BETTER THAN THE SURFACE TO WHICH IT IS ATTACHED. PROPER PREPARATION IS CRITICAL.
- 2. THE MANUFACTURERS INSTRUCTIONS MUST BE CAREFULLY FOLLOWED TO OBTAIN PROPER SEALANT ADHESION.
- 3. ADHERE TO THE JOINT DESIGN AND APPLICATION REQUIREMENTS.
- 4. CONTRACTOR OPTIONS FOR BOND BREAKER/BACKER ROD FOR CORNER/FILLET JOINT.

PREPARE CORNER/FILLET JOINT

STEP TWO



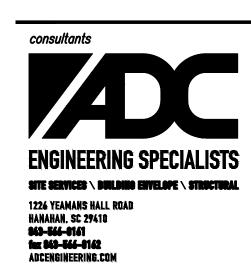


PROVIDE CORNER/FILLET JOINT OPTIONS
STEP THREE

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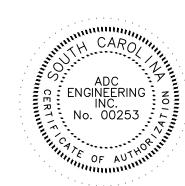
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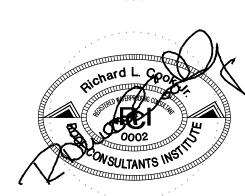
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H34-9541-JV-B

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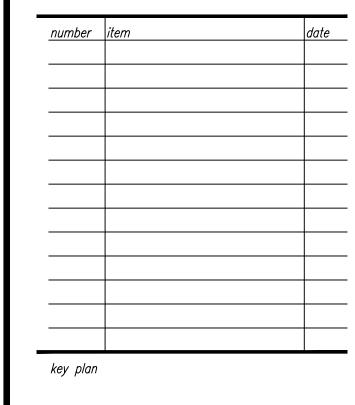
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SEALANTS DETAILS/SECTIONS

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