

| AIR DISTRIBUTION SCHEDULE |                    |              |       |        |         |           |           |        |         |  |
|---------------------------|--------------------|--------------|-------|--------|---------|-----------|-----------|--------|---------|--|
| TAG                       | DESCRIPTION        | MANUFACTURER | MODEL | FRAME  | CFM     | NECK SIZE | FACE SIZE | MAX NC | REMARKS |  |
| A                         | PERFORATED RETURN  | PRICE        | APDDR | LAY-IN |         | 10"x10"   | 24"x24"   | 30     | 1,2     |  |
| B                         | PERFORATED RETURN  | PRICE        | APDDR | LAY-IN |         | 14"x14"   | 24"x24"   | 30     | 1,2     |  |
| 0                         | PERFORATED EXHAUST | PRICE        | APDDR | LAY-IN | 251-350 | 10"x10"   | 24"x24"   | 30     | 1,2,3   |  |

1. PROVIDE WITH STANDARD WHITE FINISH. 2. PROVIDE ALUMINUM OR ALUMINIZED STEEL CONSTRUCTION. 3. PROVIDE WITH OPPOSED BLADE DAMPER.

## GENERAL NOTES


- VISIT SITE PRIOR TO BIDDING. THIS CONTRACTOR SHALL DETERMINE DIFFICULTY OF INSTALLATION AND REFLECT THIS IN HIS BIDDING.
- 2. DO NOT SCALE DRAWINGS. SEE ARCHITECTURAL DRAWINGS AND REFLECTED CEILING PLANS FOR EXACT LOCATIONS OF DOORS, WINDOWS, AIR DISTRIBUTION, ETC. THIS
- CONTRACTOR SHALL VERIFY ALL EXISTING ITEMS AND LOCATIONS IN THE FIELD. 3. ALL DUCTWORK LOCATIONS SHALL BE COORDINATED WITH WORK UNDER OTHER DIVISIONS OF THE SPECIFICATIONS TO AVOID INTERFERENCE.
- 4. THIS CONTRACTOR SHALL BE RESPONSIBLE FOR ANY NECESSARY DISMANTLING OF
- EQUIPMENT TO BE REMOVED.
- 5. ITEMS REMOVED UNDER THIS CONTRACT SHALL BECOME THE PROPERTY OF THE CONTRACTOR AND SHALL BE DISPOSED OF PROPERLY.
- 6. ♠ CONNECTION POINT OF NEW TO EXISTING.

## DEMOLITION NOTES


- EXISTING TRANSFER GRILLE TO BE REMOVED COMPLETELY. EXISTING DUCTWORK TO REMAIN IN PLACE FOR CONNECTION TO NEW.
- 2 EXISTING EXHAUST GRILLE TO BE REMOVED COMPLETELY. EXISTING DUCTWORK TO REMAIN IN PLACE FOR CONNECTION TO NEW.

## NOTES TO SHEET

- INSTALL NEW TRANSFER GRILLE IN NEW ACOUSTICAL CEILING TILE GRID PER THE AIR DISTRIBUTION SCHEDULE AND EXTEND DUCTWORK FULL SIZE OF NECK TO EXISTING DUCTWORK AND TRANSITION AS REQUIRED.
- INSTALL NEW EXHAUST GRILLE IN NEW ACOUSTICAL CEILING TILE GRID PER THE AIR DISTRIBUTION SCHEDULE AND EXTEND DUCTWORK FULL SIZE OF NECK TO EXISTING DUCTWORK AND TRANSITION AS REQUIRED.

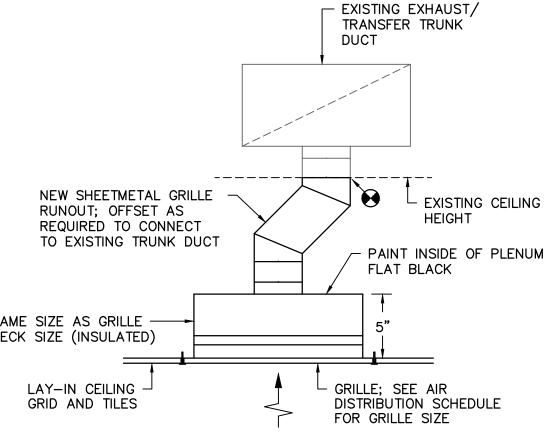


EXHAUST/TRANSFER GRILLE DETAIL NO SCALE

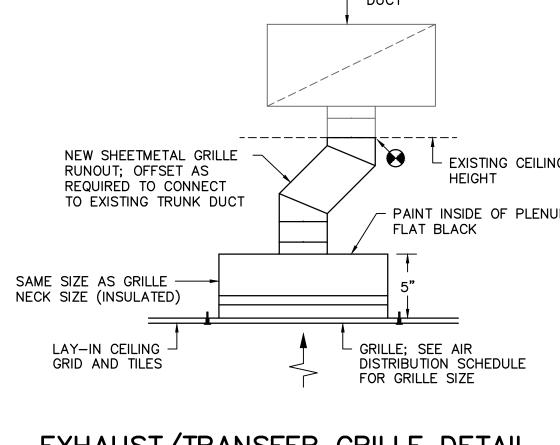




PARTIAL DEMOLITION FLOOR PLAN

M1.1 SCALE: 1/4" = 1'-0"

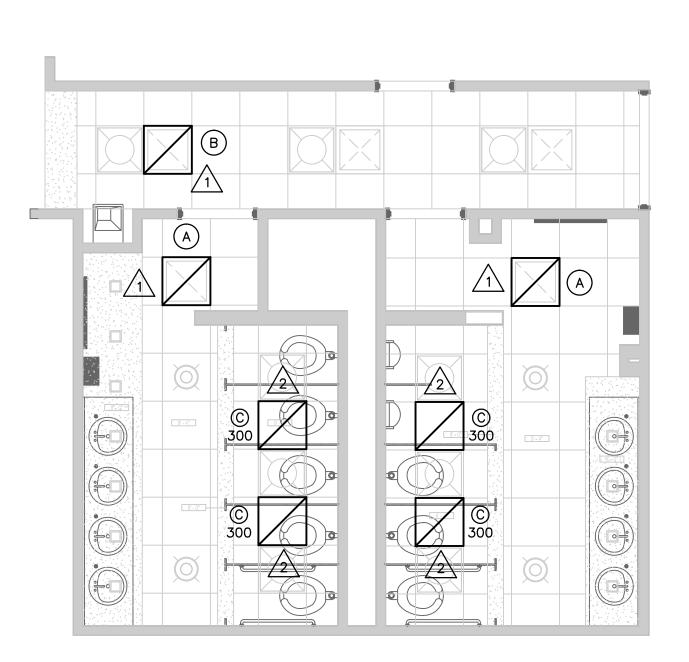


PARTIAL RENOVATION FLOOR PLAN


SCALE: 1/4" = 1'-0"

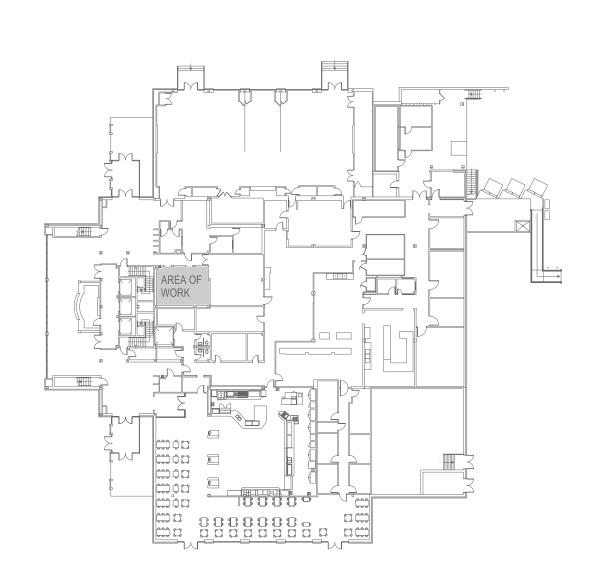



FIRST FLOOR KEY PLAN
NO SCALE

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CAPSTONE LOBBY REFURBISHMENT

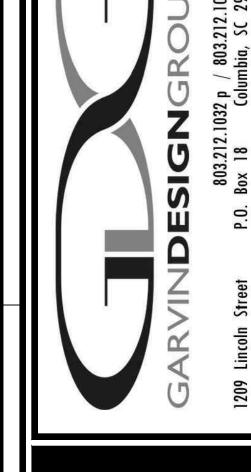

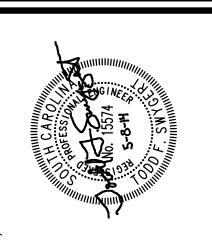FLOOR PLANS, DETAILS, NOTES, AND SCHEDULE

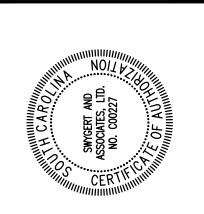DRAWING NO. M1.1
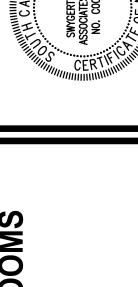
## DEMOLITION NOTES

- EXISTING WALL HUNG WATER CLOSET TO BE REMOVED COMPLETELY INCLUDING FLUSH VALVE AND CHAIR CARRIER. EXISTING WASTE, VENT, AND SUPPLY PIPING TO BE REUSED FOR NEW FIXTURE.
- EXISTING WALL HUNG URINAL TO BE REMOVED COMPLETELY INCLUDING FLUSH VALVE AND CHAIR CARRIER. EXISTING WASTE, VENT, AND SUPPLY PIPING TO BE REUSED FOR NEW FIXTURE.
- EXISTING WALL HUNG LAVATORY TO BE REMOVED COMPLETELY INCLUDING FAUCET, SUPPLY TUBING, AND P-TRAP. EXISTING WASTE, VENT, AND SUPPLY PIPING TO BE REUSED FOR NEW FIXTURE.
- EXISTING FLOOR DRAIN TO BE REMOVED. EXISTING WASTE PIPING TO BE REUSED FOR NEW FLOOR DRAIN.
- EXISTING HOSE BIBB TO BE REMOVED. EXISTING SUPPLY PIPING TO BE REUSED FOR NEW HOSE BIBB.

| PLUMBING FIXTURE SCHEDULE |                            |        |          |            |         |             |      |   |  |
|---------------------------|----------------------------|--------|----------|------------|---------|-------------|------|---|--|
|                           |                            |        |          |            |         | MIN. SUPPLY |      |   |  |
| P. NO.                    | FIXTURE                    | MFGR.  | NAME     | MFGRS. NO. | SIZE    | CW          | HW   | REMARKS   |  |
| P-1                       | WATER CLOSET               | KOHLER | KINGSTON | K-4325     |         | 1"          |      | WITH SLOAN MODEL 8111-1.28<br>BATTERY POWERED SENSOR<br>FLUSH VALVE, BENEKE 527<br>SEAT, AND CHAIR CARRIER.   |  |
| P-2                       | ACCESSIBLE<br>WATER CLOSET | KOHLER | KINGSTON | K-4330     |         | 1"          |      | WITH SLOAN MODEL 8111-1.28<br>BATTERY POWERED SENSOR<br>FLUSH VALVE, BENEKE 527<br>SEAT, AND CHAIR CARRIER.   |  |
| P-3                       | URINAL                     | KOHLER | DEXTER   | K-5016-ET  |         | 3/4"        |      | WITH SLOAN MODEL 8186-0.5<br>BATTERY POWERED SENSOR<br>FLUSH VALVE, AND CHAIR<br>CARRIER.   |  |
| P-4                       | LAVATORY                   | KOHLER | BANCROFT | K-2319     | 17"x14" | 3/8"        | 3/8" | UNDERCOUNTER MOUNTED WITH SLOAN MODEL EAF-250-ISM BATTERY POWERED SENSOR FAUCET, WATTS, OR APPROVED EQUAL, SERIES USG-B MIXING VALVE, McGUIRE 155WC OFFSET GRID DRAIN, McGUIRE H165 3/8' CAST BRASS SUPPLIES WITH STOPS, AND McGUIRE 8872 1-1/4" P-TRAP. MOUNT MIXING VALVE AS HIGH AS POSSIBLE UNDER COUNTERTOP. |  |
| FD                        | FLOOR DRAIN                | ZURN   |          | ZN-415-B   |         |             |      | WITH 5"Ø NICKLE BRONZE<br>STRAINER, P-TRAP, AND TRAP<br>GUARD BY PROSET, OR<br>APPROVED EQUAL.  |  |


NOTE: SEE ARCHITECTURAL DRAWINGS FOR MOUNTING HEIGHTS OF ALL WALL MOUNTED FIXTURES.

### GENERAL NOTES

- 1. ALL WORK SHALL BE PERFORMED ACCORDING TO ALL LOCAL, STATE, NATIONAL CODES, AND THE 2012 INTERNATIONAL PLUMBING CODE.
- 2. DO NOT SCALE DRAWINGS. SEE ARCHITECTURAL DRAWINGS FOR EXACT DIMENSIONS, FIXTURE LOCATIONS, ETC.
- EXCEPT WHERE PIPE SPACE IS PROVIDED OR UNLESS NOTED OTHERWISE, ALL SUPPLY, WASTE AND VENT RISERS SHALL BE RUN IN WALLS AND PARTITIONS.
- 4. COORDINATE CLOSELY WITH ALL WORK DONE UNDER OTHER DIVISIONS OF THE SPECIFICATIONS TO AVOID INTERFERENCE AND CONFLICT.
- 5. ALL PIPING INSULATION SHALL BE RUN CONTINUOUSLY.


### NOTES TO SHEET

- 1 INSTALL NEW WALL HUNG WATER CLOSET, FLUSH VALVE, AND CHAIR CARRIER AS SPECIFIED IN THE PLUMBING FIXTURE SCHEDULE AND WATER CLOSET SUPPLY DETAIL. RECONNECT TO EXISTING WASTE, VENT, AND SUPPLY PIPING. TRANSITION AS REQUIRED FOR NEW FIXTURE HEIGHTS.
- 2 INSTALL NEW WALL HUNG URINAL, FLUSH VALVE, AND CHAIR CARRIER AS SPECIFIED IN THE PLUMBING FIXTURE SCHEDULE AND TYPICAL URINAL SUPPORT DETAIL. RECONNECT TO EXISTING WASTE, VENT, AND SUPPLY PIPING. TRANSITION AS REQUIRED FOR NEW FIXTURE HEIGHTS.
- 3 INSTALL NEW COUNTERTOP LAVATORY, FAUCET, SUPPLIES WITH STOPS, AND P-TRAP AS SPECIFIED IN THE PLUMBING FIXTURE SCHEDULE. RECONNECT TO EXISTING WASTE, VENT, AND SUPPLY PIPING. TRANSITION AS REQUIRED.
- 4 INSTALL NEW FLOOR DRAIN AS SPECIFIED IN THE PLUMBING FIXTURE SCHEDULE. RECONNECT TO EXISTING WASTE LINE. TRANSITION AS REQUIRED.
- 5) INSTALL NEW WOODFORD, OR APPROVED EQUAL, MODEL 24 LOOSE KEY HOSE BIBB. RECONNECT TO EXISTING SUPPLY PIPING.

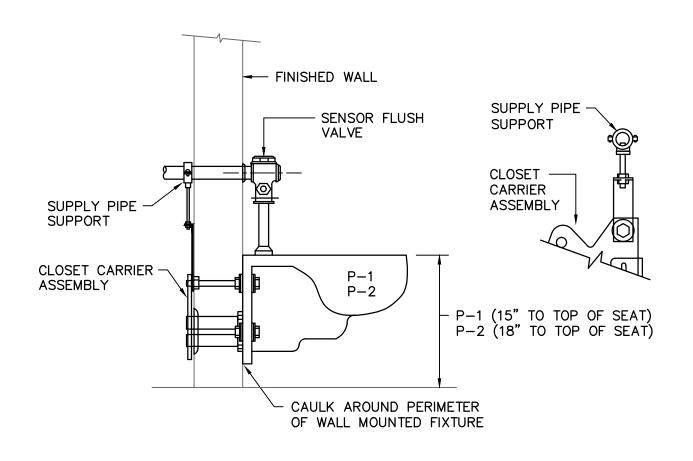


WATER CLOSET SUPPLY DETAIL

NO SCALE

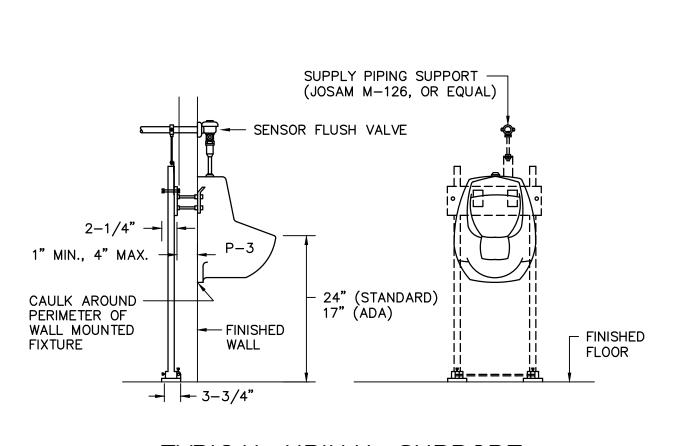


TYPICAL URINAL SUPPORT


NO SCALE

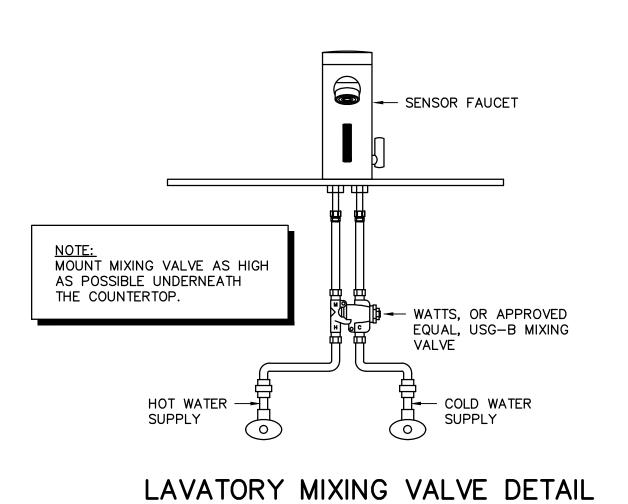

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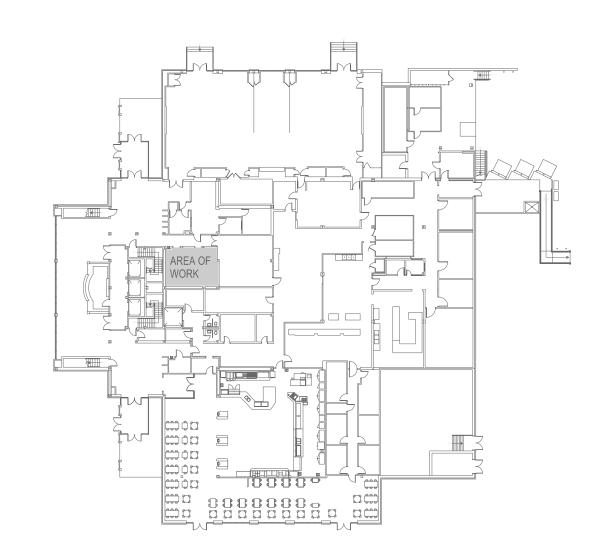


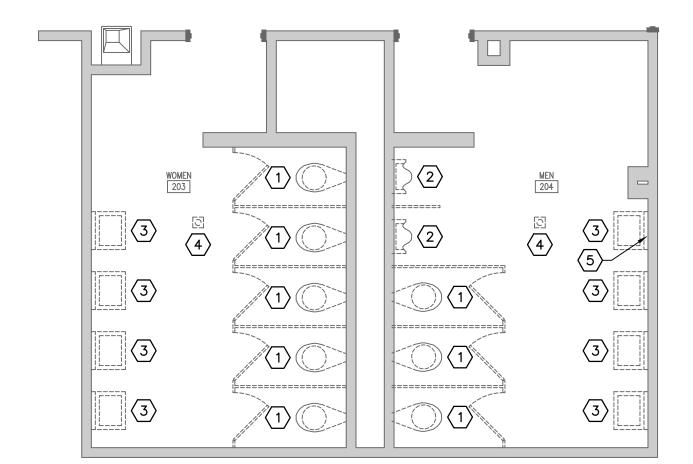

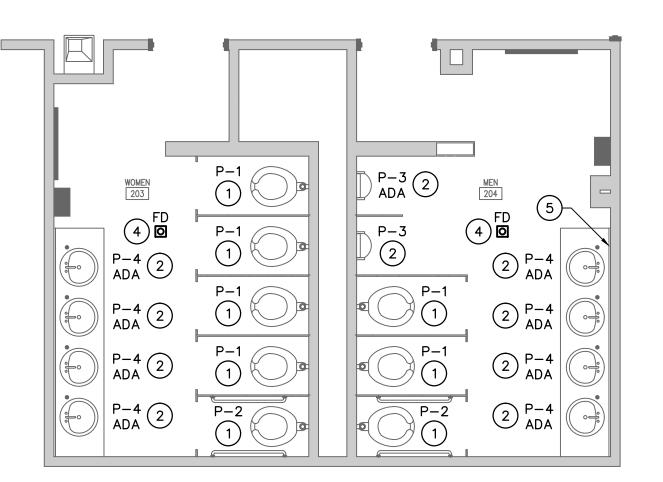

PARTIAL RENOVATION FLOOR PLAN

SCALE: 1/4" = 1'-0"



FIRST FLOOR KEY PLAN
NO SCALE


Swygert & Associates


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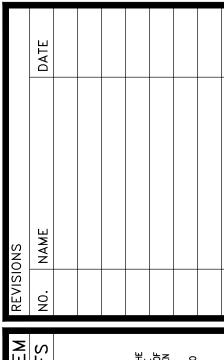
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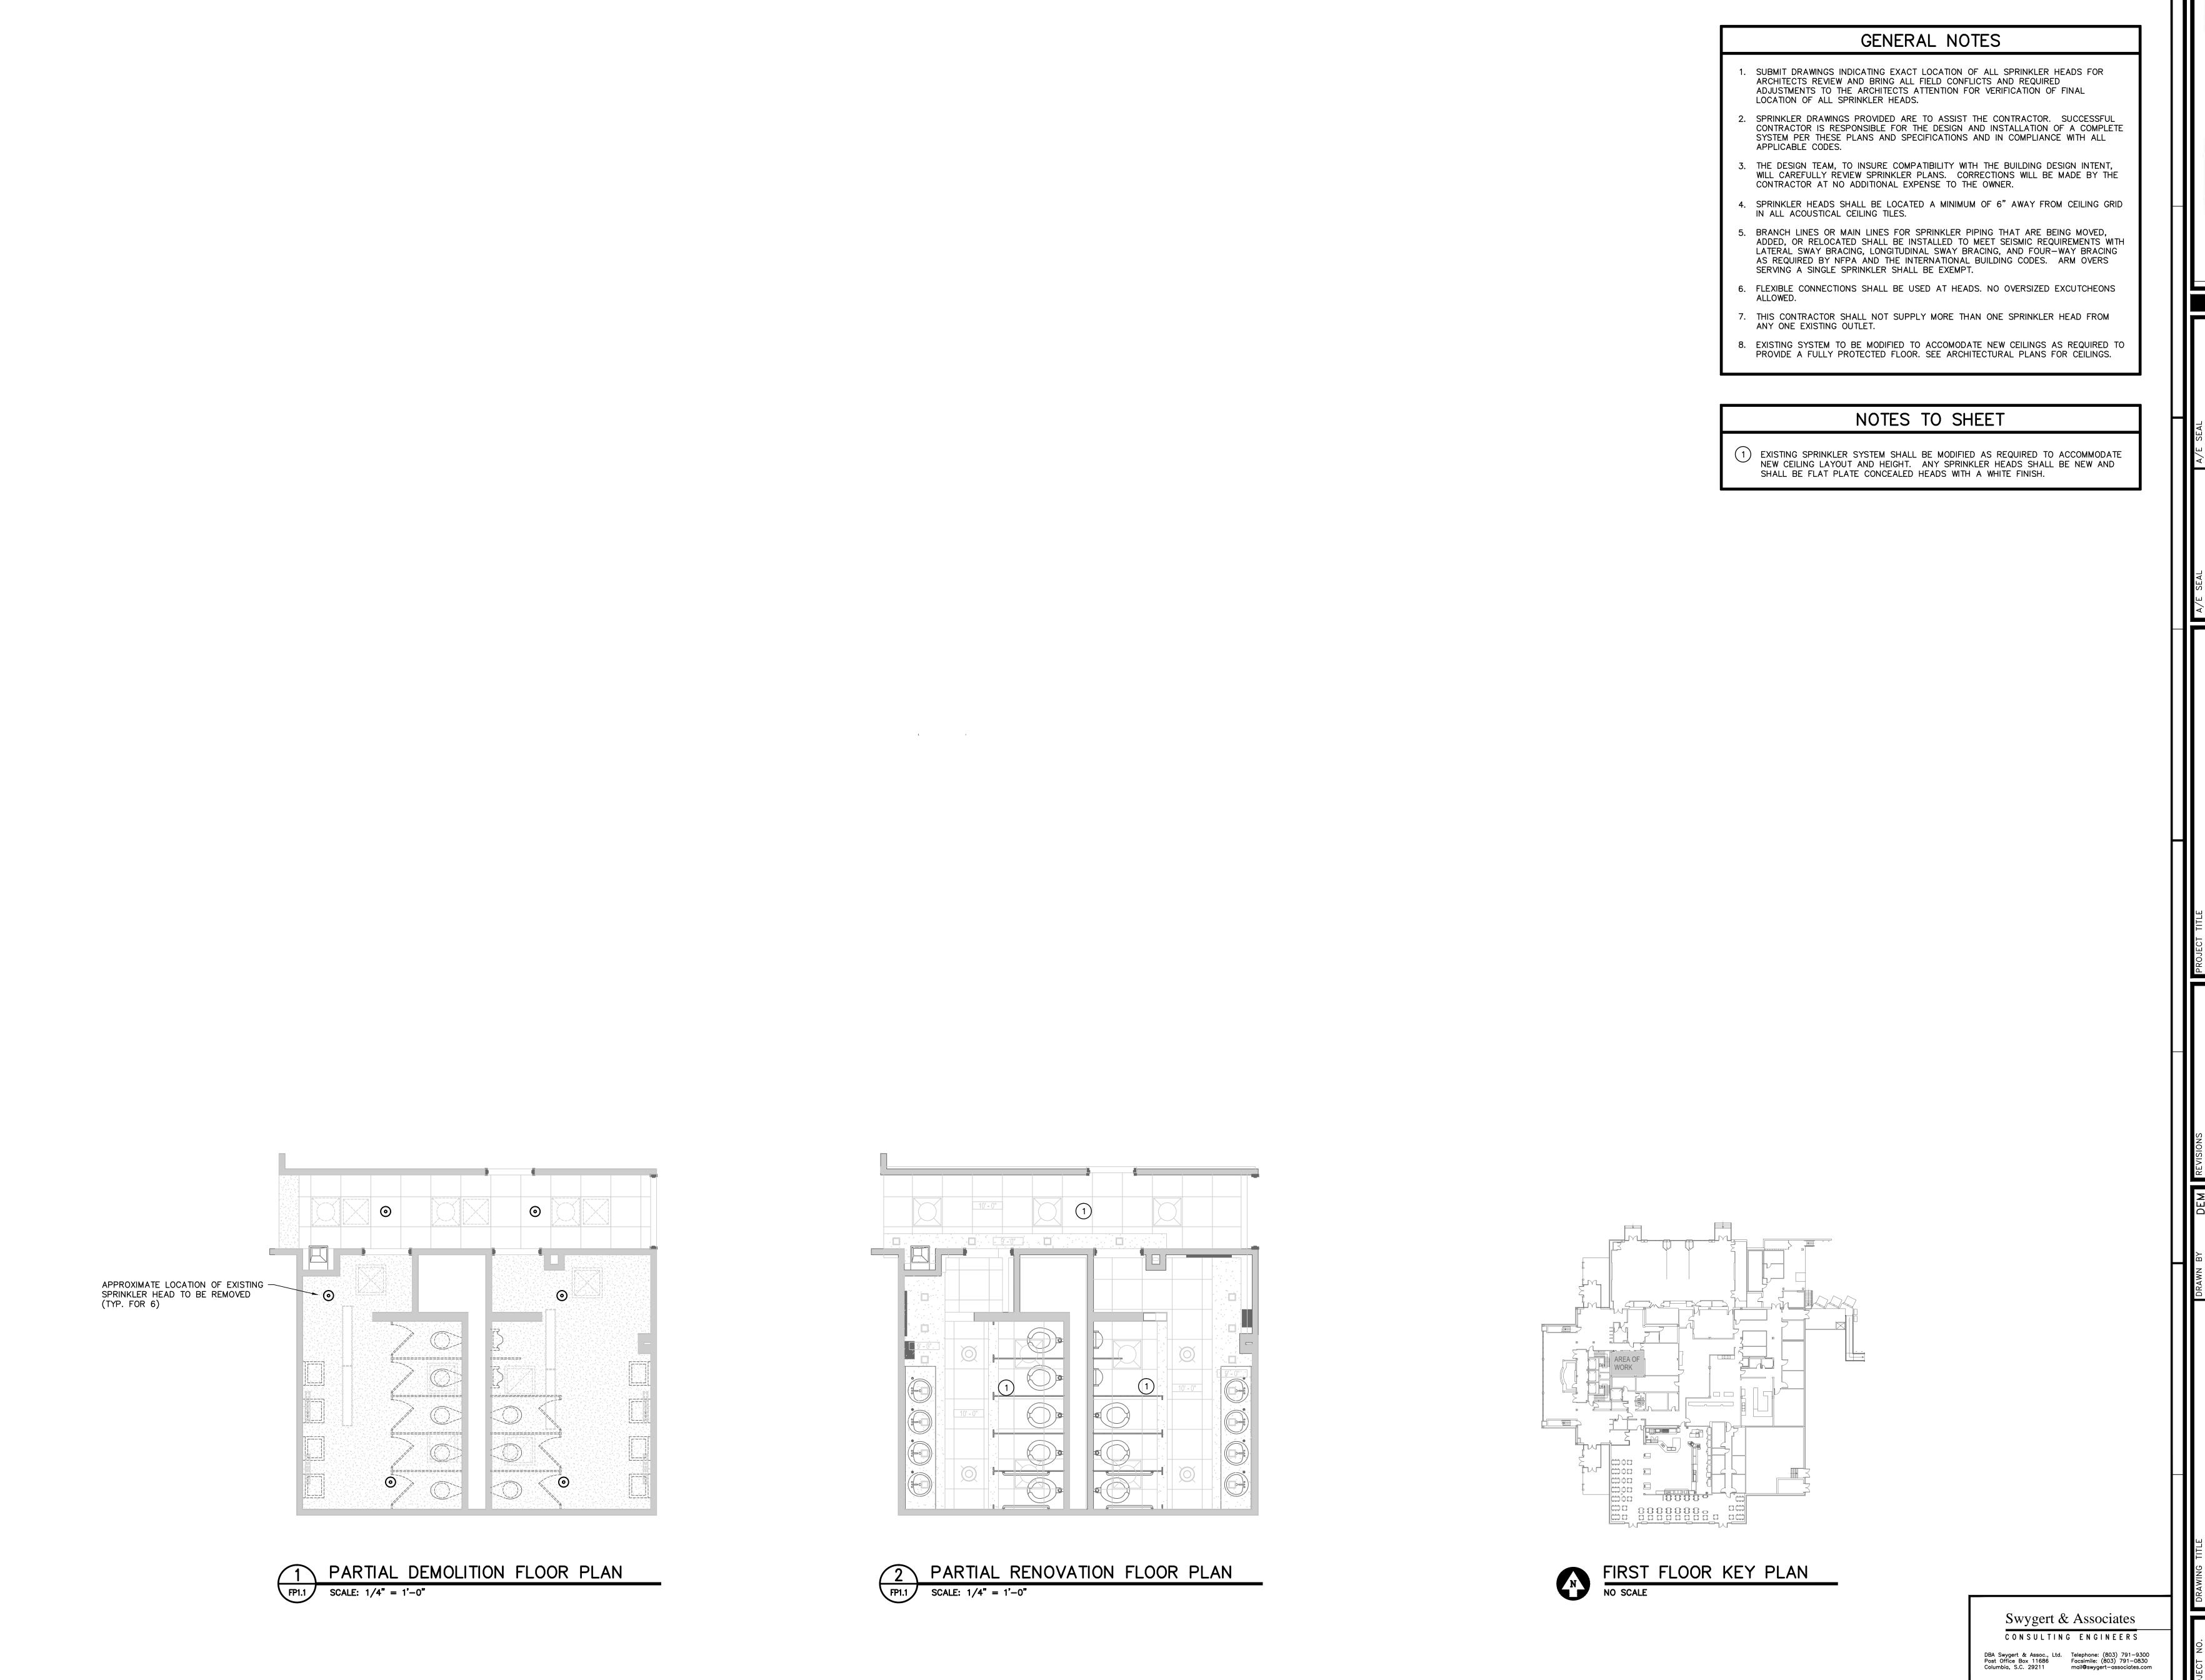
CAPSTONE LOBBY RESTRO







FLOOR PLANS, DETAILS, NOTES, AND SCHEDULE
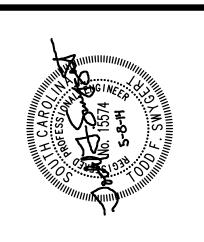
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O6.08.14
O6.08.14

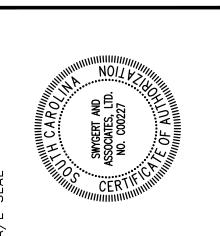

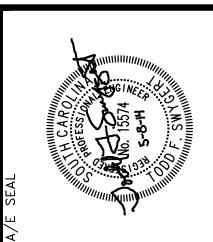


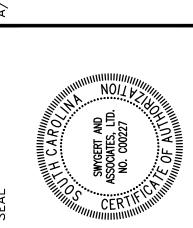

FLOOR PI NOTES

DRAWING NO.

FP1.1

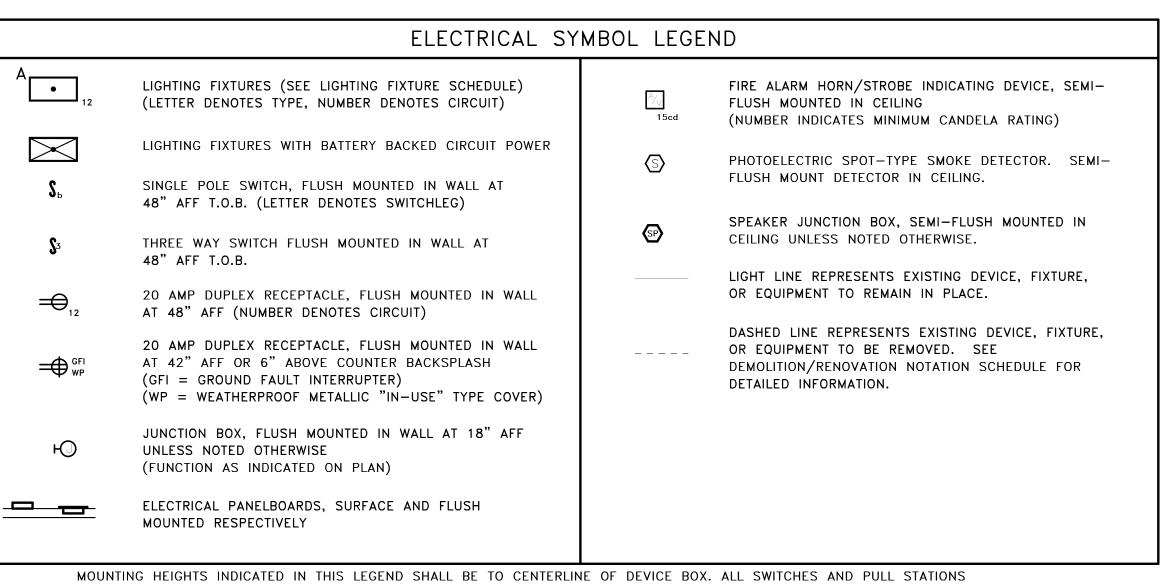

SHALL BE INSTALLED TO BE 48" AFF TO TOP OF BOX UNLESS NOTED OTHERWISE.

## GENERAL NOTES

- EXISTING BRANCH CIRCUITS LISTED WERE TAKEN FROM AS-BUILT DOCUMENTS AND HAVE NOT BEEN FIELD VERIFIED. CONTRACTOR SHALL FIELD VERIFY SOURCE OF BRANCH CIRCUITS PRIOR TO WORK.
- 2. ALL CIRCUITS SHALL BE 2#12, 1#12 GND. IN 3/4"C. UNLESS NOTED
- COMMUNICATIONS, SECURITY CAMERAS, AND ACCESS CONTROL SYSTEM RACEWAYS SHALL BE ROUTED FROM DEVICE LOCATIONS TO CONSOLIDATION JUNCTION BOX. SEE PLANS FOR DETAILS.
- 4. ALL WORK SHALL COMPLY WITH NFPA70.2011 (NATIONAL ELECTRIC
- ELECTRICAL LAYOUT DRAWINGS ARE DIGRAMMATIC. COORDINATE ALL WORK WITH ARCHITECTURAL, CIVIL, STRUCTURAL, AND MECHANICAL CONTRACT
- INSTALL THE ELECTRICAL SYSTEM WITHOUT INTERFERING WITH DUCTS, PIPES, STRUCTURAL STEEL, OR OTHER SYSTEMS.
- LOCATE LIGHTING FIXTURES SYMMETRICALLY IN THE PROPER RELATION TO FINISHED AREAS, EXCEPT WHERE DIMENSIONED ON DRAWINGS OR LOCATED ON REFLECTED CEILING PLANS.
- PROVIDE TWO #12 STEEL, SLACK CABLES TO STRUCTURE FROM EACH FIXTURE MOUNTED IN A GRID CEILING.
- 9. MOUNT GROUPED DEVICES IN A SINGLE CONTINUOUS MULTI-GANG BOX.
- 10. EMT FITTINGS SHALL BE OF THE COMPRESSION TYPE. SET SCREW OR INDENTOR TYPE FITTINGS SHALL NOT BE USED.
- 11. OUTLETS WHICH OCCUR ON OPPOSITE SIDES OF A COMMON WALL SHALL BE OFFSET A MINIMUM OF 12 INCHES.
- 12. WALL PENETRATIONS FOR RACEWAYS SHALL BE PROVIDED BY ELECTRICAL CONTRACTOR. PROVIDE FIRESTOPPING AROUND RACEWAYS PENETRATING RATED WALLS PER ARCHITECTURAL DRAWINGS. PROVIDE DRAFTSTOP SEAL AT NON-RATED WALLS.
- 13. EXISTING PLASTER CEILING SHALL REMAIN IN PLACE. EXTEND EXISTING LIGHTING BRANCH CIRCUITS AND FIRE ALARM SYSTEM CABLING FROM JUNCTION BOXES IN CEILING USING RACEWAY AND JUNCTION BOXES SURFACE MOUNTED TO EXISTING PLASTER CEILING.


|        |      |  | LIGHTI       | NG FIXTURE SCHED                                  | ULE                  |                        |         |                                    |
|--------|------|--|--------------|---|----------------------|------------------------|---------|------------------------------------|
|        | Туре |  |              |   | Optical              |                        |         |                                    |
| Symbol | Mark | Description  | Manufacturer | Model   | Element              | Mounting               | Voltage | Lamps                              |
|        | А    | 2'x2' LED ARCHITECTURAL GRID TROFFER               | CREE         | CR22-32L-35K                                      | DIFFUSED LENS        | GRID                   | 120 V   | LED (32W, 835, 3200 LUMENS)        |
| . 🖂    | AE   | SAME AS TYPE "A" EXCEPT WITH INTEGRAL BATTERY PACK | CREE         | CR22-32L-35K-EB14                                 | DIFFUSED LENS        | GRID                   | 120 V   | LED (32W, 835, 3200 LUMENS)        |
| o      | В    | FLUORESCENT DOWNLIGHT                              | INDY         | L4-08-30-U-G2<br>L400H-C-L-WH                     | NONE                 | CEILING                | 120 V   | LED (9W, 830, 670 LUMENS)          |
|        | BE   | LED DOWNLIGHT, WITH BATT. PACK                     | INDY         | L4-08-30-U-G2-BR<br>L400H-C-L-WH                  | NONE                 | CEILING                | 120 V   | LED (9W, 830, 670 LUMENS)          |
|        | С    | 8' LED RECESSED LINEAR SLOT TYPE<br>FIXTURE        | PINNACLE     | E2A-30-8'-SF-UNV-1C-W-L<br>G (FURNISHED BY OWNER) | .125 ACRYLIC<br>LENS | RECESSED IN<br>CEILING | 120 V   | LED (6.23W/FT, 830, 368 LUMENS/FT) |

#### GENERAL LIGHTING NOTES


- LIGHTING FIXTURE MANUFACTURERS LISTED ARE BASIS OF DESIGN. PRIOR APPROVED EQUAL IS DEFINED TO BE A MANUFACTURER CAPABLE OF PROVIDING A FIXTURE EQUAL TO THE BASIS OF DESIGN. BASIS OF DESIGN FIXTURES WERE SELECTED BASED ON A FAST LEAD TIMES TO MEET STRICT PROJECT SCHEDULE. ANY ALTERNATE FIXTURES MUST BE ABLE TO MAINTAIN PROJECT SCHEDULE. PRIOR APPROVED EQUAL MANUFACTURERS ARE AS LISTED BELOW:
- 1.1 TYPE A, AE: LITHONIA, COLUMBIA, DAY-BRITE, METALUX, JUNO, FINELITE, FOCALPOINT, AXIS. 1.2 TYPE B: KURT VERSEN, AMERLUX, GOTHAM, PATHWAY, LIGHTOLIER, PORTFOLIO
- 1.3 TYPE D: MARK ARCHITECTURAL LIGHTING, LEDALITE, ZUMTOBEL

ELECTRICAL ABBREVIATIONS


- LOCATE LIGHTING FIXTURES SYMMETRICALLY IN THE PROPER RELATION TO FINISHED AREAS, EXCEPT WHERE DIMENSIONED ON DRAWINGS OR LOCATED ON REFLECTED CEILING PLANS. COORDINATE LIGHTING FIXTURE LOCATIONS WITH EQUIPMENT IN EQUIPMENT ROOMS. NOTIFY A/E OF CONFLICTS PRIOR TO ANY ROUGH—IN INSTALLATION.
- LIGHTING FIXTURE CATALOG NUMBERS ARE INDICATIVE OF THE STYLE OF THE FIXTURE REQUIRED. CONTRACTOR SHALL PROVIDE FIXTURES WITH THE PROPER TRIM, VOLTAGE, AND OPTIONS NECESSARY FOR
- 4 PROVIDE TWO #12 STEEL, SLACK CABLES TO STRUCTURE (STUDS MOUNTED AT PLASTER CEILING) FROM EACH FIXTURE MOUNTED IN A GRID CEILING.

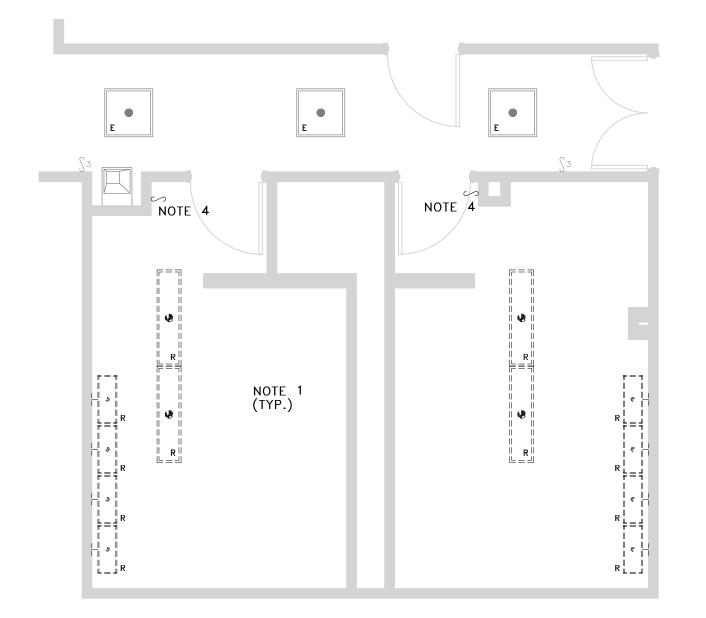

## FIRST FLOOR LIGHTING DEMOLITION PLAN E0.1 SCALE: 1/4" = 1'-0"

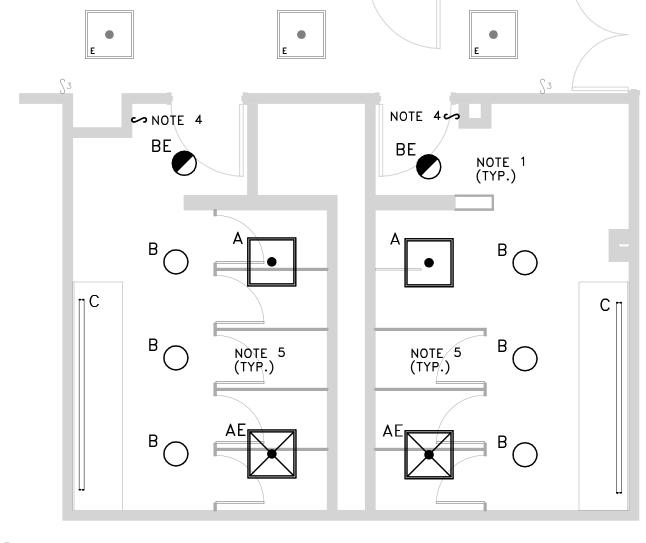


2 FIRST FLOOR LIGHTING RENOVATION PLAN E0.1 SCALE: 1/4" = 1'-0"

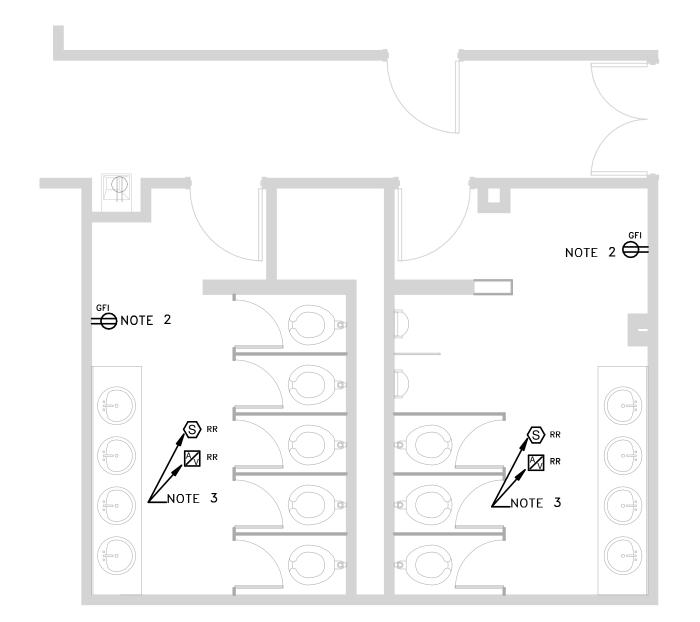

# 4 FIRST FLOOR POWER RENOVATION PLAN

## RENOVATION NOTES

- ALL LIGHTING FIXTURES SHALL BE SERVED FROM EXISTING LIGHTING BRANCH CIRCUIT. MODIFY AND EXTEND EXISTING BRANCH CIRCUIT TO FIXTURE LOCATIONS.
- PROVIDE A GFI TYPE RECEPTACLE IN PLACE OF EXISTING RECEPTACLE. PROVIDE A NEW STAINLESS
- RE-INSTALL EXISTING FIRE ALARM DEVICES ON NEW CEILING. MODIFY AND EXTEND EXISTING FIRE ALARM SYSTEM TO NEW DEVICE LOCATIONS. MAKE ALL REQUIRED CONNECTIONS AND TEST SYSTEM.
- PROVIDE A SINGLE-POLE SWITCH IN PLACE OF EXISTING DEVICE. PROVIDE A NEW STAINLESS STEEL WALLPLATE.
- SUPPORT ALL LIGHTING FIXTURES FROM STUDS MOUNTED AT EXISTING CEILING. COORDINATE WITH ARCHITECTURAL DRAWINGS.

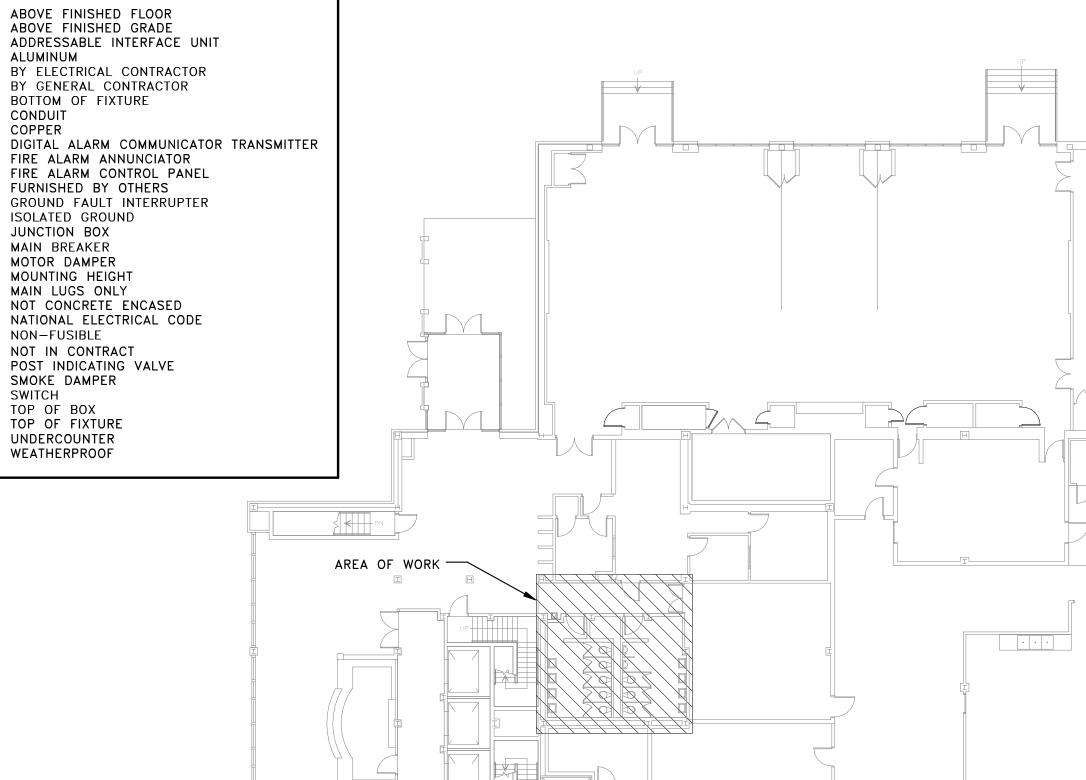

# DEMOLITION/RENOVATION NOTATION

- E EXISTING FIXTURE OR DEVICE TO REMAIN IN PLATES; COLOR TO MATCH EXISTING.
- R EXISTING FIXTURE OR DEVICE TO BE REMOVED BY THE ELECTRICAL CONTRACTOR, MAINTAIN CONTINUITY OF REMAINING PORTIONS OF BRANCH
- RE EXISTING DEVICE TO BE REMOVED BY THE ELECTRICAL CONTRACTOR. EXISTING CIRCUIT SHALL BE RETAINED. PROVIDE NEW DEVICE AS SHOWN ON RENOVATION PLANS.
- RR EXISTING FIXTURE TO BE RELOCATED BY THE ELECTRICAL CONTRACTOR TO NEW LOCATION
- RN RELOCATED FIXTURE (NEW LOCATION)

SHOWN ON RENOVATION PLAN.

CIRCUIT.



5 KEYPLAN

E0.1  $\int SCALE$ : 1/16" = 1'-0"

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ELECTRICAL DRAWING INDEX EO.1 ELECTRICAL PLANS

3 FIRST FLOOR POWER DEMOLITION PLAN

=(<del>)</del> NOTE 2

 $\setminus$  E0.1 / SCALE: 1/4" = 1'-0"

## DEMOLITION NOTES

- DISCONNECT AND REMOVE ALL LIGHTING FIXTURES IN RESTROOMS. EXISTING BRANCH CIRCUIT SHALL BE RE-USED IN RENOVATION PHASE. CONTRACTOR SHALL FIELD VERIFY SOURCE OF EXISTING BRANCH CIRCUIT PRIOR TO WORK.
- EXISTING RECEPTACLE SHALL BE REPLACED IN RENOVATION PHASE. DISCONNECT AND REMOVE DEVICE AND WALL PLATE AND PROTECT WIRING DURING DEMOLITION PHASE.
- EXISTING FIRE ALARM SYSTEM DEVICES SHALL BE RELOCATED IN RENOVATION PHASE. DISCONNECT DEVICES, REMOVE AND STORE IN A CLEAN AND DRY LOCATION. DEMOLISH ALL EXISTING EXPOSED RACEWAYS. PROTECT EXISTING WIRING DURING DEMOLITION PHASE.
- EXISTING SWITCH SHALL BE REPLACED IN RENOVATION PHASE. DISCONNECT AND REMOVE DEVICE AND WALL PLATE AND PROTECT WIRING DURING DEMOLITION PHASE.