





UPSTATE INFORMATION RESOURCE CENTER RENOVATIONS

STATE PROJECT NO.: H34-9517

150 GRAMLING DRIVE SPARTANBURG, SC 29303

DRAWING INDEX

DRAWING NO.	TITLE
T101	TITLE SHEET
D101 D102 A300 A301 A302 A501 A601 A602 A901 A902	FIRST FLOOR DEMOLITION PLAN SECOND FLOOR DEMOLITION PLAN BASEMENT FLOOR PLAN / REFLECTED CEILING PLAN FIRST FLOOR PLAN SECOND FLOOR PLAN FINISH SCHEDULE / DOOR SCHEDULE / DOOR & FRAME TYPES & DETAILS ALTERNATE NO. 1: STAIR DETAILS ALTERNATE NO. 2: CASEWORK ELEVATIONS & DETAILS FIRST FLOOR REFLECTED CEILING PLAN SECOND FLOOR REFLECTED CEILING PLAN
MD101 MD102 M100 M101 M102 M201	FIRST FLOOR DEMOLITION PLAN SECOND FLOOR DEMOLITION PLAN BASEMENT FLOOR PLAN FIRST FLOOR PLAN SECOND FLOOR PLAN DETAILS, NOTES, SCHEDULE & LEGEND
E001 E101 E102 E201 E202	ELECTRICAL SYMBOLS AND NOTES FIRST FLOOR LIGHTING PLAN SECOND FLOOR LIGHTING PLAN BASEMENT POWER PLAN FIRST FLOOR POWER PLAN

ABBREVIATIONS

E601

ELEC EQ EXIST EXP EXT FD FE FF FLR FLOUR FTG GALV GB	CONCRETE CONSTRUCTION CONTINUOUS CARPET CLASSROOM DOUBLE DEEP SHELVES DETAIL DIMENSION ELEVATION EACH EXPANSION JOINT ELECTRICAL EQUAL EXISTING EXPANSION EXTERIOR FLOOR DRAIN FIRE EXTINGUISHER FINISH FLOOR FLOURESCENT FIXTURE FOOTING GALVANIZED GRAB BAR	PL LAM PL PLUMB PR PT RD REINF REQ'D SCHED SEC SHT SIM SS STL SWC TB TEMP TOIL TRTD TYP UL	MANUFACTURER MIRROR MASONRY OPENING METAL NOSING NOT IN CONTRACT ON CENTER OUTSIDE DIAMETER OPENING PLASTIC LAMINATE PLATE PLUMBING PAIR PAINT ROOF DRAIN REINFORCE (D) (ING) REQUIRED SCHEDULE SECTION SHEET SIMILAR STAINLESS STEEL STEEL SOLID WOOD CORE TACK BOARD TEMPERED TOILET TREATED TYPICAL UNDERWRITER'S LABORATORY
GB	GRAB BAR	UL	UNDERWRITER'S LABORATORY
GC GL	GENERAL CONTRACTOR GLASS	U.N.O. VCT	UNLESS NOTED OTHERWISE
GWB	GYPSUM WALL BOARD	VER	VERIFY
HM	HOLLOW METAL	VERT	VERTICAL VERIFY IN FIELD
HORIZ ID	HORIZONTAL INSIDE DIAMETER	V.I.F. VW	VERIFY IN FIELD VIEW WINDOW
INSUL	INSIDE DIAMETER INSULATION	W/	WITH
	INTERIOR		WITHOUT


SECOND FLOOR POWER PLAN

PARTIAL POWER RISER DIAGRAM & SCHEDULES


GENERAL NOTES

- 1. THE TERM "WORK" AS USED IN THESE NOTES SHALL INCLUDE ALL PROVISIONS AS DRAWN OR SPECIFIED IN THESE DOCUMENTS AS WELL AS ALL OTHER
- SCOPE OF WORK: THE CONTRACTOR SHALL INCLUDE AND PROVIDE ALL LABOR, MATERIALS, EQUIPMENT, TRANSPORTATION, AND PAY ALL EXPENSES
- 5. IF THE CONTRACT DOCUMENTS ARE FOUND TO BE UNCLEAR, AMBIGUOUS OR CONTRADICTORY, THE CONTRACTOR MUST REQUEST CLARIFICATION
- 6. IF A CONDITION EXISTS THAT REQUIRES OBSERVATION OR ACTION BY THE ARCHITECT, OR OTHER DESIGN PROFESSIONAL, THE CONTRACTOR SHALL
- 7. CONTRACTOR SHALL BE FAMILIAR WITH PROVISIONS OF ALL APPLICABLE CODES AND SHALL ENSURE THE COMPLIANCE OF THE WORK WITH ALL LOCAL STATE AND FEDERAL CODES, TRADE STANDARDS AND MANUFACTURER'S RECOMMENDATIONS. IN THE EVENT OF CONFLICT BETWEEN LOCAL, STATE FULL COMPLIANCE WITH CODES, CONTRACTOR SHALL NOTIFY ARCHITECT
- 8. THESE DOCUMENTS DO NOT INCLUDE THE NECESSARY COMPONENTS FOR CONSTRUCTION SAFETY. SAFETY, COMPLIANCE WITH STATE AND FEDERAL REGULATIONS REGARDING SAFETY AND COMPLIANCE WITH REQUIREMENTS SPECIFIED IN THE OWNER/CONTRACTOR CONTRACT IS, AND SHALL BE, THE
- 9. CONTRACTOR SHALL PAY ALL TAXES, SECURE ALL PERMITS AND PAY ALL FEES INCURRED IN THE COMPLETION OF THE PROJECT.
- 10. THE CONTRACTOR SHALL UNCONDITIONALLY WARRANTY ALL MATERIALS, AND WORKMANSHIP FURNISHED OR INSTALLED BY HIM OR HIS SUBCONTRACTORS FOR A PERIOD OF ONE (1) YEAR FROM DATE OF ACCEPTANCE AND SHALL REPLACE ANY DEFECTIVE WORK WITHIN THAT PERIOD WITHOUT EXPENSE TO THE OWNER AND PAY FOR ALL DAMAGES TO OTHER PARTS OF THE BUILDING RESULTING FROM DEFECTIVE WORK OR ITS REPAIR. THE CONTRACTOR SHALL REPLACE DEFECTIVE WORK WITHIN A REASONABLE, AGREED UPON TIME FRAME, AFTER IT IS BROUGHT TO HIS ATTENTION.
- 11. THE CONTRACTOR SHALL AT ALL TIMES KEEP THE PREMISES FREE FROM ACCUMULATION OF WASTE MATERIALS AND RUBBISH AND AT THE COMPLETION OF THE WORK THE CONTRACTOR SHALL REMOVE ALL RUBBISH, IMPLEMENTS, AND SURPLUS MATERIALS AND LEAVE THE BUILDING IN NEW AND CLEAN
- 12. CONTRACTOR IS TO PROVIDE TO THE OWNER A LIST OF ALL SUBCONTRACTORS USED, COMPLETE WITH ADDRESSES, PHONE NUMBERS AND COPIES OF ALL WARRANTIES AND OPERATIONS AND MAINTENANCE MANUALS.
- 13. CONTRACTOR SHALL PROTECT ALL EXISTING FINISHES AND OWNER FURNISHINGS DURING CONSTRUCTION AND DEMOLITION ACTIVITIES. OWNER WILL MOVE FURNITURE, FURNISHINGS, ETC. AS NEEDED FROM IMMEDIATE CONSTRUCTION ZONES, BUT NOT ALL OF THESE ITEMS WILL BE REMOVED FROM THE PREMISES. ANY ITEMS DAMAGED BY THE CONTRACTOR SHALL BE REPLACED BY THE CONTRACTOR. TOUCH UP DAMAGED PAINT AS REQUIRED.
- 14. ALL WORK SHOWN SHALL BE INCLUDED IN BASE BID, UNLESS SPECFICIALLY DESIGNATED AS AN ALTERNATE. FOR WORK DESIGNATED AS AN ALTERNATE, BASE BID SHALL BE EXISTING CONDITION TO REMAIN.
- 15. A NEW SPRINKLER SYSTEM INSTALLATION FOR THE ENTIRE BUILDING (UNDER SEPARATE CONTRACT) WILL OCCUR IN CONJUNCTION WITH THE SCOPE OF THIS PROJECT. COORDINATE WORK WITH SEPARATE CONTRACT TO FACILITATE INSTALLATION OF NEW WORK AND AVOID SCHEDULING CONFLICTS

DRAWING SYMBOL LEGEND

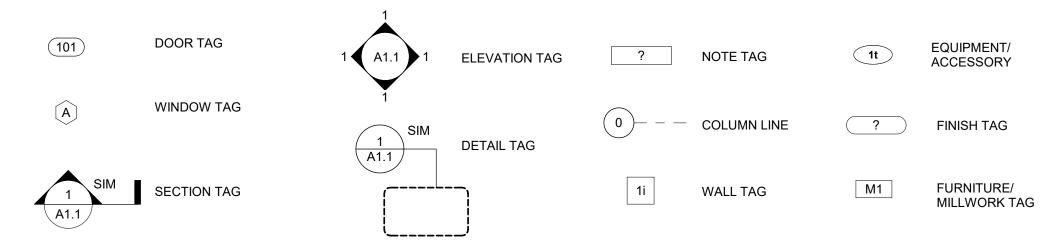

VICINITY MAP

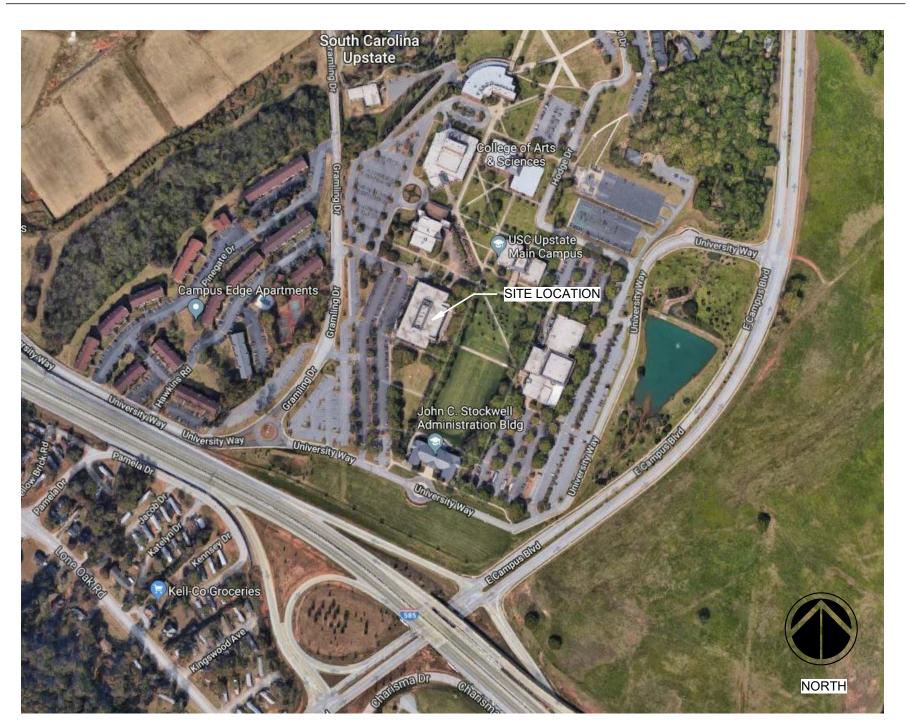

BUILDING CODE ANALYSIS SUMMARY

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Construction Classification: TYPE IIB
Occupancy Classification(s): B (Business)
                           A-2 (Cafeterias)
                           A-3 (Libraries)
    Non-separated Mixed Use
   Most Restrictive Occupancy Classification: A-2
Allowable Area per Story by Table (Sprinklered):
   Basement: 28,500 SF
    First Floor: 28,500 SF
    Frontage increase required:
   If = [F/P - 0.25] W/30
   If = [720/720 - 0.25] 30/30
   Allowable Area per Story (Aa) = [At + (NS x If)]
   Aa = [28,500 + (9,500 \times 0.75)] = 35,625
Area as Designed per Story:
   Basement: 6,682 SF
   First Floor: 29,310 SF
    Second Floor: 29,780 SF
Allowable Height in Feet:
Allowable Height in Stories:
Height as Designed in Feet:
Height as Designed in Stories: 3
Fire Resistance Ratings (TYPE IIB)
   Primary Structural Frame: 0 hour
    Bearing Walls (Exterior): 0 hour
    Bearing Walls (Interior): 0 hour
    Nonbearing Walls (Exterior): 0 hour
    Nonbearing Walls (Interior): 0 hour
    Floor Construction:
   Roof Construction:
   Fire Walls:
   Fire Barriers (Stairs):
    Shaft Enclosures:
   Fire Partitions:
Exit Access Travel Distance: 250' maximum
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Project: USC Upstate Library Modifications Code & Edition: 2018 IBC, 2017 ICC A117.1

PROJECT CONTACTS

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LAVATORY

OWNER	
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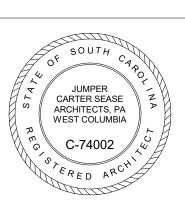
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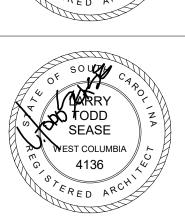
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DRAWN BY: CHECKED BY: COMM NO: 12/4/2020

SHEET NO:

TITLE SHEET

1 FIRST FLOOR DEMOLITION PLAN

DEMOLITION PLAN LEGEND

EXISTING WALL TO REMAIN

= = = EXISTING ITEM TO BE DEMOLISHED

DEMOLITION GENERAL NOTES

- 1. ALL HAZARDOUS MATERIALS SHALL BE REMOVED PRIOR TO
- 2. ALL MATERIALS THAT HAVE BEEN DEMOLISHED SHALL BE REMOVED IMMEDIATELY AND DISPOSED OF PROPERLY. NO DEMOLISHED MATERIALS SHALL BE STOCKPILED ON SITE.
- 3. PROTECT OWNER'S PROPERTY AND PERSONS AT ALL TIMES.
- 4. ANY ITEMS NOT SHOWN TO BE DEMOLISHED THAT ARE DAMAGED SHALL BE REPAIRED OR REPLACED BY THE CONTRACTOR.
- REQUIRED WITH THE OWNER.
- CONTRACTOR SHALL ASCERTAIN FROM THE OWNER WHETHER OR NOT THE OWNER WISHES TO RETAIN ANY ITEMS. ANY SUCH ITEMS SHALL BE REMOVED WITH CARE SO AS TO PREVENT UNNECESSARY DAMAGE AND TURNED OVER TO THE OWNER.
- 7. THE CONTRACTOR SHALL CONTROL AND LIMIT DUST RESULTING FROM DEMOLITION AND PREVENT THE SPREAD OF DUST TO THE
- 9. EXPLOSIVES WILL NOT BE PERMITTED UNLESS SPECIFICALLY APPROVED.
- DISRUPTED BY ANY DEMOLITION.
- ADDITIONAL DEMOLITION REQUIREMENTS.
- 12. PROVIDE NEW PANELBOARD DIRECTORY CARD IN EXISTING PANELBOARDS AS REQUIRED AFTER DEMOLITION/REWORKING OF EXISTING CIRCUITS.
- 13 DEMOLITION INCLUDES REMOVAL OF ALL ITEMS NECESSARY TO FACILITATE THE NEW CONSTRUCTION, WHETHER SPECIFICALLY INDICATED OR NOT, UNLESS NOTED OTHERWISE.
- 14. ALL FINISHES TO REMAIN THAT ARE DISTURBED SHALL BE REPAIRED TO MATCH EXISTING. TOUCH UP DAMAGED PAINT AS REQUIRED.

PLAN NORTH

- 15. CONTRACTOR SHALL MARK WALLS ABOVE CEILINGS AS REQUIRED THE LOCATIONS OF EXISTING GRID PRIOR TO REMOVAL TO FACILITATE NEW CEILING GRID ALIGNMENT AND REINSTALLATION OF EXISTING LIGHT FIXTURES IN SAME
- 16. REMOVE ALL EXISTING LAY-IN CEILINGS THROUGHOUT (LAY-IN CEILINGS ARE PRESENT IN ALL SPACES U.N.O.). REMOVE EXISTING GWB CEILINGS WHERE INDICATED ON CEILING AND DEMOLITION PLANS. ALL CEILING FIXTURES (LIGHTING, MECHANICAL, ETC.) SHALL BE TEMPORARILY HUNG AND REINSTALLED IN NEW CEILINGS UNLESS NOTED OTHERWISE.

- START OF CONSTRUCTION UNDER SEPARATE CONTRACT.
- 5. COORDINATE ANY SYSTEMS SHUTDOWNS WHICH MAY BE

6. PRIOR TO COMMENCING WITH THE DEMOLITION, THE

- REMAINING BUILDING. 8. BURNING ON THE SITE WILL NOT BE PERMITTED.
- 10. CONTRACTOR SHALL MAKE FUNCTIONAL ALL CIRCUITS
- 11. REFER TO MECHANICAL AND ELECTRICAL DRAWINGS FOR
- LOCATIONS.

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PLAN


12/4/2020

FIRST FLOOR

DEMOLITION

COMM NO:

DATE:

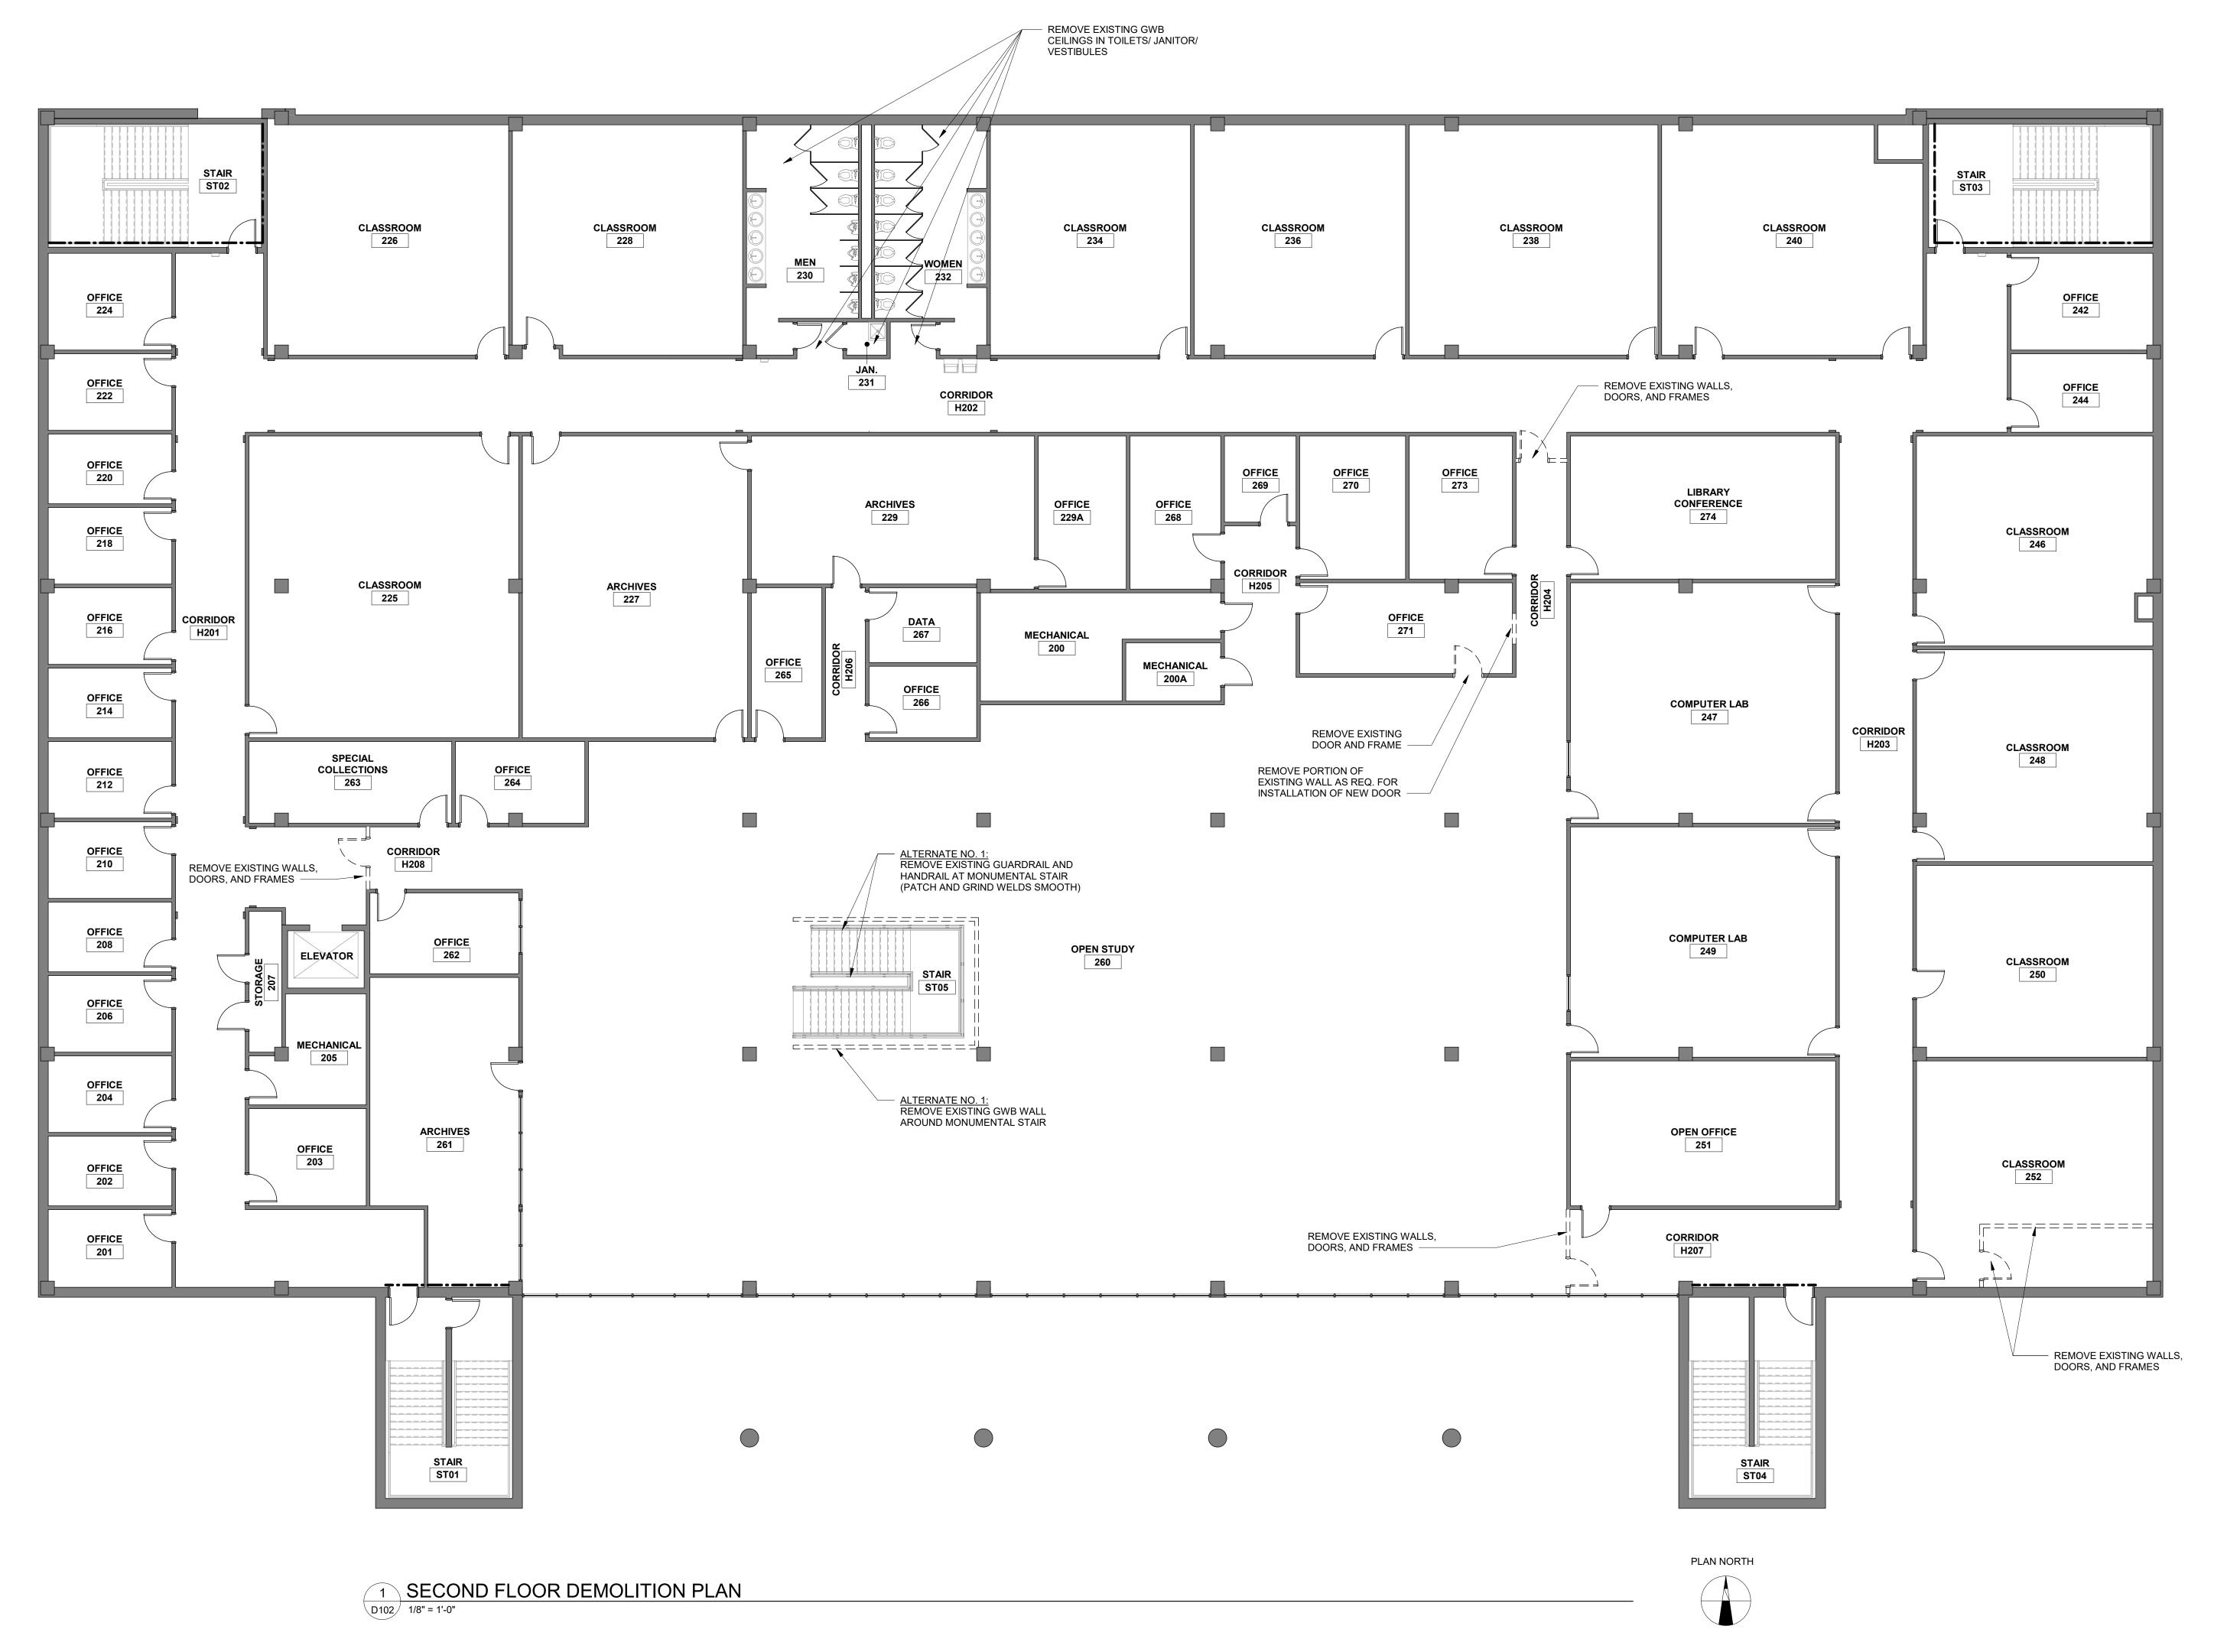


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29303

RESOURCE (FIONS ARTANBURG, NO.: H34-9517

DEMOLITION PLAN LEGEND

DEMOLITION GENERAL NOTES

EXISTING WALL TO REMAIN

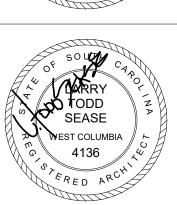= = = = EXISTING ITEM TO BE DEMOLISHED

- ALL HAZARDOUS MATERIALS SHALL BE REMOVED PRIOR TO
- START OF CONSTRUCTION UNDER SEPARATE CONTRACT. ALL MATERIALS THAT HAVE BEEN DEMOLISHED SHALL BE REMOVED IMMEDIATELY AND DISPOSED OF PROPERLY. NO DEMOLISHED MATERIALS SHALL BE STOCKPILED ON SITE.
- 3. PROTECT OWNER'S PROPERTY AND PERSONS AT ALL TIMES.

CONTRACTOR SHALL ASCERTAIN FROM THE OWNER WHETHER


- ANY ITEMS NOT SHOWN TO BE DEMOLISHED THAT ARE DAMAGED SHALL BE REPAIRED OR REPLACED BY THE CONTRACTOR.
- 5. COORDINATE ANY SYSTEMS SHUTDOWNS WHICH MAY BE REQUIRED WITH THE OWNER. PRIOR TO COMMENCING WITH THE DEMOLITION, THE
- OR NOT THE OWNER WISHES TO RETAIN ANY ITEMS. ANY SUCH ITEMS SHALL BE REMOVED WITH CARE SO AS TO PREVENT UNNECESSARY DAMAGE AND TURNED OVER TO THE OWNER. THE CONTRACTOR SHALL CONTROL AND LIMIT DUST RESULTING
- FROM DEMOLITION AND PREVENT THE SPREAD OF DUST TO THE REMAINING BUILDING. 8. BURNING ON THE SITE WILL NOT BE PERMITTED.
- 9. EXPLOSIVES WILL NOT BE PERMITTED UNLESS SPECIFICALLY APPROVED.
- 10. CONTRACTOR SHALL MAKE FUNCTIONAL ALL CIRCUITS DISRUPTED BY ANY DEMOLITION.
- 11. REFER TO MECHANICAL AND ELECTRICAL DRAWINGS FOR ADDITIONAL DEMOLITION REQUIREMENTS.
- 12. PROVIDE NEW PANELBOARD DIRECTORY CARD IN EXISTING PANELBOARDS AS REQUIRED AFTER DEMOLITION/REWORKING OF EXISTING CIRCUITS.
- 13. DEMOLITION INCLUDES REMOVAL OF ALL ITEMS NECESSARY TO FACILITATE THE NEW CONSTRUCTION, WHETHER SPECIFICALLY INDICATED OR NOT, UNLESS NOTED OTHERWISE.
- 14. ALL FINISHES TO REMAIN THAT ARE DISTURBED SHALL BE REPAIRED TO MATCH EXISTING. TOUCH UP DAMAGED PAINT AS REQUIRED.
- 15. CONTRACTOR SHALL MARK WALLS ABOVE CEILINGS AS REQUIRED THE LOCATIONS OF EXISTING GRID PRIOR TO REMOVAL TO FACILITATE NEW CEILING GRID ALIGNMENT AND REINSTALLATION OF EXISTING LIGHT FIXTURES IN SAME LOCATIONS.
- 16. REMOVE ALL EXISTING LAY-IN CEILINGS THROUGHOUT (LAY-IN CEILINGS ARE PRESENT IN ALL SPACES U.N.O.). REMOVE EXISTING GWB CEILINGS WHERE INDICATED ON CEILING AND DEMOLITION PLANS. ALL CEILING FIXTURES (LIGHTING, MECHANICAL, ETC.) SHALL BE TEMPORARILY HUNG AND REINSTALLED IN NEW CEILINGS UNLESS NOTED OTHERWISE.

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12/4/2020 SHEET TITLE: SECOND **FLOOR**

DEMOLITION PLAN



2 BASEMENT REFLECTED CEILING PLAN A300 1/8" = 1'-0"

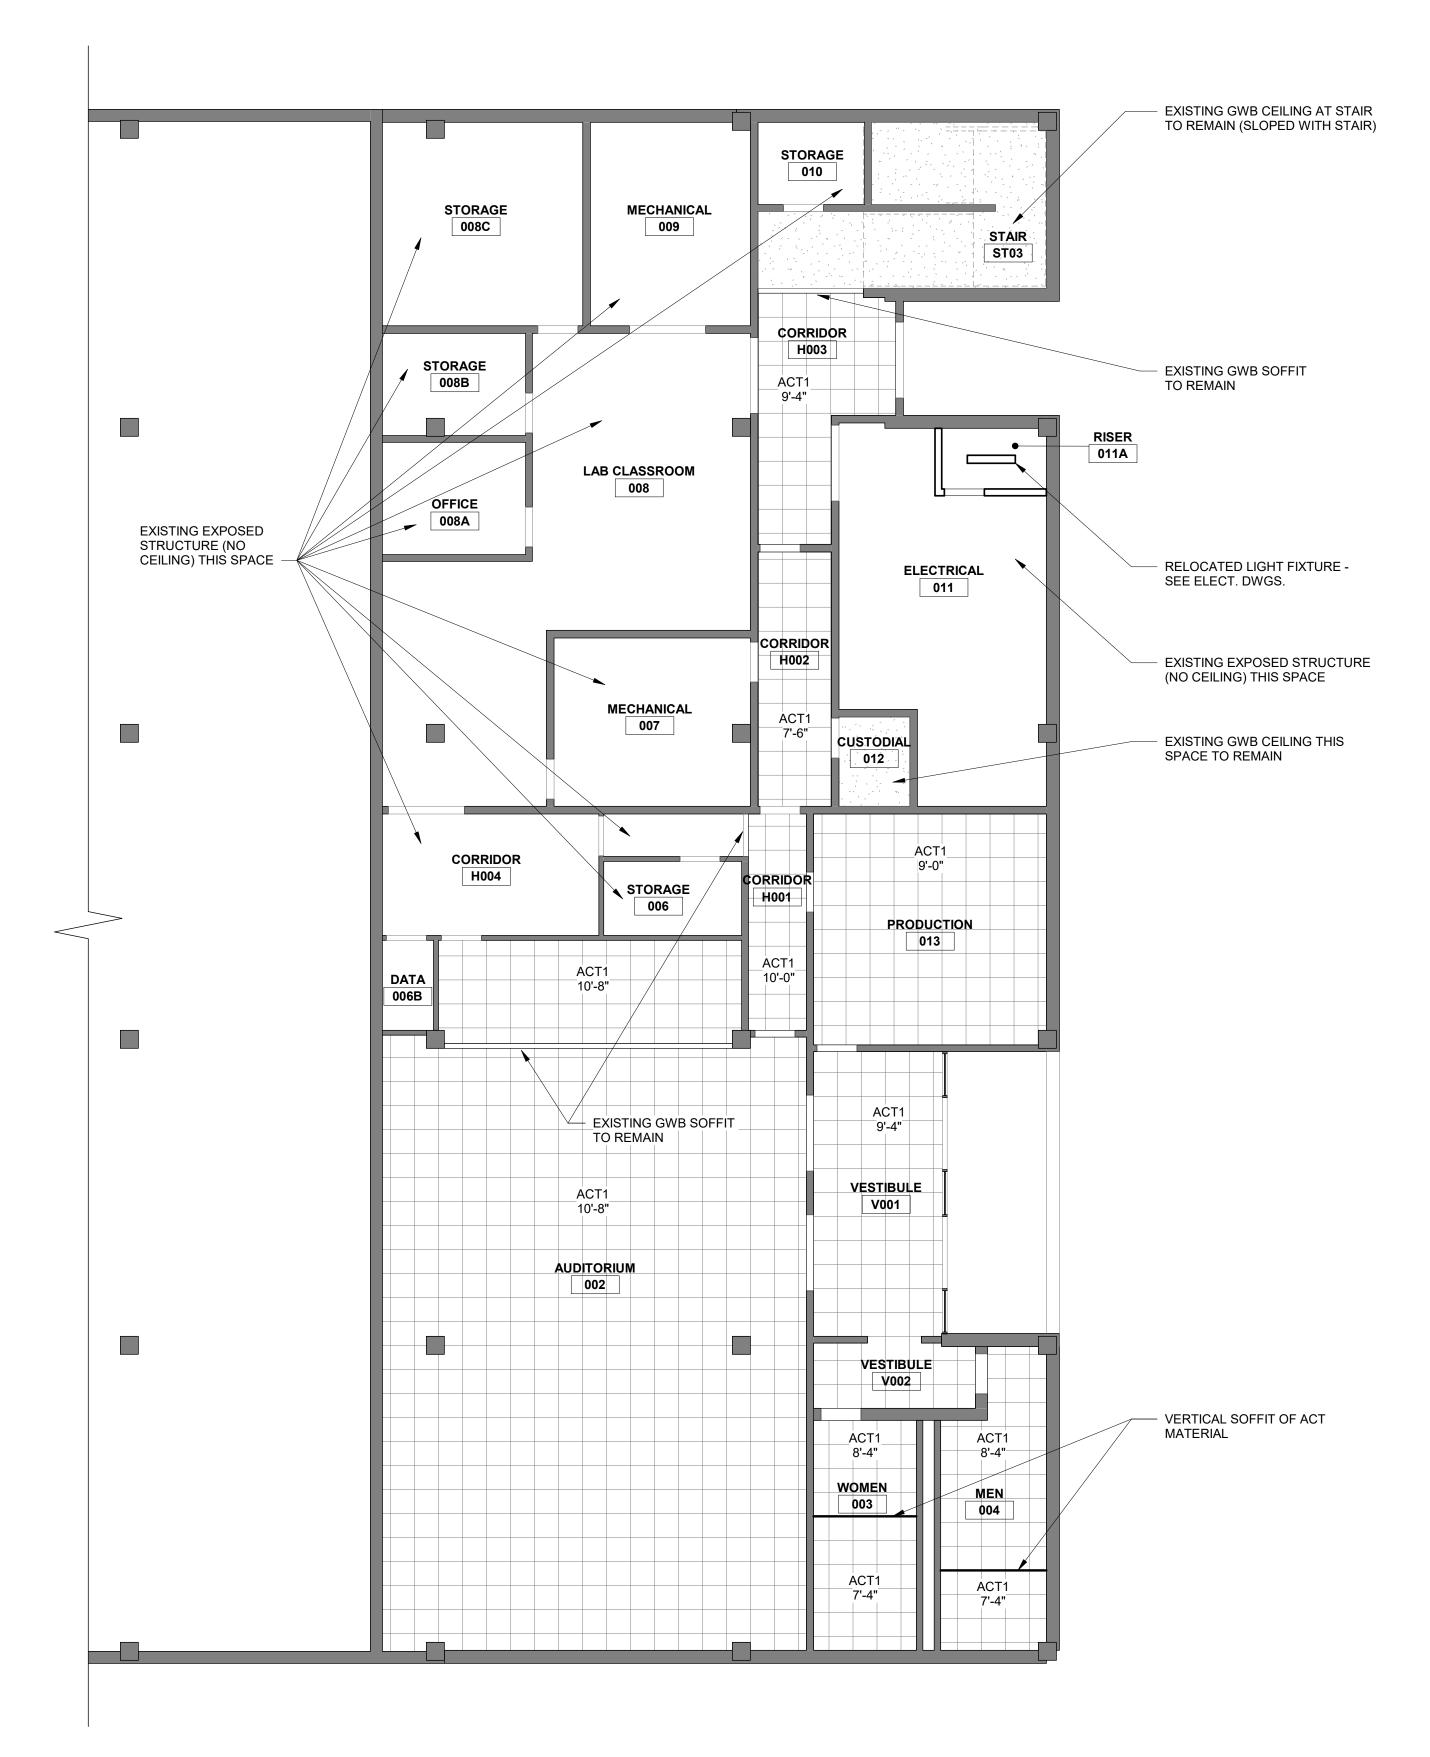CEILING PLAN LEGEND

(9'-4" A.F.F. U.N.O.)


NEW 2'X2' ACOUSTICAL TILE CEILING SYSTEM
(TILE AND GRID) TO MATCH EXISTING SYSTEM


NEW GWB SOFFIT / BULKHEAD PER DETAIL

INSTALLED IN 1ST FLOOR LIBRARY SPACE

CEILING PLAN GENERAL NOTES

- SPACES U.N.O.). REMOVE EXISTING GWB CEILINGS WHERE INDICATED ON CEILING AND DEMOLITION PLANS. ALL CEILING UNLESS NOTED OTHERWISE.
- 3. ALL NEW CEILING HEIGHTS SHALL MATCH EXISTING HEIGHTS U.N.O. LIGHTS, SMOKE DETECTORS, FIRE ALARM DEVICES, ETC. FOR ITEMS NOT INDICATED ON THE REFLECTED CEILING PLAN, COORDINATE LOCATIONS WITH THE ARCHITECT PRIOR TO
- . IF AS-BUILT CONDITIONS DEMAND THAT A CEILING BOARD LARGER THAN 2'-0" IN ANY DIMENSION BE USED IN THE PERIMETER BOARDS OF A TYPICAL 2'X2' GRID, THEN THAT BOARD SHALL BE CUT FROM A 2'X4' BOARD. A DOUBLE WALL ANGLE SHALL NOT BE USED IN THE CEILING GRID SYSTEM.
- CEILING SUSPENSION SYSTEM TO MEET SEISMIC REQUIREMENTS OF THE INTERNATIONAL BUILDING CODE CURRENT EDITION, AS WELL AS MANUFACTURER'S ESR REPORT, FOR SEISMIC DESIGN
- LOCATE ALL RECESSED FIXTURES AT THE CENTERLINE OF TILE UNLESS NOTED OTHERWISE. INSTALL ALL ELECTRICAL SYSTEM OR AS INDICATED ON THE REFLECTED CEILING PLANS. SEE ELECTRICAL DWGS. FOR FIXTURE TYPES.

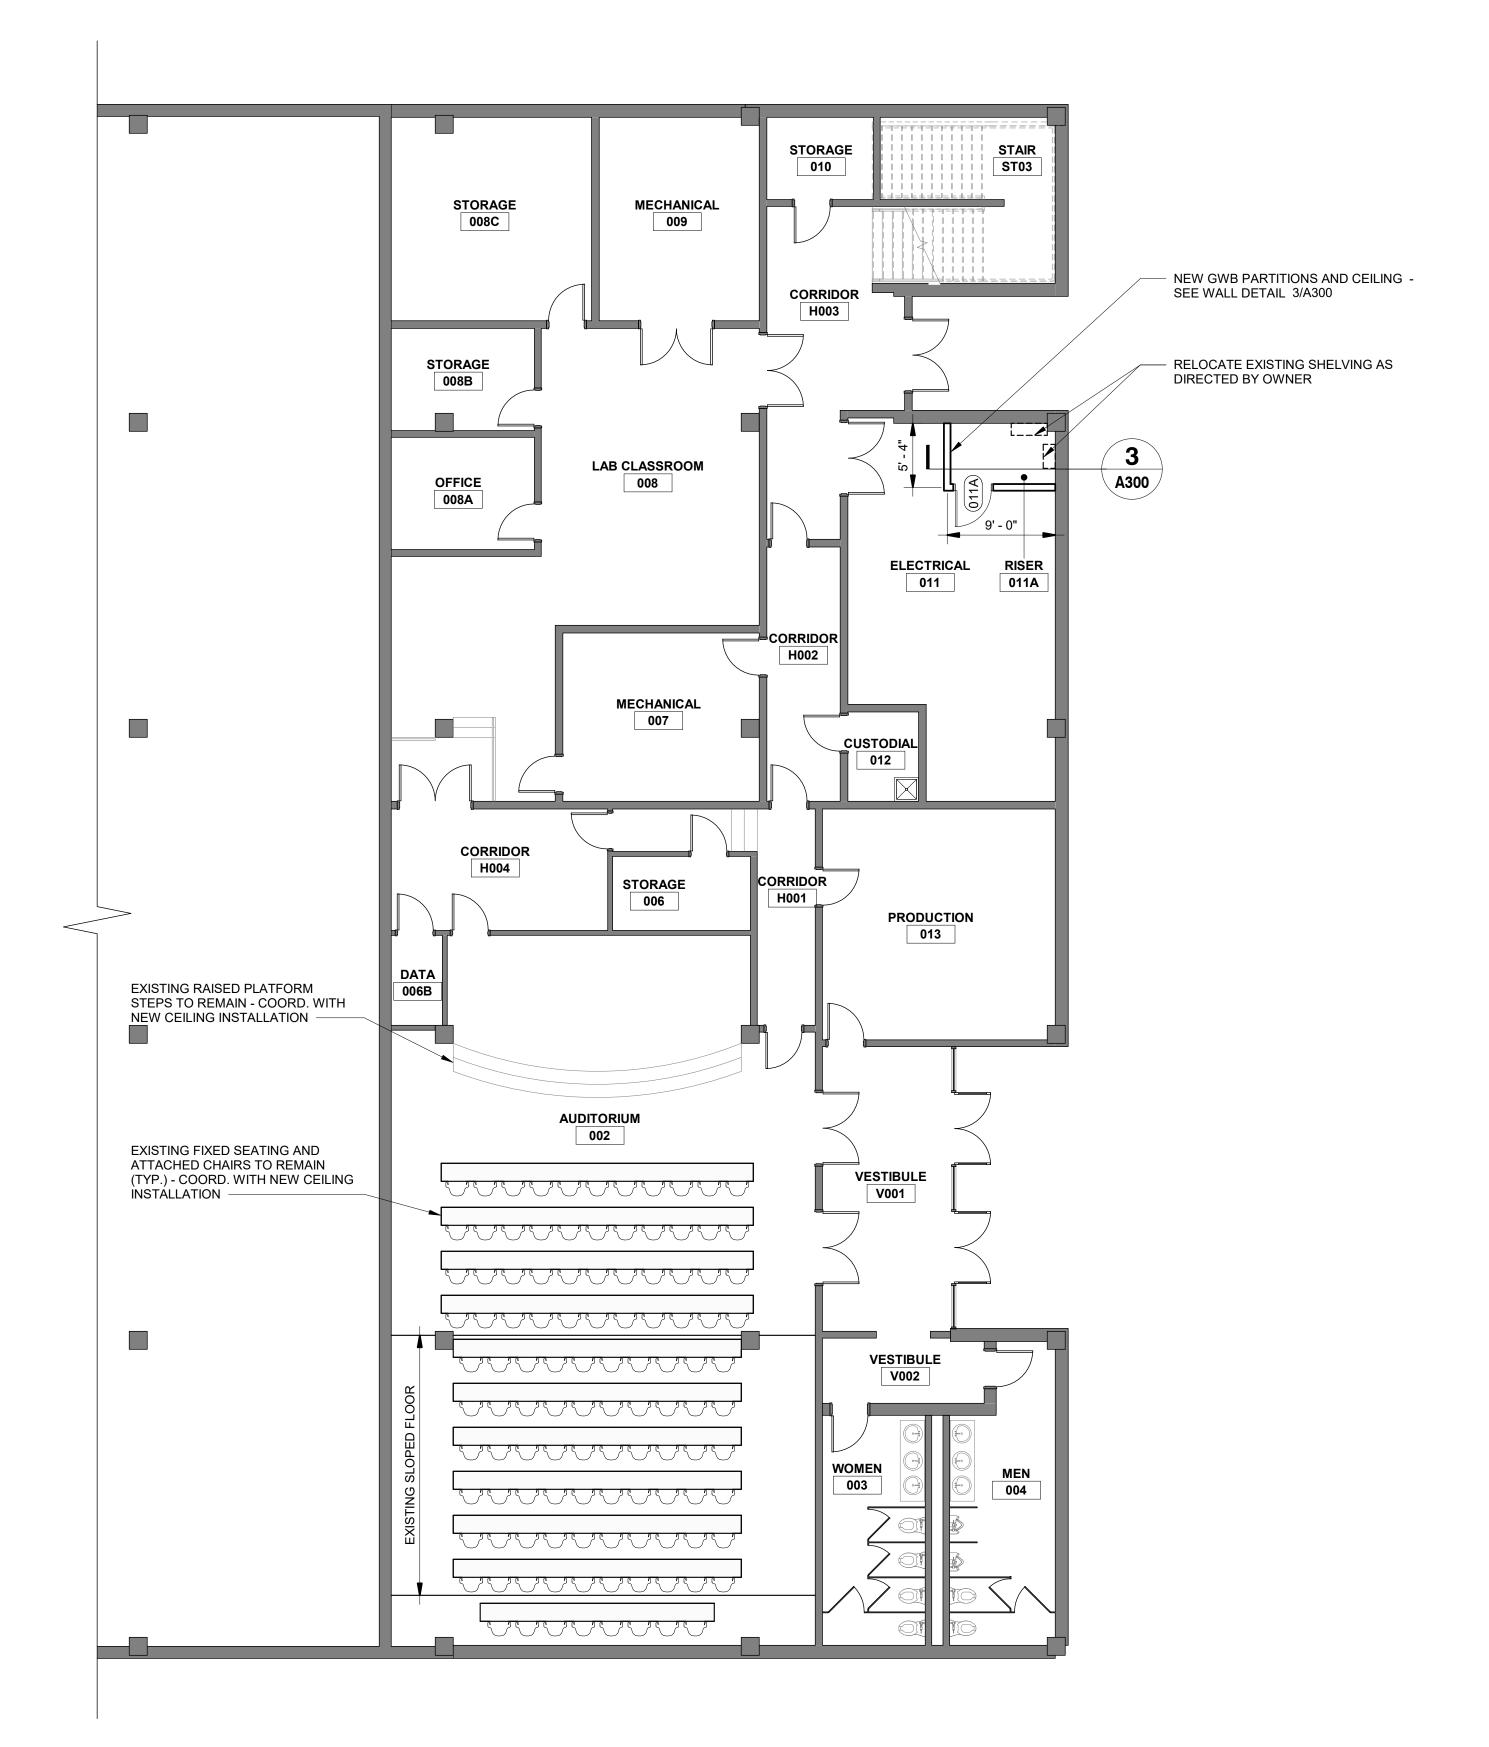

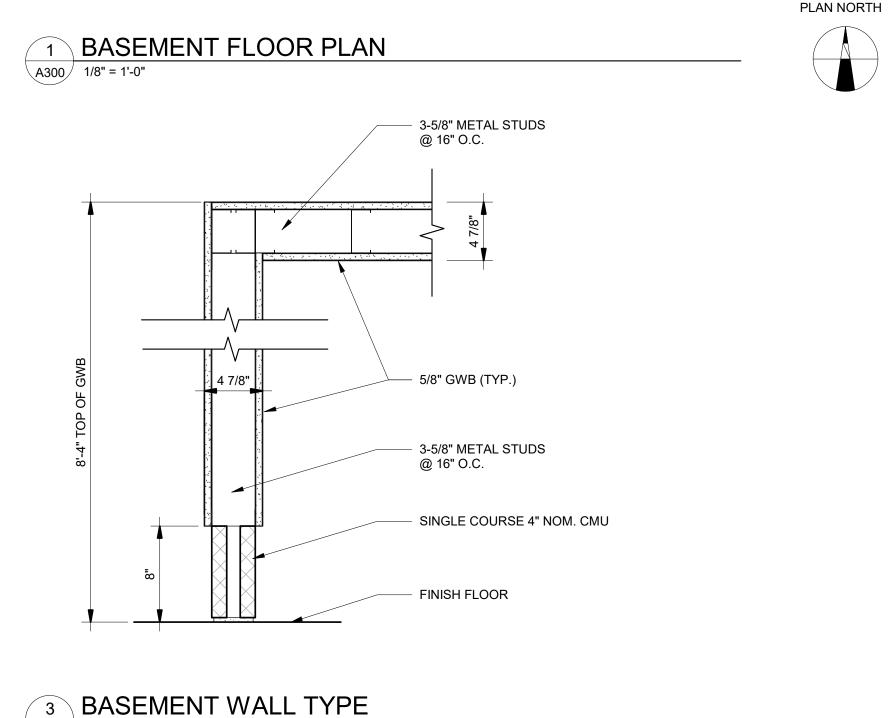

A300 1 1/2" = 1'-0"

WALL LEGEND

—•—• EXISTING 1-HOUR RATED WALL TO REMAIN EXISTING WALL TO REMAIN

NEW WALL (5/8" GWB EA. SIDE OF 3 5/8" METAL STUDS @ 16" O.C. -EXTEND TO 6" ABOVE CEILING AND BRACE TO STRUCTURE AT 4'-0" O.C. CUT BACK EXISTING CEILING GRID AS REQUIRED AND REINSTALL UP TO NEW WALL.)

AND 3' EA. SIDE OF WALL ABOVE CEILING) NEW WALL (SAME AS W1, ADD SOUND BATT INSULATION IN STUD CAVITY

NEW WALL (5/8" GWB ONE SIDE OF 3 5/8" METAL STUDS @ 16" O.C. -EXTEND TO UNDERSIDE OF CEILING)

FLOOR PLAN NOTES

A.F.F. TO TOP OF CABINET

- 1. SEE FINISH SCHEDULE FOR LOCATIONS OF NEW PAINT ON NEW AND EXISTING WALLS. SEE DOOR SCHEDULE FOR NEW PAINT ON NEW DOOR FRAMES.
- 2. ALL FLOOR FINISHES AND BASE ARE BY OWNER (N.I.C.). 3. DIMENSIONS SHOWN FOR NEW GWB PARTITIONS ARE TAKEN TO THE CENTERLINE OF STUD, CENTERLINE OF COLUMNS, OR FACE OF EXISTING WALLS, UNLESS NOTED OTHERWISE.
- 4. GENERAL CONTRACTOR TO FIELD VERIFY ALL DIMENSIONS AND REPORT
- DISCREPANCIES IMMEDIATELY TO THE ARCHITECT. 5. DOOR JAMBS ARE 6" NEAREST PERPENDICULAR WALL, UNLESS NOTED
- 6. CONTRACTOR TO PROTECT ALL EXISTING FINISHES, FIXTURES, AND EQUIPMENT DURING CONSTRUCTION.

7. (FEC) INDICATES NEW SEMI-RECESSED FIRE EXTINGUISHER CABINET AT 48"

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SOURCE (IS ANBURG, H34-951

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South Carolina

12/4/2020 SHEET TITLE: BASEMENT FLOOR PLAN /


CEILING PLAN


- CONTRACTOR SHALL MARK WALLS ABOVE CEILINGS AS REQUIRED THE LOCATIONS OF EXISTING GRID, INCLUDING CEILING HEIGHT, PRIOR TO REMOVAL TO FACILITATE NEW CEILING GRID ALIGNMENT AND REINSTALLATION OF EXISTING LIGHT FIXTURES IN SAME LOCATIONS.
- REMOVE ALL EXISTING LAY-IN CEILINGS THROUGHOUT. INCLUDING GRID, TILE, AND WALL MOLD (LAY-IN CEILINGS ARE PRESENT IN ALL FIXTURES (LIGHTING, MECHANICAL, ETC.) SHALL BE TEMPORARILY HUNG AND REINSTALLED IN NEW CEILINGS IN SAME LOCATIONS
- REFER TO ELECTRICAL DRAWINGS FOR ALL CEILING MOUNTED EXIT
- INSTALLATION. COORDINATE ALL HVAC MECHANICAL DEVICES WITH MECHANICAL
- CATEGORY "C".
- COMPONENTS WITHOUT INTERFERING WITH DUCTS, PIPES, BEAMS, ETC. LOCATE LIGHT FIXTURES SYMMETRICALLY, AS DIMENSIONED,

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FIRST FLOOR PLAN


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29303 SC, NO.: H34-9517

18104

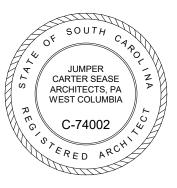12/4/2020

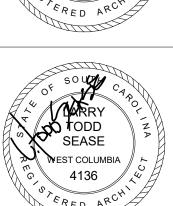SECOND FLOOR PLAN

SHEET NO:

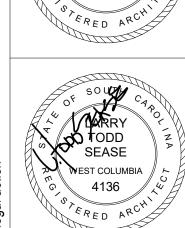WALLS. SEE DOOR SCHEDULE FOR NEW PAINT ON NEW DOOR FRAMES.

3. DIMENSIONS SHOWN FOR NEW GWB PARTITIONS ARE TAKEN TO THE CENTERLINE OF STUD, CENTERLINE OF COLUMNS, OR FACE OF EXISTING

GENERAL CONTRACTOR TO FIELD VERIFY ALL DIMENSIONS AND REPORT DISCREPANCIES IMMEDIATELY TO THE ARCHITECT.


5. DOOR JAMBS ARE 6" NEAREST PERPENDICULAR WALL, UNLESS NOTED

CONTRACTOR TO PROTECT ALL EXISTING FINISHES, FIXTURES, AND EQUIPMENT DURING CONSTRUCTION.

7. FEC INDICATES NEW SEMI-RECESSED FIRE EXTINGUISHER CABINET AT 48" A.F.F. TO TOP OF CABINET

2. ALL FLOOR FINISHES AND BASE ARE BY OWNER (N.I.C.).

WALLS, UNLESS NOTED OTHERWISE.

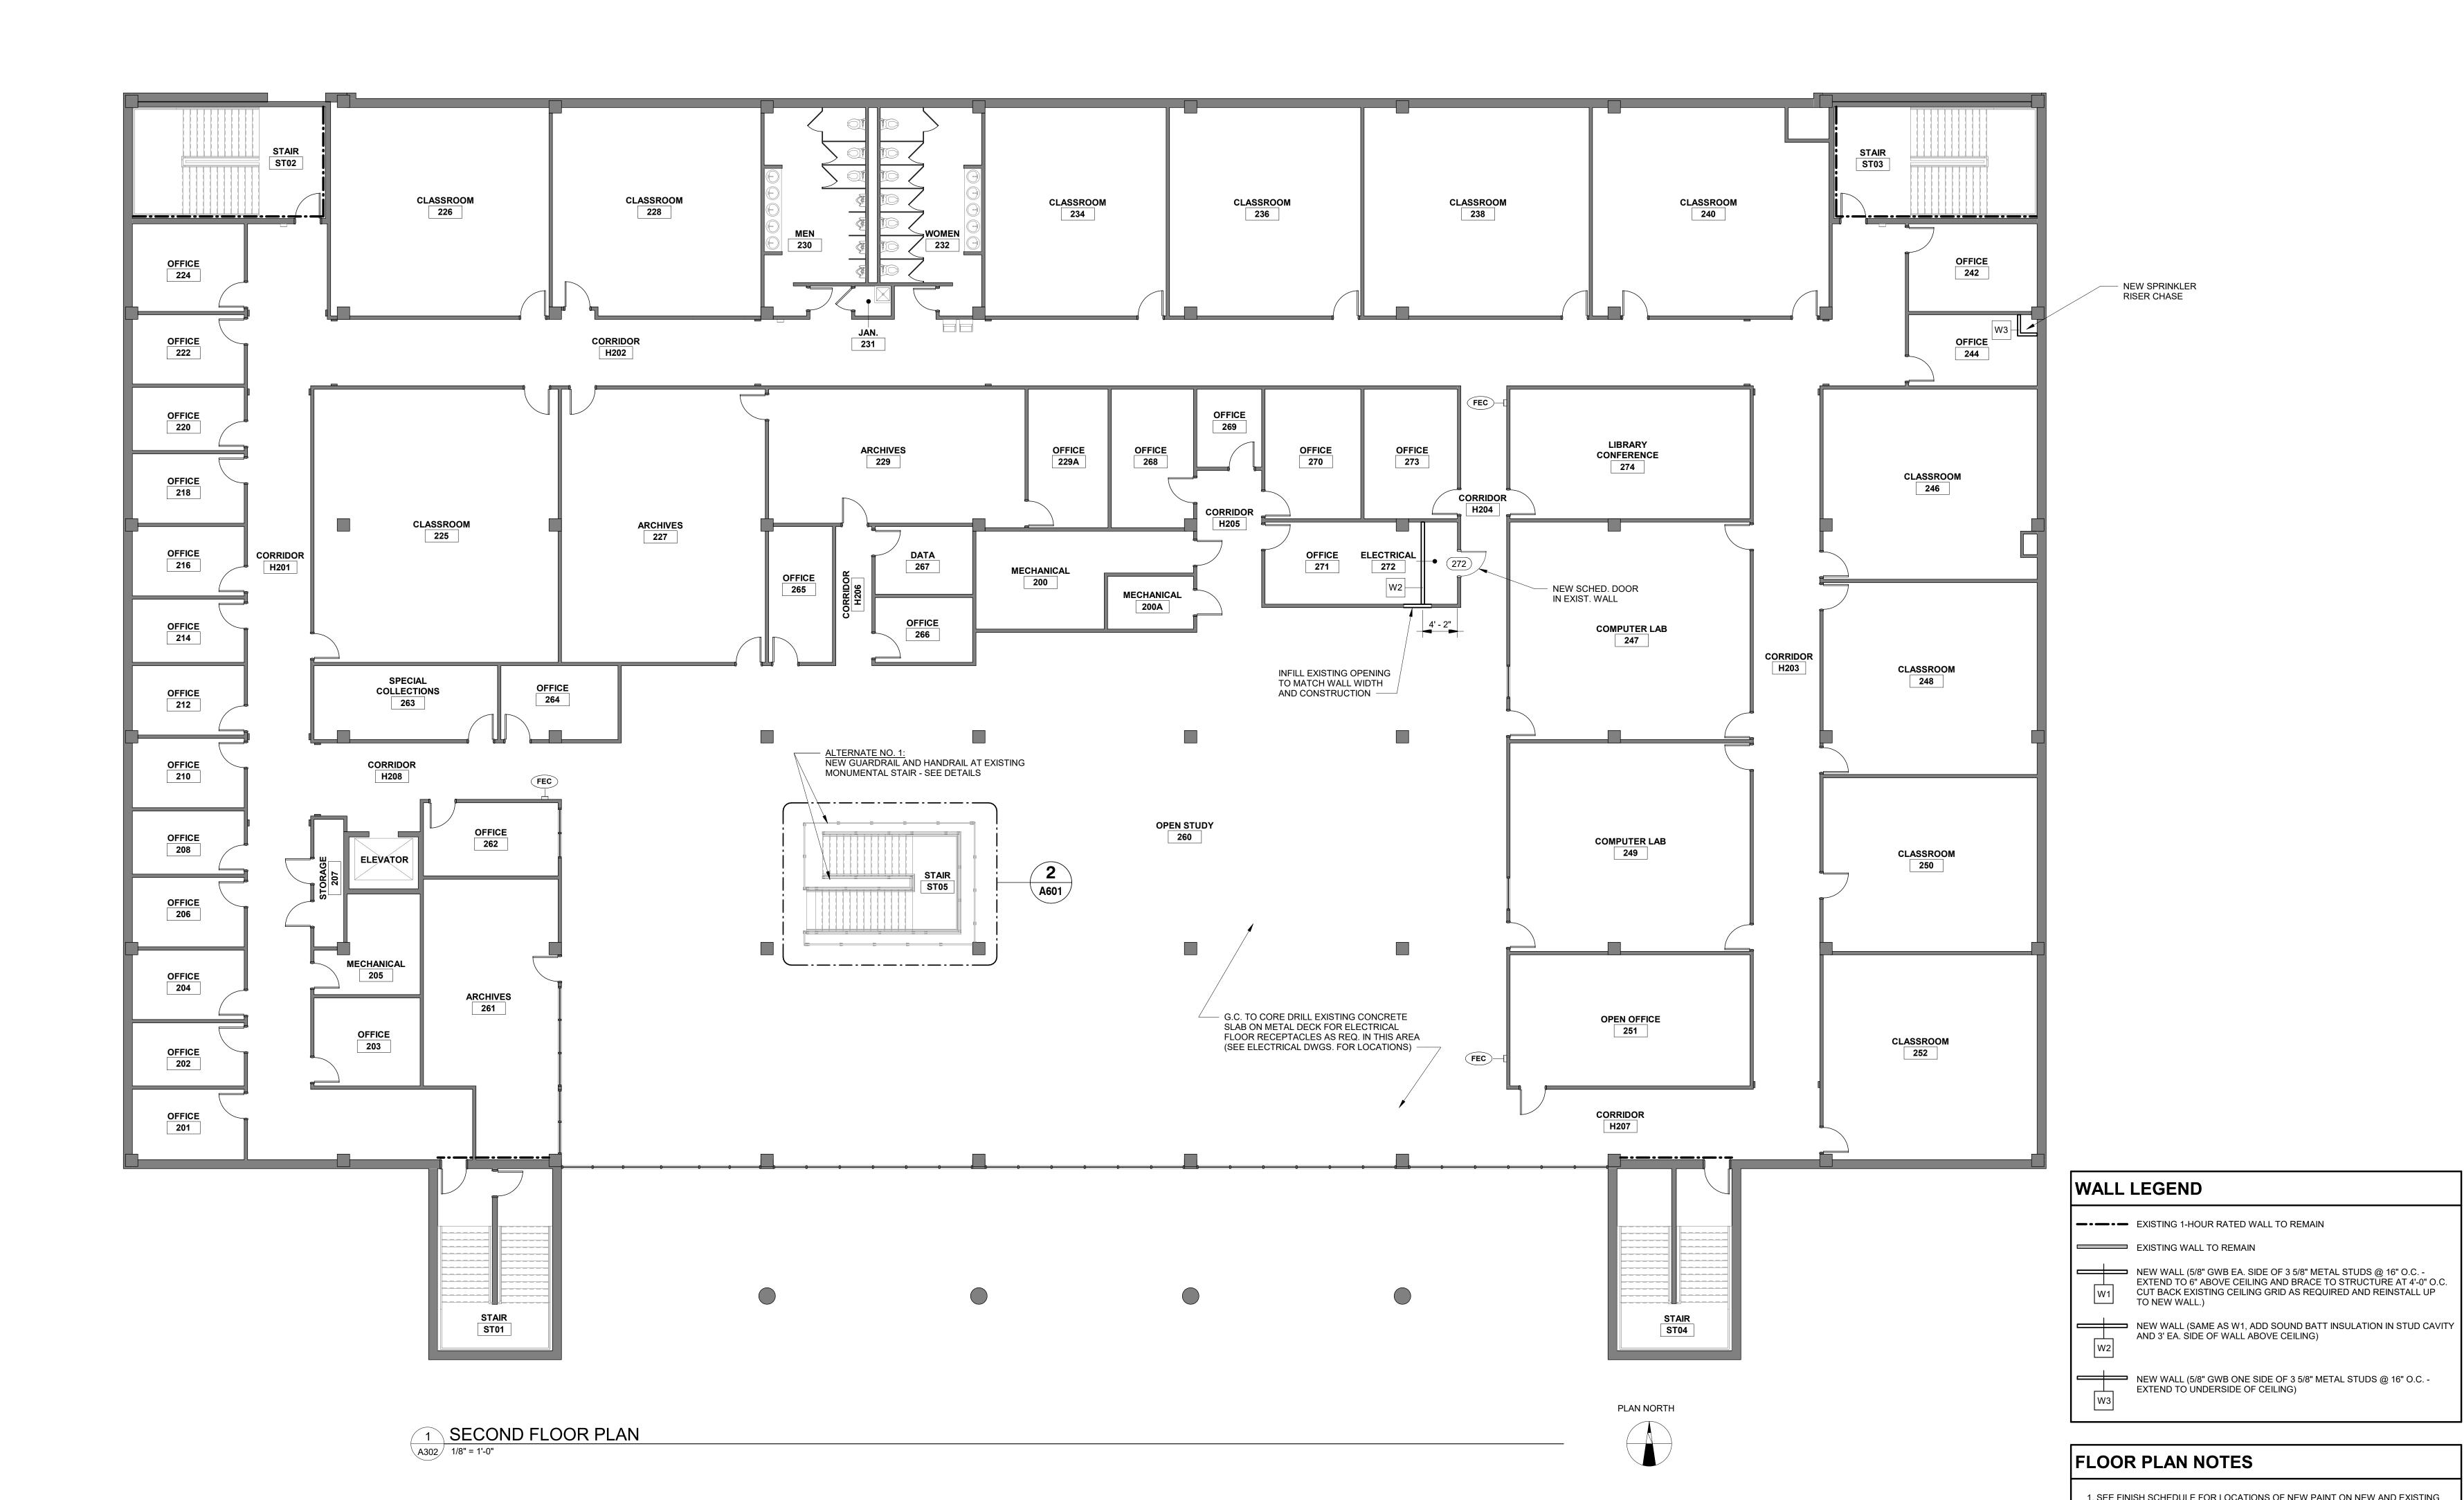

ROOM

ROOM NAME

WOMEN

STORAGE

MECHANICAL

LAB CLASSROOM

DATA

OFFICE

STORAGE

STORAGE

STORAGE

MECHANICAL

ELECTRICAL

13 PF 00 OF	CUSTODIAL PRODUCTION OPEN STUDY 24/7 COMPUTER LAB FOOD WORK ROOM CAFE CAFE SEATING CIRCULATION/HELP DESK IT OFFICE OFFICE OFFICE OFFICE OFFICE STORAGE OFFICE LIBRARY REFERENCE DESK OFFICE OFFICE OFFICE STORAGE OFFICE COFFICE OFFICE SUPPLIES ELECTRICAL STORAGE CONFERENCE STORAGE	BASEMENT BASEMENT 1ST FLOOR						 PT	ALTERNATE NO. 2
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50 CL	OFFICE OFFICE OFFICE CLASSROOM CLASSROOM ARCHIVES CLASSROOM ARCHIVES OFFICE MEN JAN. WOMEN CLASSROOM COMPUTER LAB CLASSROOM COMPUTER LAB	2ND FLOOR							
51 OF	OFFICE OFFICE OFFICE CLASSROOM CLASSROOM ARCHIVES CLASSROOM ARCHIVES OFFICE MEN JAN. WOMEN CLASSROOM	2ND FLOOR							
52 CL	OFFICE OFFICE OFFICE CLASSROOM CLASSROOM ARCHIVES CLASSROOM ARCHIVES OFFICE MEN JAN. WOMEN CLASSROOM COMPUTER LAB CLASSROOM COMPUTER LAB	2ND FLOOR							
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66 OF	OFFICE OFFICE OFFICE CLASSROOM CLASSROOM ARCHIVES CLASSROOM ARCHIVES OFFICE MEN JAN. WOMEN CLASSROOM COMPUTER LAB CLASSROOM COMPUTER LAB CLASSROOM COMPUTER LAB CLASSROOM OPEN OFFICE CLASSROOM OPEN OFFICE CLASSROOM OPEN STUDY ARCHIVES OFFICE SPECIAL COLLECTIONS	2ND FLOOR							

FINISH SCHEDULE

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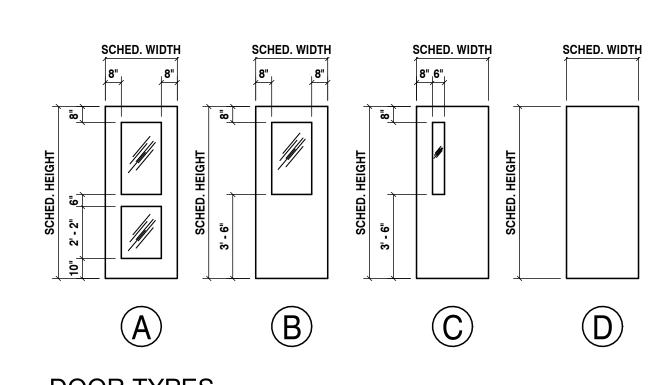
BASEMENT


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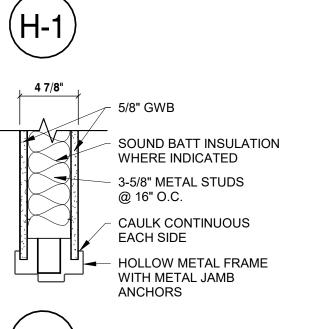
BASEMENT

				FIN	SH SCH	IEDULE			
ROOM			FLOOR		WALL	WALL			
#	ROOM NAME	Level	FINISH	BASE TYPE	NORTH	SOUTH	WALL EAST	WALL WEST	COMMENTS
267	DATA	2ND FLOOR							
268	OFFICE	2ND FLOOR							
269	OFFICE	2ND FLOOR							
270	OFFICE	2ND FLOOR							
271	OFFICE	2ND FLOOR			PT	PT	PT	PT	
272	ELECTRICAL	2ND FLOOR			PT	PT	PT	PT	
273	OFFICE	2ND FLOOR							
274	LIBRARY CONFERENCE	2ND FLOOR							
H001	CORRIDOR	BASEMENT							
H002	CORRIDOR	BASEMENT							
H003	CORRIDOR	BASEMENT							
H004	CORRIDOR	BASEMENT							
H101	CORRIDOR	1ST FLOOR							
H102	CORRIDOR	1ST FLOOR							
H103	CORRIDOR	1ST FLOOR							
H104	CORRIDOR	1ST FLOOR			PT	PT	PT	PT	
H105	CORRIDOR	1ST FLOOR			PT	PT	PT		
H106	CORRIDOR	1ST FLOOR			PT	PT		PT	
H201	CORRIDOR	2ND FLOOR							
H202	CORRIDOR	2ND FLOOR							
H203	CORRIDOR	2ND FLOOR							
H204	CORRIDOR	2ND FLOOR					PT	PT	
H205	CORRIDOR	2ND FLOOR							
H206	CORRIDOR	2ND FLOOR							
H207	CORRIDOR	2ND FLOOR			PT				
H208	CORRIDOR	2ND FLOOR			PT	PT			
ST01	STAIR	2ND FLOOR							
ST01	STAIR	1ST FLOOR							
ST02	STAIR	1ST FLOOR							
ST02	STAIR	2ND FLOOR							
ST03	STAIR	1ST FLOOR							
ST03	STAIR	2ND FLOOR							
ST03	STAIR	BASEMENT							
ST04	STAIR	1ST FLOOR							
ST04	STAIR	2ND FLOOR							
ST05	STAIR	1ST FLOOR			PT	PT	PT	PT	ALTERNATE NO. 1
ST05	STAIR	2ND FLOOR			PT	PT	PT	PT	ALTERNATE NO. 1
V001	VESTIBULE	BASEMENT						F1	ACICIMATE IV. I
V001 V002	VESTIBULE	BASEMENT	<u></u>						
V100	VESTIBULE	1ST FLOOR							

DOOR SCHEDULE													
DOOR #	DOOR TYPE	DOOR WIDTH	DOOR HEIGHT	DOOR MATERIAL	DOOR FINISH	FRAME TYPE	FRAME MATERIAL	FRAME FINISH	HEAD	JAMB	SILL	RATING	REMARKS
011A	D	3'-0"	7' - 0"	НМ	PT	1	НМ	PT	H-1	J-1	-		
101	С	3'-8"	7' - 0"	swc	ST	1	НМ	PT	H-1	J-1	-		ALTERNATE NO. 2
104	С	3'-0"	7' - 0"	swc	ST	1	НМ	PT	H-1	J-1	-		ALTERNATE NO. 2
117A	В	3'-0"	7' - 0"	swc	ST	1	НМ	PT	H-1	J-1	-		
117B	В	3'-0"	7' - 0"	swc	ST	1	НМ	PT	H-1	J-1	-		
117C	В	3'-0"	7' - 0"	swc	ST	1	НМ	PT	H-1	J-1	-		
117D	В	3'-0"	7' - 0"	SWC	ST	1	НМ	PT	H-1	J-1	-		
117E	В	3'-0"	7' - 0"	swc	ST	1	НМ	PT	H-1	J-1	-		
117F	В	3'-0"	7' - 0"	swc	ST	1	НМ	PT	H-1	J-1	-		
120	С	3'-0"	7' - 0"	swc	ST	1	НМ	PT	H-1	J-1	-		
272	D	3'-0"	7' - 0"	swc	ST	1	НМ	PT	H-1	J-1	-		
H104	Α	3'-0"	7' - 0"	swc	ST	2	НМ	PT	H-1	J-1	-		





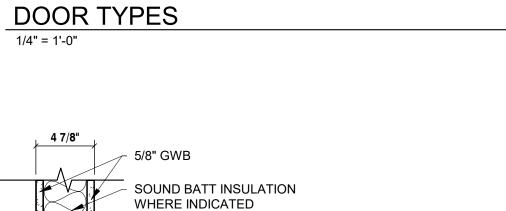

- 3-5/8" METAL STUDS


- CAULK CONTINUOUS

@ 16" O.C.

EACH SIDE

HOLLOW METAL FRAME



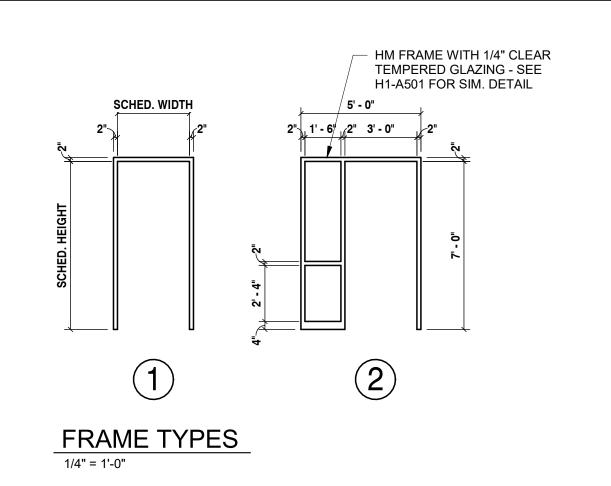

DIMENSIONS SHOWN ARE MINIMUM FOR A.D.A. REQUIREMENTS. ALL DOORS SHALL MEET THESE REQUIREMENTS

TYP. DOOR CLEARANCE

PUSH SIDE

FINISH SCHEDULE NOTES

- 1. ALL FLOOR FINISHES AND BASE ARE PROVIDED BY OWNER (N.I.C.).
- 2. PAINT NEW AND EXISTING WALLS AS INDICATED ON SCHEDULE (PT).
- 3. SEE REFLECTED CEILING PLANS FOR NEW CEILINGS AND HEIGHTS.
- 4. PAINT NEW GWB SOFFITS TO MATCH WALLS (SEE REFLECTED CEILING PLANS).


Jumper

Carter


Sease

ARCHITECTS

412 Meeting Street West Columbia South Carolina

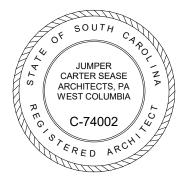



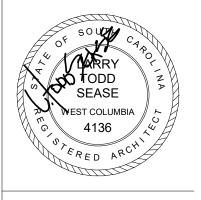

29303

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ARTANBURG, NO.: H34-9517

GRAMLING I STATE


50

CENTER

RESOURCE ONS

DOOR SCHEDULE LEGEND

HM HOLLOW METAL
PT PAINT (COLOR TO BE SELECTED BY ARCHITECT)
ST STAIN (MATCH EXISTING DOORS)
SWC SOLID WOOD CORE

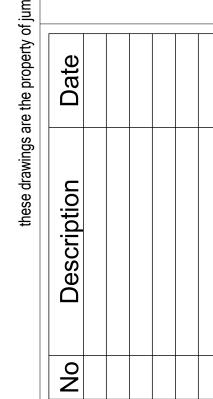

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these drawings are the proper	Description					
are tne prope	Date					

CHECKED BY: 18104

COMM NO:


12/4/2020 SHEET TITLE:

FINISH SCHED. / DOOR SCHED. / DOOR & FRAME TYPES &

SHEET NO:


A501

DETAILS

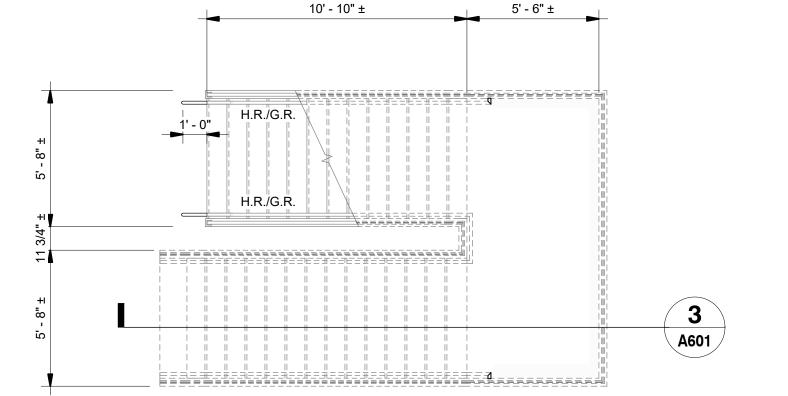


FIELD VERIFY ALL DIMENSIONS PRIOR TO FABRICATION


1 STAIR 05 - 1ST FLOOR PLAN A601 1/4" = 1'-0"

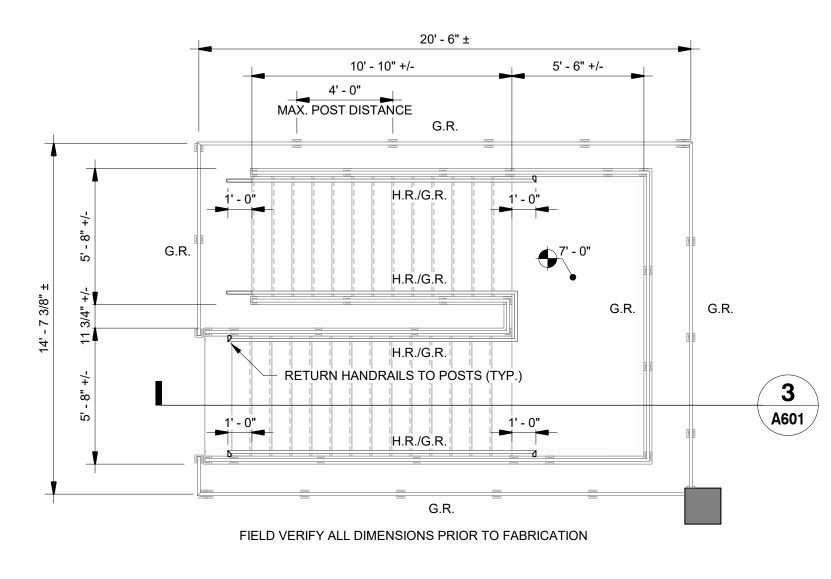


2 STAIR 05 - 2ND FLOOR PLAN
A601 1/4" = 1'-0"

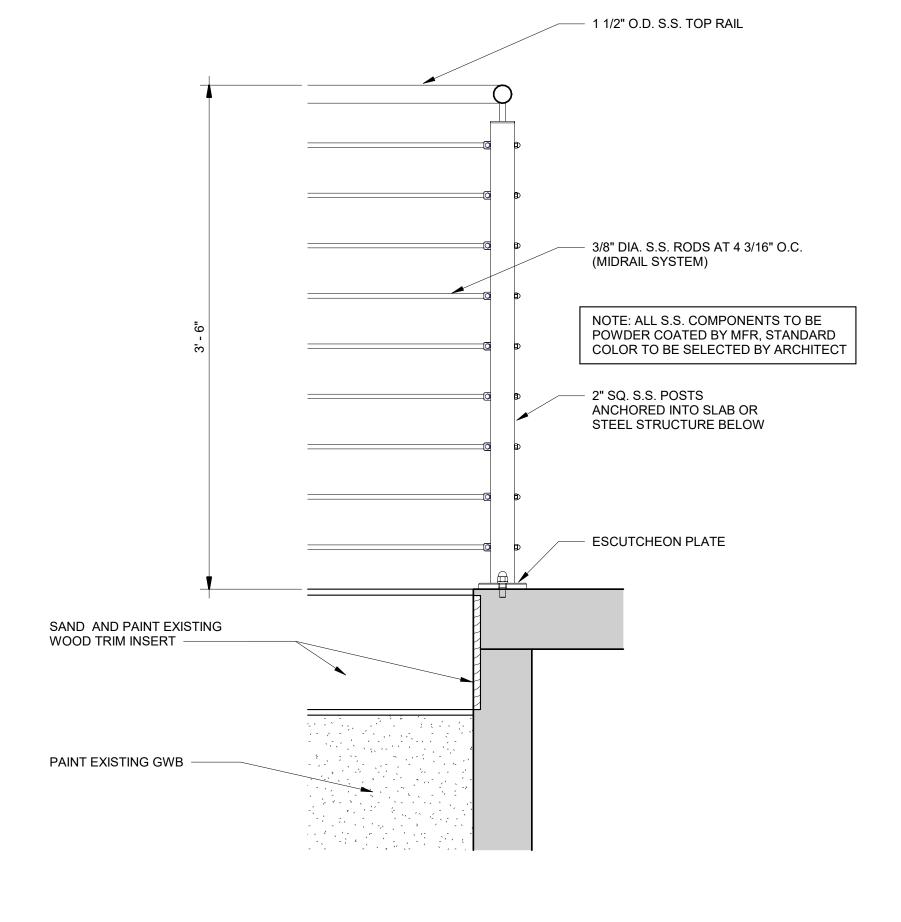

4 GUARDRAIL DETAIL A601 1 1/2" = 1'-0"

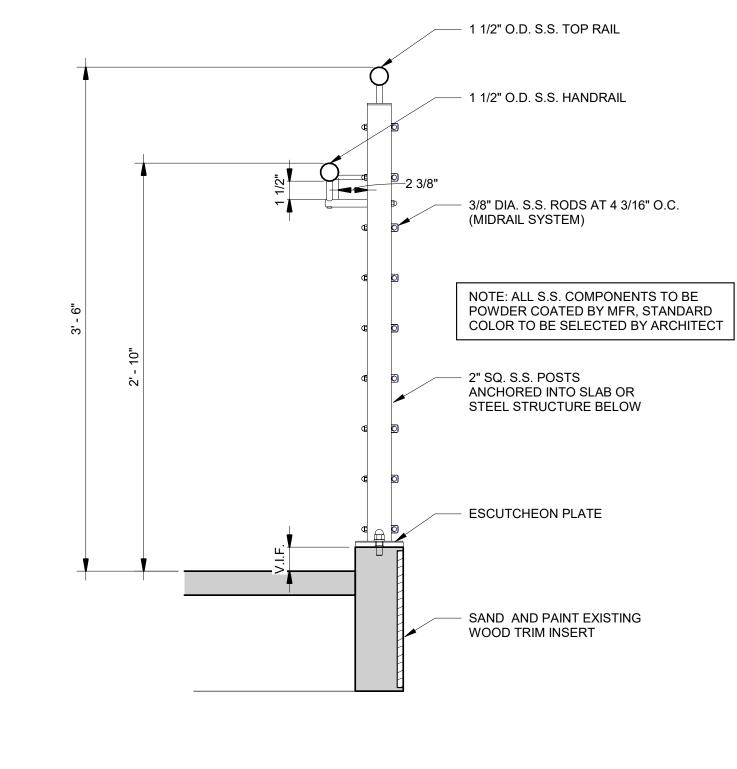

5 GUARDRAIL/HANDRAIL DETAIL A601 1 1/2" = 1'-0"

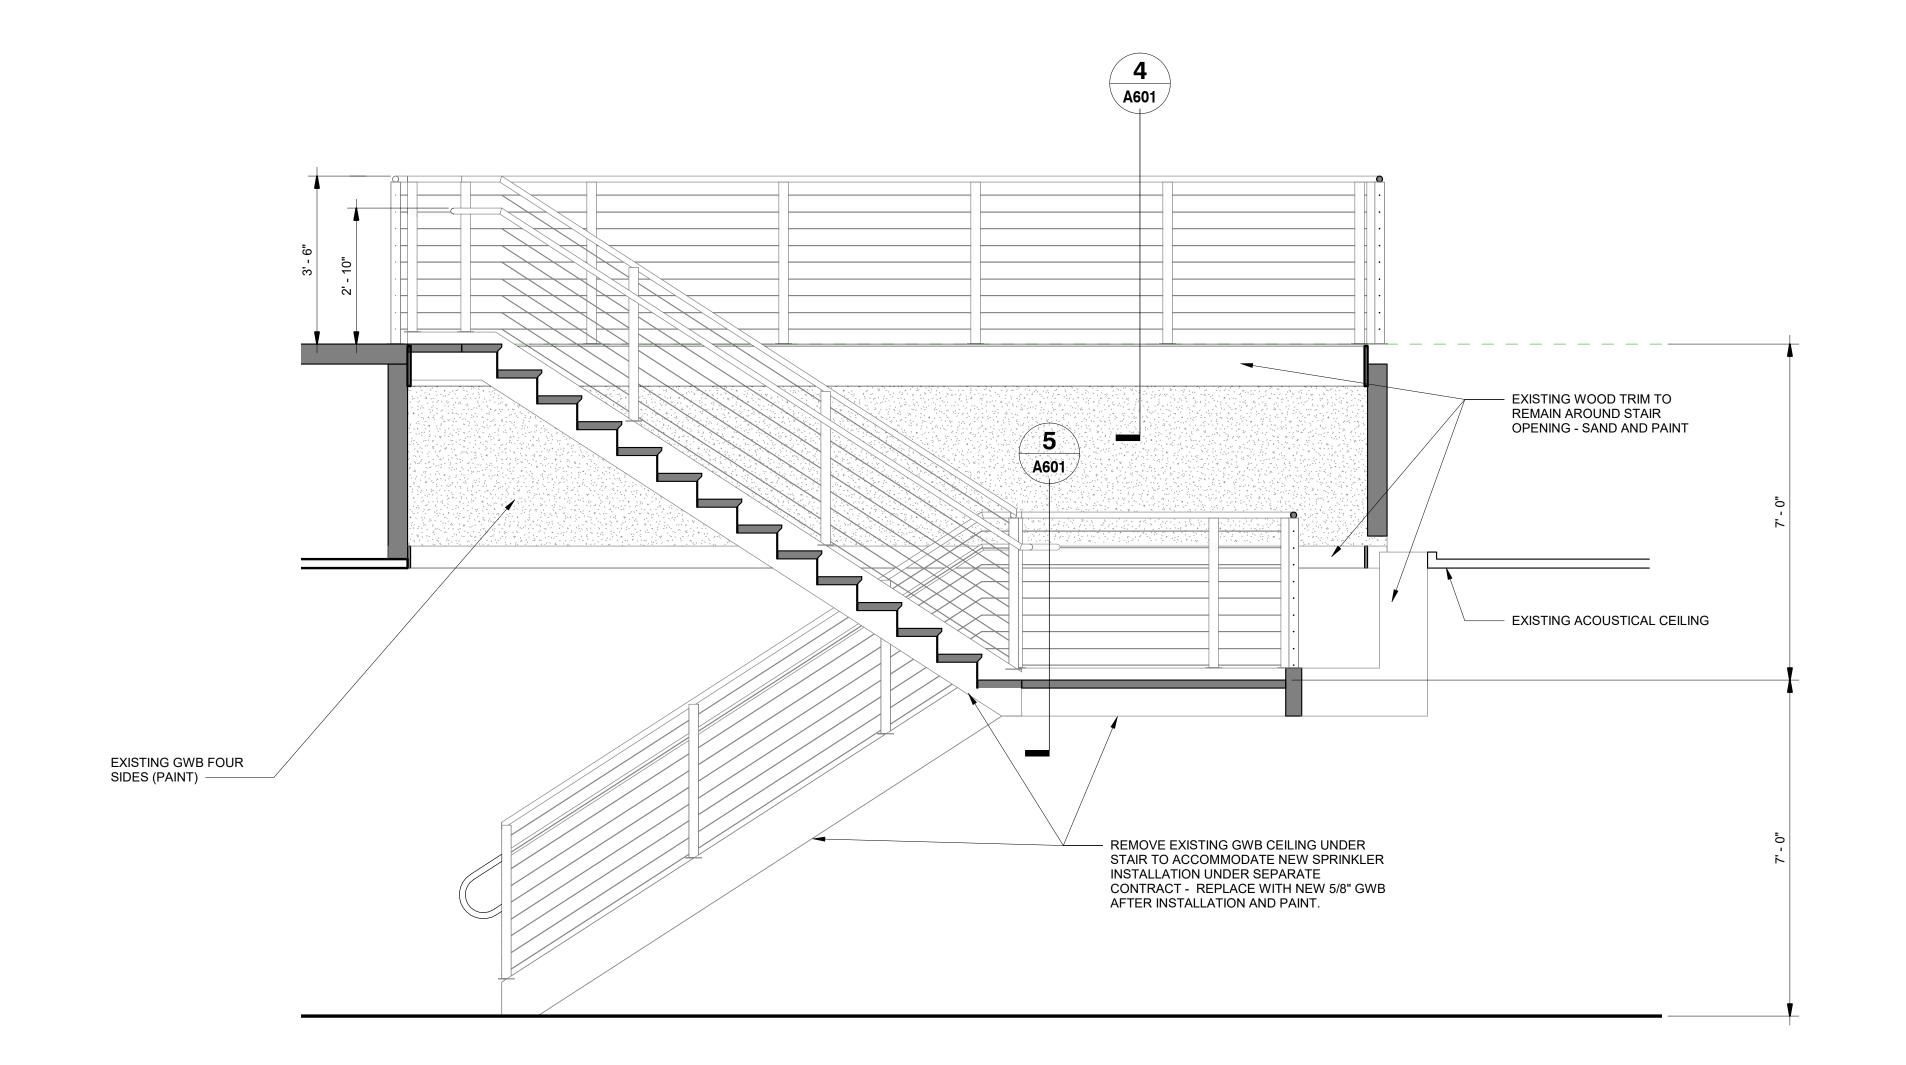

3 STAIR 05 SECTION
A601 1/2" = 1'-0"


Jumper

Carter


Sease

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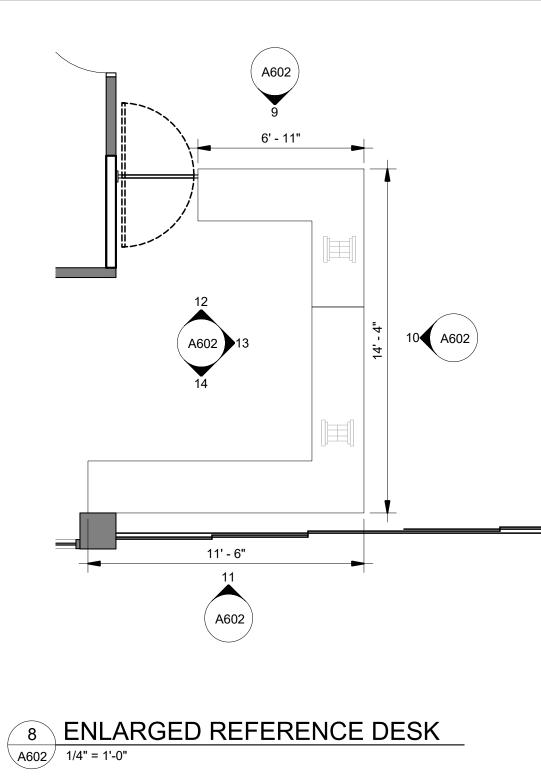
DRAWN BY: CBG CHECKED BY: COMM NO: 18104

12/4/2020 SHEET TITLE:

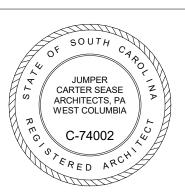ALT. NO. 1

STAIR DETAILS

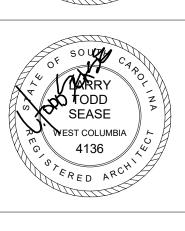A601



DBL SWING DOOR

8' - 4 3/4"

10 REFERENCE DESK ELEVATION

4' - 10 3/4"

- CAM LOCKS, TYP.

11 REFERENCE DESK ELEVATION

12 REFERENCE DESK ELEVATION

2' - 0" 2" 2' - 3" 1' - 4"1' - 4"1' - 4"1' - 4" 2' - 3

13 REFERENCE DESK ELEVATION

14 REFERENCE DESK ELEVATION

A602 1/4" = 1'-0"

CAM LOCKS, TYP.

A602 1/4" = 1'-0"

9 REFERENCE DESK ELEVATION

VERIFY SIGNAGE TEXT (PL-3) - SEE DETAIL


VERIFY SIGNAGE TEXT (PL-3) -

ACCESS PANEL, TYP.

DUPLEX/DATA, TYP.

- CAM LOCKS, TYP.

SEE DETAIL

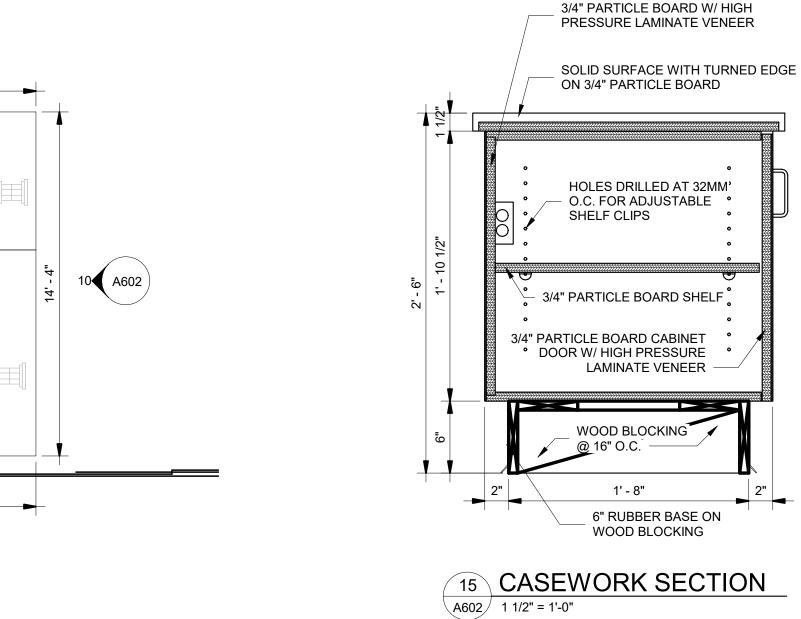

SOLID SURFACE WITH TURNED

- CABLING CHASE

CABINET BEYOND

WOOD BLOCKING @ 16" O.C.

6" RUBBER BASE ON

-WOOD BLOCKING-

18 CASEWORK SECTION

EDGE OF SOLID SURFACE COUNTERTOP ABOVE

3/4" PARTICLE BOARD WITH

EDGE OF RUBBER

1' - 6"

2' - 0"

BASE BELOW

PLASTIC LAMINATE (PL-1) -

3/4" PARTICLE BOARD WITH

FOR MORE INFORMATION -

PLASTIC LAMINATE GRAPHIC LETTERS (PL-3) EMBEDDED

FLUSH WITH BASE LAMINATE

(SEE DETAIL) -

21 PLAN SECTION

PLASTIC LAMINATE W/ EDGE TRIM


TO MATCH (PL-2) SEE ELEVATION

2" 4"


A602 1 1/2" = 1'-0"


3/4" PARTICLE BOARD W/ - HIGH PRESSURE LAMINATE

EDGE ON 3/4" PARTICLE BOARD

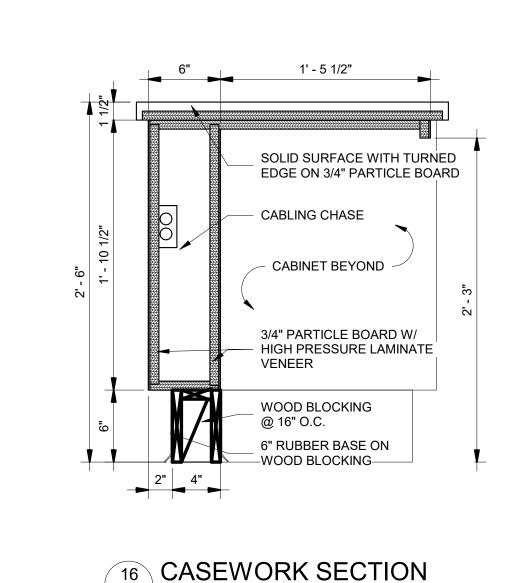



A602 1 1/2" = 1'-0"

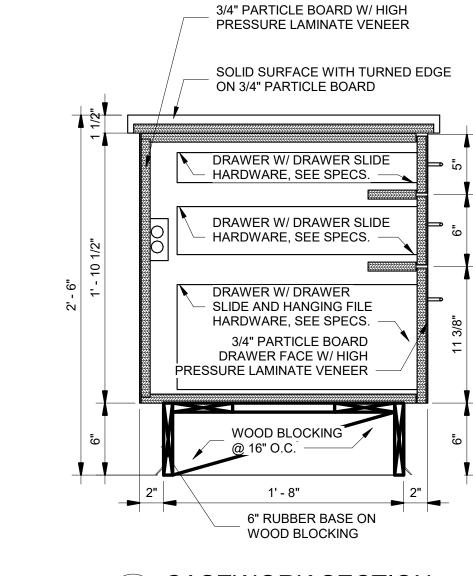

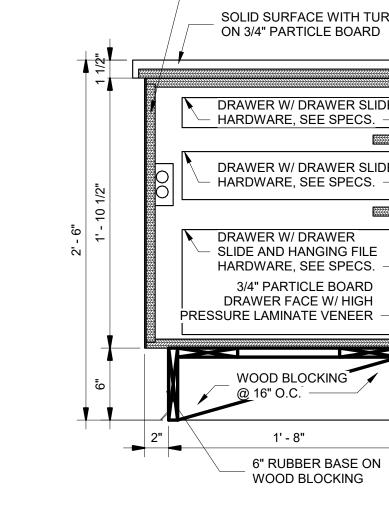

A602 1 1/2" = 1'-0"

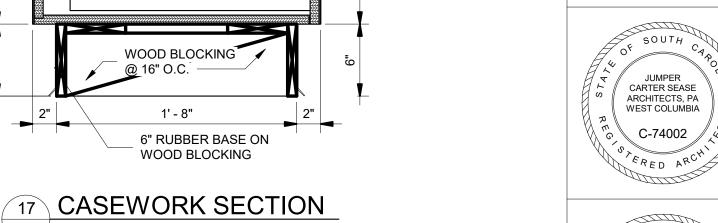

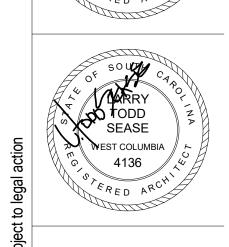

Jumper

Carter

Sease


ARCHITECTS


412 Meeting Street West Columbia

South Carolina

29303


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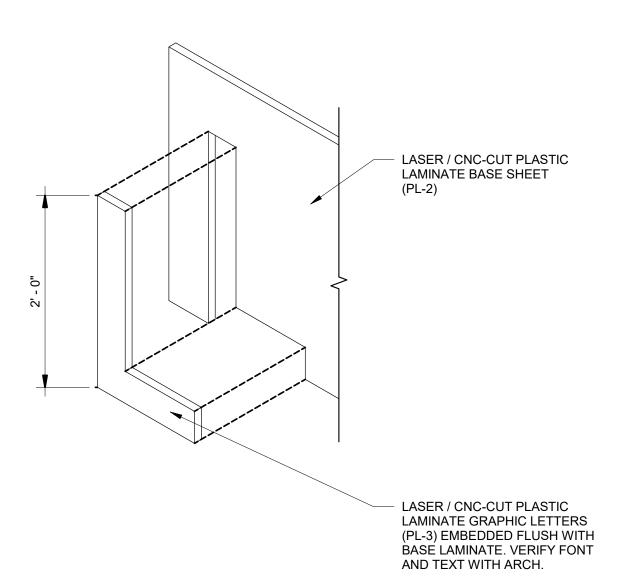


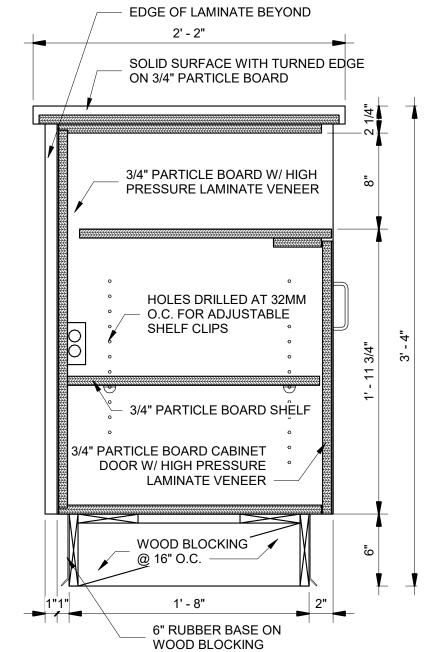
3/4" PARTICLE BOARD W/ HIGH

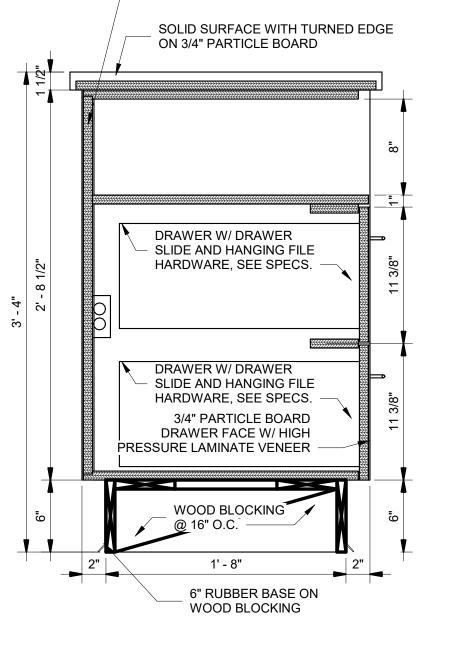PRESSURE LAMINATE VENEER







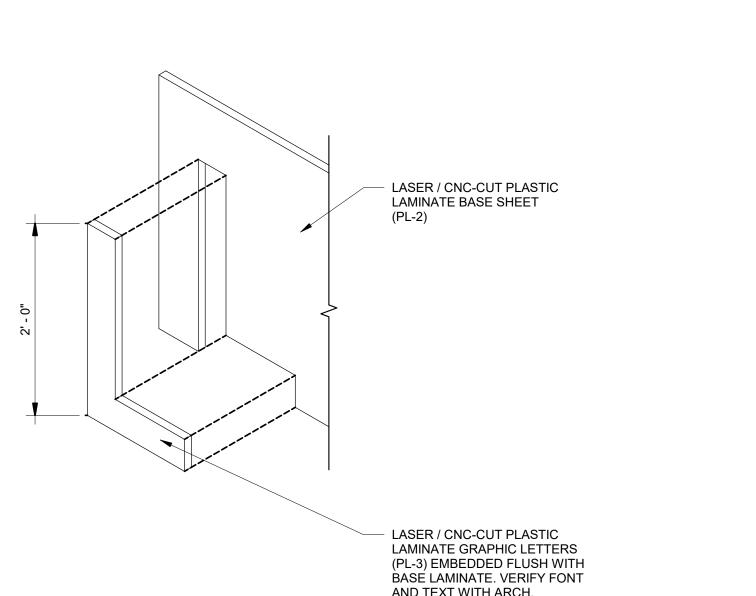

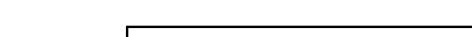

- 1. ALL CASEWORK SHOWN THIS SHEET SHALL BE INCLUDED AS <u>ALTERNATE NO. 2.</u> 2. CASEWORK DIMENSIONS SHALL BE FIELD VERIFIED PRIOR TO UNIT FABRICATION AND INSTALLATION.
- 3. COUNTERTOPS AND BACKSPLASHES SHALL BE CAULKED TO THE WALL. 4. CASEWORK FABRICATOR AND INSTALLER SHALL COORDINATE WITH
- APPROPRIATE SUBCONTRACTORS FOR INSTALLATION OF ELECTRICAL RECEPTACLES, DATA OUTLETS, ETC. WITHIN THE CASEWORK.
- 6. ALL OPENINGS IN COUNTERS SHALL BE CUT IN, NOT SEAMED.

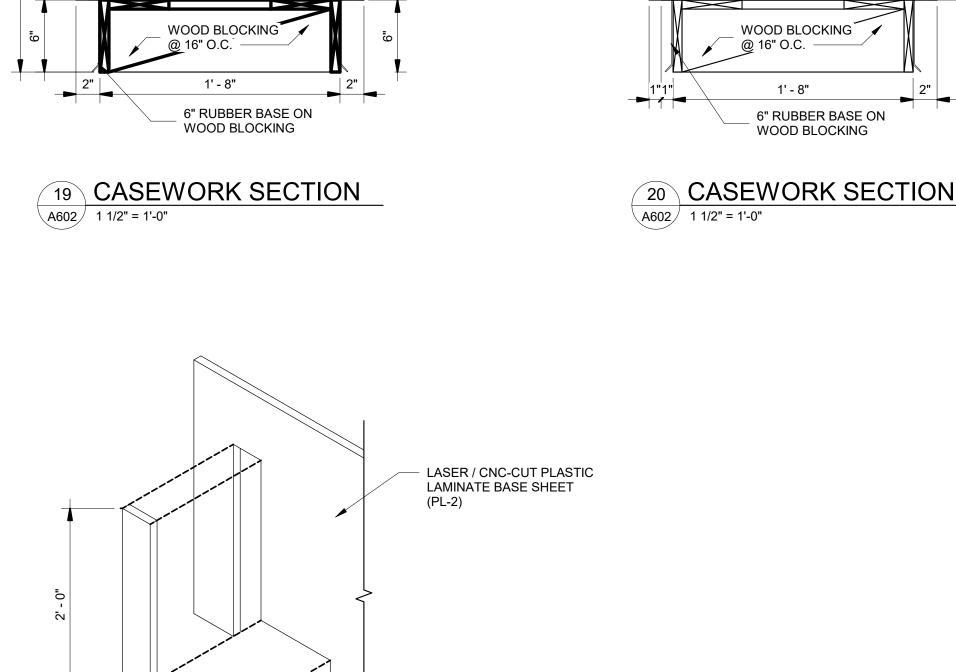

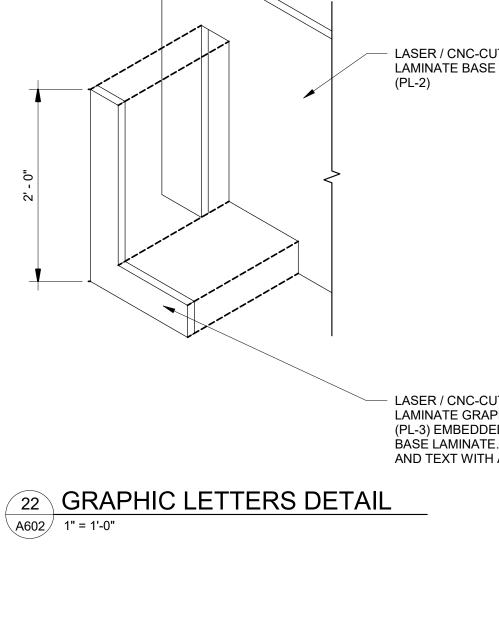



- 5. PROVIDE WALL MOUNTED ANGLE SUPPORTS (FINISH TO MATCH THE COLOR AND MATERIAL OF ADJACENT CASEWORK) WHERE NECESSARY FOR SUPPORT OF COUNTERTOPS ABOVE KNEE SPACES.

A602

DRAWN BY: CHECKED BY:

CBG COMM NO: 18104

DATE: 12/4/2020 SHEET TITLE:

ALT. NO. 2 CASEWORK **ELEVATIONS & DETAILS**

Carter

Sease

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South Carolina







29303 RESOURCE (TIONS)
ARTANBURG,
NO.: H34-9517

GRAMLING I STATE

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DRAWN BY:

CHECKED BY: COMM NO: 18104 DATE: 12/4/2020 SHEET TITLE:

FIRST FLOOR **CEILING PLAN**

SHEET NO:

CATEGORY "C".

B. LOCATE ALL RECESSED FIXTURES AT THE CENTERLINE OF TILE

ELECTRICAL DWGS. FOR FIXTURE TYPES.

UNLESS NOTED OTHERWISE. INSTALL ALL ELECTRICAL SYSTEM

COMPONENTS WITHOUT INTERFERING WITH DUCTS, PIPES, BEAMS, ETC. LOCATE LIGHT FIXTURES SYMMETRICALLY, AS DIMENSIONED, OR AS INDICATED ON THE REFLECTED CEILING PLANS. SEE

NEW 2'X2' ACOUSTICAL TILE CEILING SYSTEM
(TILE AND GRID) TO MATCH EXISTING SYSTEM

NEW GWB SOFFIT / BULKHEAD PER DETAIL

(9'-4" A.F.F. U.N.O.)

INSTALLED IN 1ST FLOOR LIBRARY SPACE

ACT1 8'-0"

9'-4"

CLASSROOM

CORRIDOR

H202

ARCHIVES

227

ACT1 8'-0"

WOMEN

JAN. 231

ARCHIVES

9'-4"

NEW GWB SOFFIT AT 8'-0"

CLASSROOM

OFFICE

OFFICE 271

CLASSROOM

OFFICE

273

CORRIDOR

(SEE DETAIL 2/A901)

CLASSROOM

EXISTING DECORATIVE

SOFFIT TO REMAIN

229A

MECHANICAL

EXISTING GWB CEILING AT STAIR

ST03

OFFICE

242

OFFICE

CLASSROOM

248

CLASSROOM

EXISTING DECORATIVE SOFFIT TO REMAIN

CLASSROOM

- EXISTING GWB CEILING AT STAIR

CEILING PLAN LEGEND

(9'-4" A.F.F. U.N.O.)

NEW 2'X2' ACOUSTICAL TILE CEILING SYSTEM

NEW GWB SOFFIT / BULKHEAD PER DETAIL

(TILE AND GRID) TO MATCH EXISTING SYSTEM

INSTALLED IN 1ST FLOOR LIBRARY SPACE

TO REMAIN -

CLASSROOM

EXISTING DECORATIVE

CONFERENCE

COMPUTER LAB

COMPUTER LAB

OPEN OFFICE

ST04

PLAN NORTH

CORRIDOR

SOFFIT TO REMAIN

EXISTING GWB CEILING AT STAIR

CLASSROOM

EXISTING DECORATIVE SOFFIT TO REMAIN

CLASSROOM

225

TO REMAIN

STAIR ST02

CORRIDOR

OFFICE

218


Jumper

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412 Meeting Street West Columbia South Carolina





29303

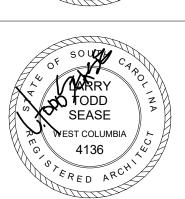DRAWN BY:

CHECKED BY:

COMM NO: DATE:

18104 12/4/2020 SHEET TITLE:

SECOND **CEILING PLAN**

SHEET NO:

CEILING PLAN GENERAL NOTES

- CONTRACTOR SHALL MARK WALLS ABOVE CEILINGS AS REQUIRED THE LOCATIONS OF EXISTING GRID, INCLUDING CEILING HEIGHT, PRIOR TO REMOVAL TO FACILITATE NEW CEILING GRID ALIGNMENT AND REINSTALLATION OF EXISTING LIGHT FIXTURES IN SAME LOCATIONS.
- REMOVE ALL EXISTING LAY-IN CEILINGS THROUGHOUT, INCLUDING GRID, TILE, AND WALL MOLD (LAY-IN CEILINGS ARE PRESENT IN ALL SPACES U.N.O.). REMOVE EXISTING GWB CEILINGS WHERE INDICATED ON CEILING AND DEMOLITION PLANS. ALL CEILING FIXTURES (LIGHTING, MECHANICAL, ETC.) SHALL BE TEMPORARILY HUNG AND REINSTALLED IN NEW CEILINGS IN SAME LOCATIONS UNLESS NOTED OTHERWISE.
- . ALL NEW CEILING HEIGHTS SHALL MATCH EXISTING HEIGHTS U.N.O. REFER TO ELECTRICAL DRAWINGS FOR ALL CEILING MOUNTED EXIT
- LIGHTS, SMOKE DETECTORS, FIRE ALARM DEVICES, ETC. FOR ITEMS NOT INDICATED ON THE REFLECTED CEILING PLAN, COORDINATE LOCATIONS WITH THE ARCHITECT PRIOR TO
- COORDINATE ALL HVAC MECHANICAL DEVICES WITH MECHANICAL
- 6. IF AS-BUILT CONDITIONS DEMAND THAT A CEILING BOARD LARGER THAN 2'-0" IN ANY DIMENSION BE USED IN THE PERIMETER BOARDS OF A TYPICAL 2'X2' GRID, THEN THAT BOARD SHALL BE CUT FROM A 2'X4' BOARD. A DOUBLE WALL ANGLE SHALL NOT BE USED IN THE CEILING GRID SYSTEM.
- CEILING SUSPENSION SYSTEM TO MEET SEISMIC REQUIREMENTS OF THE INTERNATIONAL BUILDING CODE CURRENT EDITION, AS WELL AS MANUFACTURER'S ESR REPORT, FOR SEISMIC DESIGN CATEGORY "C".
- LOCATE ALL RECESSED FIXTURES AT THE CENTERLINE OF TILE UNLESS NOTED OTHERWISE. INSTALL ALL ELECTRICAL SYSTEM COMPONENTS WITHOUT INTERFERING WITH DUCTS, PIPES, BEAMS, ETC. LOCATE LIGHT FIXTURES SYMMETRICALLY, AS DIMENSIONED, OR AS INDICATED ON THE REFLECTED CEILING PLANS. SEE ELECTRICAL DWGS. FOR FIXTURE TYPES.


- $\langle 1 \rangle$ RELOCATE EXISTING THERMOSTAT AS SHOWN ON RENOVATION FLOOR PLAN.
- $\langle 2 \rangle$ REMOVE EXISTING CEILING GRILLE AND DUCTWORK AS SHOWN.
- REMOVE EXISTING CEILING GRILLE AND VERIFY SERVICE. CAP EXISTING DUCT AT MAIN TRUNK AS REQUIRED.
- REMOVE EXISTING RUNOUT DUCT AND CEILING GRILLE. PATCH EXISTING SHEET METAL DUCT WITH GALVANIZED METAL AND SEAL WITH MASTIC. PATCH INSULATION PER SPECIFICATIONS.


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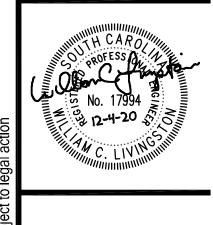
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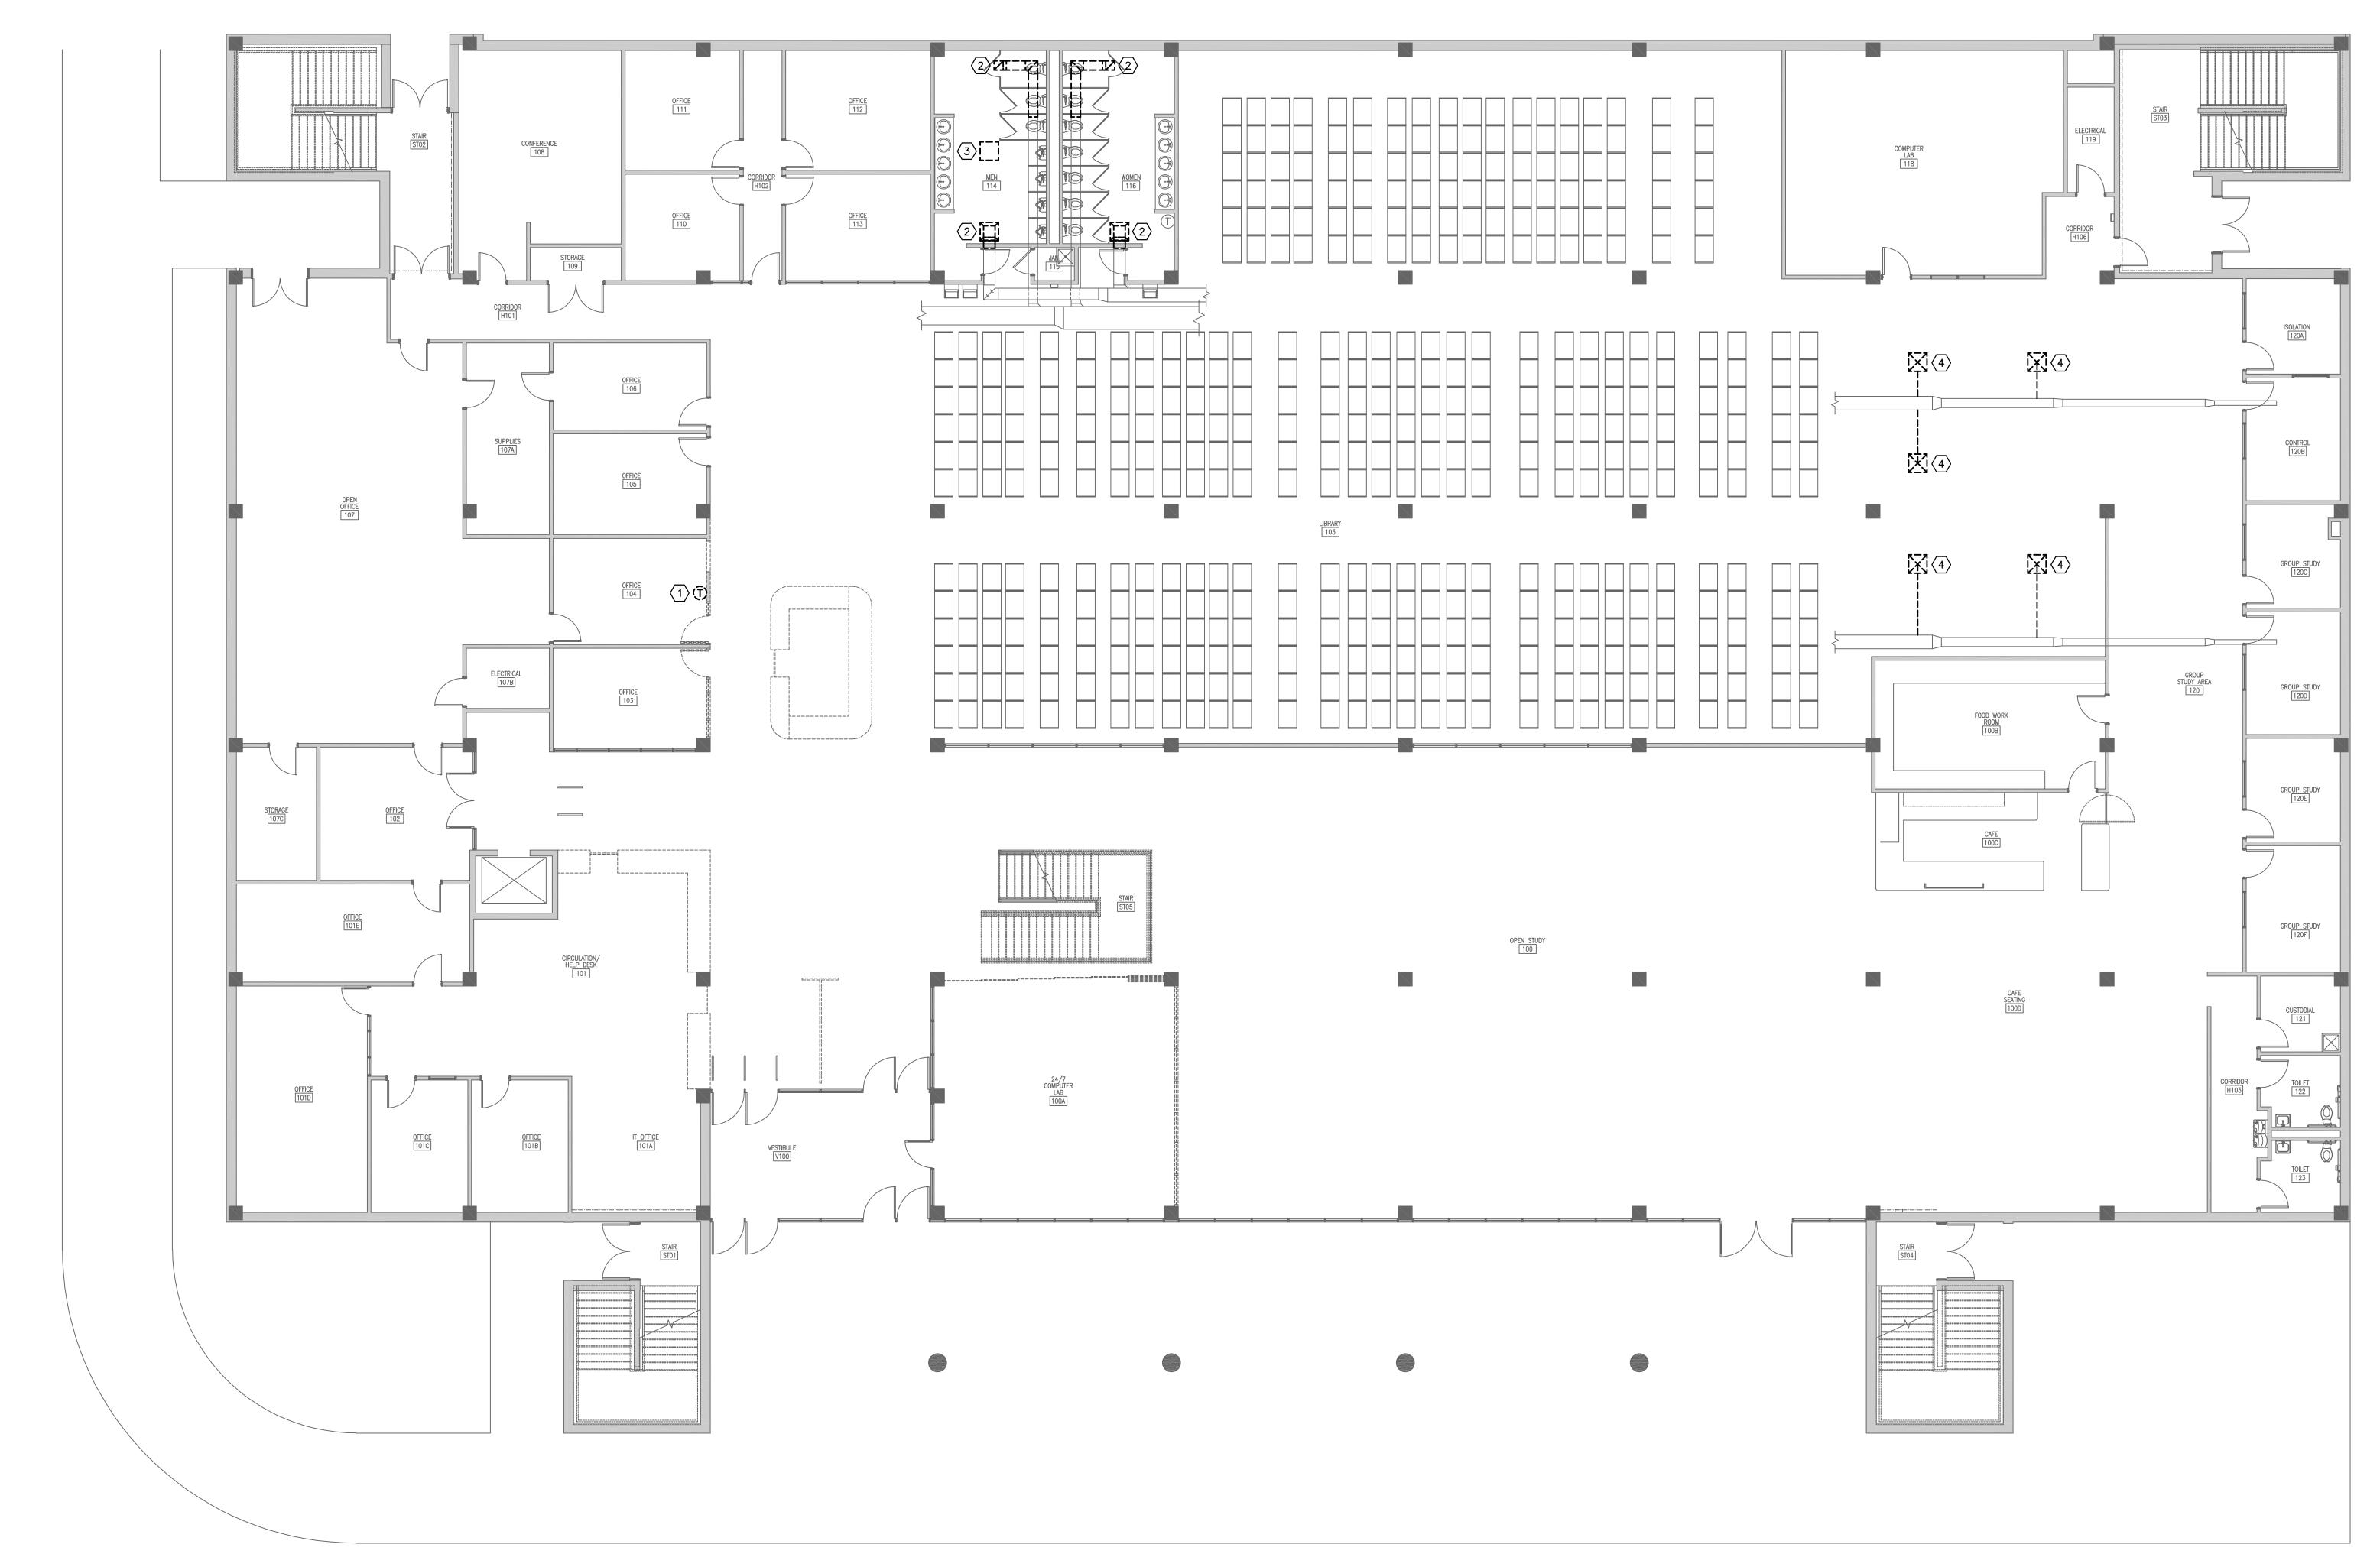
BID DOCUMENTS

12/04/2020

FIRST FLOOR DEMOLITION

T FIRST FLOOR DEMOLITION PLAN

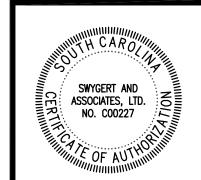MD101 SCALE: 1/8" = 1'-0"

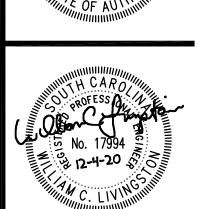

NOTE:
ALL EXISTING CEILINGS WILL BE REMOVED AND REPLACED. CONTRACTOR TO TEMPORARILY SUPPORT DIFFUSERS AND GRILLES AS REQUIRED AND INSTALL IN NEW GRID. CONTRACTOR TO SEAL DUCT AND INSULATION FOR RUNOUTS AS REQUIRED IF DAMAGED DURING CEILING

INSTALLATION.

- $\langle 1 \rangle$ RELOCATE EXISTING THERMOSTAT AS SHOWN ON RENOVATION FLOOR PLAN.
- $\langle 2 \rangle$ REMOVE EXISTING CEILING GRILLE AND DUCTWORK AS SHOWN.
- REMOVE EXISTING CEILING GRILLE AND VERIFY SERVICE. CAP EXISTING DUCT AT MAIN TRUNK AS REQUIRED.
- 4 RELOCATE EXISTING SUPPLY DIFFUSER AS SHOWN ON RENOVATION PLAN.


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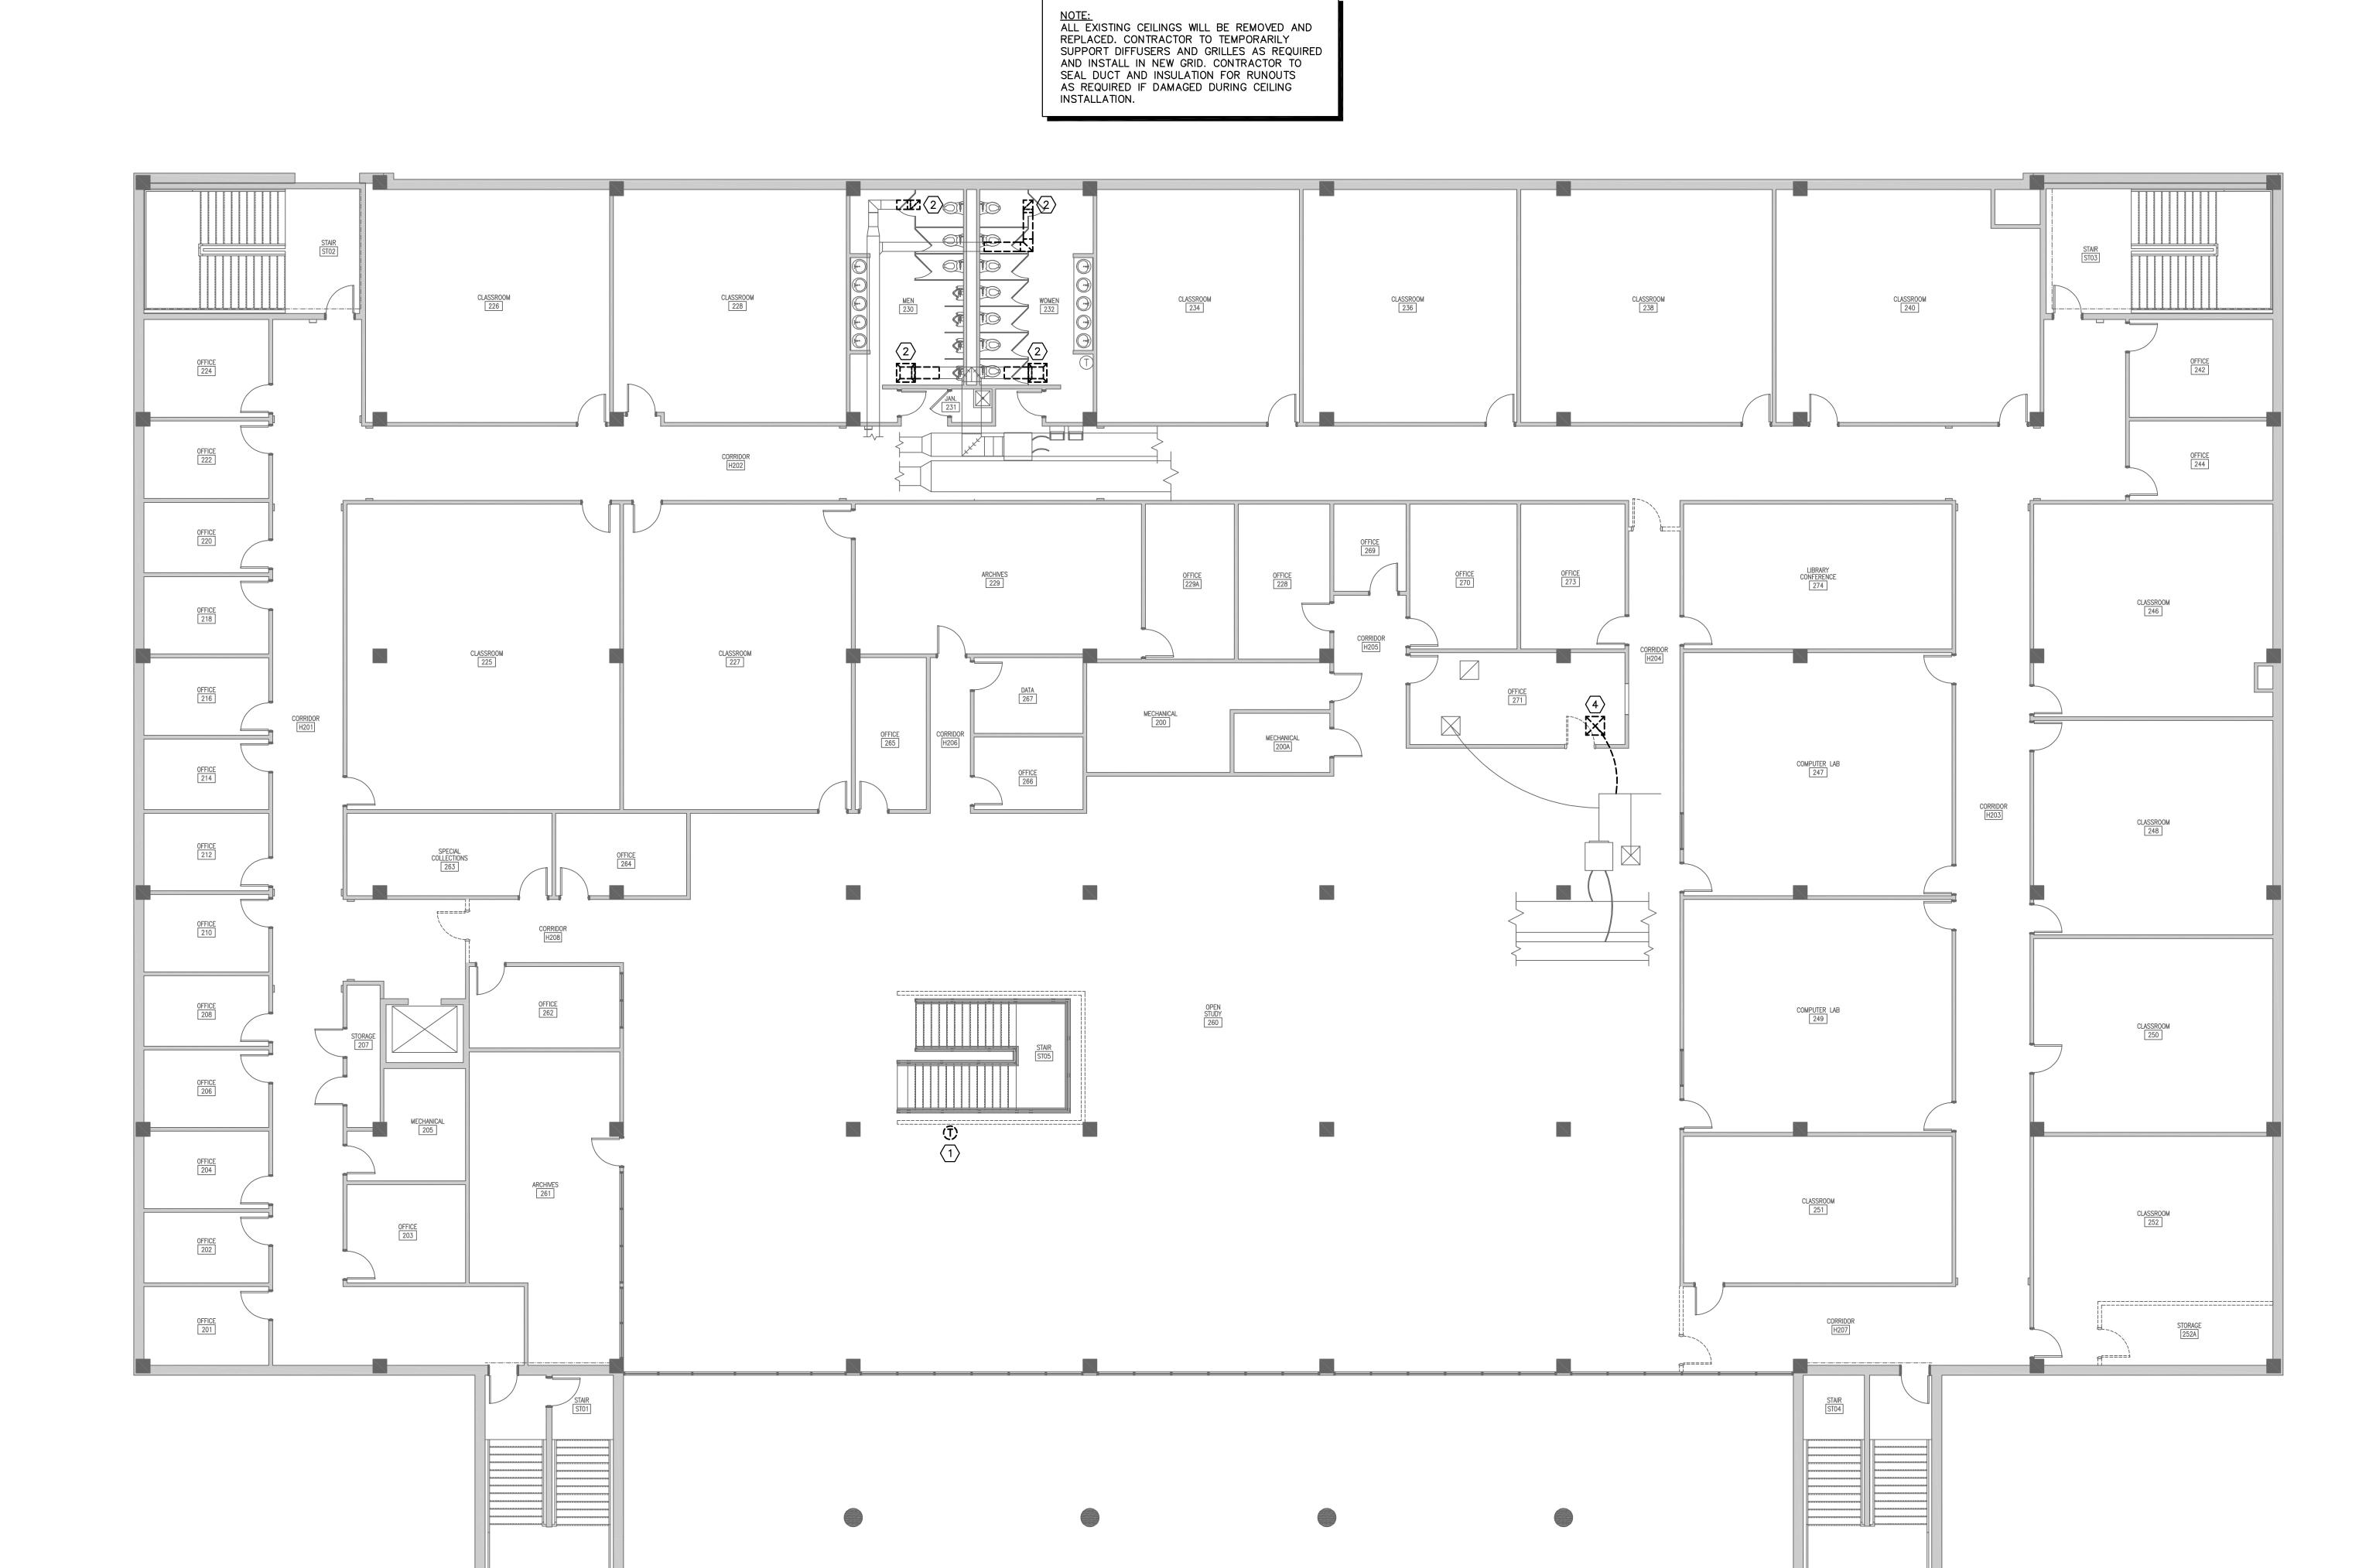
12/04/2020

SECOND FLOOR
DEMOLITION

Swygert & Associates
CONSULTING ENGINEERS DBA Swygert & Assoc., Ltd.
Post Office Box 11686
Columbia, S.C. 29211

Telephone: (803) 791-9300
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mail@swygert-associates.com



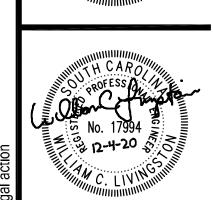







BASEMENT FLOOR PLAN - RENOVATION


SCALE: 1/8" = 1'-0"


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CHECKED BY:

12/04/2020

BASEMENT FLOOR PLANS

Swygert & Associates CONSULTING ENGINEERS

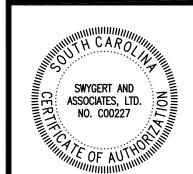NOTES TO SHEET

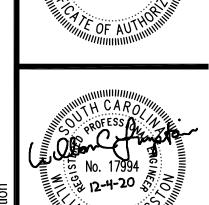1) RELOCATE THERMOSTAT TO THIS LOCATION.

ELECTRICAL 119

OFFICE (117A) (A) 150

A150


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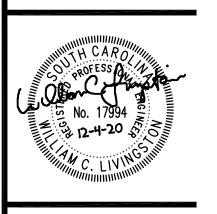
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FIRST FLOOR PLAN

NOTE:
ALL EXISTING CEILINGS WILL BE REMOVED AND REPLACED. CONTRACTOR TO TEMPORARILY SUPPORT DIFFUSERS AND GRILLES AS REQUIRED AND INSTALL IN NEW GRID. CONTRACTOR TO SEAL DUCT AND INSULATION FOR RUNOUTS AS REQUIRED IF DAMAGED DURING CEILING INSTALLATION.

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Columbia, S.C. 29211

Telephone: (803) 791-9300
Facsimile: (803) 791-0830
mail@swygert-associates.com

NOTES TO SHEET

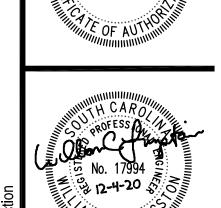(1) RELOCATE THERMOSTAT TO THIS LOCATION.

2 RELOCATE SUPPLY DIFFUSER TO THIS LOCATION.


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NBURG, SC 29303 H34-9517

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12/04/2020

SHEET TITLE:
SECOND FLOOR
PLAN

CLASSROOM 226

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CORRIDOR H202 OFFICE 244 CLASSROOM 246 OFFICE 216 MECHANICAL 200A CLASSROOM 248 CORRIDOR H206 OFFICE 204

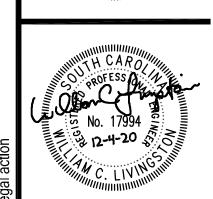
NOTE:
ALL EXISTING CEILINGS WILL BE REMOVED AND REPLACED. CONTRACTOR TO TEMPORARILY SUPPORT DIFFUSERS AND GRILLES AS REQUIRED AND INSTALL IN NEW GRID. CONTRACTOR TO SEAL DUCT AND INSULATION FOR RUNOUTS AS REQUIRED IF DAMAGED DURING CEILING INSTALLATION.

		AIR D	ISTRIB	UTION	SCHE	ULE			
TAG	DESCRIPTION	MANUFACTURER	MODEL	FRAME	CFM	NECK SIZE	FACE SIZE	MAX NC	REMARKS
A	UNI-FLOW SUPPLY	PRICE	ASPD	LAY-IN	0-125	6"ø	24"x24"	30	1, 2
B	UNI-FLOW SUPPLY	PRICE	ASPD	LAY-IN	351-600	12"ø	24"x24"	30	1, 2
0	PERFORATED EXHAUST	PRICE	APDDR	LAY-IN	0-1000	22"x22"	24"x24"	30	1, 2
0	PERFORATED RETURN	PRICE	APDDR	LAY-IN	0-1000	22"x22"	24"x24"	30	1, 2

1. PROVIDE WITH STANDARD WHITE FINISH. 2. PROVIDE ALUMINUM OR ALUMINIZED STEEL CONSTRUCTION.

LEGEND						
SYMBOL	DESCRIPTION					
(A)100	TYPE "A" DIFFUSER, 100 CFM					
T	THERMOSTAT					
\boxtimes	RECTANGULAR SUPPLY DUCTWORK					
	RETURN, EXHAUST, FRESH AIR DUCTWORK					
48×24	48"x24" RECTANGULAR DUCT					
•	CONNECTION POINT OF NEW TO EXISTING					


SPIN-IN FITTING WITH 45' EXTRACTOR AND MANUAL BALANCING DAMPER WITH L.P. SUPPLY STANDOFF LOCKING QUADRANT (INSULATED) TRUNK DUCT - ROUND SHEET METAL (INSULATED) RUNOUT (INSULATED) - FLEXIBLE DUCT RUNOUT (SAME SIZE AS DIFFUSER NECK) 8'-O" LONG MAX. RIGID ROUND SHEET METAL ELBOW (INSULATED) INSULATE BACKPAN -OF ALL DIFFUSERS AND GRILLES DIFFUSER (SEE SCHEDULE — FOR MODEL AND SIZE)

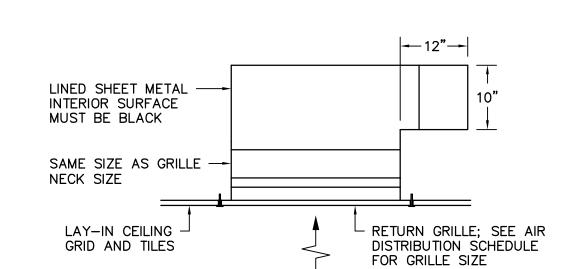

CEILING DIFFUSER DETAIL

NO SCALE

RETURN GRILLE DETAIL NO SCALE

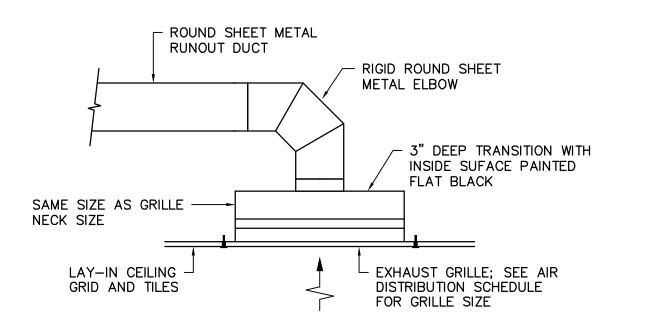

EXHAUST GRILLE DETAIL NO SCALE

GENERAL NOTES

- 1. ALL WORK SHALL BE IN ACCORDANCE WITH THE 2015 INTERNATIONAL MECHANICAL CODE, 2015 INTERNATIONAL FUEL GAS CODE, 2009 INTERNATIONAL ENERGY CONSERVATION CODE, AND 2005 SMACNA HVAC DUCT CONSTRUCTION STANDARD. ALL LOCAL CODES OR REQUIREMENTS STILL APPLY.
- 2. VISIT SITE PRIOR TO BIDDING. THIS CONTRACTOR SHALL DETERMINE DIFFICULTY OF INSTALLATION AND REFLECT THIS IN HIS BIDDING.
- 3. DO NOT SCALE DRAWINGS. SEE ARCHITECTURAL DRAWINGS AND REFLECTED CEILING PLANS FOR EXACT LOCATIONS OF DOORS, WINDOWS, AIR DISTRIBUTION,
- 4. DO NOT SCALE DRAWINGS. THIS CONTRACTOR SHALL VERIFY ALL EXISTING ITEMS
- AND LOCATIONS IN THE FIELD. 5. ALL DUCTWORK LOCATIONS SHALL BE COORDINATED WITH WORK UNDER OTHER
- 6. EXISTING PIPE, DUCTWORK, CONDUIT, ETC. THAT INTERFERES WITH THE ROUTING OF NEW SYSTEMS SHALL BE RELOCATED. THIS CONTRACTOR SHALL INCLUDE THE

DIVISIONS OF THE SPECIFICATIONS TO AVOID INTERFERENCE.

- COST OF SUCH IN HIS BID UNLESS NOTED OTHERWISE. 7. ALL DUCTWORK INSULATION SHALL BE RUN CONTINUOUSLY THROUGH PARTITIONS.
- 8. ALL MECHANICAL ITEMS EXTENDING THROUGH WALLS SHALL BE FLASHED.
- 9. SPACE ABOVE CEILING TO BE USED AS RETURN AIR PLENUM WHERE DUCT IS NOT INDICATED ABOVE RETURN AIR GRILLES.
- 10. ALL OPEN END DUCTS SHALL HAVE 1/4-INCH MESH GALVANIZED SCREEN IN REMOVABLE FRAME.
- 11. WHERE 2'X2' LAY IN GRILLES ARE SPECIFIED IN HARD CEILINGS, A PLASTER FRAME SHALL BE PROVIDED SO THE GRILLE CAN LAY IN THE CEILING.
- 12. PROVIDE FOR ACCESS TO ALL EQUIPMENT REQUIRING CLEANING OR ADJUSTMENT PER MANUFACTURER'S INSTRUCTIONS. PROVIDE FULL SPACE FOR COIL REMOVAL AND REPLACEMENT FOR ALL HOT WATER AND CHILLED WATER AIR HANDLING
- 13. THIS CONTRACTOR SHALL PROVIDE ALL ITEMS OF MISCELLANEOUS STEEL AS REQUIRED FOR INSTALLATION OF ALL MECHANICAL ITEMS.
- 14. REMOVAL AND REPLACEMENT OF CEILING, AS REQUIRED FOR INSTALLATION OF NEW WORK, SHALL BE DONE BY GENERAL CONTRACTOR.
- 15. CORRECT SETTINGS ON ALL BALANCING FITTINGS SHALL BE PERMANENTLY MARKED. PROVIDE ORANGE FLAGGING RIBBON ON EACH DAMPER HANDLE FOR EASY IDENTIFICATION.
- 16. THIS CONTRACTOR SHALL BE RESPONSIBLE FOR ANY NECESSARY DISMANTLING OF EQUIPMENT TO BE REMOVED.
- 17. ITEMS REMOVED UNDER THIS CONTRACT SHALL BECOME THE PROPERTY OF THE CONTRACTOR AND SHALL BE DISPOSED OF PROPERLY.
- 18. THIS CONTRACTOR SHALL PATCH ALL WALLS AND FINISHES TO MATCH EXISTING WHERE ALL ITEMS OR EQUIPMENT ARE REMOVED.

SPECIFICATIONS

- 1. ALL WORK SHALL BE IN ACCORDANCE WITH THE 2015 INTERNATIONAL MECHANICAL CODE, 2009 INTERNATIONAL ENERGY CONSERVATION CODE, AND 2005 SMACNA HVAC DUCT CONSTRUCTION STANDARD. ALL LOCAL CODES OR REQUIREMENTS STILL APPLY.
- 2. ALL RECTANGULAR DUCT SHALL BE TYPE G-60 GALVANIZED SHEET METAL. SEALED WITH LOW PRESSURE DUCT MASTIC. ROUND DUCTS SHALL BE GALVANIZED SHEET METAL SEALED WITH LOW PRESSURE DUCT MASTIC. LOCKING QUADRANT BALANCING DAMPERS SHALL BE INSTALLED IN EACH BRANCH TAKEOFF AT THE MAIN TRUNK DUCT. FLEXIBLE DUCT SHALL NOT EXCEED 5' IN LENGTH AND SHALL BE EQUAL TO FLEXMASTER TYPE 1M.
- 3. SUPPLY AND RETURN DUCTS SHALL BE INSULATED WITH 2" THICK, 3/4# DENSITY DUCT WRAP. DUCT WRAP SHALL BE SEALED WITH FIBERGLASS REINFÓRCING MESH, STAPLES AND MASTIC AT THE JOINTS.
- 4. SUBMIT ALL EQUIPMENT AND PRODUCTS PROPOSED TO BE USED FOR THIS PROJECT PRIOR TO ORDERING, SUBMIT SIX COPIES OF DATA SHEETS TO THE ENGINEER, BOUND IN A SINGLE VOLUME FOR APPROVAL.
- 5. SUBMIT A TEST AND BALANCE REPORT AT PROJECT COMPLETION PRIOR TO FINAL ACCEPTANCE. BALANCE FAN AIR VOLUMES TO WITHIN 5% OF DESIGN AND DIFFUSER AIR VOLUMES TO WITHIN 10% OF DESIGN.
- 6. ALL EQUIPMENT, PRODUCTS AND WORK SHALL BE GUARANTEED TO BE FREE OF DEFECTS IN MANUFACTURE AND WORKMANSHIP FOR A PERIOD OF ONE YEAR FROM THE DATE OF SUBSTANTIAL COMPLETION. ALL REPAIRS WILL BE MADE AT NO COST TO THE OWNER.


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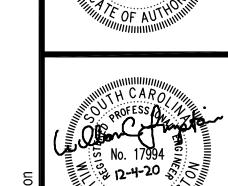
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West Columbia

South Carolina





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BID DOCUMENTS

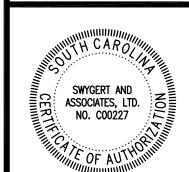DRAWN BY: CHECKED BY:

DATE: 12/04/2020

COMM NO:

SHEET TITLE: DETAILS, NOTES, SCHEDULE, AND LEGEND

SHEET NO:

M201

OCCUPANCY SENSOR NOTES:

MANUFACTURER: PRODUCTS SUPPLIED SHALL BE FROM A SINGLE MANUFACTURING THAT HAS BEEN CONTINUOUSLY INVOLVED IN THE MANUFACTURING OF OCCUPANCY SENSORS FOR A MINIMUM OF FIVE (5) YEARS. MIXING OF MANUFACTURERS SHALL NOT BE ALLOWED. FURNISH AND INSTALL SENSORS AS MANUFACTURED BY WATTSTOPPER, ACUITY, EATON, CRESTRON, OR LUTRON. ALTERNATIVE MANUFACTURERS WILL BE CONSIDERED AS OUTLINED IN SECTION 260500, PARAGRAPH 1-09 OF THE SPECIFICATIONS.

WARRANTY: ALL COMPONENTS SHALL BE U.L. LISTED, OFFER A MINIMUM FIVE (5) YEAR WARRANTY AND MEET ALL STATE AND LOCAL APPLICABLE CODE REQUIREMENTS. CONTRACTOR SHALL WARRANT ALL EQUIPMENT FURNISHED IN ACCORDANCE TO THIS SPECIFICATION TO BE UNDAMAGED, FREE OF DEFECTS IN MATERIALS AND WORKMANSHIP, AND IN CONFORMANCE WITH THE SPECIFICATIONS. THE SUPPLIER'S OBLIGATION SHALL INCLUDE REPAIR OR REPLACEMENT, AND TESTING WITHOUT CHARGE TO THE OWNER, ALL OR ANY PARTS OF EQUIPMENT WHICH ARE FOUND TO BE DAMAGED, DEFECTIVE OR NON-CONFORMING AND RETURNED TO THE SUPPLIER. THE WARRANTY SHALL COMMENCE UPON THE OWNER'S ACCEPTANCE OF THE PROJECT. WARRANTY ON LABOR SHALL BE FOR A MINIMUM PERIOD OF ONE (1) YEAR.

SUBMITTALS AND DOCUMENTATION: MANUFACTURER SHALL SUBSTANTIATE CONFORMANCE TO THIS SPECIFICATION RY SUPPLYING THE NECESSARY DOCUMENTS, PERFORMANCE DATA AND WIRING DIAGRAMS. SUBMIT A LIGHTING PLAN CLEARLY MARKED BY MANUFACTURER SHOWING PROPER PRODUCT, LOCATION, WIRING, AND ORIENTATION OF EACH SENSOR. SUBMIT STANDARD CATALOG LITERATURE WHICH INCLUDES PERFORMANCE SPECIFICATIONS INDICATING COMPLIANCE TO THE SPECIFICATION.

THE CONTRACT DOCUMENTS ARE DIAGRAMMATIC AND ONLY ESTABLISH THE MINIMUM NUMBER AND TYPE OF SENSOR REQUIRED IN EACH SPACE. THE CONTRACTOR SHALL FURNISH ADDITIONAL SENSORS AS NECESSARY TO PROVIDE THE REQUIRED COVERAGE. THE CONTRACTOR MAY NOT REDUCE THE NUMBER OF SENSORS IN A SPACE OR CHANGE THE SENSOR TYPE IN A SPACE WITHOUT WRITTEN PERMISSION FROM THE ENGINEER. IN ORDER TO PROVIDE COVERAGE FOR THE CONTROLLED AREA AND ACCOMMODATE ALL OWNER OCCUPANCY REQUIREMENTS, ALL ROOMS/SPACES SHALL HAVE BETWEEN NINETY (90) AND ONE HUNDRED (100) PERCENT COVERAGE.

OCCUPANCY SENSOR SYSTEM DESIGN IS BASED ON WATTSTOPPER SENSORS — WHERE AN ALTERNATIVE MANUFACTURER IS PROVIDED THE OCCUPANCY SENSOR SYSTEM SHALL PROVIDE COMPARABLE COVERAGE TO THE DESIGNED SYSTEM. LAYOUT OF OCCUPANCY SENSORS ON THE CONTRACT DOCUMENTS REPRESENTS THE BASIS OF DESIGN. THE OCCUPANCY SENSOR SUPPLIER SHALL FURNISH SHOP DRAWINGS AND PRINTED MATERIAL INDICATING LAYOUT OF SENSORS, RACEWAY, AND WIRING REQUIRED TO CONTROL THE LIGHTING INDICATED ON THE CONTRACT DRAWINGS. NO CHANGE ORDER WILL BE ALLOWED FOR ADDITIONAL SENSORS, RACEWAY, WIRING, POWER SUPPLIES, SATELLITE RELAYS, ETC., REQUIRED ON SHOP DRAWINGS BY THE OCCUPANCY SENSOR SUPPLIER. WHERE POWER SUPPLIES ARE REQUIRED FOR OPERATION OF THE OCCUPANCY SENSORS, BUT ARE NOT SHOWN ON THE LIGHTING PLANS, THE POWER SUPPLIES MUST BE INCLUDED AS PART OF THE BASE BID FOR THIS PROJECT. SEE OCCUPANCY SENSOR DETAILS THIS SHEET.

INSTALLATION: IT SHALL BE THE CONTRACTOR'S RESPONSIBILITY TO LOCATE AND AIM SENSORS IN THE CORRECT LOCATION REQUIRED FOR COMPLETE AND PROPER VOLUMETRIC COVERAGE WITHIN THE RANGE OF COVERAGE(S) OF CONTROLLED AREAS PER THE MANUFACTURER'S RECOMMENDATIONS. PROPER JUDGMENT MUST BE EXERCISED IN EXECUTING THE INSTALLATION SO AS TO ENSURE THE BEST POSSIBLE INSTALLATION IN THE AVAILABLE SPACE AND TO OVERCOME LOCAL DIFFICULTIES DUE TO SPACE LIMITATIONS OR INTERFERENCE OF STRUCTURAL COMPONENTS. IT SHALL BE THE CONTRACTOR'S RESPONSIBILITY TO MAKE ALL PROPER ADJUSTMENTS TO ASSURE OWNER'S SATISFACTION WITH THE OCCUPANCY SYSTEM. PROVIDE ALL POWER PACKS AND MOUNTING HARDWARE NECESSARY FOR A COMPLETE AND OPERABLE SYSTEM.

LOW VOLTAGE WIRING: ALL LOW VOLTAGE WIRING FOR OCCUPANCY SENSOR APPLICATIONS SHALL BE RUN IN METAL CONDUIT, EXCEPT AS NOTED BELOW.

LOW VOLTAGE WIRING FOR OCCUPANCY SENSORS MAY BE RUN WITHOUT CONDUIT ABOVE ACCESSIBLE ACOUSTICAL GRID CEILINGS PROVIDED THE WIRING IS PLENUM RATED AND IS INSTALLED AND SUPPORTED IN ACCORDANCE WITH THE REQUIREMENTS OF NEC 725.24 AND 300.4(D).

POWER SUPPLIES: FURNISH, INSTALL, AND WIRE POWER PACKS PER THE MANUFACTURER'S INSTRUCTIONS POWER PACKS ARE NOT SHOWN ON DRAWINGS BUT ARE REQUIRED. SEE OCCUPANCY SENSOR DETAILS AND TYPICAL LIGHTING WIRING PLANS FOR ADDITIONAL INFORMATION. POWER SUPPLIES SHALL BE LOCATED ABOVE THE ROOM SWITCH LOCATION UNLESS NOTED OTHERWISE ON THE DRAWINGS. OCCUPANCY SENSOR POWER SUPPLIES TO BE MOUNTED IN A SEPARATE JUNCTION BOX AS NOTED ON DETAIL, EXCEPT AS NOTED BELOW.

WHERE MOUNTED CONCEALED ABOVE ACCESSIBLE CEILINGS OCCUPANCY SENSOR POWER SUPPLIES MAY BE MOUNTED ADJACENT TO A JUNCTION BOX PER THE MANUFACTURER'S INSTRUCTIONS PROVIDED THE HOUSING IS UL 2043 PLENUM RATED.

OCCUPANCY SENSOR TIME DELAY SETTINGS: FIELD VERIFY DELAY SETTINGS FOR ALL OCCUPANCY SENSORS WITH THE OWNER PRIOR TO FINAL SETUP. RECOMMENDED DELAY SETTINGS ARE AS FOLLOWS:

- SET DELAY FOR ALL OCCUPANCY SENSORS LOCATED IN CORRIDORS, LOBBIES, LOCKER ROOMS, SHOWER ROOMS, GYMS, AND THE CAFETERIA TO 30 MINUTES UNLESS NOTED OTHERWISE ON THE DRAWINGS (FIELD
- SET DELAY FOR ALL OCCUPANCY SENSORS LOCATED IN GROUP TOILETS, STAIRS, OTHER COMMON AREAS,
- THE MEDIA CENTER, AND SCIENCE LABORATORIES TO 20 MINUTES UNLESS NOTED OTHERWISE ON THE DRAWINGS (FIELD VERIFY WITH OWNER).
- SET DELAY FOR ALL OTHER OCCUPANCY SENSORS TO 10 MINUTES UNLESS NOTED OTHERWISE ON THE DRAWINGS (FIELD VERIFY WITH OWNER).

<u>DUAL TECHNOLOGY SENSORS:</u> SET TRIGGER FOR DUAL TECHNOLOGY SENSORS SO BOTH TECHNOLOGIES ARE REQUIRED TO TRIGGER ON, EITHER TECHNOLOGY IS REQUIRED TO HOLD ON, AND EITHER TECHNOLOGY IS REQUIRED TO RETRIGGER ON (5 SECOND DURATION).

<u>VERIFICATION AND TRAINING:</u> IT SHALL BE THE MANUFACTURER'S RESPONSIBILITY TO VERIFY ALL PROPER ADJUSTMENTS AND TRAIN OWNER'S PERSONNEL TO ENSURE OWNERS SATISFACTION WITH THE OCCUPANCY SYSTEM. THIS SERVICE SHALL BE PROVIDED AT NO ADDITIONAL COST TO THE OWNER OR THE ARCHITECT/ENGINEER. TRAINING SESSION TO INCLUDE REPRESENTATIVES FROM THE END USER, THE OWNER, THE ENGINEER, AND THE OWNER'S MAINTENANCE PERSONNEL. THE TRAINING SESSION SHALL NOT BE SCHEDULED UNTIL AFTER COMMISSIONING HAS BEEN COMPLETED AND HAS BEEN REVIEWED IN WRITING BY THE ENGINEER. THE TRAINING SESSION MUST BE SCHEDULED IN WRITING A MINIMUM OF TEN DAYS IN ADVANCE — FAILURE TO DO SO MAY RENDER THE TRAINING NULL & VOID AND REQUIRE RE-TRAINING AT NO ADDITIONAL COST TO THE OWNER OR THE ARCHITECT/ENGINEER.

COMMISSIONING: UPON COMPLETION OF THE INSTALLATION, THE OCCUPANCY SENSORS SHALL BE COMPLETELY COMMISSIONED BY THE MANUFACTURER'S FACTORY AUTHORIZED TECHNICIAN WHO WILL VERIFY ALL ADJUSTMENTS AND SENSOR PLACEMENT TO ENSURE A TROUBLE-FREE OCCUPANCY-BASED LIGHTING CONTROL SYSTEM. THIS SERVICE IS PROVIDED AT NO ADDITIONAL COST TO THE OWNER. THE ELECTRICAL CONTRACTOR SHALL PROVIDE BOTH THE MANUFACTURER AND THE ELECTRICAL ENGINEER WITH TEN WORKING DAYS WRITTEN NOTICE OF THE SCHEDULED COMMISSIONING DATE - FAILURE TO DO SO MAY RENDER THE COMMISSIONING NULL & VOID AND REQUIRE RE-COMMISSIONING AT NO ADDITIONAL COST TO THE OWNER. UPON COMPLETION OF THE SYSTEM FINE TUNING THE FACTORY AUTHORIZED TECHNICIAN SHALL PROVIDE THE PROPER TRAINING TO THE OWNER'S PERSONNEL IN THE ADJUSTMENT AND MAINTENANCE OF THE SENSORS (SEE ABOVE). COMMISSIONING AND TRAINING SHALL NOT BE PROVIDED UNTIL INSTALLATION IS COMPLETE. SEE LOW VOLTAGE SWITCHING SYSTEM

SPECIFICATIONS AND NOTES FOR ADDITIONAL LIGHTING CONTROLS COMMISSIONING REQUIREMENTS.

<u>FINAL REVIEW:</u> A FINAL REVIEW OF THE ELECTRICAL INSTALLATION BY THE ENGINEER CANNOT BE PROVIDED UNTIL THE OCCUPANCY SENSOR INSTALLATION HAS BEEN PROPERLY COMMISSIONED. THE CONTRACTOR SHALL PROVIDE WRITTEN DOCUMENTATION TO THE ENGINEER THAT THE OCCUPANCY SENSOR COMMISSIONING AND TRAINING HAS BEEN PROVIDED PRIOR TO REQUESTING A FINAL REVIEW.

SUSTAINABLE DESIGN PROJECTS: FOR PROJECTS PURSUING LEED OR GREEN GLOBES CERTIFICATION. COMMISSIONING OF LIGHTING CONTROLS SHALL INCLUDE DETAILED DOCUMENTATION OF LIGHTING CONTROLS SETUP AND PROGRAMMING, AND COORDINATION WITH THE OWNER'S LEED CONSULTANT. THE SPECIFIED COMMISSIONING AND DOCUMENTATION FOR LIGHTING CONTROLS INCLUDES THE LOW VOLTAGE CONTROLS SPECIFIED HEREIN AND THE OCCUPANCY SENSORS SPECIFIED ON THE DRAWINGS.

LIGHTING SYMBOLS

RECESSED FIXTURE, WIRE THRU GREENFIELD FROM OUTLET BOX ABOVE CEILING, PROVIDE AS SCHEDULED. "NL" DENOTES FIXTURE WIRED TO A SEPARATE 24/7 NIGHT LIGHT CIRCUIT. HALF-SHADED FIXTURE DENOTES EMERGENCY LIGHTING FIXTURE. PROVIDE EMERGENCY BALLASTS OF GENERATOR TRANSFER DEVICES WHERE SCHEDULED.

WALL OR CEILING MOUNTED LED EXIT LIGHT, SHADED AREA DENOTES FACE. WALL OR CEILING MOUNTED LED EXIT LIGHT, SHADED AREA DENOTES FACE.

WALL MOUNTED EMERGENCY LIGHTING FIXTURE. PROVIDE AS SCHEDULED.

SINGLE POLE SWITCH, 20A, 120/277V, 48" AFF TO TOP OF OUTLET BOX. SUBSCRIPT DENOTES OUTLETS CONTROLLED. WP DENOTES SWITCH WITH LOCKABLE SHALLOW N-USE STYLE WEATHERPROOF COVER PLATE, SEE 260500.

SAME, EXCEPT THREE WAY.

SAME, EXCEPT FOUR WAY. SAME, EXCEPT SINGLE POLE KEYED SWITCH, 20A, 120/277V, 48" AFF.

120/277V. 0—10V LED WALL BOX DIMMER WITH INTEGRAL ON/OFF BUTTON. 48" AFF TO TOP OF OUTLET BOX. RATING=1200W (120V) & 1660W (277V). ON/OFF TO BE ACCOMPLISHED WITHOUT THE USE OF SEPARATE POWER PACKS, UNLESS NOTED OTHERWISE. GREENGATE WBSD-010SLD OR EQUIVALENT OF WATTSTOPPER, ACUITY, CRESTRON, LEVITON, OR LUTRON. SEE DETAIL ON E605

SAME, EXCEPT WIRED PER THE MANUFACTURER'S INSTRUCTIONS FOR FOR THREE WAY SWITCHING. SLIDE-TO-OFF WALL BOX DIMMER, 48" AFF TO TOP OF OUTLET BOX. "DE" DENOTES ELECTRONIC LOW VOLTAGE DIMMER, "DM" DENOTES MAGNETIC VOLTAGE DIMMER, "600", "1000", "1500", OR S₆₀₀ "2000" DENOTES 600W, 1000W, 1500W, OR 2000W INCANDESCENT DIMMER. LUTRON NOVA T SERIES, OR EQUIVALENT. ALL DIMMERS TO BE SLIDE-TO-OFF UNLESS NOTED OTHERWISE. WALL MOUNTED IR SENSOR WITH BUILT-IN SWITCH, 48" AFF. SEE OCCUPANCY SENSOR DETAILS.

WALL MOUNTED PRESET COUNTDOWN TIME SWITCH, 48" AFF. SEE OCCUPANCY SENSOR DETAILS. WATTSTOPPER RT-50 OR EQUIVALENT OF ACUITY, EATON, CRESTRON, OR LUTRON.

WATTSTOPPER PW-100 (A) OR PW-200 (AB), OR EQUIVALENT OF ACUITY, EATON, CRESTRON,

(DT) CEILING MOUNTED 360° DUAL TECHNOLOGY OCCUPANCY SENSOR. FURNISH, INSTALL, AND WIRE POWER PACK(S) PER THE MANUFACTURER'S INSTRUCTIONS. POWER PACKS NOT SHOWN ON DT WG DRAWINGS, BUT ARE REQUIRED, SEE OCCUPANCY SENSOR DETAILS AND NOTES FOR ADDITIONAL NFORMATION. WATTSTOPPER DT-300 (1000SF) WITH BZ-150 POWER PACK(S), OR EQUIVALENT OF ACUITY, EATON, CRESTRON, OR LUTRON. "WG" DENOTES WIRE GUARD.

CEILING MOUNTED 360° INFRARED TECHNOLOGY OCCUPANCY SENSOR. FURNISH. INSTALL. AND WIRE POWER PACK(S) PER THE MANUFACTURER'S INSTRUCTIONS. POWER PACKS NOT SHOWN ON DRAWINGS, BUT ARE REQUIRED, SEE OCCUPANCY SENSOR DETAILS AND NOTES FOR ADDITIONAL NFORMATION. WATTSTOPPER CI-300-1 (IR. 500SF) AND CI-300 (IR2, 1200SF) WITH BZ-150 POWER PACK(S), OR EQUIVALENT OF ACUITY, EATON, CRESTRON, OR LUTRON.

(UT) CEILING MOUNTED 360° ULTRASONIC SENSOR, FURNISH, INSTALL, AND WIRE POWER PACK(S) PER THE MANUFACTURER'S INSTRUCTIONS. POWER PACKS NOT SHOWN ON DRAWINGS, BUT ARE REQUIRED, SEE OCCUPANCY SENSOR DETAILS AND NOTES FOR ADDITIONAL INFORMATION. ARROWS DENOTE SENSOR FOR CORRIDORS WITH 90° LINEAR COVERAGE PATTERN. WATTSTOPPER UT-300-3 (2000SF OR 90LF) WITH BZ-150 POWER PACK(S), OR EQUIVALENT OF ACUITY, EATON, CRESTRON, OR LUTRON.

LIGHTING FIXTURE SCHEDULE NOTES

- FIXTURE BODIES MANUFACTURED FROM PRE-PAINTED STEEL SHALL BE PAINTED AFTER FABRICATION, UNLESS
- WARRANTY FOR ALL LED FIXTURES SHALL BE A MINIMUM OF 10-YEARS FROM DATE OF SUBSTANTIAL COMPLETION UNLESS NOTED OTHERWISE.
- 3. REFER TO LUMINAIRE SCHEDULE FOR LED DESIGN CRITERIA (DELIVERED LUMENS, LUMENS PER WATT, CRI, COLOR TEMPERATURE, LUMEN MAINTENANCE FACTOR). LISTED CRITERIA REPRESENTS THE MINIMUM ACCEPTABLE VALUES. FIXTURES NOT MEETING THE LISTED MINIMUM REQUIREMENTS ARE NOT ACCEPTABLE.
- 4. REFER TO ARCHITECTURAL DRAWINGS FOR CEILING SCHEDULE AND/OR REFLECTED CEILING PLAN.
- WIRE RECESSED LED OR FLUORESCENT FIXTURES THRU GREENFIELD FROM OUTLET BOX ABOVE CEILING. EXCEPT THAT TYPE MC CABLE MAY BE USED FOR LIGHT FIXTURE WIRING ABOVE ACCESSIBLE LAY-IN CEILINGS.
- 6. PULL UNSWITCHED HOT LEG, SAME CIRCUIT IN ROOM, TO ALL EXIT LIGHTS AND EMERGENCY BATTERY LIGHTS AS REQUIRED. ALL EMERGENCY BATTERIES SHALL BE SEALED, MAINTENANCE—FREE, HIGH TEMPERATURE NICKEL CADMIUM BATTERIES, UNLESS NOTED.
- WHERE SPECIFIED FOR DIGITAL SWITCHING SYSTEMS, LOW VOLTAGE LIGHTING CONTROL SYSTEMS, AND OCCUPANCY SENSORS - PROVIDE ALL POWER PACKS, POWER SUPPLIES, RELAYS, PROGRAMMING, CABLING, MOUNTING HARDWARE, ETC. NECESSARY TO PROVIDE COMPLETE AND OPERABLE LIGHTING CONTROL SYSTEMS.
- 8. FIXTURE MOUNTING HEIGHTS REFER TO ARCHITECTURAL DRAWINGS & ELEVATIONS FOR MOUNTING HEIGHTS OF WALL MOUNTED LIGHT FIXTURES. MOUNTING HEIGHTS INDICATED ON ELECTRICAL DRAWINGS ARE FOR BIDDING PURPOSES, FIELD VERIFY ALL MOUNTING HEIGHTS WITH ARCHITECT PRIOR TO ROUGH-IN.
- 9. 0-10V LED DIMMERS SHALL INCLUDE AN INTEGRAL ON/OFF SWITCH UNLESS NOTED OTHERWISE. 10. PROVIDE SEPARATE SHOP DRAWING SUBMITTALS FOR LIGHT FIXTURES AND LIGHTING CONTROLS AS INDICATED IN
- SECTION 260510. 11. LIGHT FIXTURES MOUNTED IN ACOUSTICAL CEILING GRID OR SIMILAR CEILING SYSTEMS SHALL BE SECURELY FASTENED TO THE CEILING FRAMING MEMBER BY MECHANICAL MEANS SUCH AS BOLTS, SCREWS, RIVETS, OR LISTED CLIPS PER THE REQUIREMENTS OF NEC 410.36(B), WITHIN 6" OF EACH CORNER.
- 12. ALL SCREWS, BOLTS, ETC. FOR LIGHT FIXTURES LOCATED OUTDOORS SHALL BE STAINLESS STEEL, INCLUDING MOUNTING HARDWARE FOR LIGHT FIXTURE ACCESSORIES.

SCOPE OF WORK

THE WORK OF THIS SECTION SHALL PROVIDE COMPLETE ELECTRICAL SYSTEMS FOR WORK AS SPECIFIED HEREIN AND SHALL INCLUDE THE PROVIDING OF ALL CONDUCTORS, RACEWAYS, FITTINGS, CIRCUIT PROTECTIVE DEVICES, LIGHT FIXTURES, FIRE ALARM DEVICES, BOXES, SUPPORTS, AND ALL ASSOCIATED APPURTENANCES AND MISCELLANEOUS EQUIPMENT NECESSARY, ALL OF WHICH SHALL BE COMPLETELY CONNECTED, TESTED, ADJUSTED AND LEFT IN PROPER OPERATING CONDITION. THE ELECTRICAL SYSTEM TO BE PROVIDED SHALL INCLUDE SERVICE AND DISTRIBUTION FACILITIES POWER FOR MOTOR OPERATED EQUIPMENT, LIGHTING SYSTEMS, AND ALL OUTLETS AS COVERED HEREINAFTER.

GENERAL NOTES:

- ALL ELECTRICAL WORK SHALL BE PERFORMED IN STRICT ACCORDANCE WITH THE 2017 NATIONAL ELECTRICAL CODE (NEC), THE 2018 INTERNATIONAL BUILDING CODE (IBC), AND ANY LOCAL CODES, LAWS AND ORDINANCES WHICH MAY APPLY. WHERE DIFFERENCES EXIST BETWEEN THE CODES, THE STRICTER CODE SHALL APPLY.
- 2. ALL CONDUITS SHALL CONTAIN A GROUNDING CONDUCTOR REGARDLESS OF USE.
- THE CONTRACTOR FOR THE WORK UNDER THIS SECTION SHALL PROCURE AND PAY FOR ALL PERMITS, FEES, AND LICENSES REQUIRED FOR THE EXECUTION OF THIS WORK. SATISFACTORY EVIDENCE OF COMPLIANCE WITH THE REQUIREMENT AND ALL CERTIFICATES OF INSPECTION SHALL BE DELIVERED TO THE OWNER PROMPTLY UPON REQUEST.
- TYPE MC CABLE MAY BE USED FOR INTERIOR, CONCEALED BRANCH CIRCUITS. HOMERUNS SHALL BE IN METALLIC CONDUIT. WHERE CABLE WOULD OTHERWISE BE EXPOSED, IT SHALL BE INSTALLED IN CONDUIT. REDHEAD BUSHINGS SHALL BE PROVIDED AT EACH CABLE TERMINATION. TYPE MC MAY NOT BE USED UNDERGROUND OR UNDER SLAB. TYPE MC CABLE MAY NOT PENETRATE RATED
- ALL LOW VOLTAGE WIRING FOR OCCUPANCY SENSOR APPLICATIONS SHALL BE RUN IN METAL CONDUIT.
- 6. UNLESS OTHERWISE NOTED FOR 120-VOLT, 20-AMP CKTS: #10 AWG SHALL BE USED FOR HOMERUNS LONGER THAN 75 FEET #12 AWG SHALL BE USED FOR HOMERUNS 75 FEET OR SHORTER
- MULTIWIRE BRANCH CIRCUITS USING A SHARED OR COMMON NEUTRAL ARE NOT PERMITTED ON THIS PROJECT. THE CONTRACTOR SHALL PULL A SEPARATE NEUTRAL FOR ALL 120V AND 277V CIRCUITS.
- 8. MOUNT RECEPTACLES 16" AFF UNLESS OTHERWISE NOTED.
- 9. ALL LIGHT SWITCHES AND RECEPTACLES SHALL BE BY THE SAME MANUFACTURER. COVER PLATES SHALL BE JUMBO STAINLESS STEEL DEVICE COLOR TO BE SELECTED BY THE ARCHITECT UNLESS STATED WITH THE DEVICE SYMBOL.
- 10. ELECTRICAL METALLIC TUBING AND RIGID GALVANIZED STEEL CONDUIT SHALL BE THE ONLY TYPES OF CONDUIT INSTALLED WITHIN THE BUILDING. PVC IS PERMITTED UNDERGROUND.
- BRANCH CIRCUITS SHALL BE RUN CONCEALED WHERE PRACTICAL. BRANCH CIRCUITS RUN EXPOSED TO WEATHER ON EXTERIOR WALL OR ON ROOFS SHALL BE RUN IN GRC OR IMC WITH SCREWED FITTINGS. BRANCH CIRCUITS RUN CONCEALED IN WALLS OR CEILINGS SHALL BE RUN IN EMT, GRC, OR IMC. BRANCH CIRCUITS RUN EXPOSED IN DRY, FINISHED SPACES SHALL BE RUN IN WIREMOLD SURFACE METAL RACEWAY. BRANCH CIRCUITS RUN EXPOSED IN DAMP LOCATIONS, UNFINISHED SPACES (ATTICS), AND UNOCCUPIED SPACES (STORAGE ROOM, EQUIPMENT ROOMS, JANITOR'S CLOSET, ETC.) MAY BE RUN IN EMT IN LIEU OF WIREMOLD.
- 12. CONDUIT HOMERUNS TO PANELBOARDS AND CONDUITS SHOWN WITH MULTIPLE CIRCUITS SHALL BE 3/4" MINIMUM, OTHERWISE RACEWAYS SHALL BE 1/2" MINIMUM, EXCEPT THAT FLEXIBLE CONDUIT SHALL BE 3/8" MINIMUM.
- 13. INTERIOR CONDUIT HOMERUNS TO PANELBOARDS SHALL BE RUN OVERHEAD IN EMT, GRC, OR IMC UNLESS NOTED OTHERWISE ON TH
- 14. FIRE ALARM SYSTEM CONDUITS AND COMMUNICATIONS SYSTEM CONDUITS TO BE EMT RUN OVERHEAD CONCEALED IN WALLS OR CEILING UNLESS NOTED OTHERWISE.
- 15. ALL FIRE RATED WALLS, FLOORS, ETC WHICH HAVE A CONDUIT OR OTHER ELECTRICAL PENETRATION SHALL BE SEALED TO EQUAL THE RATING OF THE WALL, FLOOR, ETC. THAT IS PENETRATED. CONTRACTOR SHALL USE A U.L. RATED AND LISTED ASSEMBLY FOR THE SEALING MATERIAL AND METHOD. COORDINATE MANUFACTURER WITH THE GENERAL CONTRACTOR SO THAT ALL TRADES ON THE PROJECT USE THE SAME MANUFACTURER. THROUGH PENETRATIONS OF CONDUITS AND CABLES OF FIRE RESISTANCE RATED WALLS MUST COMPLY WITH SECTION 714.3.1 OF THE IBC. THROUGH PENETRATIONS OF FIRE RESISTANCE CEILING ASSEMBLIES MUST COMPLY WITH SECTION 714.4.1.1 OF THE IBC.
- 16. ALL OUTLET BOXES 4"x4" OR SMALLER LOCATED ON OPPOSITE SIDES OF A RATED WALL SHALL HAVE A MINIMUM OF 24" HORIZONTAL SPACING OR SHALL BE PROTECTED WITH LISTED PUTTY PADS. ALL OUTLET BOXES LARGER THAN 4"x4" (COMMUNICATIONS OUTLETS. ETC.) LOCATED IN RATED WALLS SHALL BE PROTECTED WITH LISTED PUTTY PADS.
- REFER TO ARCHITECTURAL DRAWINGS FOR DIMENSIONS, LOCATIONS, CABINETS, ETC.
- 18. CONCEAL ALL CONDUIT AND FITTINGS EXCEPT WHERE THE ARCHITECT GRANTS SPECIFIC PERMISSION.
- 19. ALL WORK AND MATERIALS SHALL BE GUARANTEED FOR ONE YEAR FROM DATE OF ACCEPTANCE.
- 20. PROVIDE ONE COMPLETE SET OF ELECTRICAL DRAWINGS MARKED UP FOR RECORD DRAWINGS. SHOW ALL LOCATIONS OF EQUIPMENT
- 21. INSTALL ALL MATERIALS PER MANUFACTURER'S INSTRUCTIONS.
- 22. IDENTIFY MAJOR EQUIPMENT INSTALLED WITH LAMICOR LABELS (SEE SPECS). PROVIDE FLASH HAZARD SIGN AT ALL ELECTRICAL PANELS. PROVIDE A TYPED DIRECTORY IN ALL PANEL BOARDS CLEARLY DESCRIBING THE LOCATION OF AND TYPE OF LOAD BEING SERVED FOR ALL CIRCUITS.
- 23. VISIT SITE TO DETERMINE EXISTING CONDITIONS PRIOR TO SUBMITTING BID.
- 24. ALL RACEWAYS, FIXTURES, WIRING, DEVICES, AND EQUIPMENT RENDERED USELESS BY THIS WORK SHALL BE REMOVED AND DELIVERED TO THE OWNER'S STORAGE FACILITY AS DIRECTED. ANY MATERIAL NOT WANTED BY THE OWNER SHALL BE DISPOSED OF BY THE CONTRACTOR. 25. ELECTRICAL CONTRACTOR SHALL DO ALL CUTTING AND PATCHING AS REQUIRED TO INSTALL HIS WORK. FINISH PATCHING AND
- PAINTING WILL BE DONE BY THE GENERAL CONTRACTOR.
- 26. CONDUITS TO BE RUN UNDER WALKWAYS AND PAVINGS SHALL BE INSTALLED BY JACKING OR BORING, UNLESS NOTED. DO NOT CUT WALKWAYS OR PAVEMENTS, UNLESS ACCEPTABLE TO THE ENGINEER. ALLOWED CUTS IN PAVEMENT OR CONCRETE SHALL BE MADE USING A PAVEMENT SAW, AND SHALL BE PATCHED TO MATCH THE EXISTING SURFACE.
- 27. WHERE DISAGREEMENTS EXISTS ON THE DESIGN DOCUMENTS, THE ITEM OR ARRANGEMENTS OF BETTER QUALITY, GREATER QUANTITY, OR HIGHER COST SHALL BE INCLUDED IN THE BASE BID. ANY DISCREPANCIES BETWEEN THE DRAWINGS, SPECIFICATIONS, AND FIELD CONDITIONS SHALL BE RESOLVED WITH THE ENGINEER PRIOR TO COMMENCING WORK. ALL AGREEMENTS SHALL BE VERIFIED IN
- 28. ALL WORK UNDER THIS SECTION SHALL BE COORDINATED WITH OTHER TRADES TO INSURE PROPER LOCATION OF OUTLETS AND EQUIPMENT CONNECTIONS, AND TO MINIMIZE CONFLICTS WITH STRUCTURAL MEMBERS, DUCT WORK, PIPING, ETC. CONFLICTS BETWEEN EQUIPMENT AND/OR MATERIAL LOCATIONS SHALL BE CORRECTED AS DIRECTED BY THE ARCHITECT—ENGINEER AT NO ADDITIONAL COST TO THE OWNER.

ELECTRICAL SUBMITTALS

ELECTRICAL SHOP DRAWINGS SHALL BE SUBMITTED IN ONE COMPLET PACKAGE CONTAINING ALL ITEMS REQUIRED BY THE ELECTRICAL DRAWINGS AND THE DIVISION 26-28 SPECIFICATIONS. PARTIAL SHOP DRAWING SUBMITTALS MAY BE REJECTED BY THE ARCHITECT-ENGINEER. REFER TO SECTION 260510 OF THE ELECTRICAL SPECIFICATIONS FOR REQUIRED SUBMITTAL FORMAT AND FOR ADDITIONAL REQUIREMENTS.

ALTERNATES

ALTERNATES: REFER TO SECTION 012300 — ALTERNATES FOR ALTERNATI DESCRIPTIONS. REFER TO SECTION 260500 FOR BRIEF DESCRIPTIONS OF ALTERNATES WITH ELECTRICAL RAMIFICATIONS. WHERE CONFLICTS EXIST, SECTION 012300 SHALL SUPERSEDE THE DESCRIPTIONS.

ABBREVIATIONS

- LTG LIGHTING
- AFF ABOVE FINISHED FLOOR MFR MANUFACTURER AFG ABOVE FINISHED GRADE
- MLO MAIN LUGS ONLY AWG AMERICAN WIRE GAUGE
- NEC NATIONAL ELECTRICAL CODE AHJ AUTHORITY HAVING
- NEMA NATIONAL ELECTRICAL JURISDICTION MANUFACTURERS ASSOCIATION CKT CIRCUIT
- NIC NOT IN CONTRACT CU COPPER
- PH,Ø PHASE EC EMPTY CONDUIT RCPT RECEPTACLE
- EQPT EQUIPMENT RE: REFER TO
- TYP TYPICAL FWE FURNISHED WITH EQUIPMENT UNO UNLESS NOTED OTHERWISE
- GFI GROUND FAULT INTERRUPTER VOLTS IAW IN ACCORDANCE WITH
- W WIRE OR WATTS KVA KILOVOLTAMPERES
- WP WEATHERPROOF KW KILOWATTS

ELECTRICAL DEMOLITION NOTES

- IT IS THE GENERAL INTENTION OF THESE DRAWINGS TO COVER ALL SITUATIONS WHERE AN ITEM IS TO BE REMOVED, WHETHER IT HAPPENS TO BE A LIGHT FIXTURE, DUPLEX RECEPTACLE, LIGHT SWITCH, FIRE ALARM DEVICE, OR OTHER ELECTRICAL ITEM. THE ELECTRICAL CONTRACTOR SHALL ASSIST THE MECHANICAL AND GENERAL CONTRACTORS IN REMOVAL OF EQUIPMENT WITH ELECTRICAL CONNECTIONS BEING REMOVED BY THESE CONTRACTORS.
- B. PRIOR TO SUBMITTING BID, THE CONTRACTOR SHALL SURVEY THE EXISTING BUILDING AND MAKE NOTE OF ANY ADDITIONAL DEMOLITION AND/OR ANY ADDITIONAL REMOVAL AND RELOCATION WHICH MAY BE REQ'D IN ORDER TO ACCOMPLISH RENOVATIONS INDICATED IN CONTRACT DOCUMENTS. NO CHANGE ORDER WILL BE ISSUED FOR ADDITIONAL WORK REQUIRED FOR DEMOLITION, REMOVAL, OR RELOCATION WORK NOT INDICATED ON THESE DRAWINGS BUT NECESSARY TO COMPLETE
- IN ALL AREAS WHERE EXISTING WALLS ARE BEING REMOVED, NEW WALLS ARE BEING ADDED. AND WHERE OTHER DEMOLITION WORK IS OCCURRING, REMOVE ALL EXISTING RECEPTACLES, LIGHTS, AND OTHER ELECTRICAL DEVICES, AND ALL WIRING AND CONDUIT NOT BEING REUSED. EXISTING CONDUIT RUN CONCEALED IN EXISTING WALLS NOT BEING REMOVED AND/OR REPLACED MAY BE ABANDONED. ALL DEMOLITION MUST BE COORDINATED WITH THE ARCHITECT AND WITH ALL OTHER TRADES TO AVOID CONFLICTS. REFER TO THE ARCHITECTURAL DEMOLITION PLAN.
- NO EXISTING ELECTRICAL MATERIALS, EQUIPMENT, WIRING, OR CONDUIT BEING REMOVED MAY BE REUSED ON THIS PROJECT UNLESS SPECIFICALLY NOTED OTHERWISE ON THESE DRAWINGS. ALL EXISTING ELECTRICAL MATERIALS AND EQUIPMENT NOT BEING REUSED SHALL BE DISPOSED OF AS INDICATED IN GENERAL NOTES.
- EXTEND, REPAIR OR REWIRE ANY CIRCUIT BROKEN BY DEMOLITION NOT TO BE ABANDONED.

SPARE PARTS:

- ADDITIONAL EXIT LIGHTS: THE ELECTRICAL CONTRACTOR SHALL FURNISH AND INSTALL ADDITIONAL EXIT LIGHTS AT THE DISCRETION OF THE ARCHITECT/ENGINEER AND/OR THE AUTHORITY HAVING JURISDICTION IN THE FOLLOWING
- (4) WALL OR CEILING MOUNTED TYPE XC LED EXIT LIGHTS
- INCLUDE COMPLETE COSTS TO FURNISH AND INSTALL THE ABOVE ADDITIONAL EXIT LIGHTS IN BASE BID. INCLUDING ALL CONDUIT, OUTLET BOXES, 120V POWER, AND WIRING. ANY DEVICES NOT USED SHALL BE TURNED OVER TO THE OWNER AS SPARE DEVICES AT THE END OF THE PROJECT.

LIGHTING FIXTURE SCHEDULE TYPE | SYMBOL DESCRIPTION MODELWATTSVOLTSNOTE 1 2x4 SPEC GRADE RECESSED LED FIXTURE WITH 0-10V DIMMING | WILLIAMS LT-24-L52/840-AF-EQCLIPS-DIM-UNV (1) LED MULTIPLE A50 CAPABILITY AND THE FOLLOWING MINIMUM CRITERIA: 5000 OR EQUIVALENT OF LITHONIA 2BLT4 SERIES, METALUX CRUZE SERIES LUMEN OUTPUT, 125LPW, 80CRI, 4000K. COLUMBIA LCAT SERIES, OR DAYBRITE EVOGRID SERIES WILLIAMS LT-24-L52/840-AF-EQCLIPS-DIM-UNV A50EB (1) LED SAME AS TYPE A50 EXCEPT FIXTURE TO INCLUDE A 10W MULTIPLE EMERGENCY LED DRIVER WITH INTEGRAL TEST SWITCH AND OR EQUIVALENT OF LITHONIA 2BLT4 SERIES | SELF-DIAGNOSTICS. OR METALUX CRUZE SERIES 2x2 SPEC GRADE RECESSED LED FIXTURE WITH 0-10V DIMMING | WILLIAMS LT-22-L39/840-AF-(L33)-EQCLIPS-DIM-UNV B33 MULTIPLE OR EQUIVALENT OF LITHONIA 2BLT4 SERIES, METALUX CRUZE SERIES CAPABILITY AND THE FOLLOWING MINIMUM CRITERIA: 3300 LUMEN OUTPUT, 120LPW, 80CRI, 4000K. COLUMBIA LCAT SERIES, OR DAYBRITE EVOGRID SERIES B39 (1) LED 2x2 SPEC GRADE RECESSED LED FIXTURE WITH 0-10V DIMMING | FIDELUX FFP22-30W-40-UNV-D MULTIPLE WIRE FOR 0-10V DIMMING WHERE NOTED. CAPABILITY AND THE FOLLOWING MINIMUM CRITERIA: 3900 OR EQUIVALENT OF LITHONIA EPANL SERIES, METALUX 24FP SERIES, OR COLUMBIA CFP SERIES LUMEN OUTPUT, 115LPW, 80CRI, 4000K. B39EM (1) LED SAME AS TYPE B39 EXCEPT FIXTURE TO INCLUDE A 10W FIDELUX FFP22-30W-40-UNV-D MULTIPLE WIRE FOR 0-10V DIMMING WHERE NOTED. EMERGENCY LED DRIVER WITH INTEGRAL TEST SWITCH AND OR EQUIVALENT OF LITHONIA EPANL SERIES, | SELF-DIAGNOSTICS. METALUX 24FP SERIES, OR COLUMBIA CFP SERIES (1) LED CEILING MOUNT SINGLE FACE LED EXIT SIGN WITH EVEN EMERGILITE ELX400-RN MULTIPLE

EQUIVALENT OF CHLORIDE, LIGHTALARMS, OR DUALLITE

ILLUMINATION RED DIFFUSER, WHITE THERMOPLASTIC HOUSING, AC | LITHONIA LQM-S-W-3-R-120/277, SURELITES LPX-6

Jumper

ELECTRICAL SHEET LIST

E001 - ELECTRICAL SYMBOLS & NOTES

E102 - SECOND FLOOR LIGHTING PLAN

E101 - FIRST FLOOR LIGHTING

E201 - BASEMENT POWER PLAN

E202 - FIRST FLOOR POWER PLAN

E203 — SECOND FLOOR POWER PLAN


E601 - POWER RISER, PANEL SCHEDULES AND DETAILS


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South Carolina

412 Meeting Street West Columbia



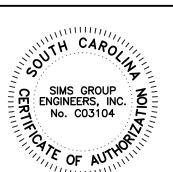

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12/4/2020

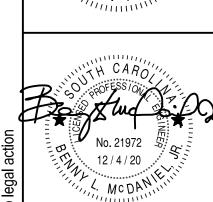C20065

SIMS GROUP ENGINEERS, INC. 800 Columbiana Drive, Suite 208 Irmo, South Carolina 29063 Phone: (803) 765-1007 Fax: (803) 765-1030 www.simsgroupusa.com

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1ST FLOOR LIGHTING PLAN

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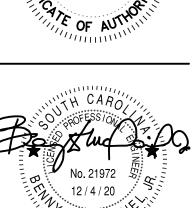
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29303 STATE INFORMATION RESOURCE CEN RENOVATIONS GRAMLING DRIVE, SPARTANBURG, SC STATE PROJECT NO.: H34-9517

DRAWN BY:

CHECKED BY: BLM COMM NO: 18104 DATE: 12/4/2020

SHEET TITLE:

2ND FLOOR LIGHTING PLAN

BID SET C20065 SIMS GROUP ENGINEERS, INC. 800 Columbiana Drive, Suite 208

Irmo, South Carolina 29063 Phone: (803) 765-1007 Fax: (803) 765-1030

E102

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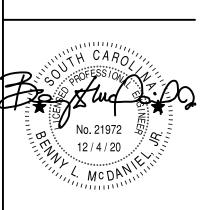
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12/4/2020

BASEMENT POWER PLAN

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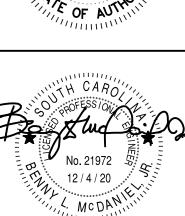
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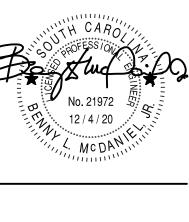
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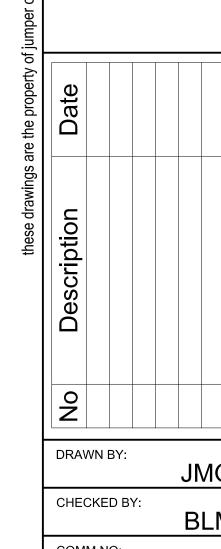
412 Meeting Street West Columbia South Carolina







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COMM NO: DATE: 12/4/2020

1ST FLOOR POWER PLAN

BID SET SIMS GROUP ENGINEERS, INC. 800 Columbiana Drive, Suite 208 Irmo, South Carolina 29063
Phone: (803) 765-1007 Fax: (803) 765-1030
www.simsgroupusa.com

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412 Meeting Street West Columbia South Carolina





29303 STATE INFORMATION RESOURCE CEN RENOVATIONS GRAMLING DRIVE, SPARTANBURG, SC STATE PROJECT NO.: H34-9517


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2ND FLOOR POWER PLAN

1 2ND FLOOR POWER PLAN
SCALE: 1/8"=1'-0"





EQUAL EQUAL
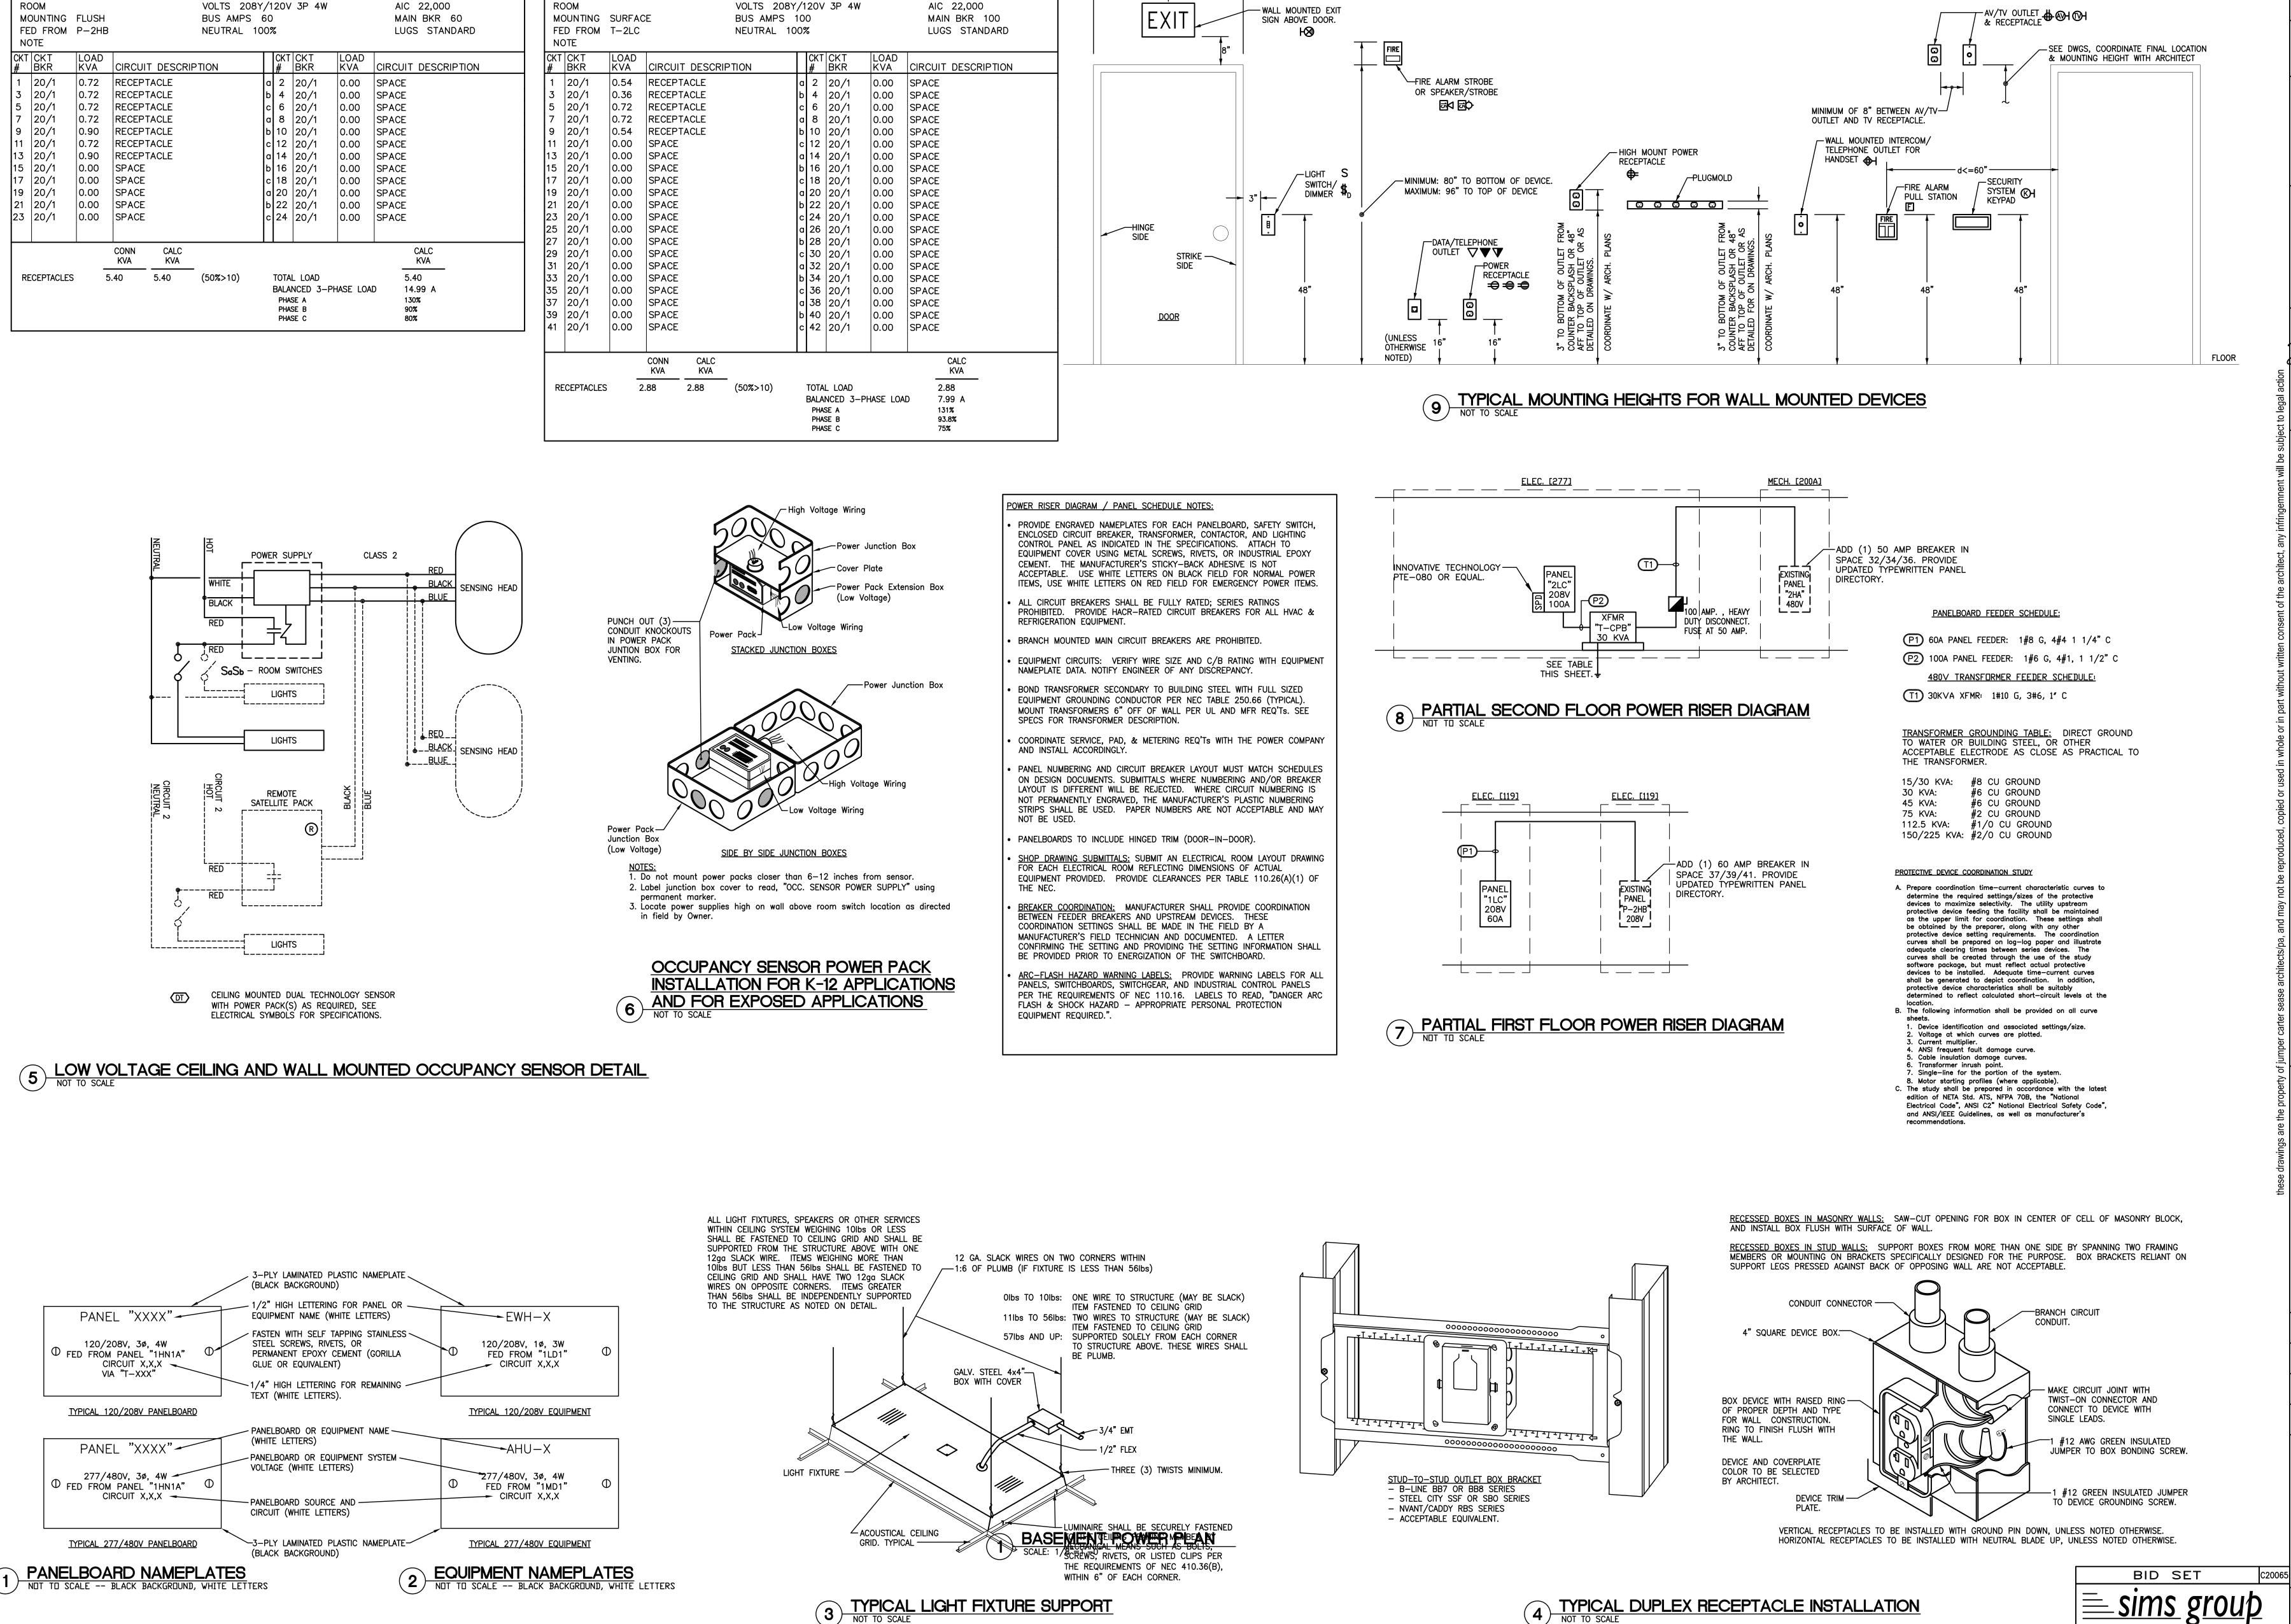
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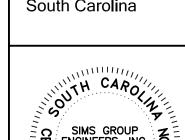
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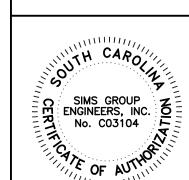
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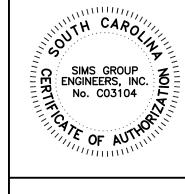
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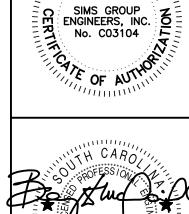
ARCHITECTS


412 Meeting Street West Columbia South Carolina










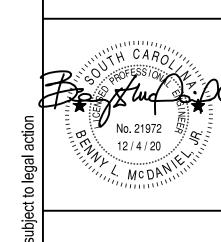

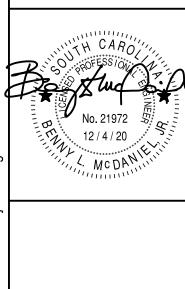

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18104 12/4/2020 SHEET TITLE: PARTIAL POWER RISER DIAGRAM AND

SCHEDULES

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