ART, HUMANITIES AND SOCIAL SCIENCES BUILDING

BUILDING CODE SUMMARY

NOTE TO AUTHORITY HAVING JURISDICTION - THIS IS AN INTERIOR RENOVATION OF THE MAIN CORRIDORS FOR FINISHES ONLY; INTERIOR RENOVATION OF 2 GANG TOILETS, FINISHES AND FIXTURES.

PROJECT INFORMATION

INTERIOR RENOVATIONS FOR ARTS, HUMANITIES, SOCIAL SCIENCES BUILDING NAME OF PROJECT: AIKEN, SOUTH CAROLINA ADDRESS: EXISTING EDUCATION BUILDING PROPOSED USE: OWNER OR AUTHORIZED AGENT: UNIVERSITY OF SOUTH CAROLINA AIKEN CODE ENFORCEMENT JURISDICTION: OFFICE OF THE STATE ENGINEER

PROJECT DESIGN TEAM

DESIGNER	FIRM	CONTACT	PHONE #
ARCHITECTURAL:	STUDIO 2LR, INC.		(803) 233-6602
CIVIL:			()
STRUCTURAL:			()
PLUMBING:	SWYGERT AND ASSOCIATES. LTD.	TODD SWYGERT	(803) 791-9300
FIRE PROTECTION:	<u></u>		()
MECHANICAL:	SWYGERT AND ASSOCIATES, LTD.	BILL LIVINGSTON	(803) 791-9300
SPRINKLER-STANDPIPE:			()
ELECTRICAL:	GWA ENGINEERING	DICKSON O'BRIEN	(803) 252-6919
OTHER:			()

CODE COMPLIANCE

SHEET NO.

AD103

ARCHITECTURE

PLUMBING

MECHANICAL

ED02A

ELECTRICAL

ELECTRICAL DEMOLITION

ARCHITECTURAL DEMOLITION

COVER SHEET

DEMOLITION PLANS

DEMOLITION PLANS

FLOOR PLAN - FIRST

FLOOR PLAN - SECOND

FINISH SPECIFICATIONS

FLOOR PLANS

ALTERNATE #1

ALTERNATE #1

ENLARGED DEMOLITION PLANS

REFLECTED CEILING PLAN - FIRST

REFLECTED CEILING PLAN - SECOND ENLARGED PLANS TOILET 211 and 213

1ST FLR FINISH SCHEDULE AND PLAN 2ND FLR FINISH SCHEDULE AND PLAN

DETAILS, NOTES, SCHEDULE, & LEGEND

FIRST FLOOR ELECTRICAL DEMOLITION PLANS - BASE BID

SECOND FLOOR ELECTRICAL DEMOLITION PLANS -

ELECTRICAL NOTES, SCHEDULES, AND DETAILS - 1

ELECTRICAL NOTES, SCHEDULES, AND DETAILS - 2

SECOND FLOOR ELECTRICAL PLAN - NEW WORK -

FIRST FLOOR ELECTRICAL PLANS - NEW WORK - BASE BID SECOND FLOOR ELECTRICAL PLAN - NEW WORK - BASE BID

FLOOR PLANS, NOTES, AND DETAILS

INTERNATIONAL BUILDING CODE: INTERNATIONAL PLUMBING CODE: INTERNATIONAL MECHANICAL CODE: INTERNATIONAL FIRE CODE: 2018 EDITION WITH SC MODIFICATIONS NATIONAL ELECTRIC CODE: 2017 EDITION INTERNATIONAL ENERGY CONSERVATION CODE 2009 EDITION ADA STANDARDS FOR ACCESSIBLE DESIGN

DRAWING LIST

SHEET NAME

BUILDING DATA

CONSTRUCTION TYPE (TABLE 503): STANDPIPES: FIRE DISTRICT: EXIST. 40 FEET NUMBER OF STORIES **BUILDING HEIGHT** HIGH RISE: **GROSS BUILDING AREA:** EXISTING (SQ. FT.) 18,430 1ST FLOOR

SCHOLAR LOOP

EXIT REQUIREMENTS

2ND FLOOR

NUMBER AND ARRANGEMENTS OF EXITS **EXISTING EXITS TO REMAIN**

EXISTING EXIT WIDTH TO REMAIN

20 MINUTE RATED DOORS.

EXISTING CORRIDORS ARE 1 HOUR FIRE RATED WITH

PLUMBING FIXTURE REQUIREMENTS

EXISTING PLUMBING FIXTURE COUNTS TO REMAIN, REPLACEMENT OF EXISTING FIXTURES AND FINISHES.


ABBREVIATIONS

	/\BBI\LVI	/ () () (<u> </u>
#	POUND OR NUMBER	GA.	GAUGE
&	AND	GALV.	GALVANIZED
@	AT	GYP.	GYPSUM
A.C.T.	ACOUSTICAL CEILING TILE	GYP. BRD.	GYPSUM WALLBOARD
A.F.F.	ABOVE FINISHED FLOOR	H.	HIGH
ALUM.	ALUMINUM	H.M.	HOLLOW METAL
ANOD.	ANODIZED	HVAC	HEATING, VENTILATION, AND AIR CONDITIONING
APPROX.	APPROXIMATE	INSUL.	INSULATION
B.O.	BOTTOM OF	MAX.	MAXIMUM
C.I.P.	CAST IN PLACE	M.O.	MASONRY OPENING
C.J.	CONTROL JOINT	MECH.	MECHANICAL
CLG.	CEILING	MIN.	MINIMUM
CLR.	CLEAR	MTL.	METAL
CMU	CONCRETE MASONRY UNIT	N.I.C.	NOT IN CONTRACT
COL.	COLUMN	NO.	NUMBER
CONC.	CONCRETE	NOM.	NOMINAL
CONT.	CONTINUOUS	O.C.	ON CENTER
CPT.	CARPET	O.H.	OVERHEAD
C.T.	CERAMIC TILE	O.P.C.I.	OWNER PROVIDED CONTRATOR INSTALLED
DEMO	DEMOLISH	OPP. HAND	
DIA.	DIAMETER	PLYWD.	PLYWOOD
DIM.	DIMENSION	P.T.	PRESSURE TREATED
DIMS.	DIMENSIONS	PVC	POLYVINYL CHLORIDE
DN.	DOWN	R.C.P.	REFLECTED CEILING PLAN
DR.	DOOR	R.D.	ROOF DRAIN
DWG.	DRAWING	REQD.	REQUIRED
EA.	EACH	RM.	ROOM
ELEC.	ELECTRICAL	SIM.	SIMILAR
ELEV.	ELEVATION OR ELEVATOR	SS	STAINLESS STEEL
EPDM	ETHYLENE PROPYLENE DIENE M-CLASS (ROOFING)	STL.	STEEL
EQ.	EQUAL	STRUCT.	STRUCTURAL
EXIST.	EXISTING	T	TEMPERED
EXP. JT.	EXPANSION JOINT	T&G_	TONGUE AND GROOVE
EXT.	EXTERIOR	TELE.	TELEPHONE
E.W.C.	ELECTRIC WATER COOLER	TLT.	TOILET
F.D.	FLOOR DRAIN	T.O.	TOP OF
F.E.	FIRE EXTINGUISHER	T.O.S.	TOP OF STEEL
F.E.C.	FIRE EXTINGUISHER CABINET	TYP.	TYPICAL
FLR.	FLOOR	U.O.N.	UNLESS OTHERWISE NOTED
F.O.	FACE OF	V.I.F.	VERIFY IN FIELD
		W.	WIDTH








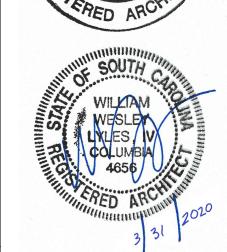


DRAWING CONVENTIONS


REFERENCE SYMBOLS


VIEW INDICATOR **NORTH ARROW ELEVATION INDICATOR** ELEVATION REVISION CLOUD

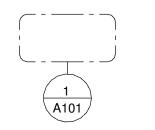

IDENTITY SYMBOLS

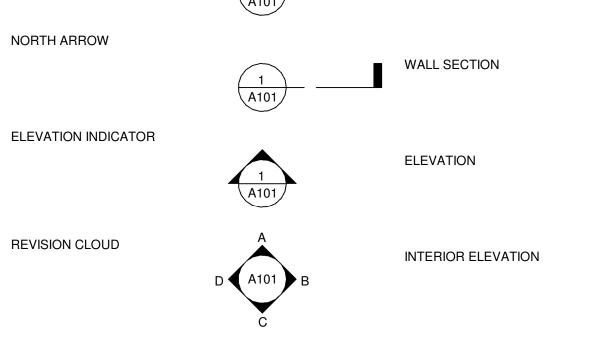


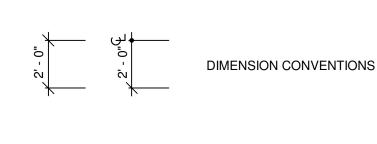

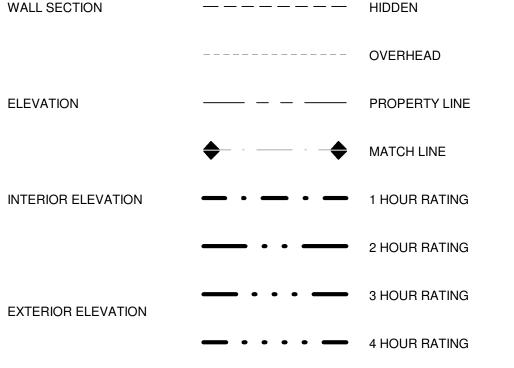

— — — — DEMOLISHED

LINE SYMBOLS

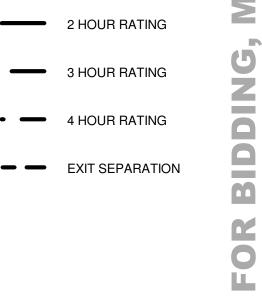

NO. DATE DESCRIPTION

REVISIONS

PROJECT NUMBER 19063

CURRENT

CURRENT REVISION

REVISION DATE

SCHOLAR LOOP

2 CAMPUS PLAN 1" = 200'-0"

UNLIMITED PER _

BLOWUP DETAIL

COLUMN GRID


SLOPE CONVENTION

BUILDING SECTION

DATE 3/31/2020


COVER SHEET

SHEET NAME

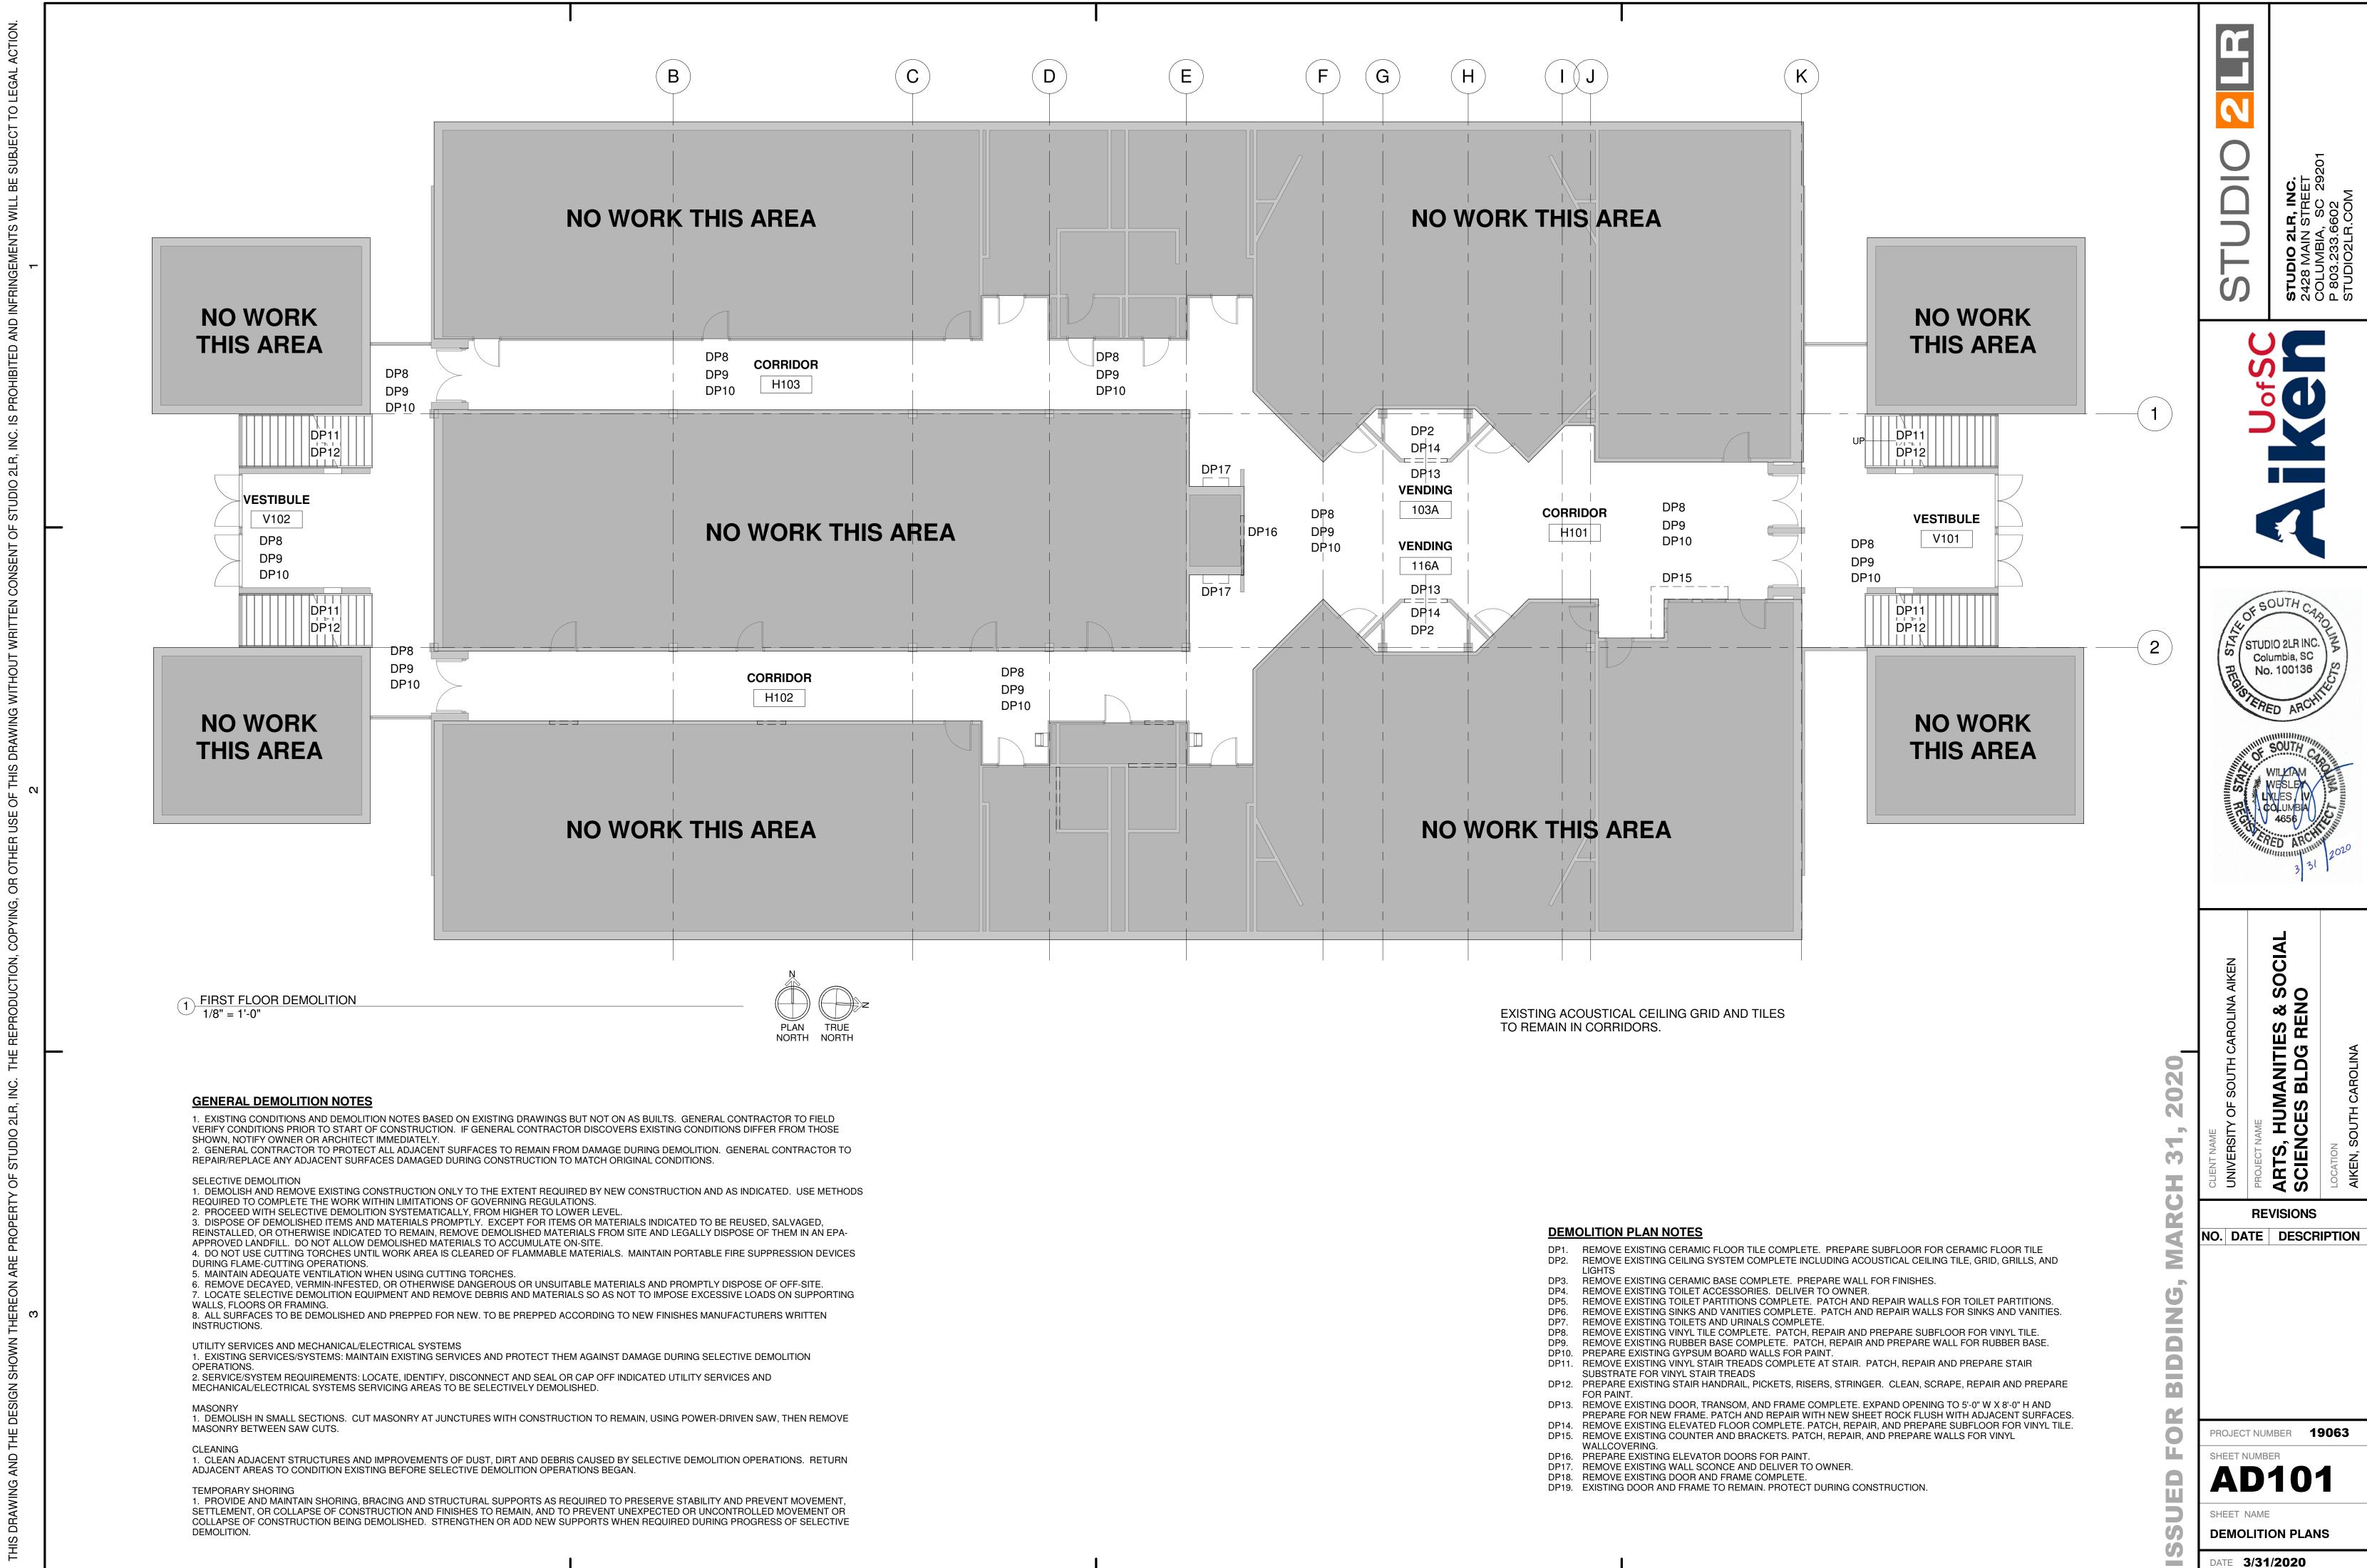

C

D

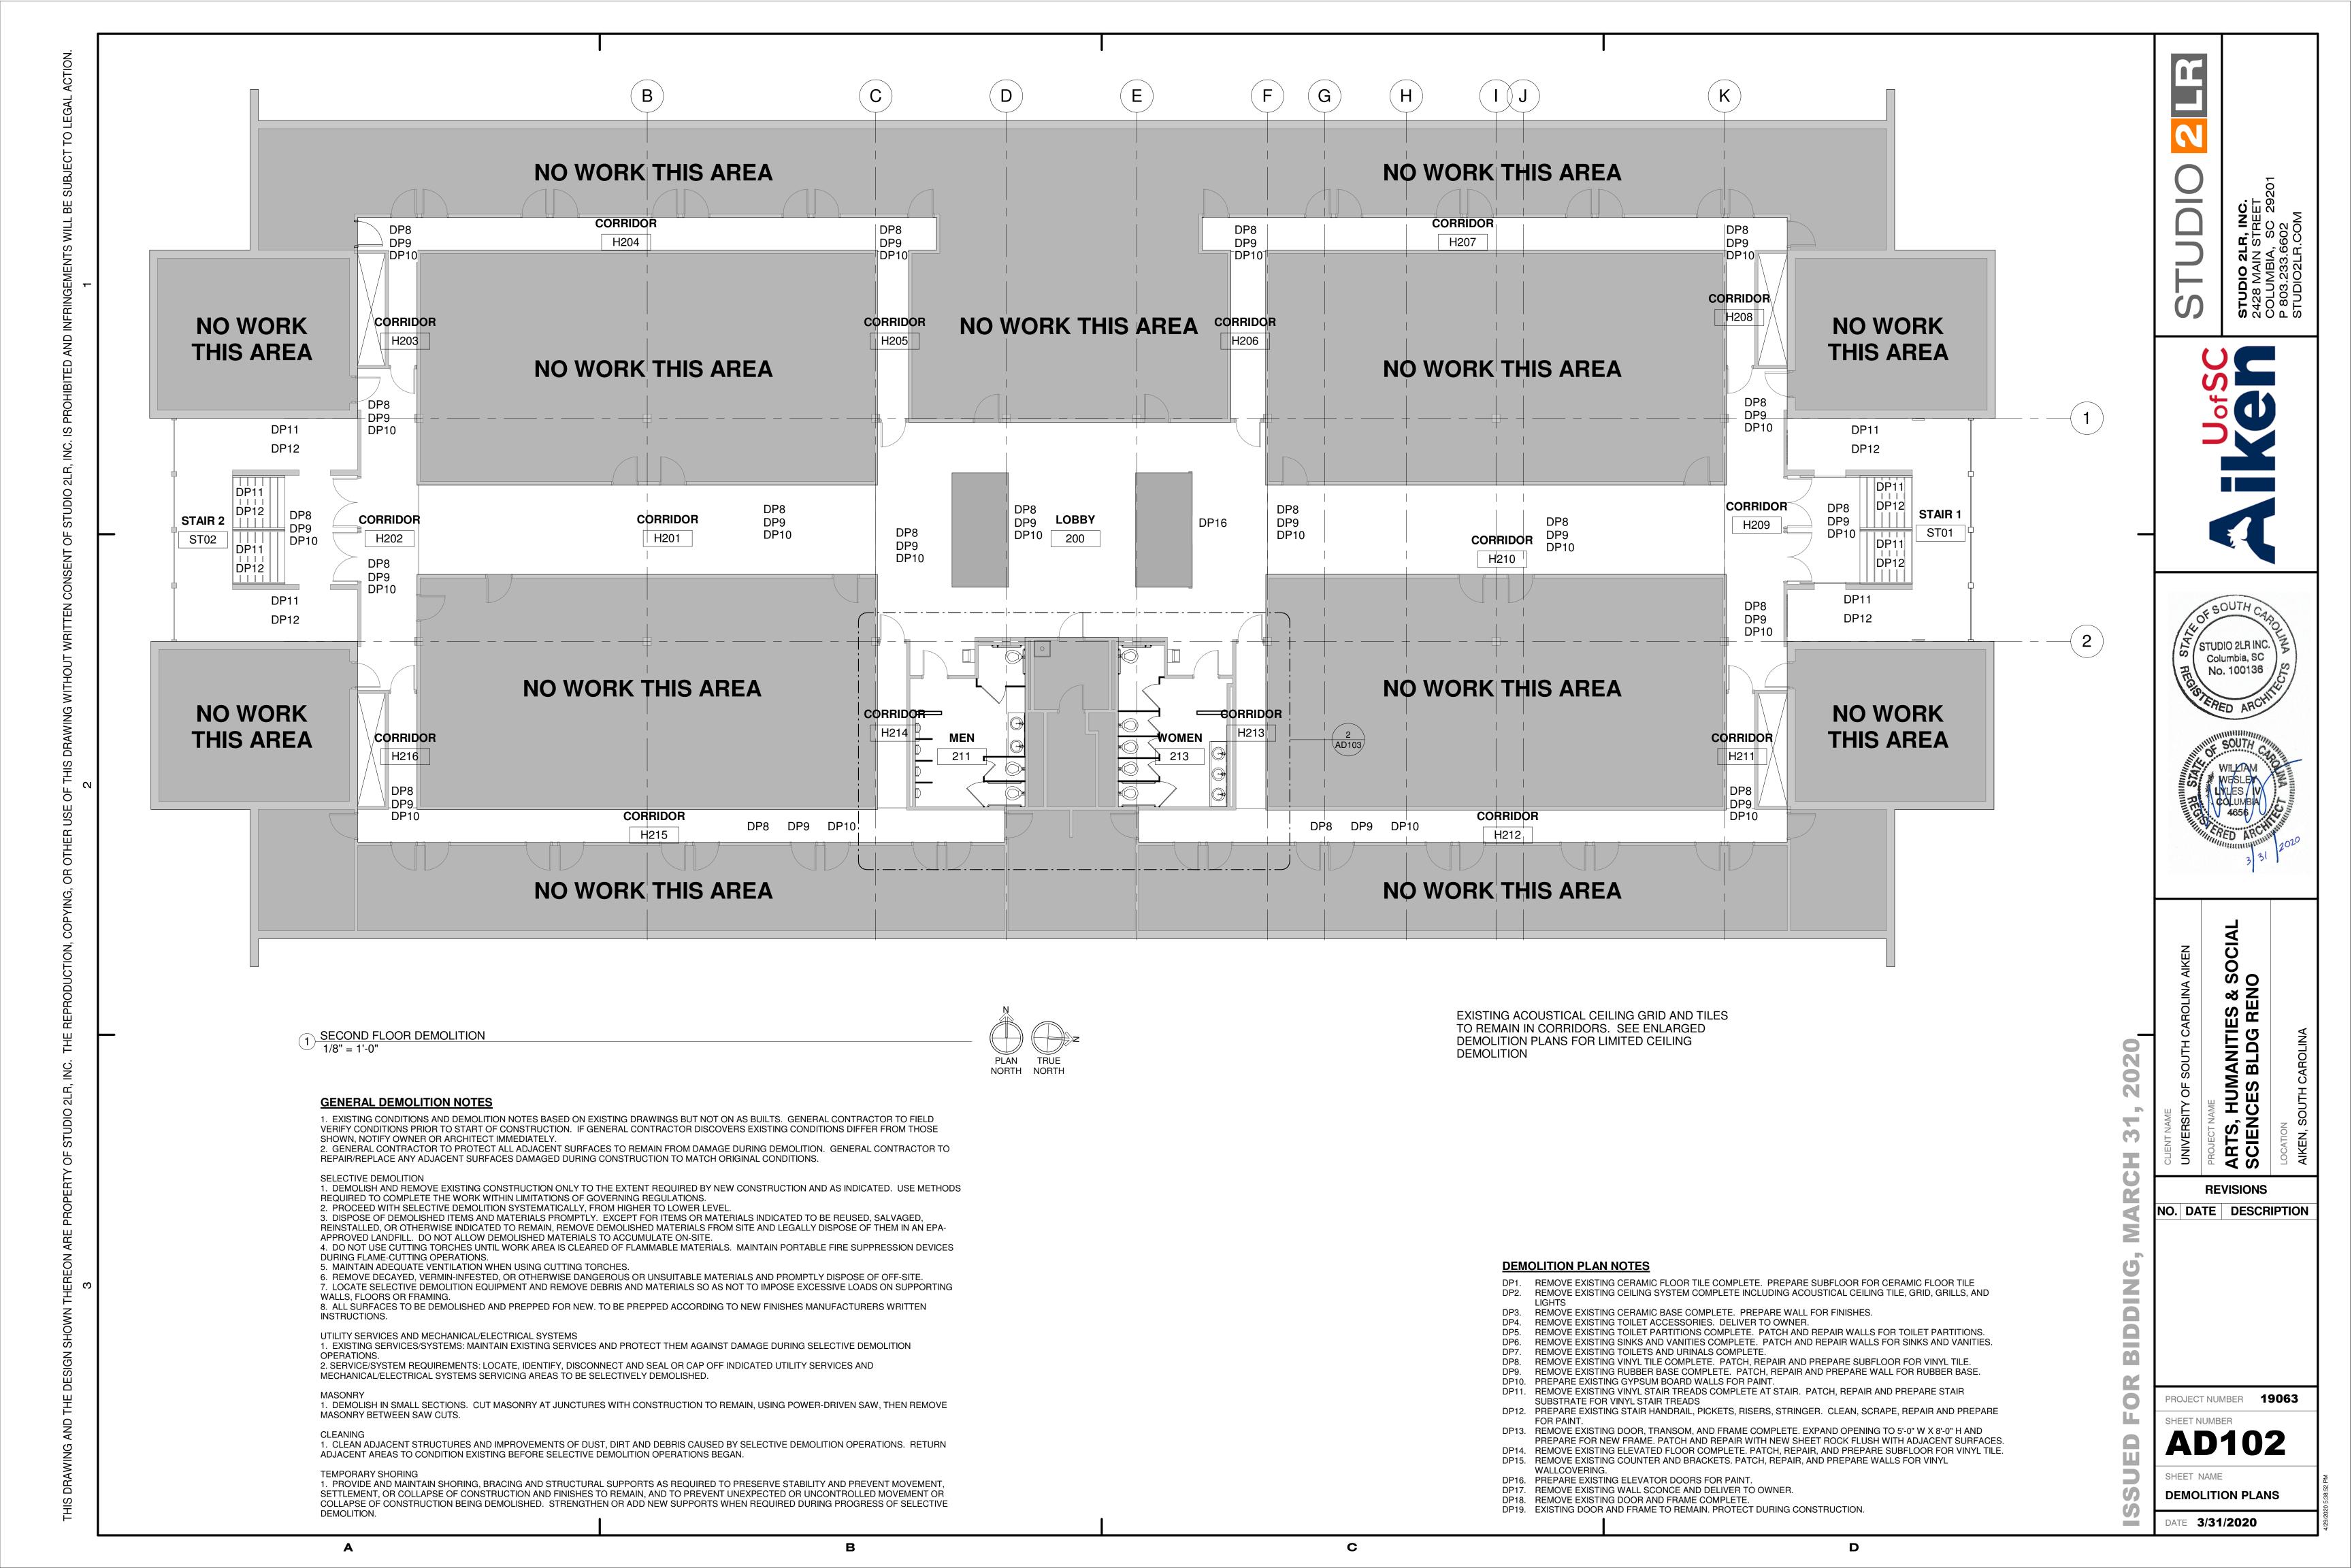

1. EXISTING CONDITIONS AND DEMOLITION NOTES BASED ON EXISTING DRAWINGS BUT NOT ON AS BUILTS. GENERAL CONTRACTOR TO FIELD VERIFY CONDITIONS PRIOR TO START OF CONSTRUCTION. IF GENERAL CONTRACTOR DISCOVERS EXISTING CONDITIONS DIFFER FROM THOSE SHOWN, NOTIFY OWNER OR ARCHITECT IMMEDIATELY. 2. GENERAL CONTRACTOR TO PROTECT ALL ADJACENT SURFACES TO REMAIN FROM DAMAGE DURING DEMOLITION. GENERAL CONTRACTOR TO REPAIR/REPLACE ANY ADJACENT SURFACES DAMAGED DURING CONSTRUCTION TO MATCH ORIGINAL CONDITIONS.

SELECTIVE DEMOLITION

1. DEMOLISH AND REMOVE EXISTING CONSTRUCTION ONLY TO THE EXTENT REQUIRED BY NEW CONSTRUCTION AND AS INDICATED. USE METHODS REQUIRED TO COMPLETE THE WORK WITHIN LIMITATIONS OF GOVERNING

2. PROCEED WITH SELECTIVE DEMOLITION SYSTEMATICALLY, FROM HIGHER TO LOWER LEVEL.

3. DISPOSE OF DEMOLISHED ITEMS AND MATERIALS PROMPTLY. EXCEPT FOR ITEMS OR MATERIALS INDICATED TO BE REUSED, SALVAGED, REINSTALLED, OR OTHERWISE INDICATED TO REMAIN, REMOVE DEMOLISHED MATERIALS FROM SITE AND LEGALLY DISPOSE OF THEM IN AN EPA-APPROVED LANDFILL. DO NOT ALLOW DEMOLISHED MATERIALS TO

4. DO NOT USE CUTTING TORCHES UNTIL WORK AREA IS CLEARED OF FLAMMABLE MATERIALS. MAINTAIN PORTABLE FIRE SUPPRESSION DEVICES DURING FLAME-CUTTING OPERATIONS.

5. MAINTAIN ADEQUATE VENTILATION WHEN USING CUTTING TORCHES. 6. REMOVE DECAYED, VERMIN-INFESTED, OR OTHERWISE DANGEROUS OR UNSUITABLE MATERIALS AND PROMPTLY DISPOSE OF OFF-SITE.

7. LOCATE SELECTIVE DEMOLITION EQUIPMENT AND REMOVE DEBRIS AND MATERIALS SO AS NOT TO IMPOSE EXCESSIVE LOADS ON SUPPORTING WALLS, FLOORS OR FRAMING. 8. ALL SURFACES TO BE DEMOLISHED AND PREPPED FOR NEW. TO BE PREPPED ACCORDING TO NEW FINISHES

MANUFACTURERS WRITTEN INSTRUCTIONS. UTILITY SERVICES AND MECHANICAL/ELECTRICAL SYSTEMS

1. EXISTING SERVICES/SYSTEMS: MAINTAIN EXISTING SERVICES AND PROTECT THEM AGAINST DAMAGE DURING

2. SERVICE/SYSTEM REQUIREMENTS: LOCATE, IDENTIFY, DISCONNECT AND SEAL OR CAP OFF INDICATED UTILITY SERVICES AND MECHANICAL/ELECTRICAL SYSTEMS SERVICING AREAS TO BE SELECTIVELY DEMOLISHED.

1. DEMOLISH IN SMALL SECTIONS. CUT MASONRY AT JUNCTURES WITH CONSTRUCTION TO REMAIN, USING POWER-DRIVEN SAW, THEN REMOVE MASONRY BETWEEN SAW CUTS.

1. CLEAN ADJACENT STRUCTURES AND IMPROVEMENTS OF DUST, DIRT AND DEBRIS CAUSED BY SELECTIVE DEMOLITION OPERATIONS. RETURN ADJACENT AREAS TO CONDITION EXISTING BEFORE SELECTIVE DEMOLITION OPERATIONS BEGAN.

TEMPORARY SHORING

1. PROVIDE AND MAINTAIN SHORING, BRACING AND STRUCTURAL SUPPORTS AS REQUIRED TO PRESERVE STABILITY AND PREVENT MOVEMENT, SETTLEMENT, OR COLLAPSE OF CONSTRUCTION AND FINISHES TO REMAIN, AND TO PREVENT UNEXPECTED OR UNCONTROLLED MOVEMENT OR COLLAPSE OF CONSTRUCTION BEING DEMOLISHED. STRENGTHEN OR ADD NEW SUPPORTS WHEN REQUIRED DURING PROGRESS OF SELECTIVE DEMOLITION.

DEMOLITION PLAN NOTES

DP1. REMOVE EXISTING CERAMIC FLOOR TILE COMPLETE. PREPARE SUBFLOOR FOR CERAMIC FLOOR TILE DP2. REMOVE EXISTING CEILING SYSTEM COMPLETE INCLUDING ACOUSTICAL CEILING TILE, GRID, GRILLS, AND

DP3. REMOVE EXISTING CERAMIC BASE COMPLETE. PREPARE WALL FOR FINISHES. REMOVE EXISTING TOILET ACCESSORIES. DELIVER TO OWNER.

REMOVE EXISTING TOILET PARTITIONS COMPLETE. PATCH AND REPAIR WALLS FOR TOILET PARTITIONS. REMOVE EXISTING SINKS AND VANITIES COMPLETE. PATCH AND REPAIR WALLS FOR SINKS AND VANITIES. REMOVE EXISTING TOILETS AND URINALS COMPLETE.

DP8. REMOVE EXISTING VINYL TILE COMPLETE. PATCH, REPAIR AND PREPARE SUBFLOOR FOR VINYL TILE. DP9. REMOVE EXISTING RUBBER BASE COMPLETE. PATCH, REPAIR AND PREPARE WALL FOR RUBBER BASE.

DP10. PREPARE EXISTING GYPSUM BOARD WALLS FOR PAINT.

DP11. REMOVE EXISTING VINYL STAIR TREADS COMPLETE AT STAIR. PATCH, REPAIR AND PREPARE STAIR SUBSTRATE FOR VINYL STAIR TREADS

DP12. PREPARE EXISTING STAIR HANDRAIL, PICKETS, RISERS, STRINGER. CLEAN, SCRAPE, REPAIR AND PREPARE

DP13. REMOVE EXISTING DOOR, TRANSOM, AND FRAME COMPLETE. EXPAND OPENING TO 5'-0" W X 8'-0" H AND PREPARE FOR NEW FRAME. PATCH AND REPAIR WITH NEW SHEET ROCK FLUSH WITH ADJACENT SURFACES.

DP14. REMOVE EXISTING ELEVATED FLOOR COMPLETE. PATCH, REPAIR, AND PREPARE SUBFLOOR FOR VINYL TILE. DP15. REMOVE EXISTING COUNTER AND BRACKETS. PATCH, REPAIR, AND PREPARE WALLS FOR VINYL

WALLCOVERING.


DP16. PREPARE EXISTING ELEVATOR DOORS FOR PAINT.

DP17. REMOVE EXISTING WALL SCONCE AND DELIVER TO OWNER. DP18. REMOVE EXISTING DOOR AND FRAME COMPLETE.

DP19. EXISTING DOOR AND FRAME TO REMAIN. PROTECT DURING CONSTRUCTION.





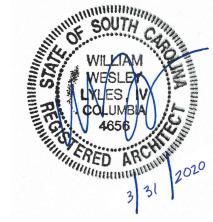

REVISIONS

NO. DATE DESCRIPTION

PROJECT NUMBER 19063

AD103


ENLARGED DEMOLITION PLANS

DATE 3/31/2020


ADD ALTERNATE #1

C


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PROJECT NUMBER 19063

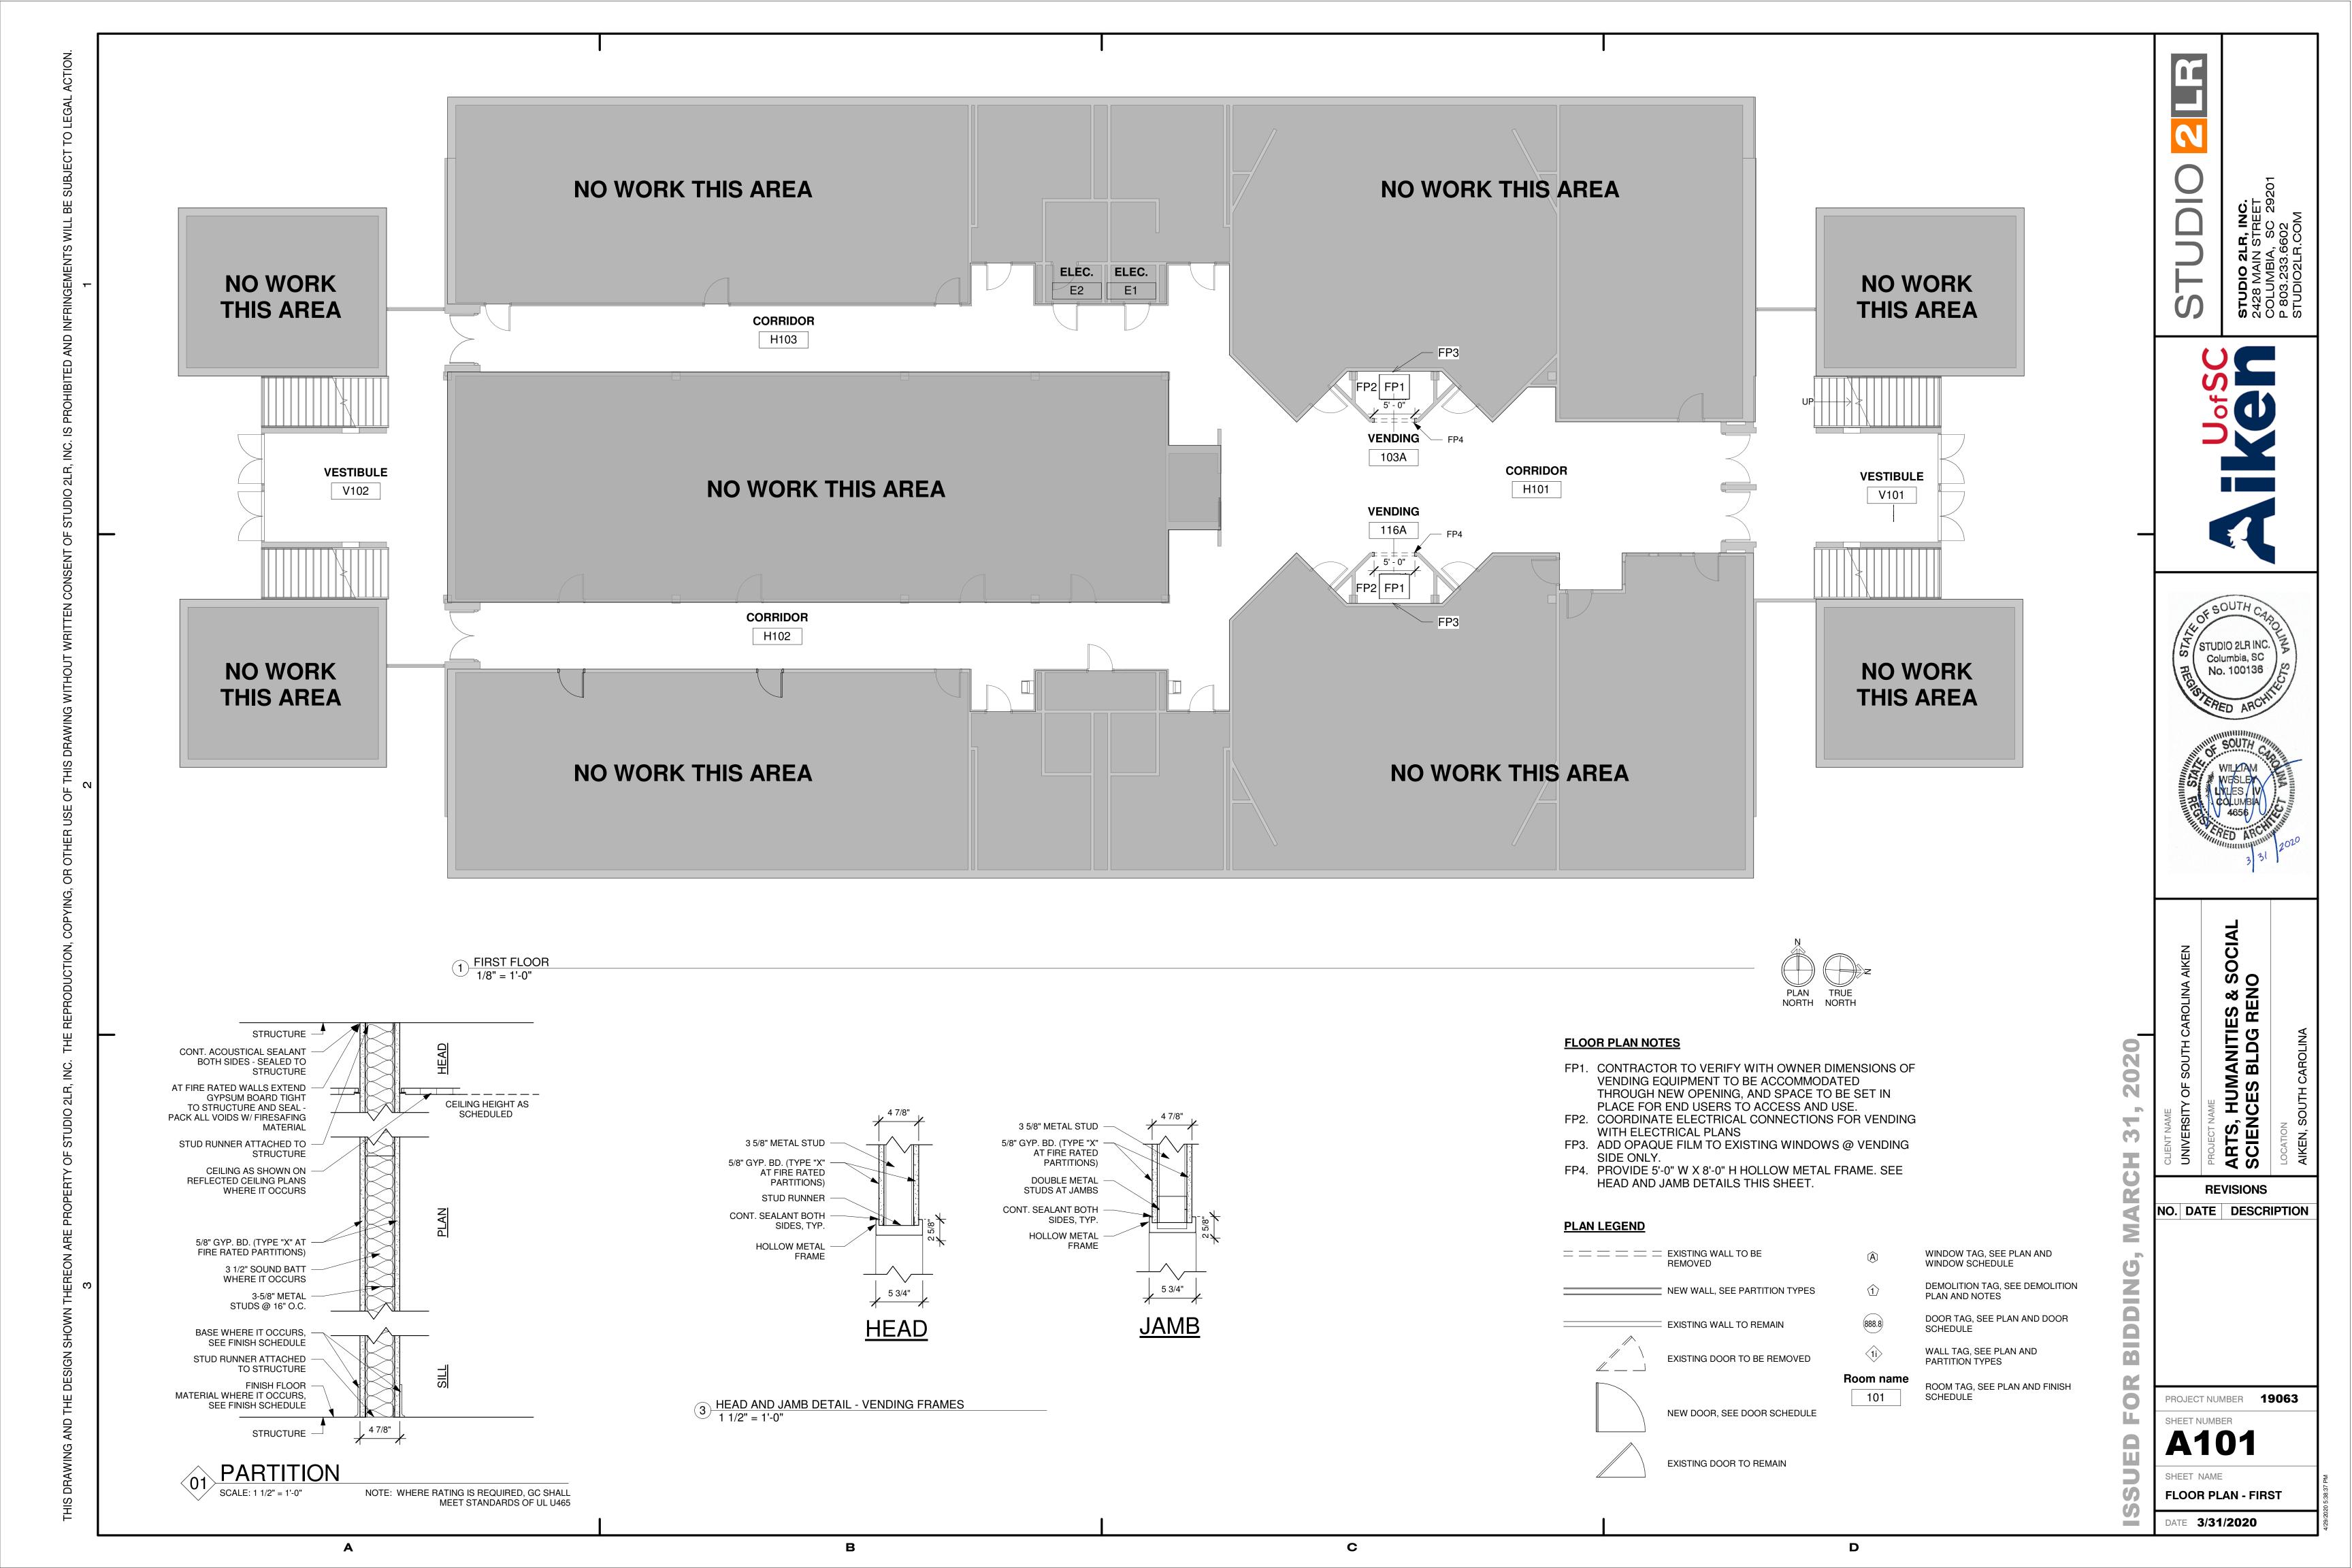
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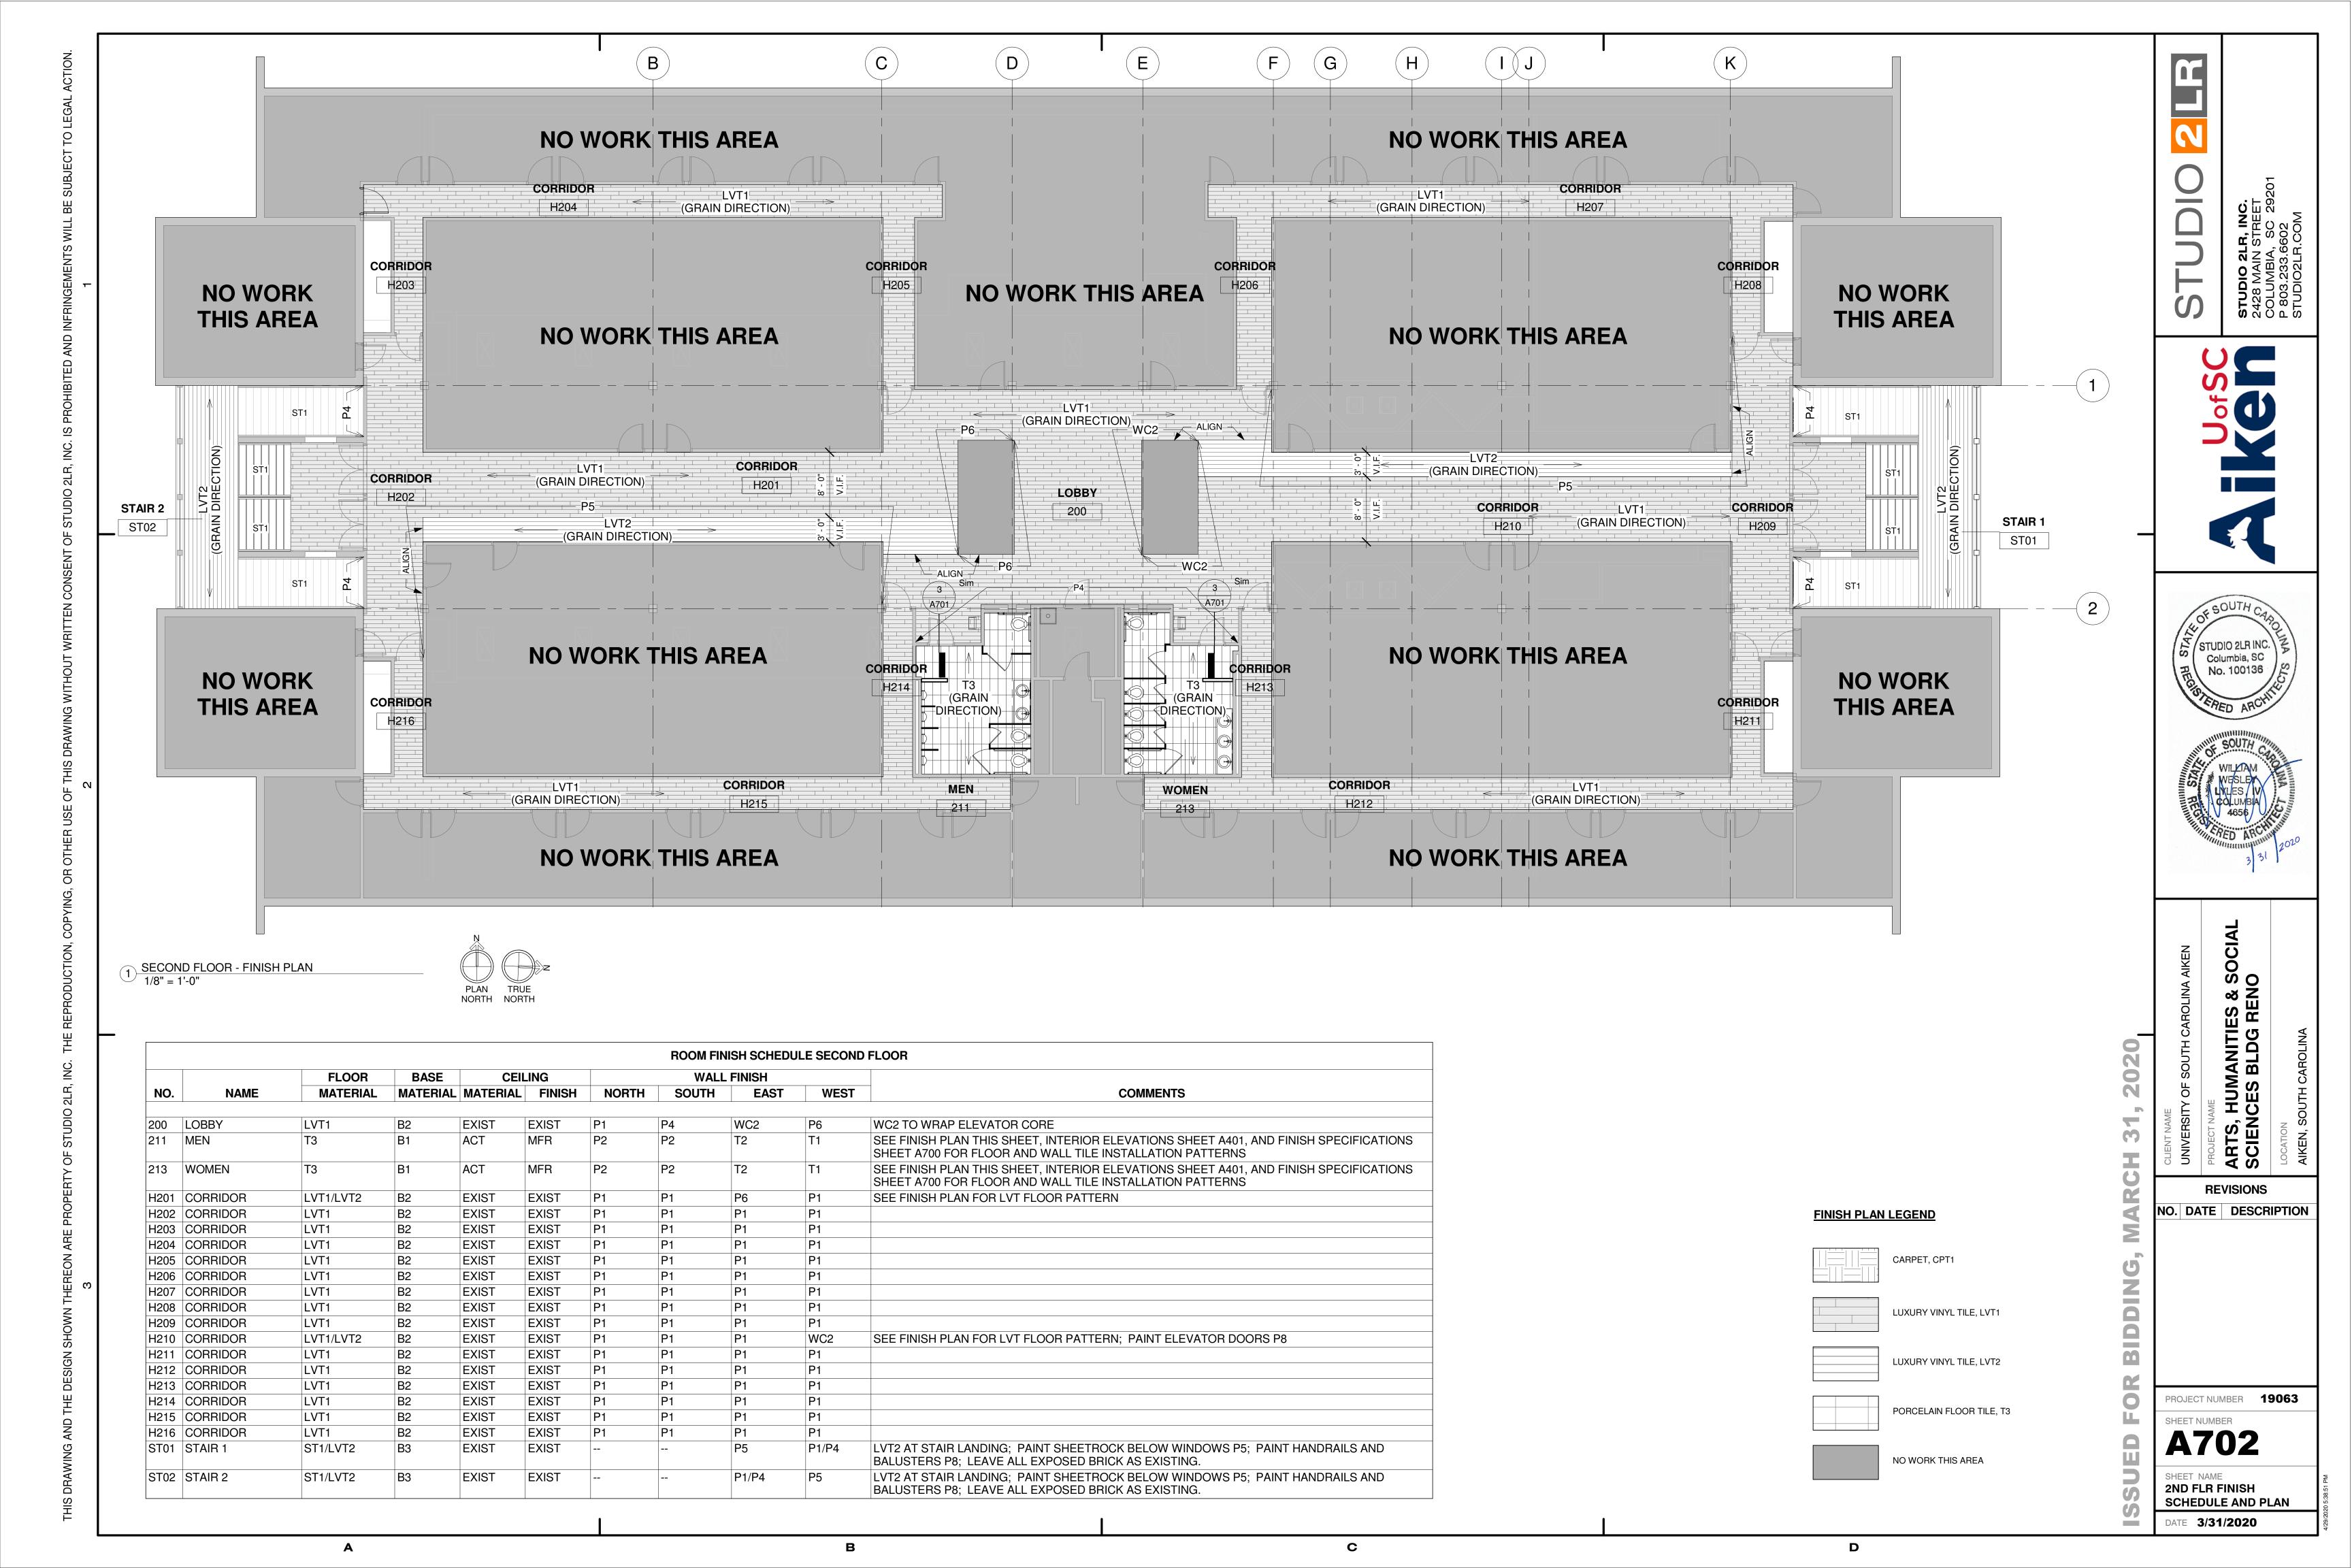
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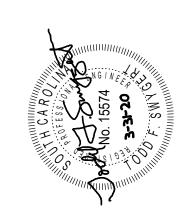
FINISH SPECIFICATIONS DATE 3/31/2020

TAG	ITEM	MANUFACTURER	DESCRIPTION	SIZE	NOTES	
CARPET (CPT)	1,2,,,	III III TO TO TELL		U.L.	1.0.20	
CPT1	WALKOEE CARRET	MILLIZEN	DATTEDNI: ODEY I OOD STACK: COLOD: DADK DI HE	EOCM V EOCM	INSTALL IN MONOLITHIC PATTERN; SCHLUTER RENO-U AEU100 AT	
	WALKOFF CARPET	MILLIKEN	PATTERN: OBEX LOOP STACK; COLOR: DARK BLUE	50CM X 50CM	FLOOR TRANSITION TO LVT	
TILE (T)						
T1	PORCELAIN TILE	INTERCERAMIC	PATTERN: IC BRITES; COLOR: JET BLUE	4 1/4" L X 12 1/4" W; 1/4" THICK	INSTALL IN HORIZONTAL STACK BOND PER INTERIOR ELEVATIONS; ALIGN GROUT JOINTS WITH FLOOR TILE JOINTS; USE GT1	
T2	PORCELAIN TILE	INTERCERAMIC	PATTERN: IC BRITES; COLOR: WHITE	4 1/4" L X 12 1/4" W; 1/4" THICK	INSTALL IN HORIZONTAL STACK BOND PER INTERIOR ELEVATIONS; ALIGN GROUT JOINTS WITH FLOOR TILE JOINTS; USE GT1	
Т3	PORCELAIN TILE	ATLAS CONCORDE	PATTERN: FRAY; COLOR: SMOKE	12"L X 24" W; 3/8" THICK	INSTALL IN STACK BOND PER FINISH PLAN; RUN LENGTH PLAN NORT TO PLAN SOUTH; CENTER PATTERN IN ROOM; ALIGN GROUT JOINTS WITH WALL TILE GROUT JOINTS ON PLAN EAST AND PLAN WEST WALI USE GT1; SCHLUTER RENO-U AEU100 AT FLOOR TRANSITION TO LV	
GROUT (GT)						
GT1	GROUT	LATICRETE	COLOR: 78 STERLING SILVER			
LUXURY VINYL TILE (LVT)						
LVT1	VINYL TILE	TARKETT	COLLECTION: iD LATITUDE ABSTRACT; PATTERN: STRIA MARBLE; COLOR: PLSM 5102 NIMBUS	6" L X 36" W	INSTALL RUNNING PLANKS ALL IN SAME DIRECTION AS INDICATE FINISH PLANS, STAGGERED END JOINTS 12" FROM END JOINT	
LVT2	VINYL TILE	TARKETT	PATTERN: COLORGRAIN; COLOR: CASCADES	6" L X 36" W	INSTALL RUNNING PLANKS ALL IN SAME DIRECTION AS INDICATED OF FINISH PLANS, STAGGERED END JOINTS 12" FROM END JOINTS.	
PAINT (P)						
P1	WALL PAINT	SHERWIN WILLIAMS	COLOR: SW 7029 AGREEABLE GRAY; FINISH: EGGSHELL			
P2	WALL PAINT	SHERWIN WILLIAMS	COLOR: SW 7029 AGREEABLE GRAY; FINISH: SEMIGLOSS			
P3	WALL PAINT	SHERWIN WILLIAMS	COLOR: SW 7587 ANTIQUE RED; FINISH: EGGSHELL			
P4	WALL PAINT	SHERWIN WILLIAMS	COLOR: SW 9138 STARDEW; FINISH: EGGSHELL			
P5	WALL PAINT	SHERWIN WILLIAMS	COLOR: SW 6515 LEISURE BLUE; FINISH: EGGSHELL			
P6	WALL PAINT	SHERWIN WILLIAMS	COLOR: SW 6244 NAVAL; FINISH: EGGSHELL			
P7	METAL FRAME PAINT	SHERWIN WILLIAMS	COLOR: SW 7674 PEPPERCORN; FINISH: SATIN		METAL FRAMES AT VENDING ALCOVES	
P8	METAL TRIM PAINT	SHERWIN WILLIAMS	COLOR: SW 6244 NAVAL; FINISH: SATIN		ELEVATOR DOORS AND HANDRAILS	
WALLCOVERING (WC)						
WC1	VINYL WALLCOVERING	MAHARAM	PATTERN: PLOT 399605; COLOR: 013 POPPY	WIDTH: 54"		
WC2	VINYL WALLCOVERING	EYKON	PATTERN: OCEAN DRIVE; COLOR: A191-321 CARLYLE	WIDTH: 54"		
PLASTIC LAMINATE (PL)						
PL1	PLASTIC LAMINATE	WILSONART	PATTERN: SATIN STAINLESS	4'W X 8'L	APRONS AT ALL VANITIES	
SOLID SURFACE (SS)						
SS1	SOLID SURFACE	CORIAN	CARBON CONCRETE			
BASE (B)						
B1	TILE BASE	ATLAS CONCORDE	PATTERN: FRAY; COLOR: SMOKE	6" X 12" COVE BASE		
B2	RUBBER BASE	TARKETT	COLOR: GREY	4" COVE BASE		
B3	RUBBER BASE	TARKETT	COLOR: NAVY BLUE	4" COVE BASE		
STAIRS (ST)						
ST1	STAIR TREAD & RISER	ROPPE	#96 VANTAGE DESIGN TREAD & RISER; COLOR: SYMMETRY #S139 DEEP NAVY; INCLUDE 2" RIBBED RUBBER STRIP IN AL - ALMOND			
TOILET PARTITIONS (TP)						
TP1	SOLID PHENOLIC FLOOR MOUNTED TOILET PARTITIONS	GENERAL PARTITIONS	PL1 ON BLACK SOLID PHENOLIC CORE. PROVIDE MFR. STANDARD COAT HOOK IN EACH STALL, TYP. PROVIDE SHOP DRAWINGS FOR REVIEW.		REFER TO SPECIFICATION SECTION 102113.17	

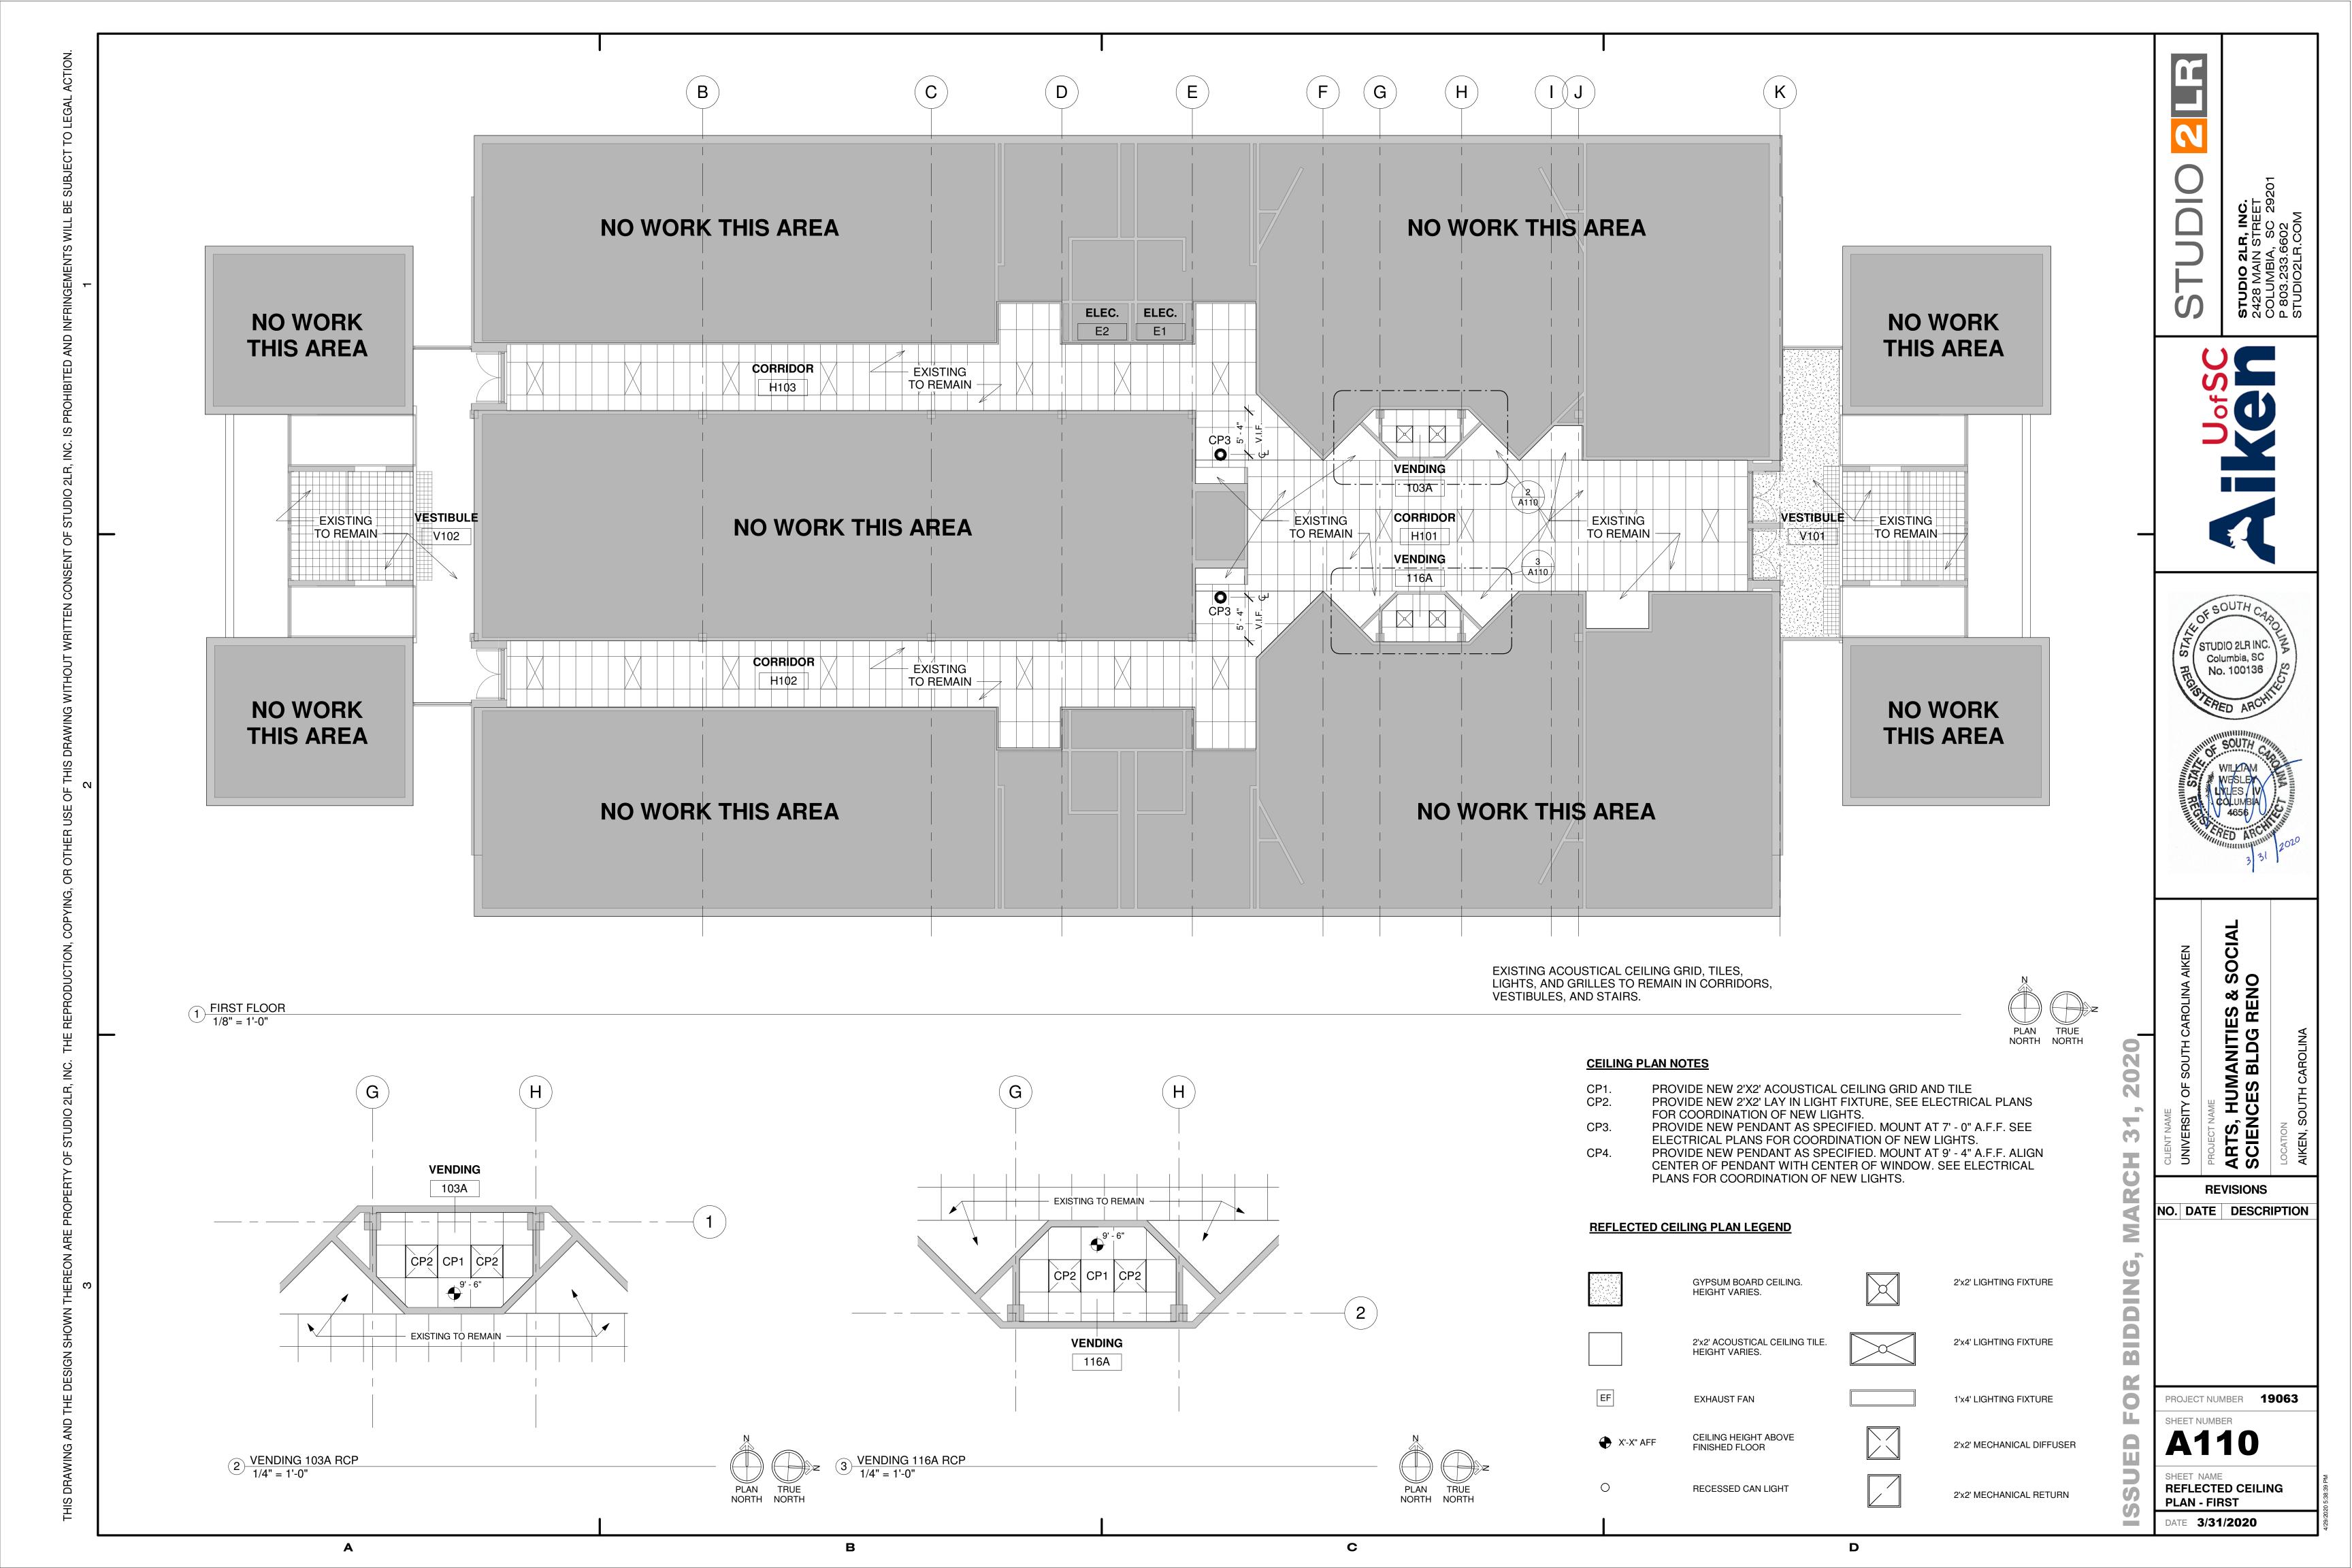FINISH SPECIFICATION



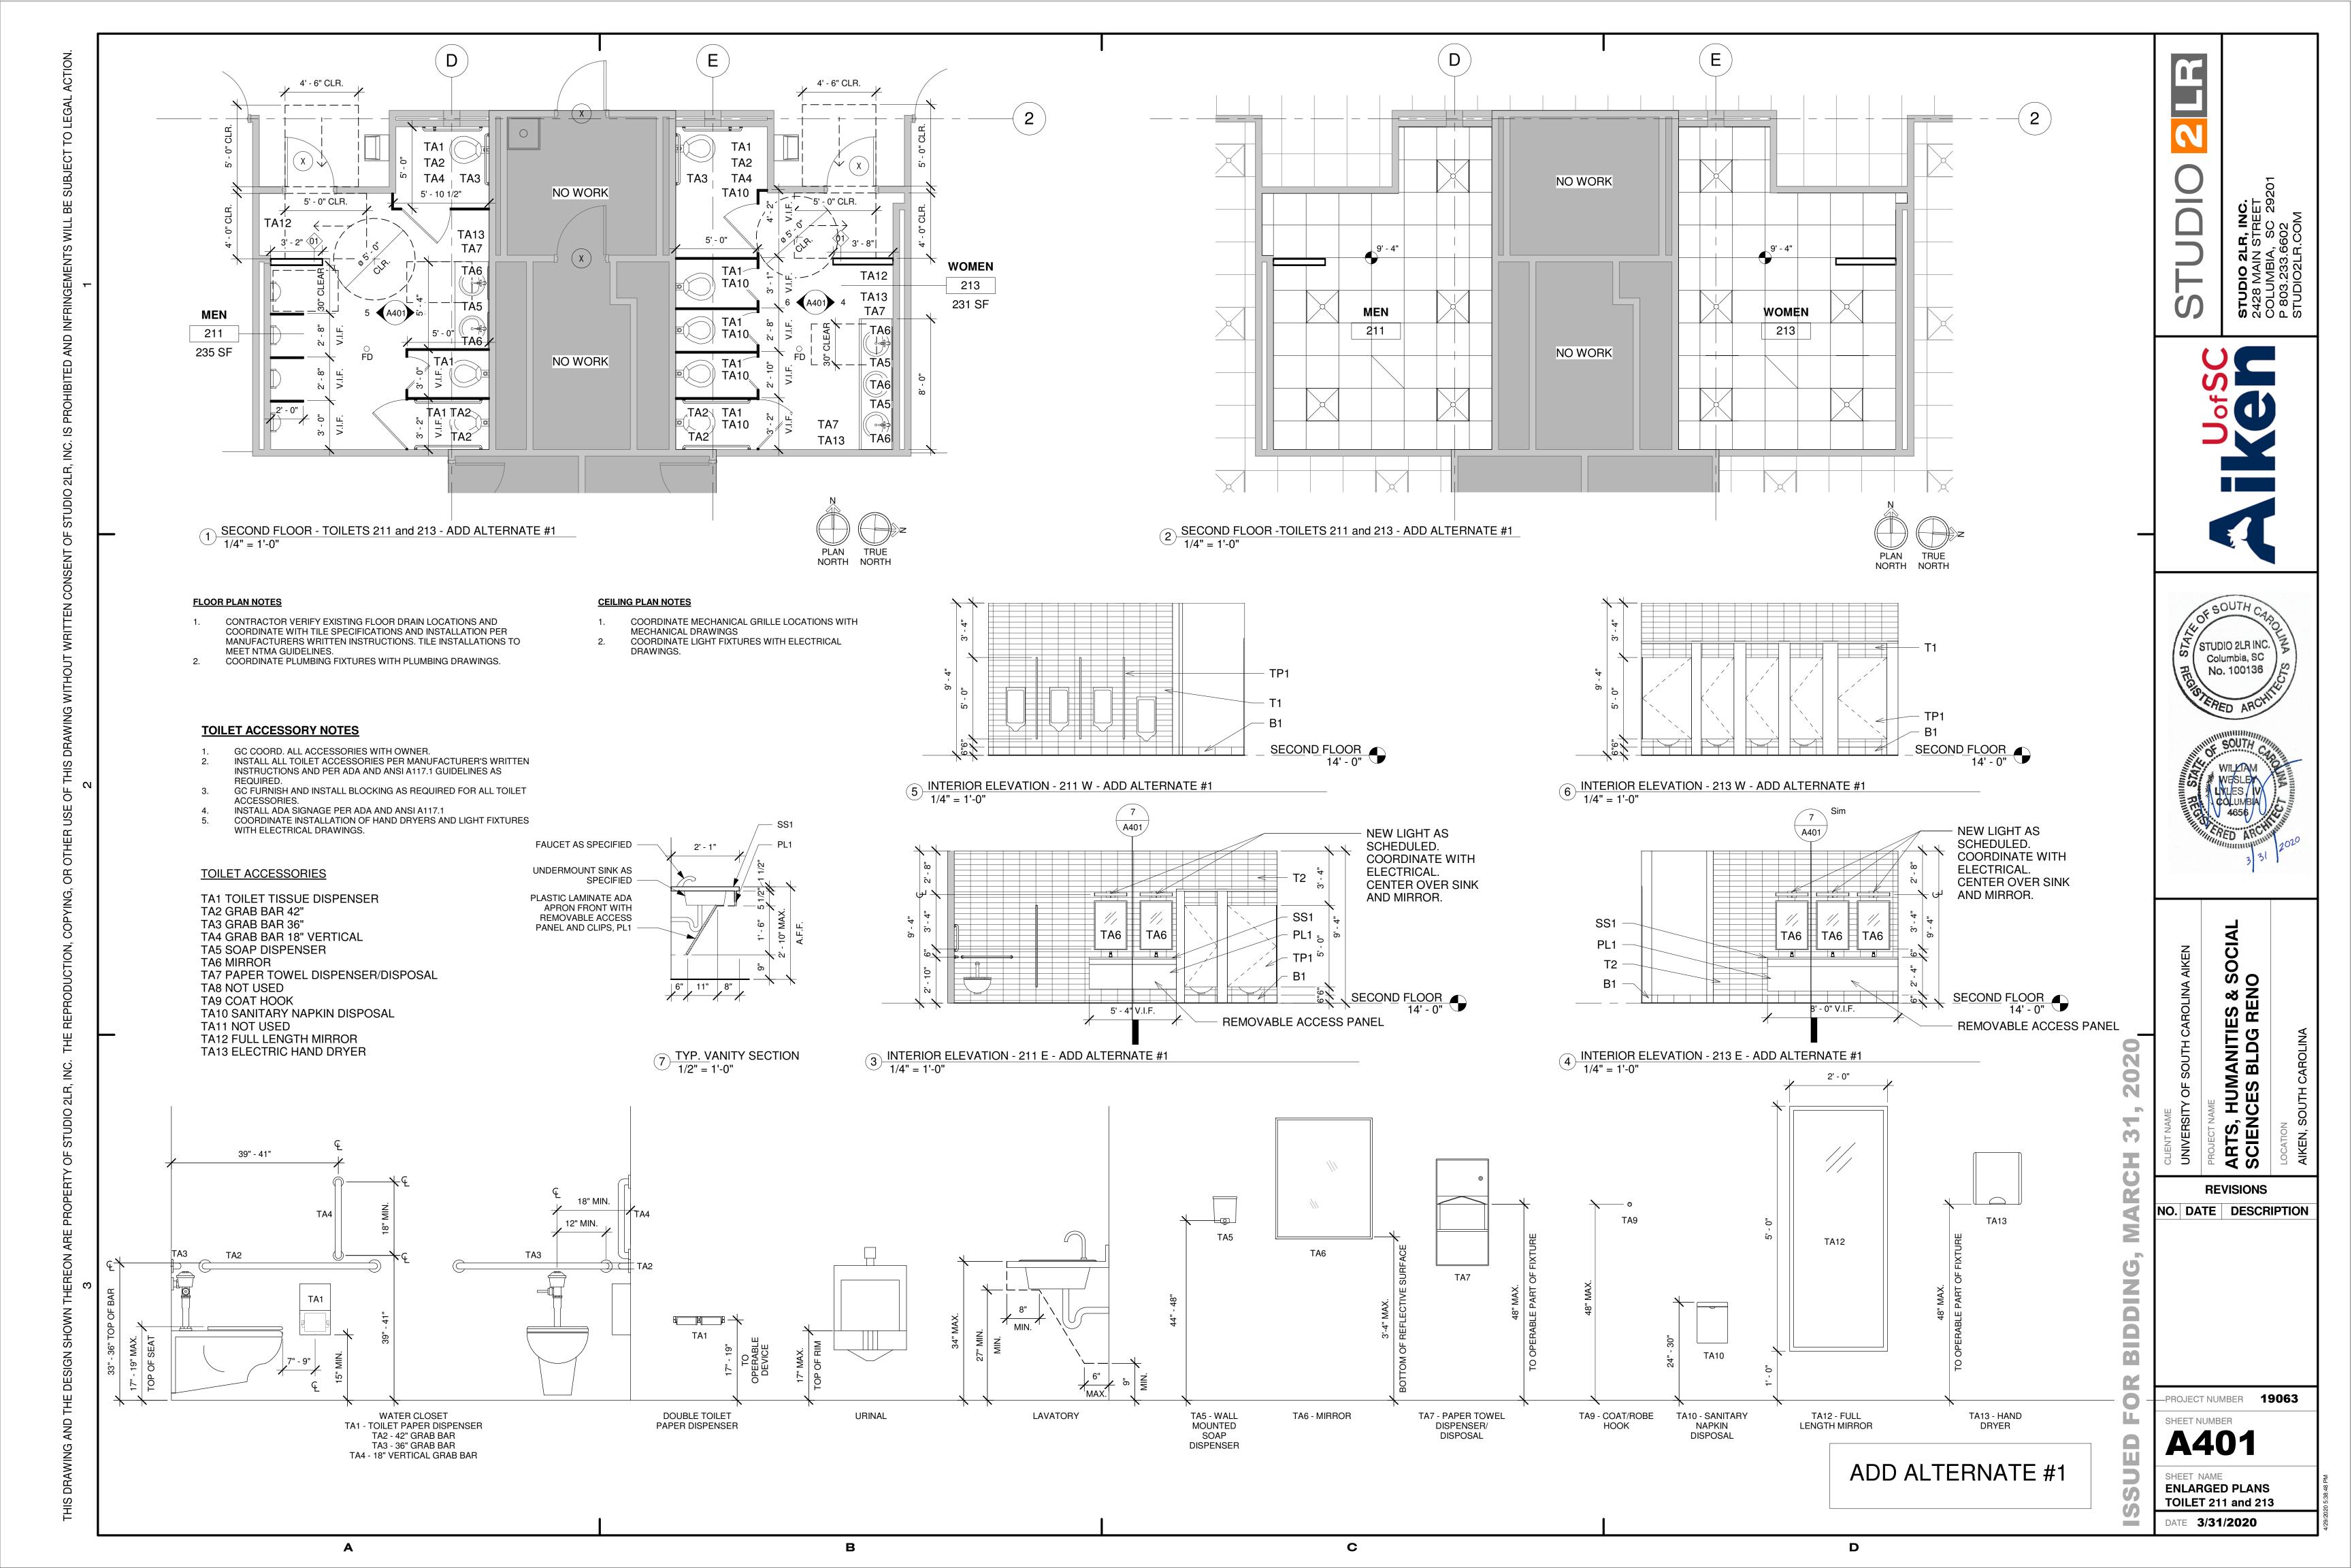

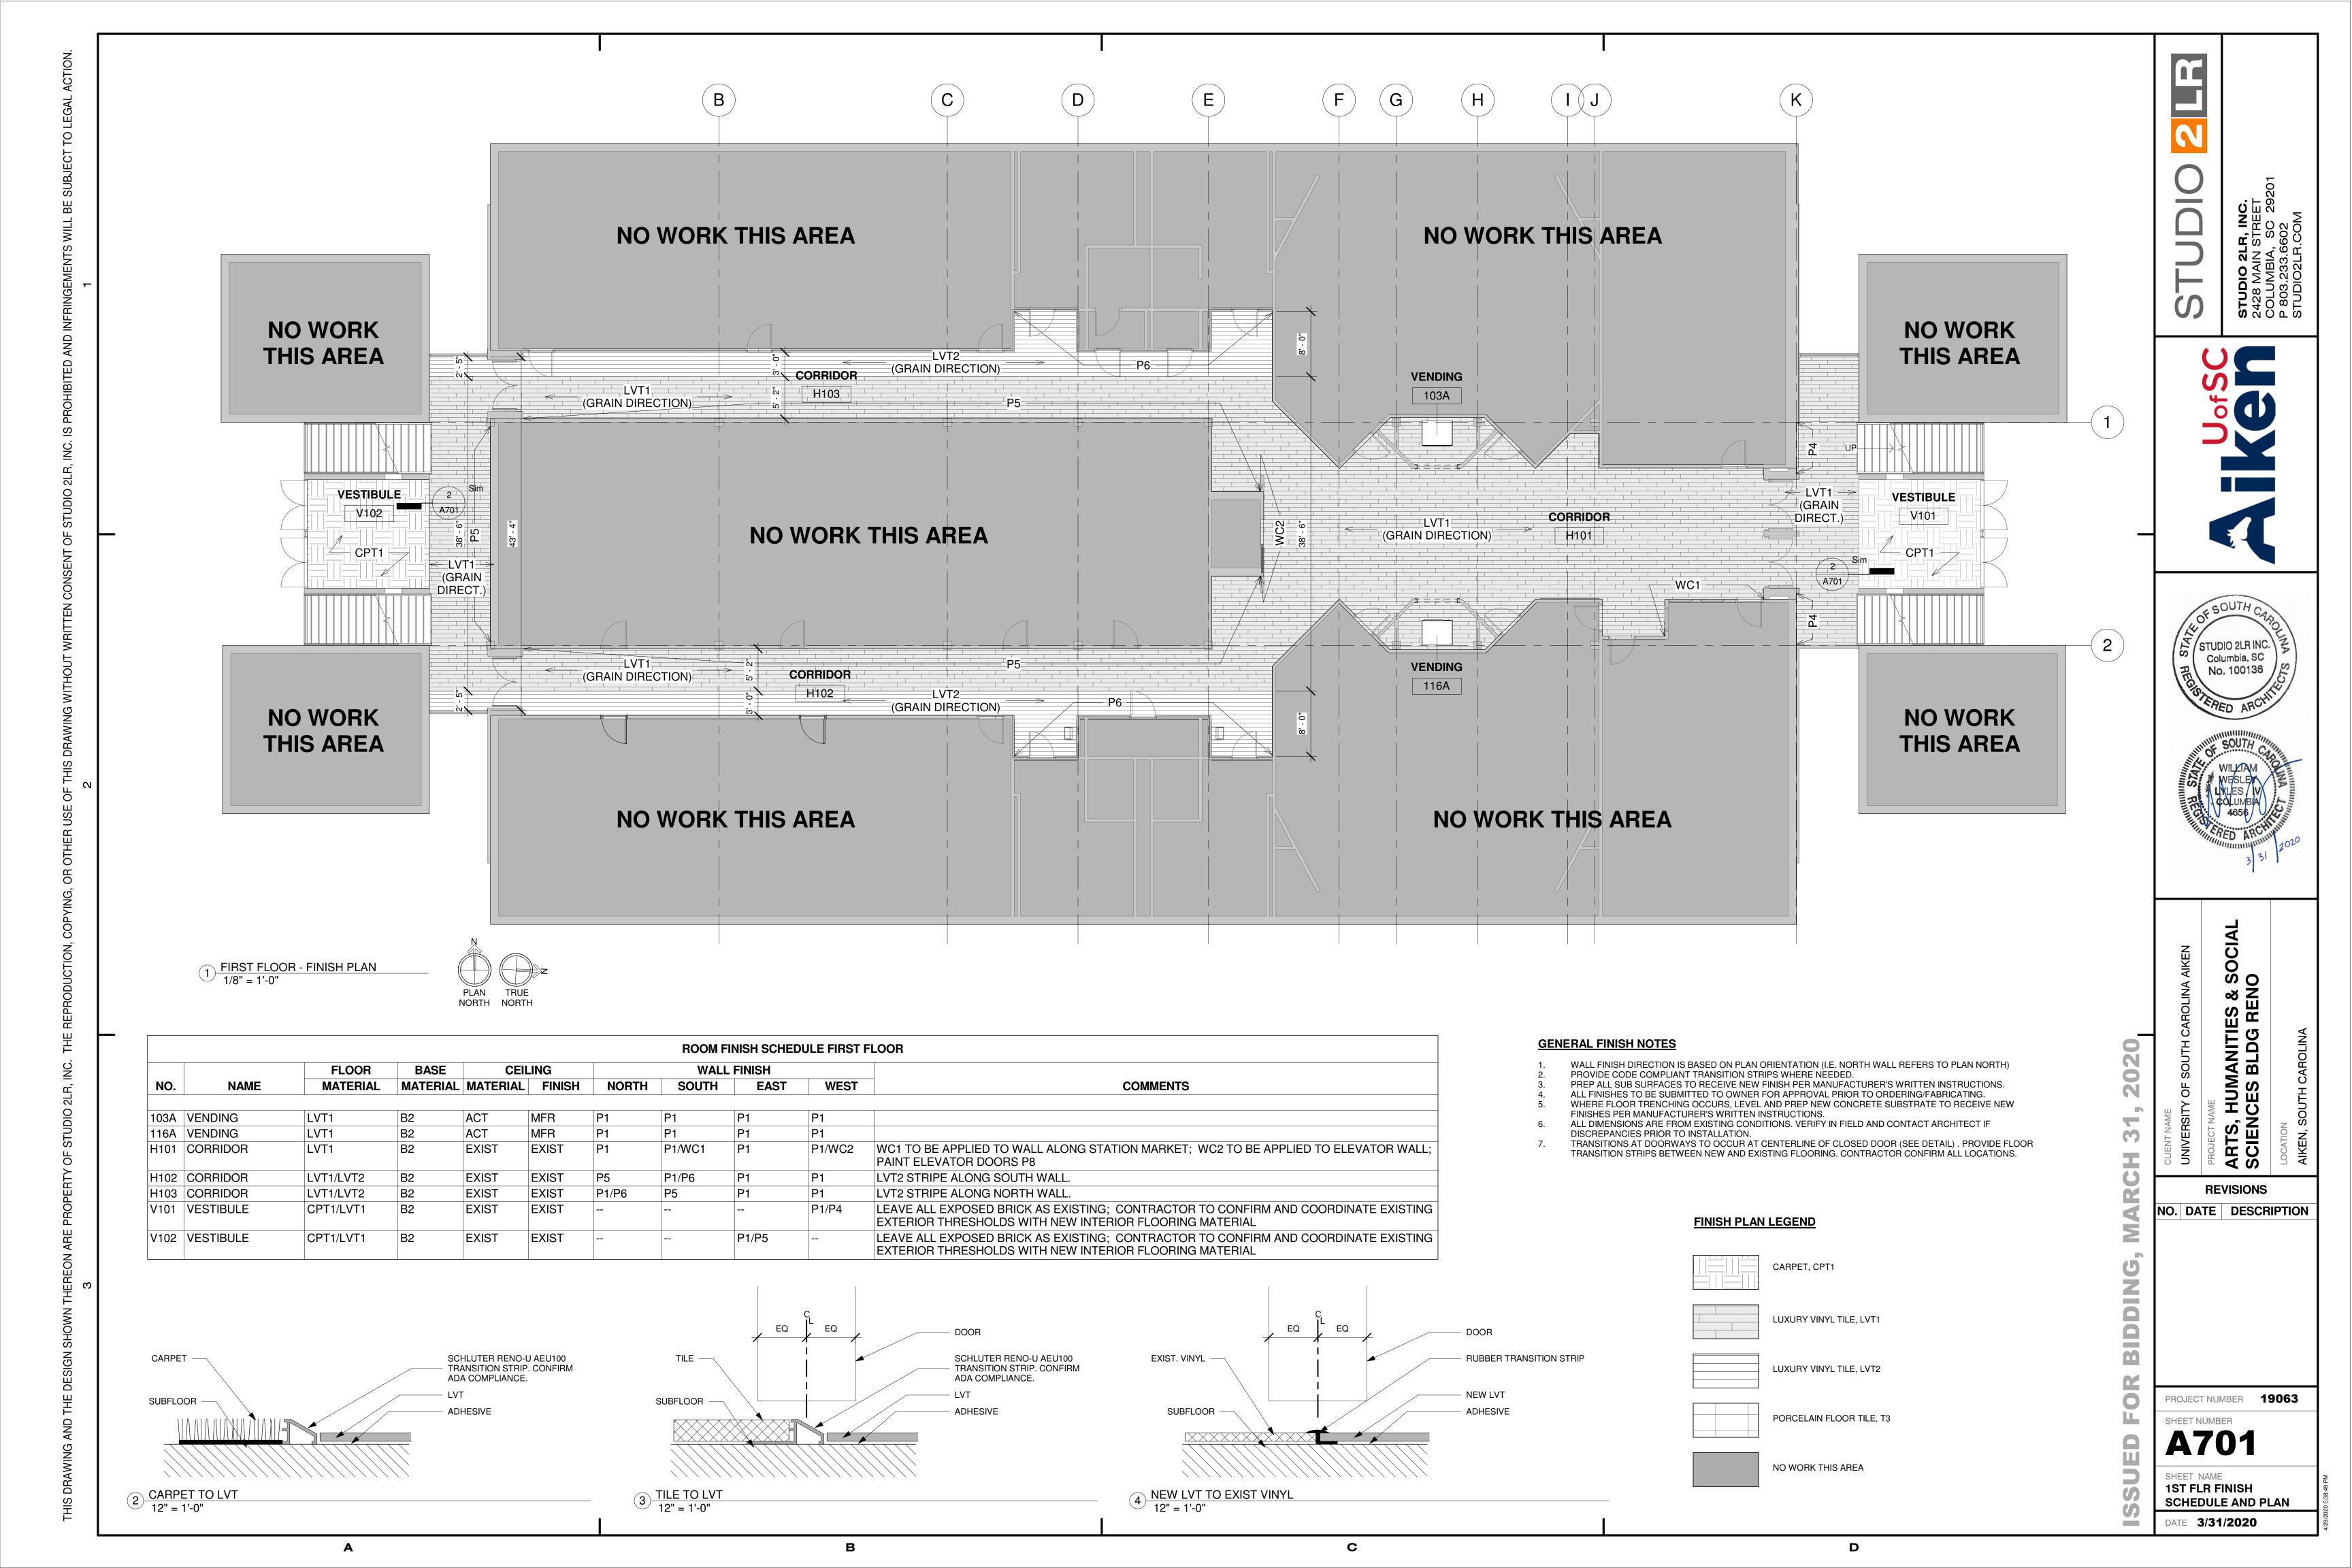



— EXHAUST TRUNK DUCT

SAME SIZE AS GRILLE -

SEE ARCHITECTURAL

DRAWINGS FOR

CEILING TYPE

NECK SIZE

MANUAL BALANCING DAMPER

ROUND SHEET METAL RUNOUT DUCT

EXHAUST GRILLE DETAIL

1 SECOND FLOOR - TOILETS 211 & 213 DEMOLITION - ALTERNATE #1

RIGID ROUND SHEET

FLAT BLACK

MIN. 3"

EXHAUST GRILLE; SEE AIR

DISTRIBUTION SCHEDULE

FOR GRILLE SIZE

PAINT INSIDE OF PLENUM

METAL ELBOW

WITH LOCKING QUADRANT

AIR DISTRIBUTION SCHEDULE

TAG	DESCRIPTION	MANUFACTURER	MODEL	FRAME	CFM	NECK SIZE	FACE SIZE	MAX NC	REMARKS
A	PERFORATED EXHAUST	PRICE	APDDR	LAY-IN	0-1000	22"x22"	24"x24"	30	1, 2

PROVIDE WITH STANDARD WHITE FINISH. 2. PROVIDE ALUMINUM OR ALUMINIZED STEEL CONSTRUCTION.

DEMOLITION NOTES

- \langle 1 \rangle REMOVE EXHAUST GRILLE AND RUNOUT DUCT. PATCH TRUNK DUCT AND SEAL AS REQUIRED.
- $\langle 2 \rangle$ REMOVE SUPPLY GRILLE AND RUNOUT DUCT. PATCH TRUNK DUCT AND SEAL AS REQUIRED.
- (3) REMOVE TRANSFER DUCT AND GRILLES.

LEGEND				
SYMBOL	DESCRIPTION			
<u>A</u> 100	TYPE "A" DIFFUSER, 100 CFM			
	EXHAUST DUCTWORK			
48x24	48"x24" RECTANGULAR DUCT			
€	CONNECTION POINT OF NEW TO EXISTING			

GENERAL NOTES

- ALL WORK SHALL BE IN ACCORDANCE WITH THE 2018 INTERNATIONAL MECHANICAL CODE, 2009 INTERNATIONAL ENERGY CONSERVATION CODE, AND 2006 SMACNA HVAC DUCT CONSTRUCTION STANDARD. ALL LOCAL CODES OR REQUIREMENTS STILL APPLY.
- VISIT SITE PRIOR TO BIDDING. THIS CONTRACTOR SHALL DETERMINE DIFFICULTY OF INSTALLATION AND REFLECT THIS IN HIS BIDDING.
- DO NOT SCALE DRAWINGS. SEE ARCHITECTURAL DRAWINGS AND REFLECTED CEILING PLANS FOR EXACT LOCATIONS OF DOORS, WINDOWS, AIR DISTRIBUTION, ETC.
- DO NOT SCALE DRAWINGS. THIS CONTRACTOR SHALL VERIFY ALL EXISTING ITEMS AND LOCATIONS IN THE FIELD.
- ALL DUCTWORK LOCATIONS SHALL BE COORDINATED WITH WORK UNDER OTHER DIVISIONS
- OF THE SPECIFICATIONS TO AVOID INTERFERENCE. WHERE 2'X2' LAY IN GRILLES ARE SPECIFIED IN HARD CEILINGS, A PLASTER FRAME SHALL BE
- PROVIDED SO THE GRILLE CAN LAY IN THE CEILING. EXHAUST DUCTS SHALL BE RIGID SHEET METAL ONLY. FLEXIBLE DUCT SHALL NOT BE USED
- THIS CONTRACTOR SHALL PROVIDE ALL ITEMS OF MISCELLANEOUS STEEL AS REQUIRED FOR
- INSTALLATION OF ALL MECHANICAL ITEMS.
- THIS CONTRACTOR SHALL BE RESPONSIBLE FOR ANY NECESSARY DISMANTLING OF EQUIPMENT TO BE REMOVED.
- 10. ITEMS REMOVED UNDER THIS CONTRACT SHALL BECOME THE PROPERTY OF THE CONTRACTOR AND SHALL BE DISPOSED OF PROPERLY.
- 11. THIS CONTRACTOR SHALL BE RESPONSIBLE FOR PROTECTING ALL EXISTING HVAC SYSTEMS FROM CONSTRUCTION DEBRIS, DUST AND DIRT FOR THE ENTIRE CONSTRUCTION DURATION. DUCT CLEANING AND UNIT/COIL CLEANING SHALL BE PERFORMED AS REQUIRED. PROTECTION SHALL INCLUDE FILTER MEDIA OVER ALL RETURN GRILLES AND RETURN DUCT OPENINGS TO PROTECT DUCTS AND EQUIPMENT.

SPECIFICATIONS

- ALL WORK SHALL BE IN ACCORDANCE WITH THE 2018 INTERNATIONAL MECHANICAL CODE, 2009 INTERNATIONAL ENERGY CONSERVATION CODE, AND 2006 SMACNA HVAC DUCT
- ALL RECTANGULAR DUCT SHALL BE TYPE G-60 GALVANIZED SHEET METAL, SEALED WITH LOW PRESSURE DUCT MASTIC. ROUND DUCTS SHALL BE GALVANIZED SHEET METAL SEALED WITH LOW PRESSURE DUCT MASTIC. LOCKING QUADRANT BALANCING DAMPERS SHALL BE INSTALLED IN EACH BRANCH TAKEOFF AT THE MAIN TRUNK DUCT. FLEXIBLE DUCT SHALL NOT
- SUPPLY DUCTS SHALL BE INSULATED WITH 2" THICK, 3/4# DENSITY DUCT WRAP. DUCT WRAP SHALL BE SEALED WITH FIBERGLASS REINFORCING MESH, STAPLES AND MASTIC AT THE
- SUBMIT ALL EQUIPMENT AND PRODUCTS PROPOSED TO BE USED FOR THIS PROJECT PRIOR
- SUBMIT A CERTIFIED ABB OR NEBB TEST AND BALANCE REPORT AT PROJECT COMPLETION PRIOR TO FINAL ACCEPTANCE. BALANCE FAN AIR VOLUMES TO WITHIN 5% OF DESIGN AND
- ALL EQUIPMENT, PRODUCTS AND WORK SHALL BE GUARANTEED TO BE FREE OF DEFECTS IN MANUFACTURE AND WORKMANSHIP FOR A PERIOD OF ONE YEAR FROM THE DATE OF SUBSTANTIAL COMPLETION. ALL REPAIRS WILL BE MADE AT NO COST TO THE OWNER.

- CONSTRUCTION STANDARD. ALL LOCAL CODES OR REQUIREMENTS STILL APPLY.
- EXCEED 5' IN LENGTH AND SHALL BE EQUAL TO FLEXMASTER TYPE 1M.
- TO ORDERING. SUBMIT SIX COPIES OF DATA SHEETS TO THE ENGINEER, BOUND IN A SINGLE VOLUME FOR APPROVAL.
- DIFFUSER AIR VOLUMES TO WITHIN 10% OF DESIGN.



2020

ARTS, HUMANITIES & SOCIAL SCIENCES BLDG RENO

NO. DATE DESCRIPTION

PROJECT NUMBER 19063

M101

SHEET NAME
FLOOR PLANS, NOTES,
AND DETAILS

MEN 211

2 SECOND FLOOR - TOILETS 211 & 213 RENOVATION - ALTERNATE #1


Swygert & Associates DBA Swygert & Assoc., Ltd. Post Office Box 11686


WOMEN 213

CONSULTING ENGINEERS

Columbia, S.C. 29211

Telephone: (803) 791-9300 Facsimile: (803) 791-0830 mail@swygert-associates.com DATE 3/31/2020

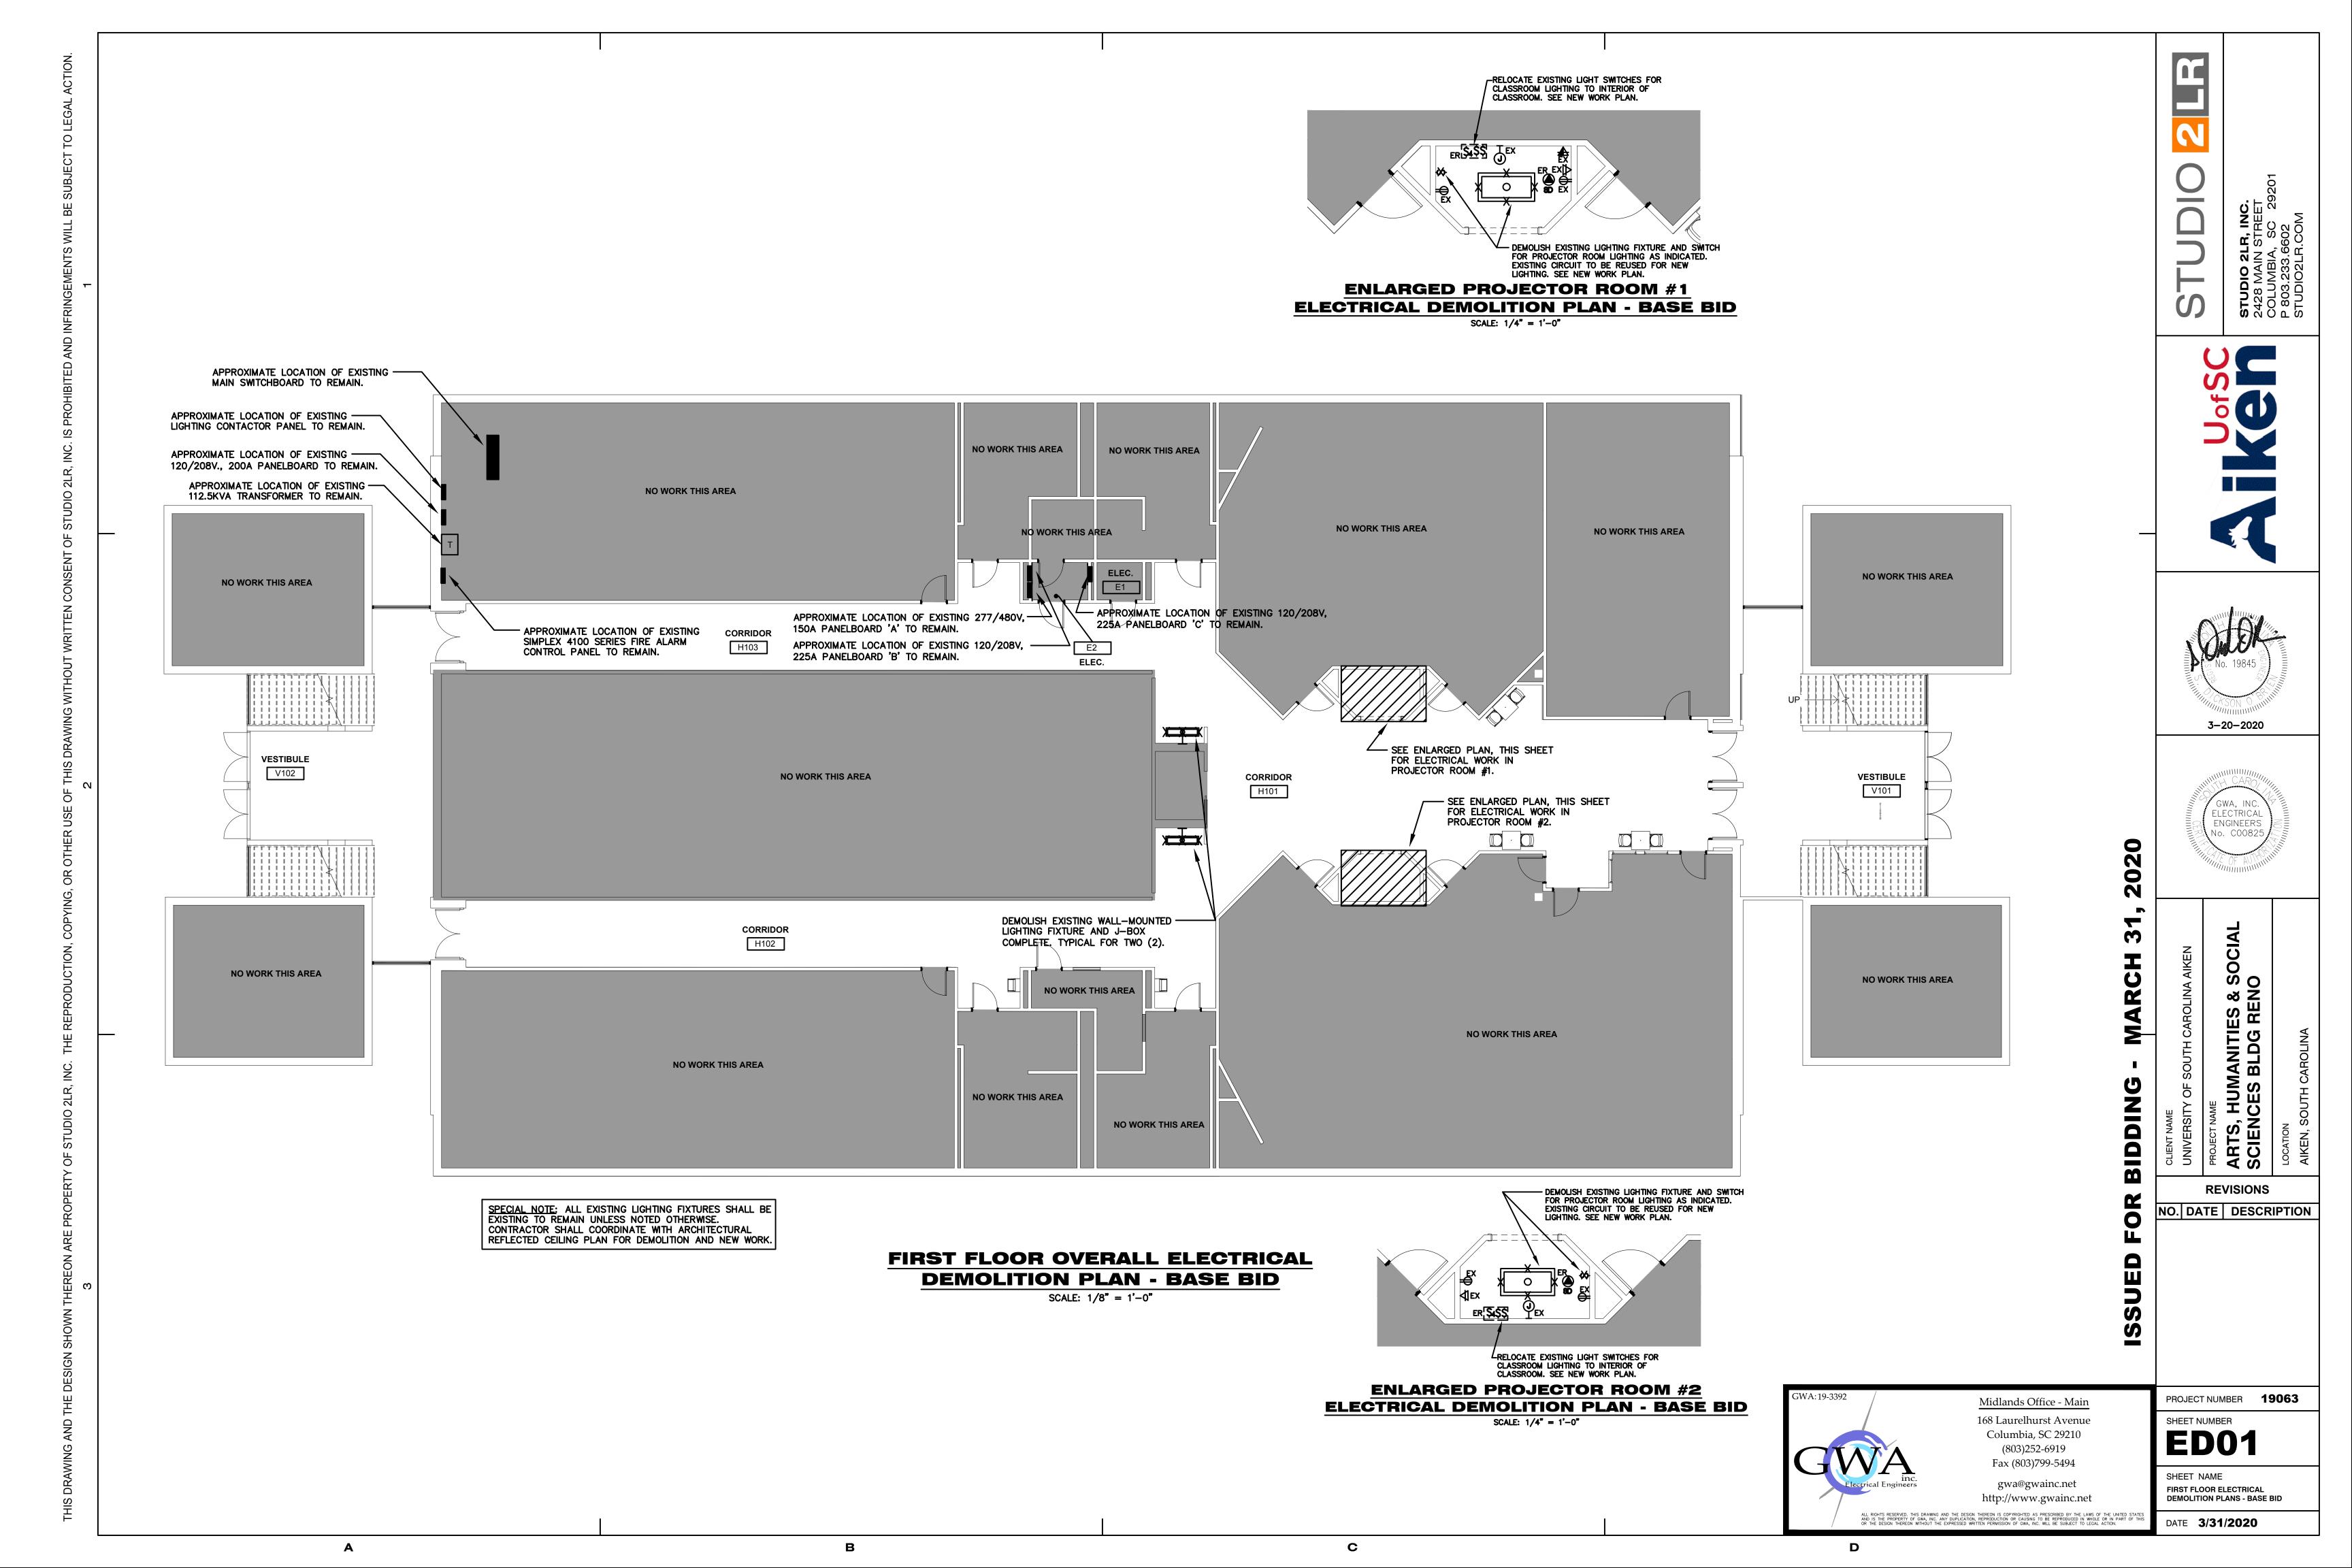

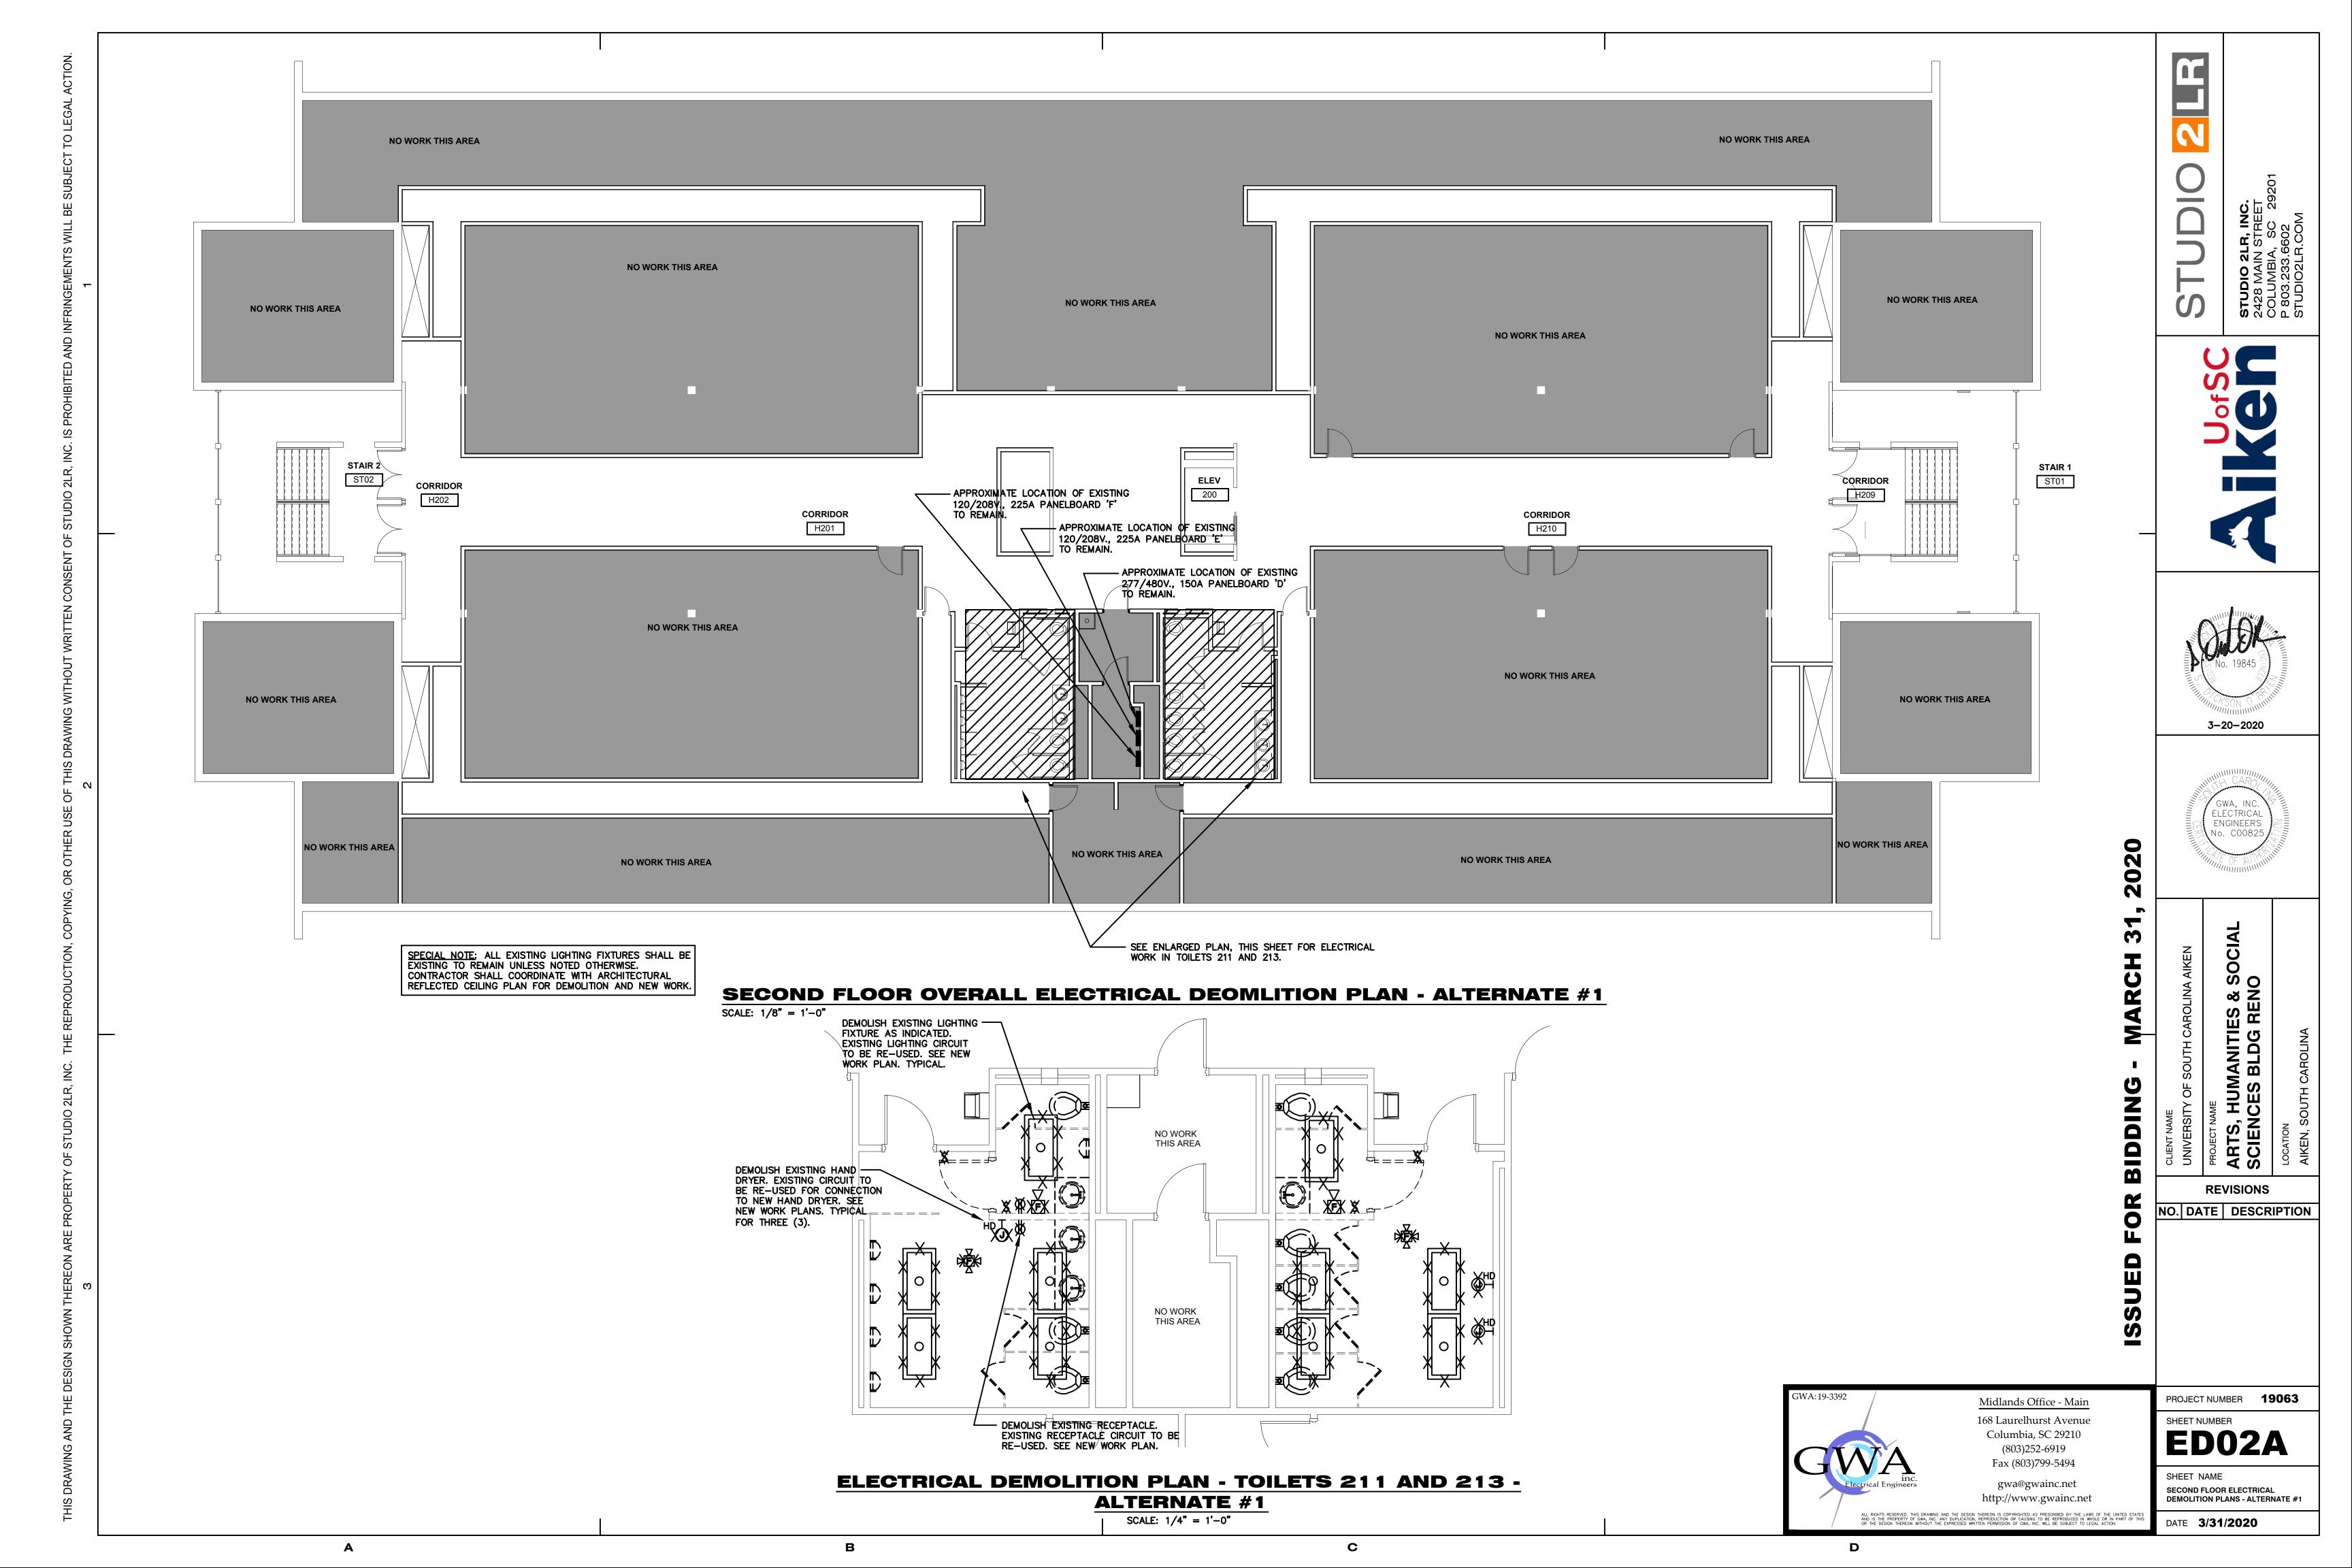

STEEL CITY.

COMPRESSION TYPE CONDUIT

MOUNT

TELE/DATA

TELEVISION

MOUNT

RECEPTACLE 1

OUTLET

THE FOLLOWING STANDARD ABBREVIATIONS ARE USED IN THESE PLANS AND SPECIFICATIONS. CONTRACTOR IS CAUTIONED THAT ALL ABBREVIATIONS LISTED MAY NOT BE USED: CONSULT PLANS AND SPECIFICATIONS FOR ABBREVIATIONS APPLICABLE TO THIS PROJECT.

ABOVE FINISHED FLOOR B.F.F. BELOW FINISHED FLOOR A.F.G. ABOVE FINISHED GRADE B.F.G. BELOW FINISHED GRADE U.N.O. UNLESS NOTED OTHERWISE CKT. CIRCUIT CONDUIT

E.C. **EMPTY CONDUIT** FLX. FLEXIBLE CONDUIT WFLX WEATHERPROOF FLEXIBLE CONDUIT ELECTRIC WATER COOLER **EWC EHWH ELECTRIC WATER HEATER**

VENTILATING FAN CEF VENTILATING FAN (CEILING EXHAUST FAN) AHU AIR HANDLING UNIT FCU FAN COIL UNIT CU **CONDENSING UNIT**

HEAT PUMP OR HORSEPOWER

BRANCH CIRCUIT WIRING -HASHMARK CODE

BRANCH CIRCUITS SHOWN ON THESE DRAWINGS MAY INCLUDE HASHMARKS WHICH INDICATE THE NUMBER OF WIRES TO BE PROVIDED IN A CONDUIT RUN BETWEEN OUTLETS OR JUNCTION BOXES. WIRE SIZES SHALL BE AS TABULATED IN PANELBOARD SCHEDULES UNLESS OTHERWISE INDICATED ON PLAN. SEE SYMBOL SCHEDULE FOR CONDUIT ROUTING NOTATION. HASHMARK CODE IS AS FOLLOWS:

EACH PHASE AND NEUTRAL WIRE IN A CONDUIT RUN IS REPRESENTED BY A HASHMARK. FOR EXAMPLE -

> TWO WRES (NO HASHMARKS) THREE WIRES (3 HASHMARKS) ──//// ➤ FOUR WRES (4 HASHMARKS) ──///// ➤ FIVE WIRES (5 HASHMARKS) . . . AND SO FORTH

NOTE: GROUND WIRES ARE NOT GENERALLY SHOWN. EXAMINE SPECIFICATIONS AND GENERAL NOTES TO DETERMINE REQUIREMENTS FOR GROUND WIRES AND WHERE SPECIFIED, PROVIDE IN ADDITION TO THE NUMBER OF WIRES INDICATED BY HASHMARK CODE.

NOTE: CONTRACTOR IS CAUTIONED THAT MULTIWIRE (LINE-TO-NEUTRAL) BRANCH CIRCUITS DO NOT INDICATE ALL REQUIRED NEUTRAL CONDUCTORS. PROVIDE SEPARATE NEUTRAL CONDUCTORS (WITH COLORED STRIPE TO MATCH PHASE CONDUCTOR) FOR EACH PHASE CONDUCTOR.

EMPTY CONDUITS ARE NOTED BY "EC" WITH TRADE SIZE.

FIRE ALARM HORN-

AND HORN/STROBE

MAGNETIC-DOOR HOLDER

LOWER

SWITCHES -

DEVICE MOUNTING HEIGHTS

DIMMER — CONTROL

HIGH MOUNT-

TELEPHONE

RECEPTACLE

TELE/DATA—

-WALL MOUNTED

SMOKE/HEAT DETECTORS

FIRE ALARM — MANUAL PULL

-3" LESS THAN

DOOR WIDTH

1. DO NOT SCALE DRAWINGS UNLESS DIMENSIONS ARE SHOWN, LOCATE OUTLETS AND EQUIPMENT AS OBVIOUSLY INDICATED AND COORDINATE WITH OTHER TRADES TO AVOID CONFLICTS.

2. MINIMUM SIZE CONDUCTOR FOR POWER SHALL BE NO. 12 AWG.

3. ALL FUSES SHALL BE DUAL-ELEMENT TYPE, "FUSETRON" BY BUSSMAN, OR "ECON" BY ECONOMY.

4. BRANCH CIRCUIT SIZES ARE AWG 12-1/2"C. UNLESS OTHERWISE NOTED IN PANELBOARD SCHEDULES.

5. ALL BRANCH CIRCUIT LOADS SHALL BE BALANCED ACROSS PANELBOARD BUSSES TO OBTAIN MINIMUM NEUTRAL CURRENT.

6. ALL FLEXIBLE CONDUIT SHALL CONTAIN A GREEN WIRE BONDED TO RIGID RACEWAY, BOX OR FIXTURE AT EACH END OF FLEX. SIZE GROUND WIRE PER N.E.C. TABLE 250-122.

7. PROVIDE PULL CORD IN ALL EMPTY RACEWAYS.

8. ALL ELECTRICAL WORK ABOVE CEILINGS UTILIZED AS RETURN AIR PLENUMS SHALL COMPLY WITH N.E.C. AND LOCAL CODES FOR WIRING USED IN ENVIRONMENTAL AIR.

9. DO NOT MOUNT FLUSH JUNCTION BOXES BACK TO BACK. STAGGER JUNCTION BOXES TO REDUCE SOUND TRANSMISSION BETWEEN ROOMS.

10. CONTRACTOR SHALL MINIMIZE REMOVAL OF STRUCTURAL STEEL FIREPROOFING FOR INSTALLATION OF CONDUIT AND EQUIPMENT HANGERS. OBTAIN APPROVAL OF GENERAL CONTRACTOR PRIOR TO REMOVAL.

11. COORDINATE WITH OTHER TRADES TO CONCEAL ELECTRICAL WORK AND PROVIDE OUTLETS IN CORRECT LOCATIONS FOR EACH PIECE OF MECHANICAL OR ELECTRICAL EQUIPMENT CONNECTED.

12. COORDINATE DEVICE REQUIREMENTS AND MOUNTING HEIGHTS FOR HAND DRYERS. SINKS, THRU-WALL UNITS AND THE LIKE WITH EQUIPMENT FURNISHED.

13. CONCEAL OUTLETS FOR ALL EQUIPMENT IN FINISHED AREAS. OBTAIN ROUGHING DIAGRAMS FOR ALL EQUIPMENT AND INSTALL ELECTRICAL WORK IN LOCATIONS AND HEIGHTS ACCORDING TO DIAGRAMS.

14. IN GENERAL, REFER TO DETAILS AND SYMBOL SCHEDULE FOR STANDARD DEVICE MOUNTING HEIGHTS. STUDY ARCHITECTURAL ELEVATIONS, SECTIONS AND CASEWORK DETAILS PRIOR TO ROUGHING AND ADJUST MOUNTING TO AVOID CONFLICTS, INCLUDING BACKSPLASHES. ALL DEVICE MOUNTING SHALL BE IN ACCORDANCE WITH ADA/ANSI A117.1.

15. CONTRACTOR SHALL VERIFY ALL DOOR SWINGS PRIOR TO ROUGHING - LOCATE SWITCHES AND OTHER DEVICES ACCORDINGLY.

16. MOUNT BRACKET TYPE LIGHTING FIXTURES AT HEIGHTS SHOWN OR SCHEDULED ON DRAWINGS OR AS DIRECTED ON JOB BY ARCHITECT, U.N.O.

17. ALL PENETRATIONS THRU WALLS, FLOORS, BARRIERS, PARTITIONS AND THE LIKE SHALL BE SEALED TIGHT. SEAL ALL PENETRATIONS THRU SMOKE TIGHT PARTITIONS WITH U.L. LISTED ASSEMBLIES OR METHODS. SEE ARCHITECTURAL DRAWINGS FOR LOCATIONS OF SMOKE PARTITIONS.

18. FIRESTOP ALL RACEWAYS PASSING THRU FIRE-RATED WALLS, FLOORS OR PARTITIONS. USE U.L. LISTED THROUGH—PENETRATION FIRESTOP SYSTEMS APPROPRIATE FOR CONSTRUCTION AND WITH RATING EQUAL TO THAT BEING PENETRATED. SUBMIT SHOP DRAWINGS FOR SYSTEM(S) PROPOSED. SEE ARCHITECTURAL DRAWINGS FOR LOCATIONS AND RATINGS.

19. OPENINGS GREATER THAN SIXTEEN(16) SQUARE INCHES IN FIRE-RATED WALLS AND PARTITIONS SHALL BE PROTECTED WITH U.L. LISTED SYSTEMS, COMPONENTS AND METHODS AS REQUIRED TO MAINTAIN RATING. PROVIDE PUDDY PADS, LIGHT COVERS, INSERTS, WRAPS, COLLARS AND THE LIKE AS REQUIRED.

20. ALL TYPEWRITTEN PANELBOARD DIRECTORIES, FIRE ALARM PROGRAMMING, LIGHTING CONTROL PROGRAMMING, LABELING AND THE LIKE SHALL UTILIZE FINAL OPERATIONAL ROOM NAMING SYSTEM AND SHALL REFLECT FINAL ROOM DESIGNATIONS. COORDINATE WITH ARCHITECT AND OWNER FOR FINAL NAMING.

21. HANGER WIRES SHALL NOT CONFLICT/TOUCH OTHER TRADES/EQUIPMENT.

ELECTRICAL SYMBOLS

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J

ER

EMERGENCY POWER SOURCE

EMERGENCY POWER SOURCE

LIGHTING FIXTURE, CONNECTED TO

LIGHTING FIXTURE

EXIT LIGHT

RANSFORMER

PANELBOARD

SAFETY SWITCH

EXISTING; TO REMAIN

EXISTING; BEING RELOCATED

EXACT DEVICE REQUIREMENTS AND PERFORMACE CHARACTERISTICS.

EXISTING; NEW LOCATION

LIGHTING FIXTURE. CEILING (WALL MOUNT) TOGGLE SWITCH FIXTURE INDICATED, CONNECTED TO WALL SWITCH - OCCUPANCY SENSOR 48" UP (OS) CEILING MOUNTED OCCUPANCY SENSOR F FIRE ALARM PULL STATION WALL OR CEILING FLUSH JUNCTION BOX CEILING (()-WALL) PULL BOX OR JUNCTION BOX IN FLOOR DUPLEX RECEPTACLE (HIGH MOUNT) GROUND FAULT INTERRUPTER RECEPTACLE | **☆₩**\$

IRE ALARM HORN\SPEAKER\STROBE (HC DENOTES HIGH CANDELLA) FIRE ALARM STROBE (VISUAL ONLY) (HC DENOTES HIGH CANDELLA) CONNECTION TO EXISTING CIRCUIT RANCH CIRCUIT RACEWAY - CONCEALED IN BRANCH CIRCUIT RACEWAY — CONCEALED IN FLOOR OR UNDERGROUND BRANCH CIRCUIT RACEWAY - EXPOSED

TYPICAL: SYMBOLS DENOTE EXISTING. l_{-XXX} REMOVE COMPLETE. TYPICAL: "X" ON PLAN SYMBOLS DENOTES EXISTING. REMOVE COMPLETE.

NOTE: ALL DEVICES SHOWN ON THIS SCHEDULE ARE SYMBOLIC ONLY. SEE ELECTRICAL SPECIFICATIONS FOR







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REVISIONS

NO. DATE | DESCRIPTION

PROJECT NUMBER 19063 SHEET NUMBER

E00 SHEET NAME

ELECTRICAL NOTES, SCHEDULES,

Midlands Office - Main 168 Laurelhurst Avenue Columbia, SC 29210 (803)252-6919 Fax (803)799-5494 gwa@gwainc.net http://www.gwainc.net

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AND DETAILS - 1 DATE 3/31/2020

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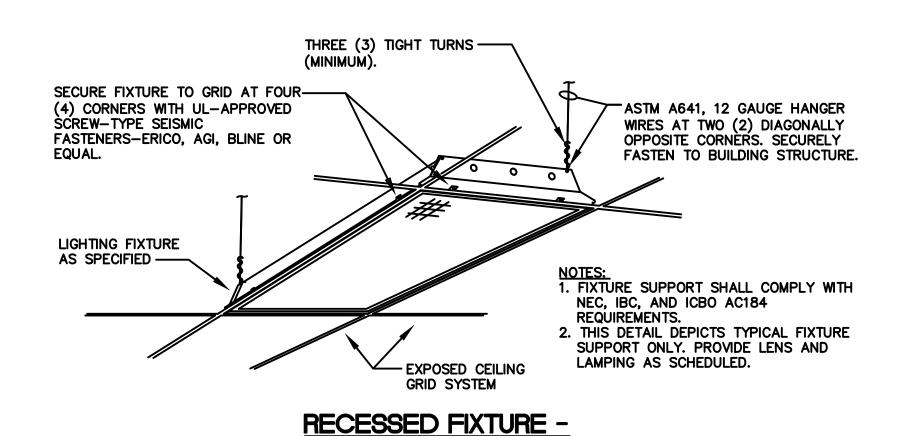
NOTES TO LIGHTING FIXTURE SCHEDULE

L1. LOCATE ALL FIXTURES IN STRICT ACCORDANCE WITH ARCHITECTUAL REFLECTED CEILING PLAN.

L2. PROVIDE ALL HALF-SHADED FIXTURES WITH EMERGENCY BATTERY UNIT. BODINE. IOTA, DUAL-LITE OR EQUAL. BATTERY UNITS SHALL BE DESIGNED AND RATED FOR USE WITH LED LUMINAIRES AND OF APPROPIATE TYPE AND WATTAGE TO SUIT LED DRIVERS FURNISHED - MINIMUM 90 MINUTE RATING. CONNECT COMPLETE TO SWITCH ON-OFF WITH ROOM/AREA LIGHTING AND ON UPON CIRCUIT FAILURE, REGARDLESS OF SWITCH POSITION.

NOTES TO OCCUPANCY SENSORS:

- 1. ALL SENSOR LOCATIONS ARE APPROXIMATE. REFER TO MANUFACTURER'S INSTALLATION INSTRUCTIONS PRIOR TO INSTALLATION.
- 2. ULTRASONIC CEILING MOUNT SENSORS SHOULD BE LOCATED A MINIMUM OF SIX (6) FEET FROM HVAC SUPPLY/RETURN VENTS.
- 3. CONTRACTOR IS RESPONSIBLE FOR PROPER SENSITIVITY AND TIME DELAY SETTINGS FOR NON-ADAPTIVE PRODUCTS, FOLLOWING THE MANUFACTURER'S RECOMMENDED PLACEMENT, AND FIELD VERIFICATION OF CIRCUITS WITH RESPECT TO POWER PACK PLACEMENT.
- 4. CONTRACTOR IS RESPONSIBLE FOR FIELD VERIFICATION OF REQUIRED NUMBER OF POWER PACKS:
- A. ONE POWER PACK IS REQUIRED FOR EACH CONTROLLED CIRCUIT, B. UP TO THREE (3) SENSORS CAN BE WIRED IN PARALLEL TO SINGLE
- POWER PACK, SÈNSOR TYPE DEPENDENT, C. IF MULTIPLE CIRCUITS ARE TO BE CONTROLLED BY A SINGLE SENSOR, AUXILIARY RELAYS MAY BE USED IN CONJUNCTION WITH A POWER PACK.
- SENSORS MOUNTED OVER DOORWAYS SHOULD BE PLACED ONE (1) FOOT INSIDE THRESHOLD.
- 6. PROVIDE FINAL QUANTITY AND LOCATION OF OCCUPANCY SENSORS FOR FULL COVERAGE IN ROOMS. OCCUPANCY SENSORS ARE INDICATED AS REQUIRED FOR SYSTEM FURNISHED.




TYPICAL HANGER SUPPORT

DEMOLITION NOTES

- BIDDERS SHALL VISIT THE SITE OF WORK PRIOR TO BIDDING AND SHALL INCLUDE IN BID ALL WORK REQUIRED TO PROVIDE NEW WORK AND TO MODIFY EXISTING WORK AS REQUIRED TO CONTINUE IN OPERATION.
- DEMOLITION WORK SHALL COMPLY WITH ANSI 10.6, NFPA 241, OSHA, AHERA AND ALL OTHER APPLICABLE LOCAL, STATE AND FEDERAL STANDARDS, CODES AND GUIDELINES.
- CONTRACTOR IS CAUTIONED THAT DEMOLITION PLANS ARE BASED ON RECORD DRAWINGS AND VISUAL FIELD OBSERVATION AND ARE INTENDED TO COMMUNICATE INTENT OF DEMOLITION AND DO NOT INDICATE EVERY COMPONENT OF ELECTRICAL SYSTEMS.
- OWNER SHALL RETAIN FIRST RIGHT OF REFUSAL ON ELECTRICAL EQUIPMENT BEING DEMOLISHED. PRIOR TO BEGINNING DEMOLITION WORK, CONTRACTOR SHALL WALL DEMOLITION AREA WITH OWNER REPRESENTATIVE AND IDENTIFY ITEMS TO BE REMOVED AND TURNED OVER TO OWNER. ALL SUCH ITEMS SHALL BE CAREFULLY REMOVED, PROTECTED AND DELIVERED TO OWNER.
- EXISTING RACEWAY AND WIRING SYSTEMS REUSED AS PART OF THIS CONTRACT SHALL BE REWORKED AS REQUIRED TO COMPLY WITH REQUIREMENTS FOR NEW WORK AND CURRENT CODES AND STANDARDS.
- CONTRACTOR SHALL EXAMINE DEMOLITION AND NEW WORK PLANS FOR ALL TRADES AND INCLUDE IN BID ALL REQUIRED REWORK AND/OR RELOCATION OF EXISTING RACEWAY, JUNCTION BOXES, DEVICES, WIRING SYSTEMS AND THE LIKE AS REQUIRED TO ACCOMMODATE NEW CONSTRUCTION.
- SEE ARCHITECTURAL DRAWINGS FOR DEMOLITION FLOOR PLAN. EXAMINE WORK TO BE DONE AND PROVIDE ALL ELECTRICAL WORK REQUIRED FOR DEMOLITION.

- INCLUDE IN BID ALL WORK REQUIRED FOR TEMPORARY WIRING AND ASSOCIATED ELECTRICAL WORK REQUIRED TO MAINTAIN EXISTING SYSTEMS IN SERVICE DURING DEMOLITION PHASE. INTERRUPTIONS IN ANY ELECTRICAL SERVICE OR SYSTEM (POWER, LIGHTING, COMMUNICATION, FIRE ALARM, ETC.) SHALL BE COORDINATED WITH AND APPROVED BY OWNER A MINIMUM OF 48 HOURS PRIOR TO PERFORMING WORK U.N.O.
- ELECTRICAL DEMOLITION GENERALLY INCLUDES REMOVAL OF EXISTING OUTLETS, DEVICES, AND OTHER ELECTRICAL COMPONENTS. WHERE ALL CIRCUIT LOADS ARE REMOVED, DEMOLISH CIRCUITS BACK TO PANELBOARD(S). WHERE ONLY PORTIONS OF CIRCUIT LOADS ARE REMOVED, REWORK CIRCUITS BY EXTENSION AND RECONNECTION TO CONTINUE REMAINING LOADS IN SERVICE BEYOND THE DEMOLITION AREA.
- WIRING SYSTEMS SHALL BE REMOVED BACK TO THE SOURCE OF SUPPLY UNLESS NOTED OTHERWISE. CIRCUIT BREAKERS, FUSIBLE SWITCHES, ETC. SUPPLYING LOADS DEMOLISHED AS PART OF THIS CONTRACT SHALL BE LABELED AS SPARE AND SET TO THE OFF POSITION.
- 11. PROVIDE REVISED CIRCUIT DIRECTORIES IN ALL PANELBOARDS AFFECTED BY NEW OR DEMOLITION WORK. INDICATE ALL LOADS, NEW, SPARE OR MODIFIED.
- 12. REMOVE ALL EXISTING, ABANDONED WIRING SYSTEMS IN CEILING SPACE, EQUIPMENT ROOMS, SHAFTS, CRAWL SPACES AND SIMILAR CAVITIES OF THE WORK AREA. INCLUDING WIRING, RACEWAYS, BOXES AND SUPPORTS.
- 13. EXISTING CEILING SYSTEMS ARE BEING REMOVED AND REPLACED IN SOME AREAS UNDER THIS CONTRACT. INCLUDE IN BID ALL WORK AS REQUIRED FOR RELOCATION OF ALL EXISTING CEILING MOUNTED ELECTRICAL DEVICES (FIRE ALARM, SENSORS, CAMERAS, CLOCKS, SPEAKERS, ETC.) TO NEW CEILING SYSTEM. PROVIDE REMOVAL, PROTÉCTION OF, TEMPORARY SUPPORT AND REINSTALLATION COMPLETE.

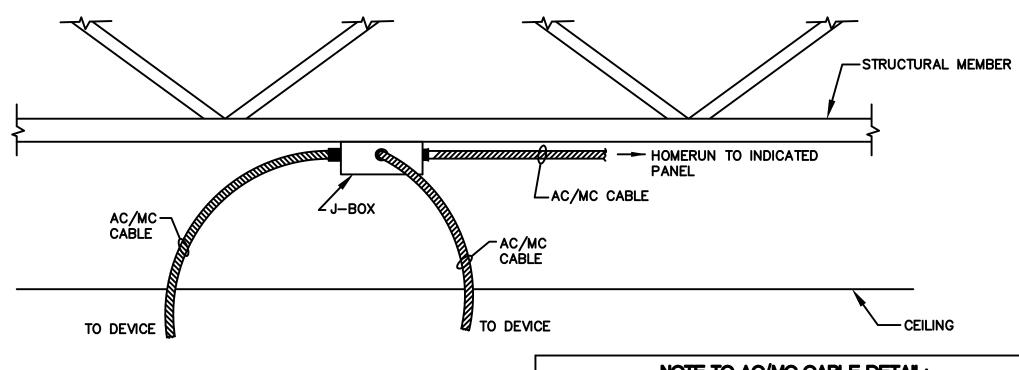

AC/MC CABLE DETAIL NO SCALE

NOTE TO AC/MC CABLE DETAIL:

UPON COMPLETION OF WORK AND PRIOR TO INSTALLATION OF GYPSUM WALLBOARD, THE SYSTEM SHALL BE FREE OF SHORTS, GROUND FAULTS, AND OPEN CIRCUITS. TEST SYSTEMS AS REQUIRED

- PROVIDE RED METALLIC RACEWAYS FOR ALL FIRE ALARM
- PROVIDE METALLIC RACEWAYS FOR ALL PANELBOARD FEEDER
- . DO NOT BUNDLE OR STACK TOGETHER MORE THAN 10 AC/MC

AND FURNISH THE ENGINEER A TEST REPORT.

- CONDUCTORS AND CABLES. AC/MC CABLE NOT PERMITTED.
- CONDUITS. AC/MC CABLE NOT PERMITTED.
- 5. SEE MATERIAL RACEWAY USE TABLE.

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SHEET NUMBER **E002**

SHEET NAME **ELECTRICAL NOTES, SCHEDULES, AND DETAILS - 2**

PROJECT NUMBER 19063

3-20-2020

No. C00825

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REVISIONS

NO. DATE DESCRIPTION

DATE **3/31/2020**

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